



No	DATE	REVISION
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NOTES

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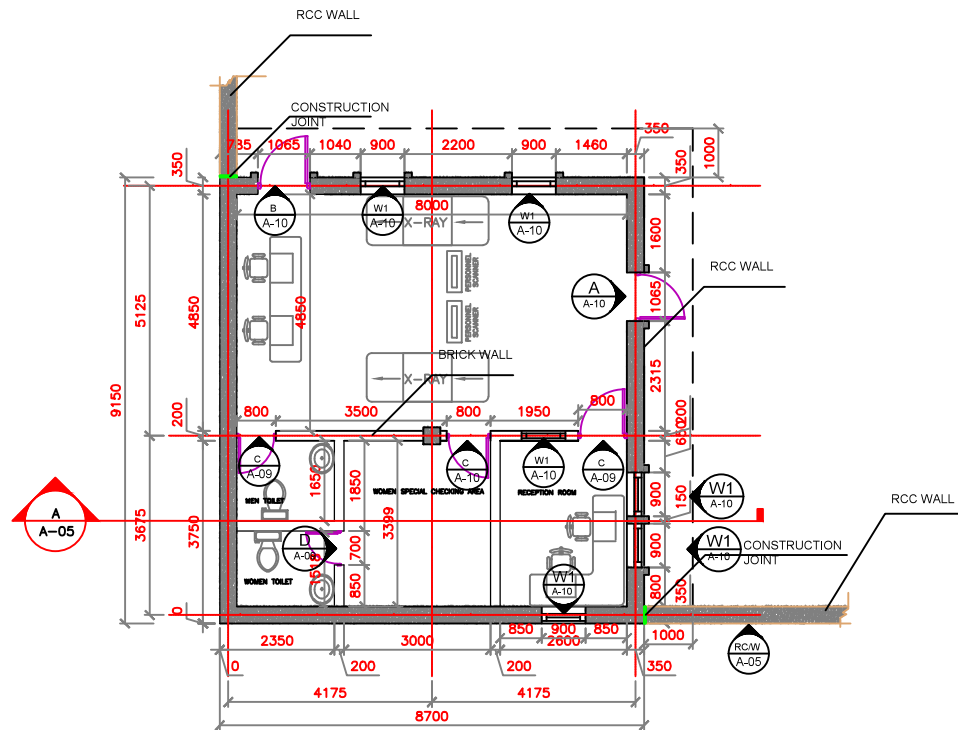
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DRAWN:	SHEET SIZE: A3		A-01	0
CHECKED:	SCALE: 1:000			
APPROVED:	DATE:			

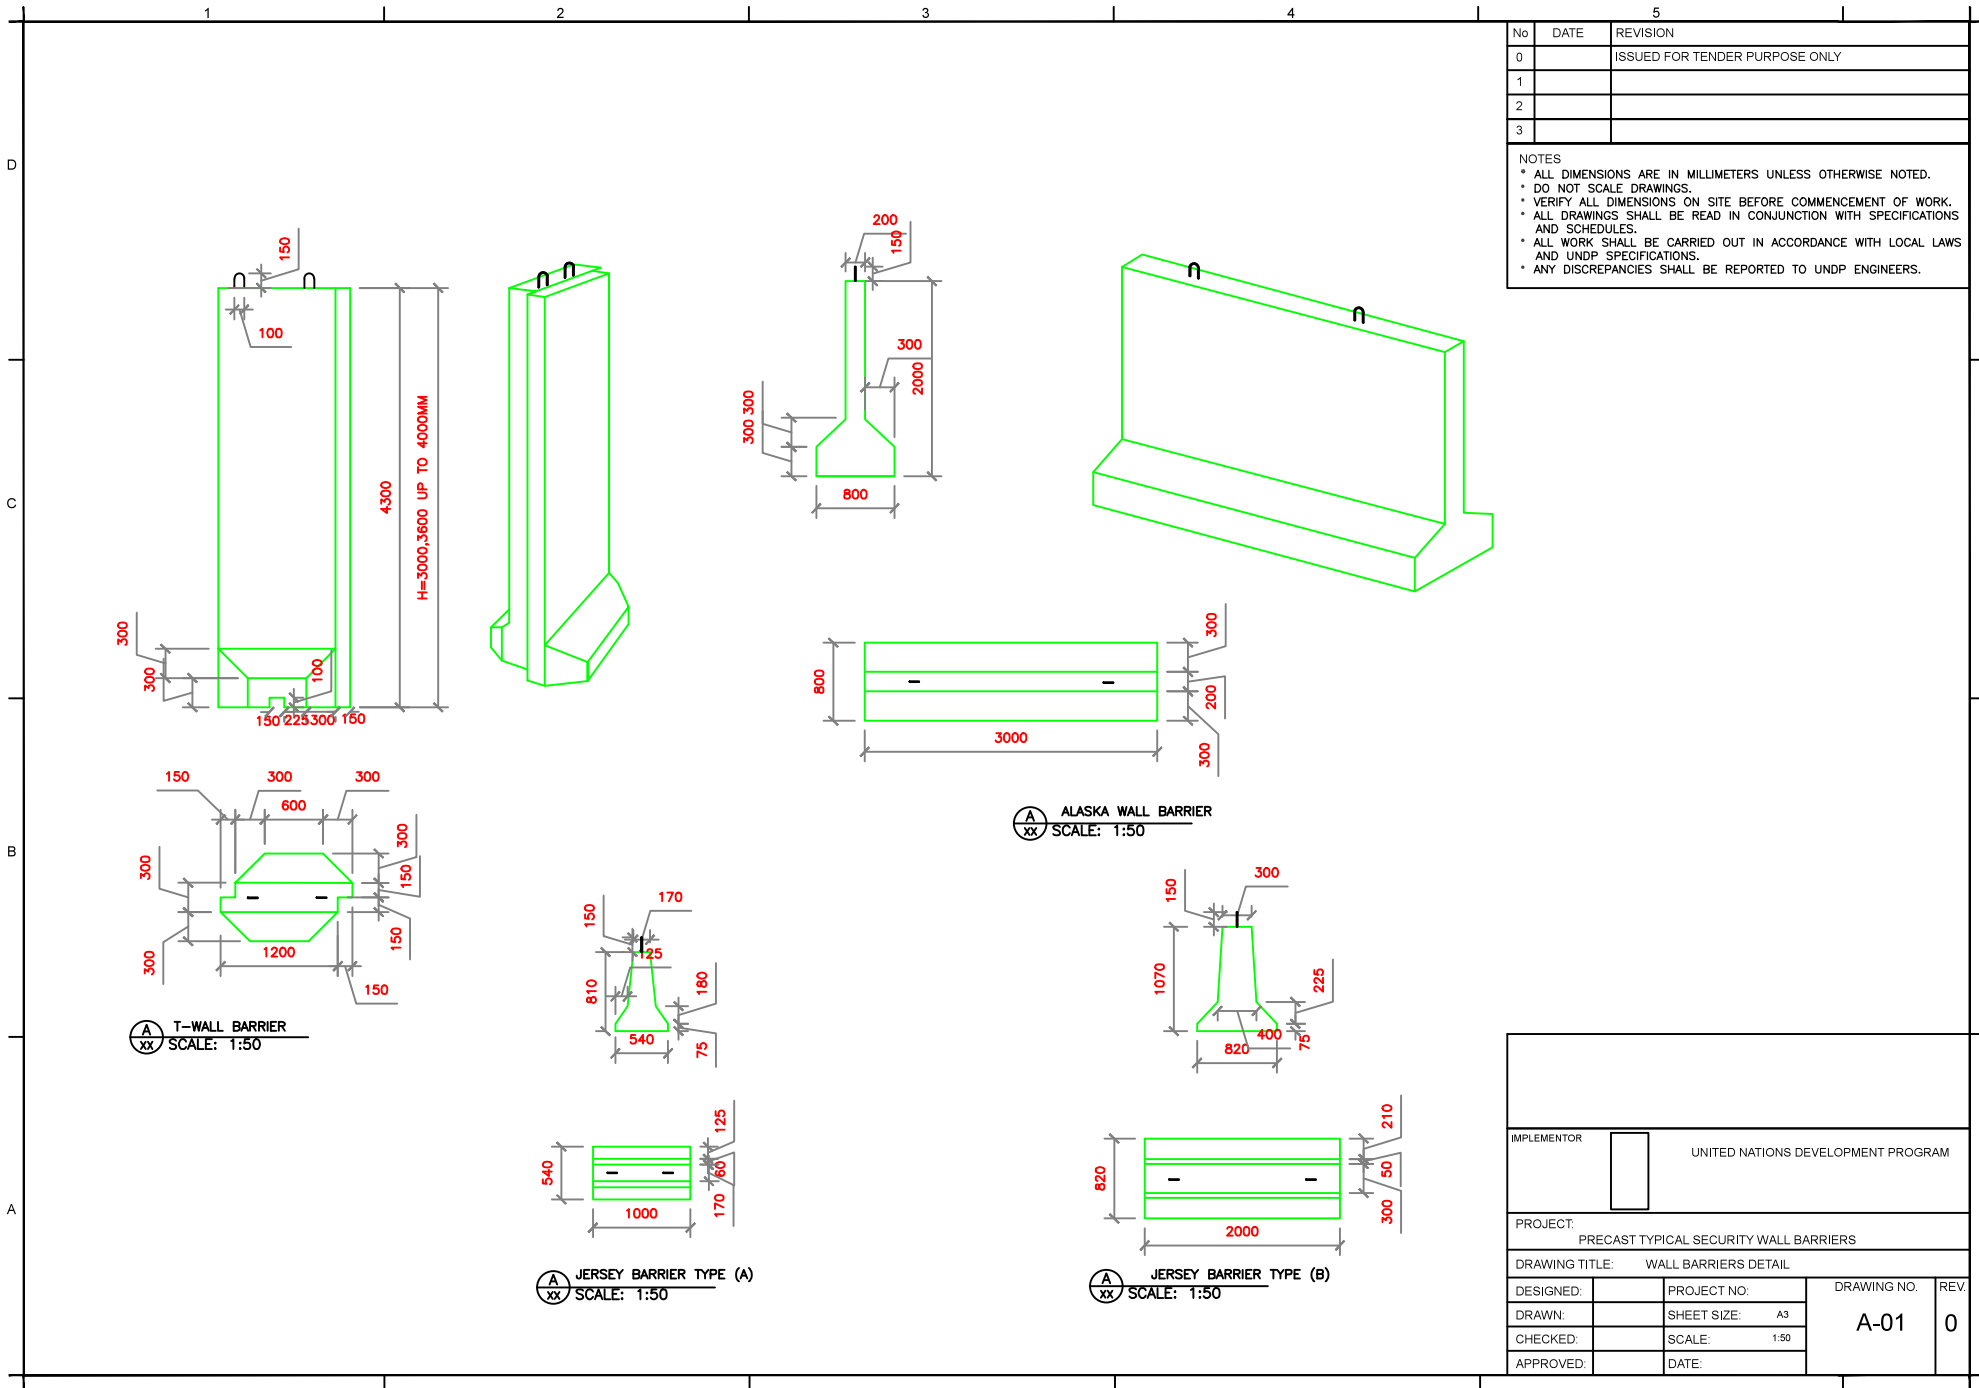




ISSUED FOR TENDER

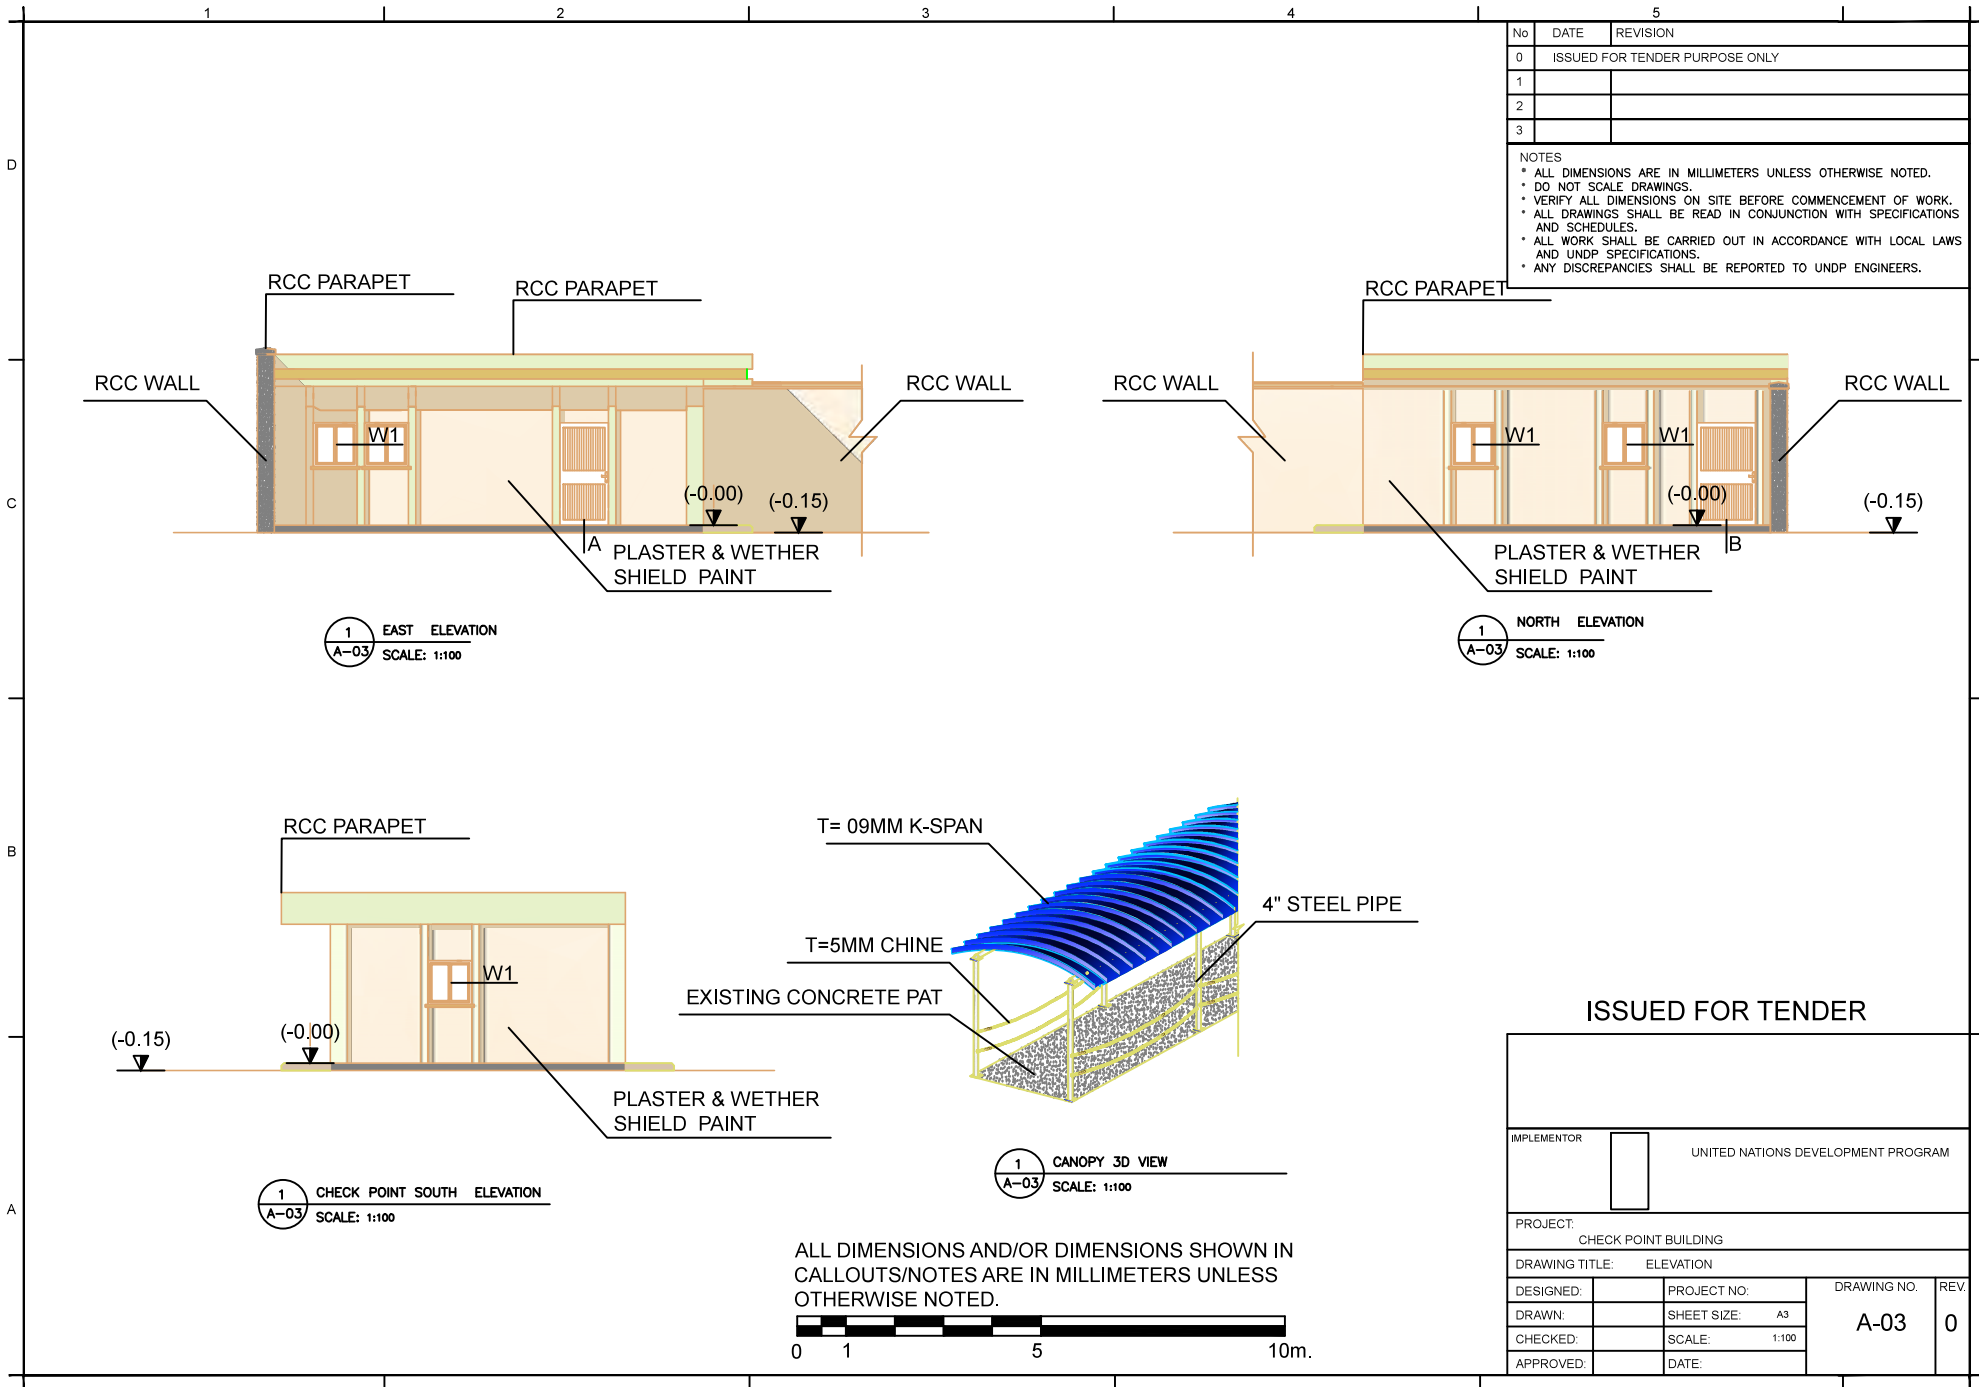IMPLEMENTOR		UNITED NATIONS DEVELOPMENT PROGRAM	
PROJECT: CHECK POINT BUILDING			
DRAWING TITLE: ELEVATION			
DESIGNED:		PROJECT NO:	DRAWING NO. A-03  0
DRAWN:		SHEET SIZE: A3	
CHECKED:		SCALE: 1:100	
APPROVED:		DATE:	



1 A.C.P. Floor Plan  
A-04  
SCALE: 1:100

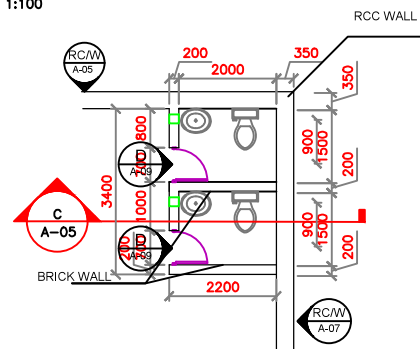

3 Male and Female toilets Floor Plan  
A-04  
SCALE: 1:100


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CALLOUTS/NOTES ARE IN MILLIMETERS UNLESS  
OTHERWISE NOTED.



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NOTES


- \* ALL DIMENSIONS ARE IN MILLIMETERS UNLESS OTHERWISE NOTED.
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2 Floor Plan Check point  
A-04  
SCALE: 1:100

ISSUED FOR TENDER

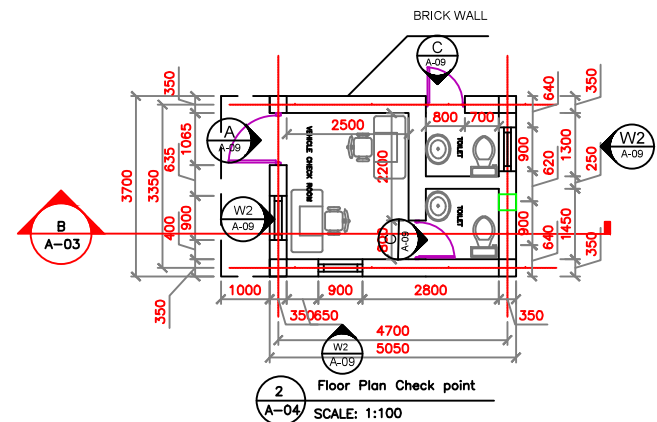IMPLEMENTOR		UNITED NATIONS DEVELOPMENT PROGRAM		
PROJECT:				
CHECK POINT BUILDING				
DRAWING TITLE: FLOOR PLANS				
DESIGNED:		PROJECT NO:	DRAWING NO. A-04	REV. 0
DRAWN:		SHEET SIZE: A3		
CHECKED:		SCALE: 1:100		
APPROVED:		DATE:		



5

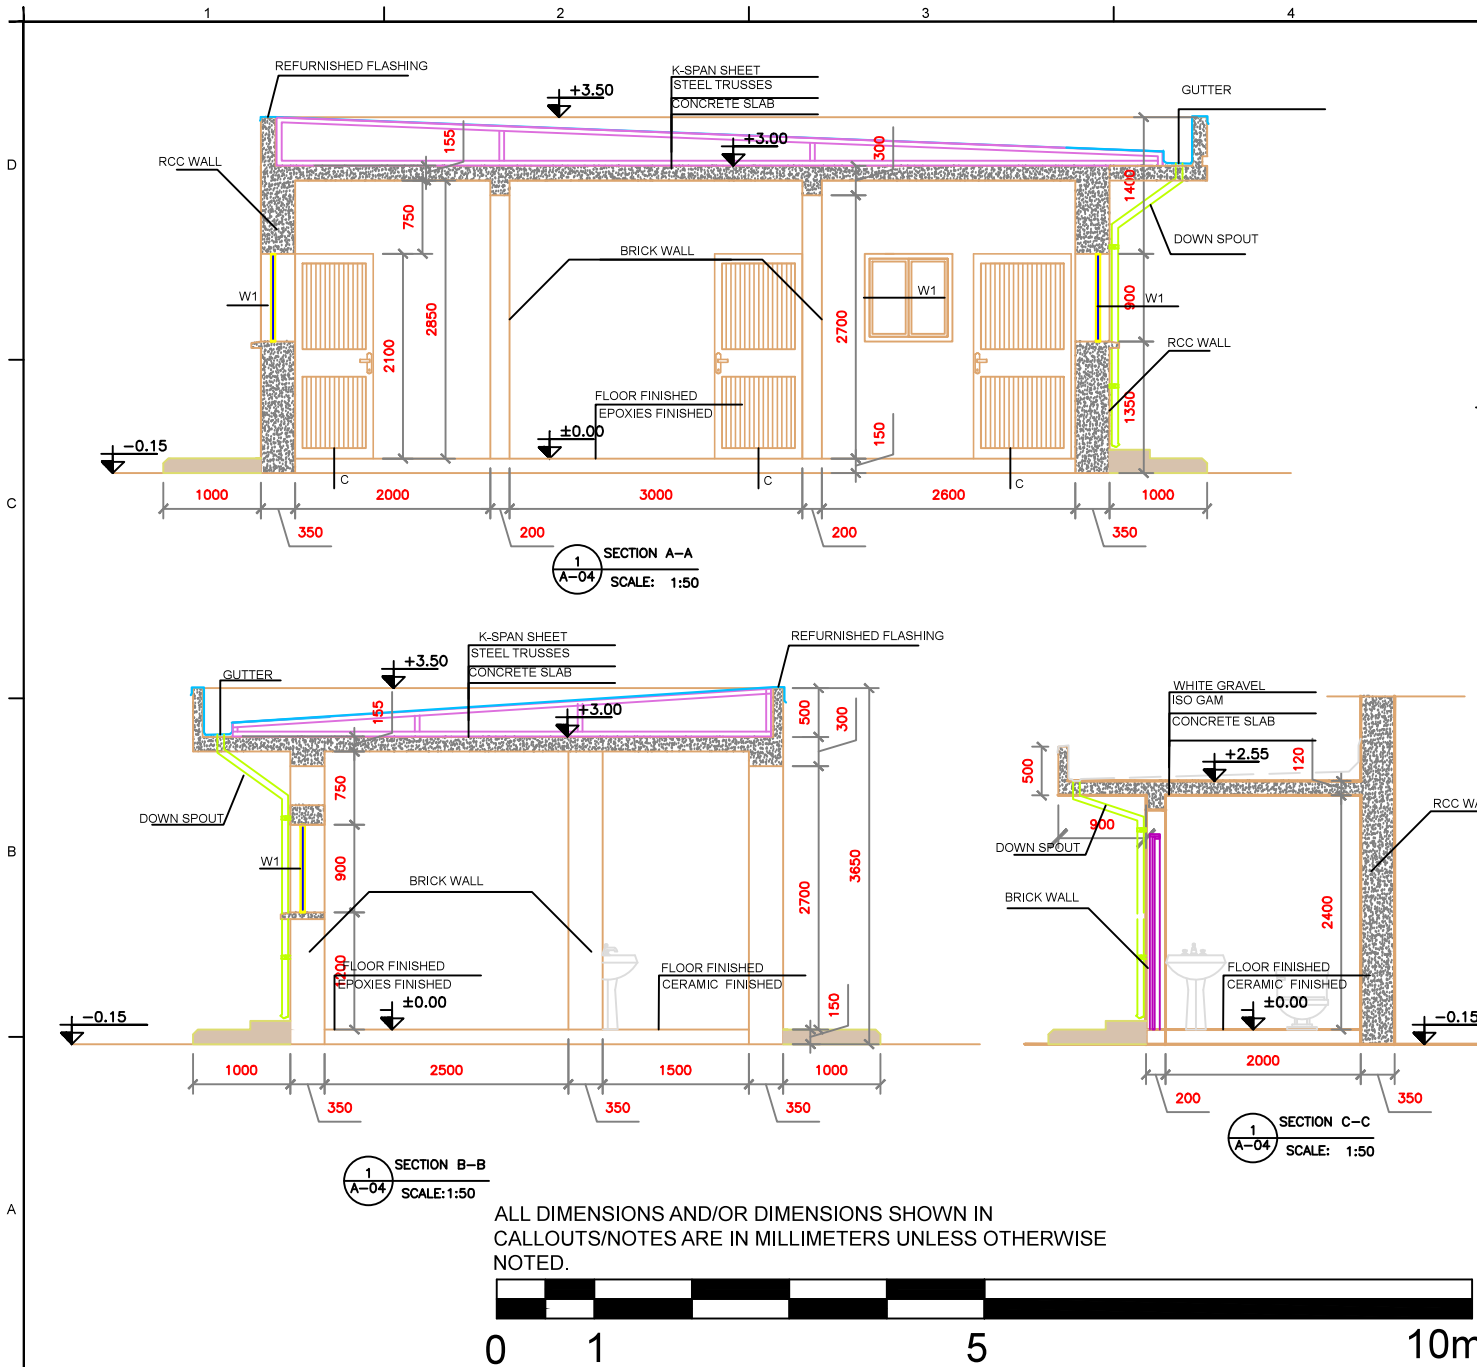
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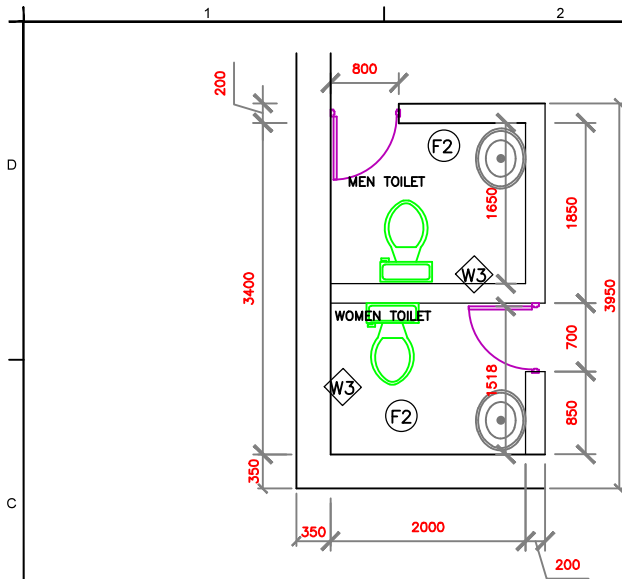
NOTES

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1  
A-02  
CANOPY SECTION D-D  
SCALE: 1:50


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UNITED NATIONS DEVELOPMENT PROGRAM			
PROJECT:			
CHECK POINT BUILDING			
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DESIGNED:	PROJECT NO:	DRAWING NO. A-05	REV. 0
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APPROVED:	DATE:		



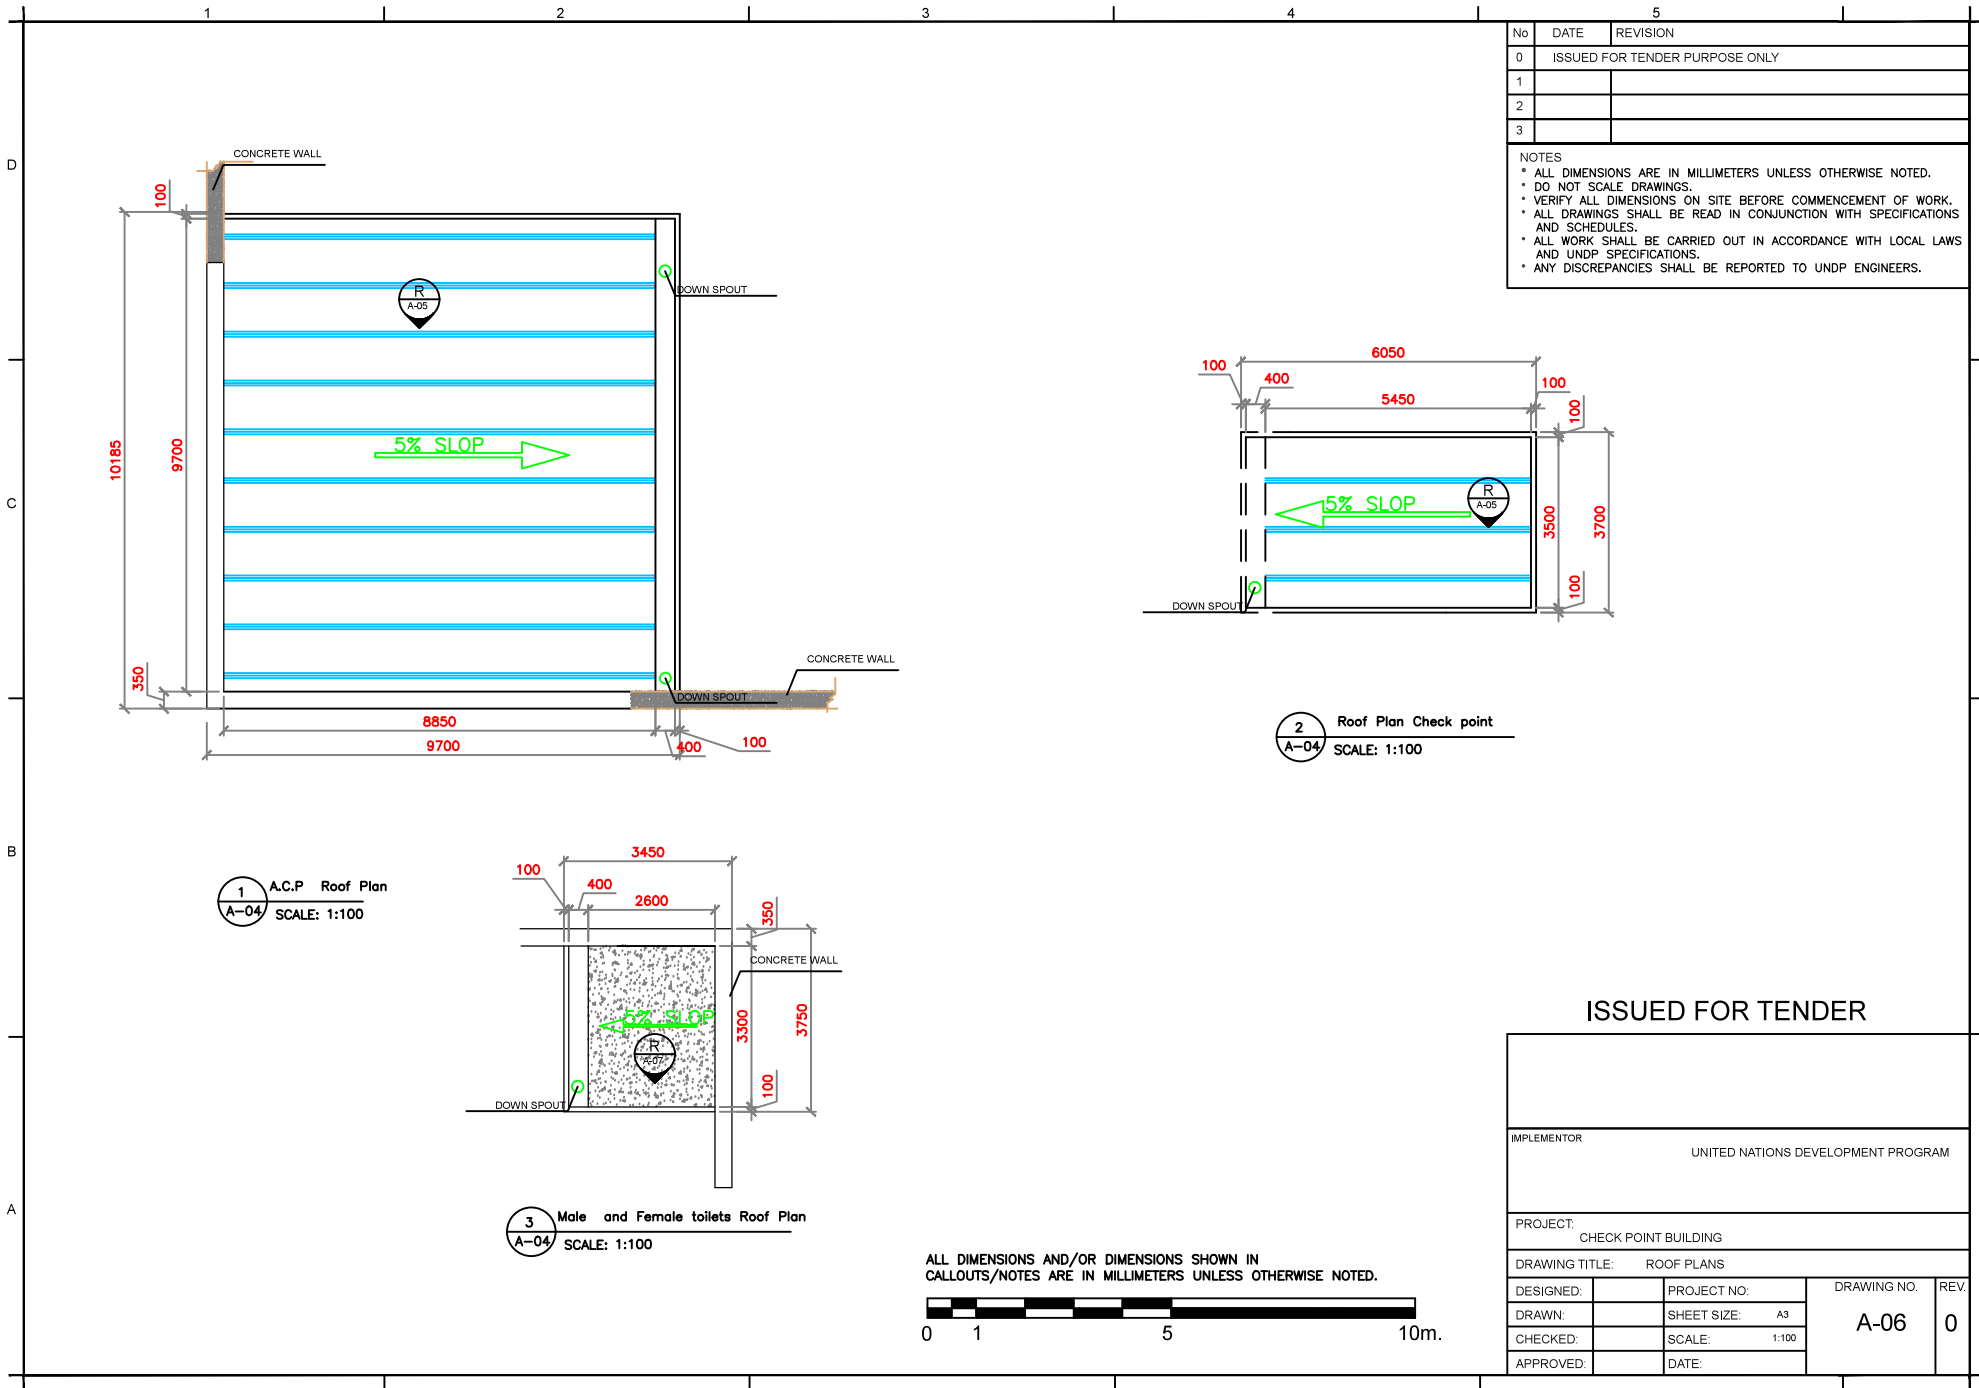



1 A.C.P. LARGE PLAN  
SCALE: 1:50

3 LARGE PLAN TOILETS  
SCALE: 1:50

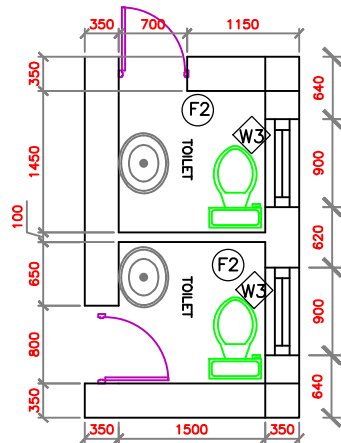

2 LARGE PLAN Check point  
SCALE: 1:50

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No	DATE	REVISION
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#### FLOOR

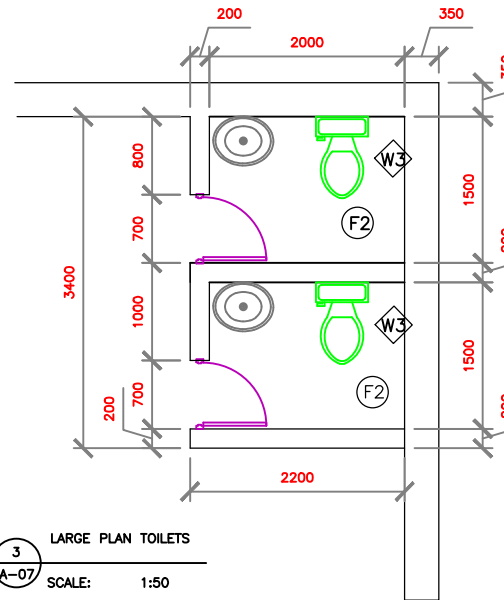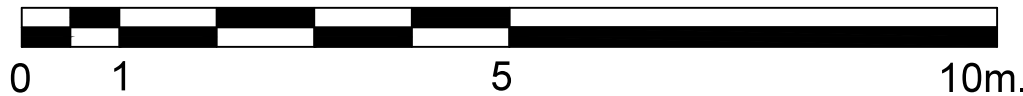F2	CERAMIC TILE
F3	

#### WALL

W3	GLASSING CERAMIC TILE
----	-----------------------

#### CEILING

C1	PLASTER/ PAINT
----	----------------

#### DOORS


C	PVC DOOR
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#### WINDOWS


W1	PVC WINDOWS
----	-------------

#### ISSUED FOR TENDER

IMPLEMENTOR			
UNITED NATIONS DEVELOPMENT PROGRAM			
PROJECT: CHECK POINT BUILDING			
DRAWING TITLE: GROUND FLOOR TOILET PLAN IN LARGE SCALE			
DESIGNED:	PROJECT NO.	DRAWING NO. A-07	REV. 0
DRAWN:	SHEET SIZE: A3		
CHECKED:	SCALE: 1:50		
APPROVED:	DATE:		



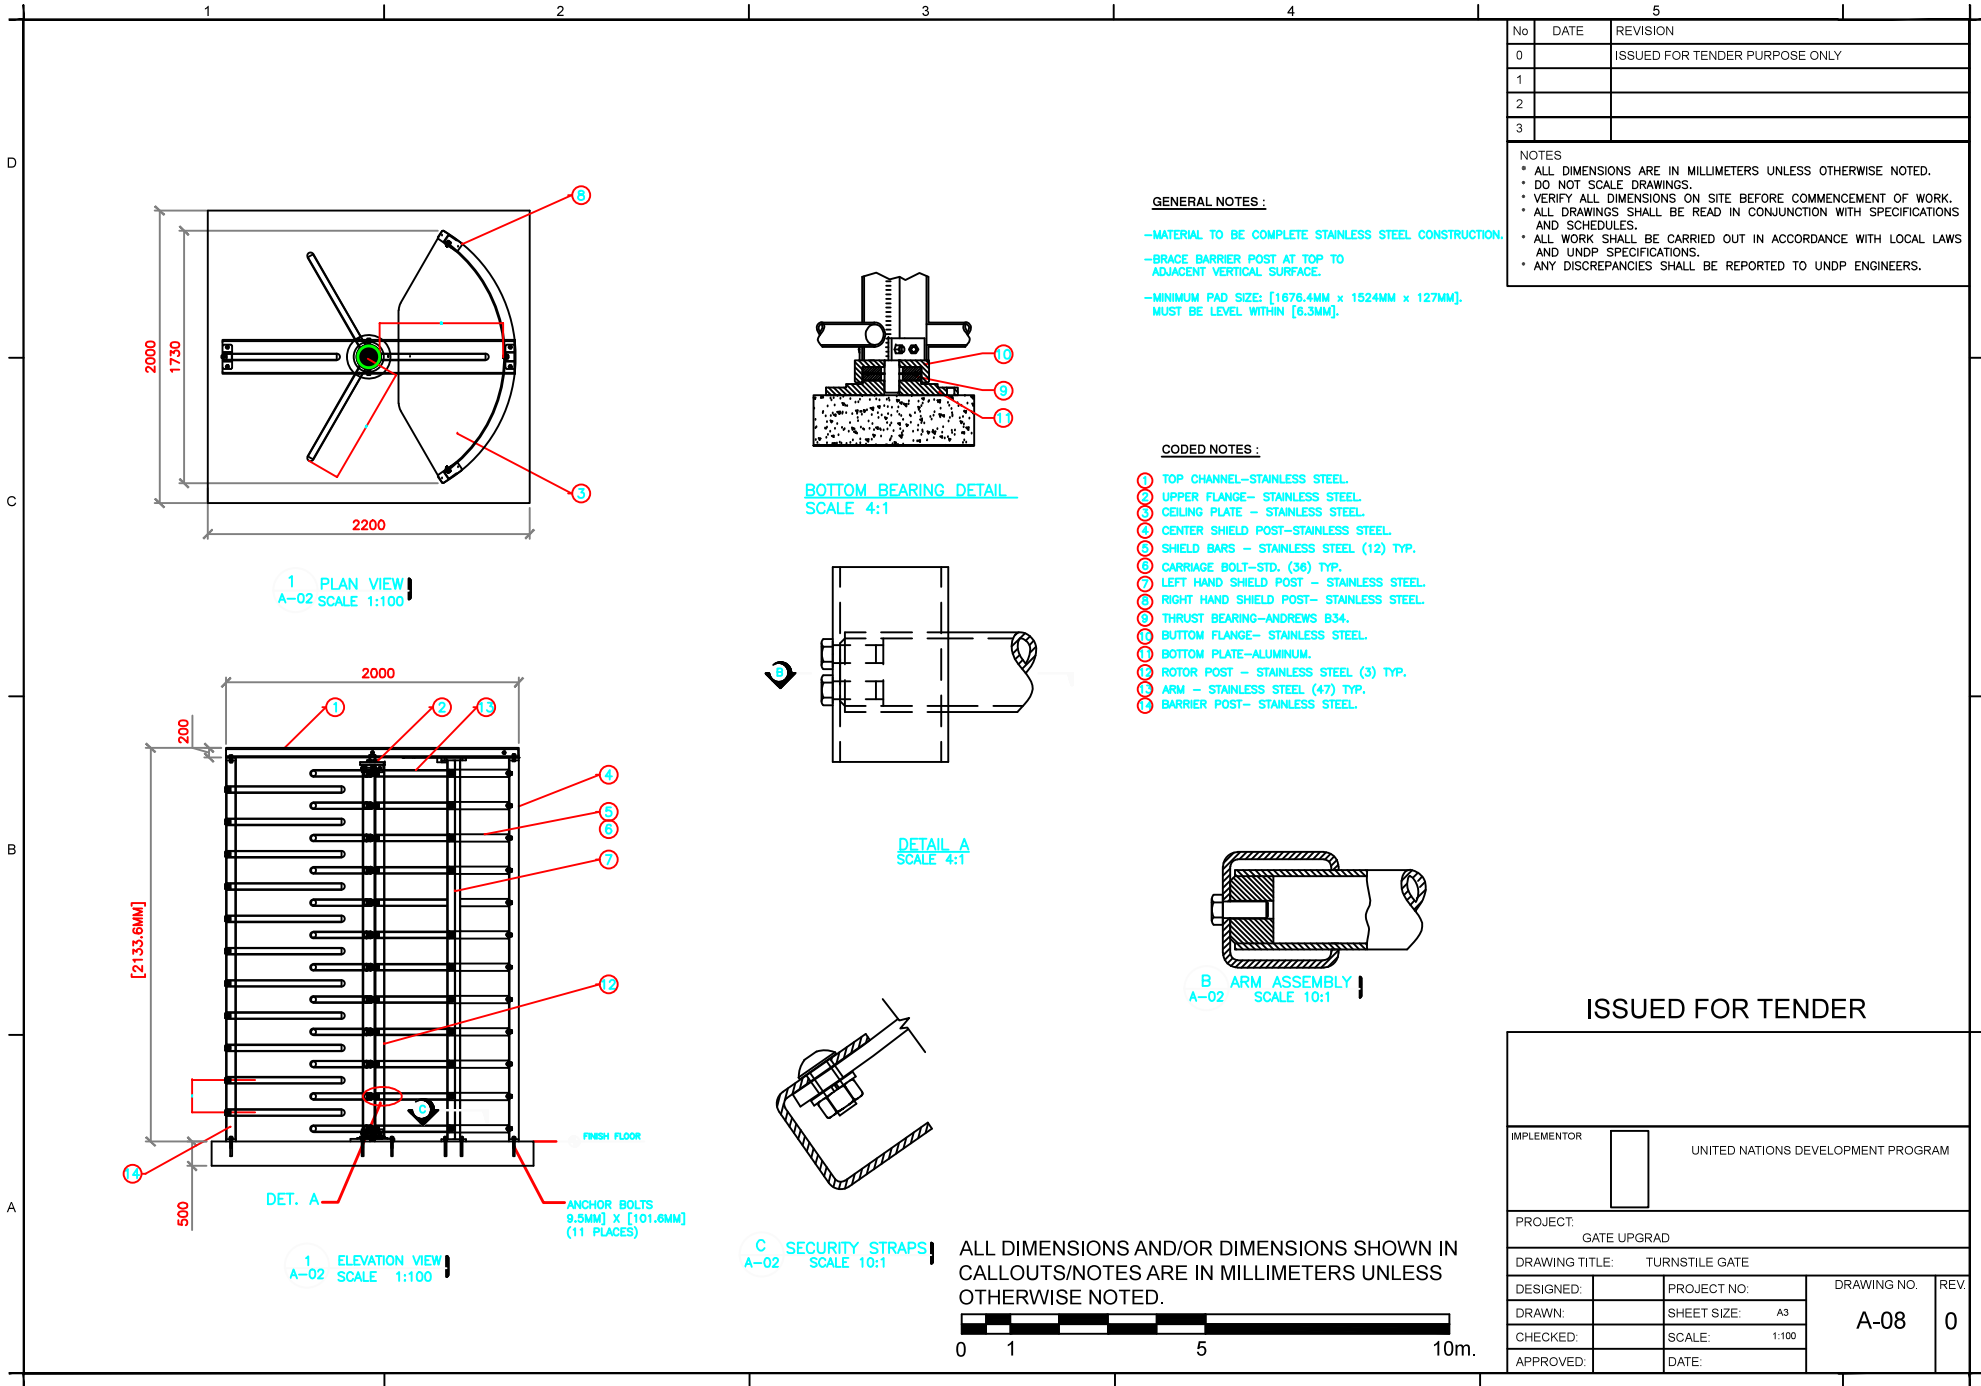


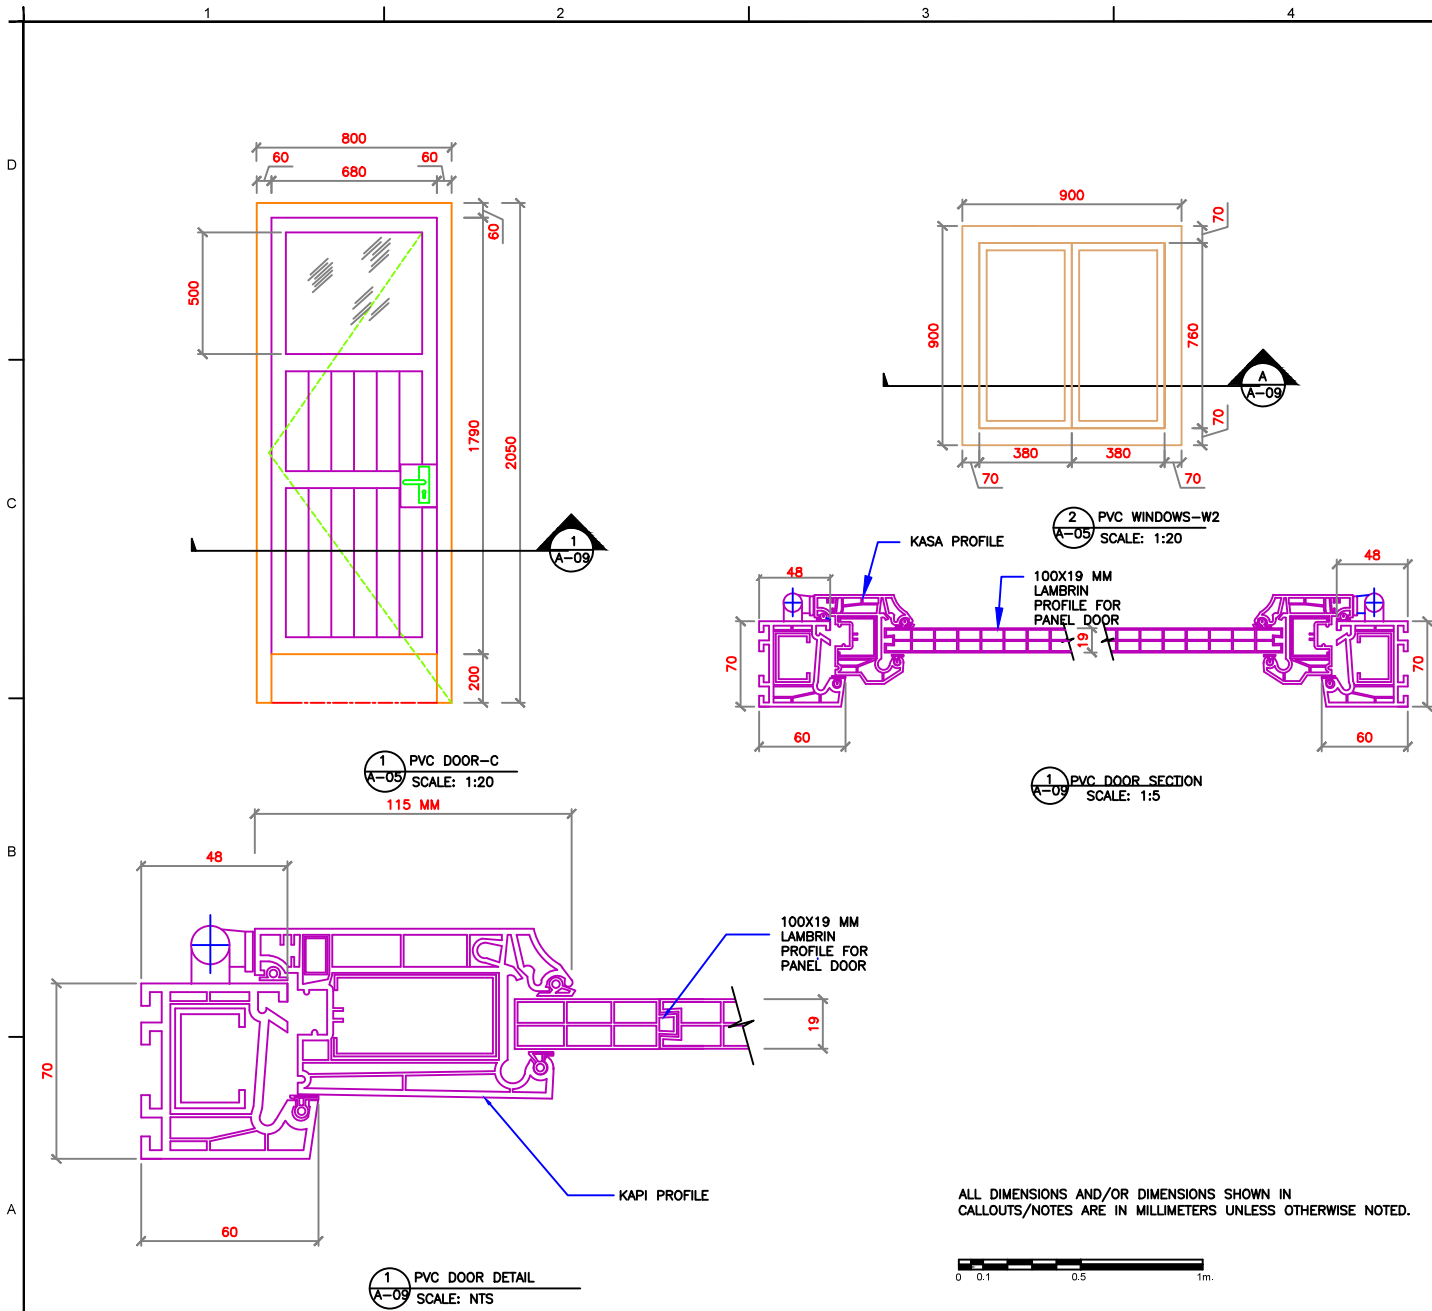

No	DATE	REVISION
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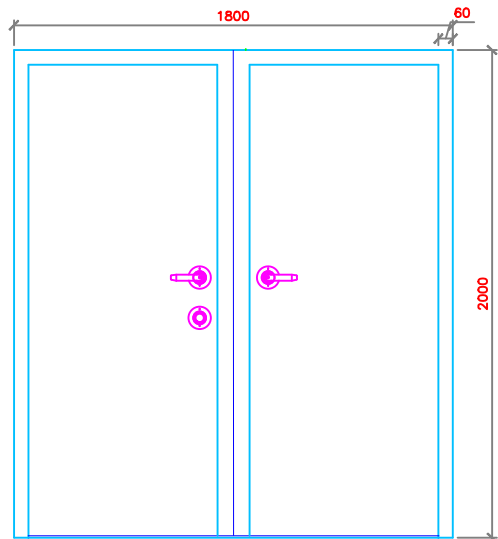
NOTES

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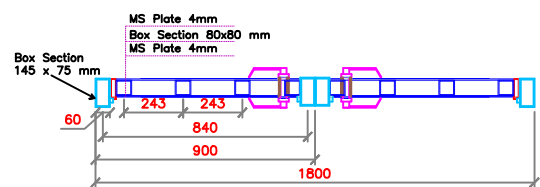


ISSUED FOR TENDER

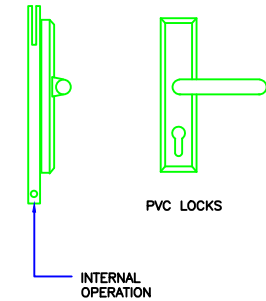
IMPLEMENTOR		UNITED NATIONS DEVELOPMENT PROGRAM		
PROJECT: CHECK POINT BUILDING				
DRAWING TITLE:		TOILET PVC DOOR		
DESIGNED:		PROJECT NO:	DRAWING NO. A-09	REV. 0
DRAWN:		SHEET SIZE: A3		
CHECKED:		SCALE: 1:20		
APPROVED:		DATE:		




(H)




2 METAL DOOR-H  
A-10  
SCALE: 1:20

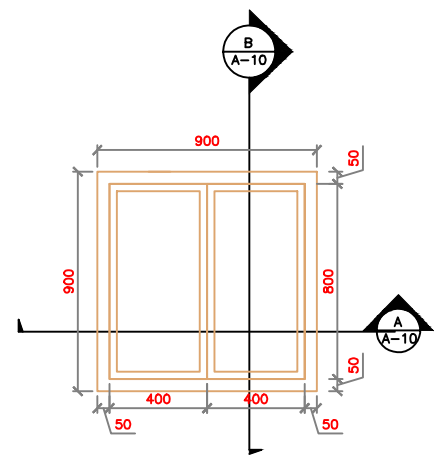


2 METAL WINDOWS-W1  
A-05  
SCALE: 1:20

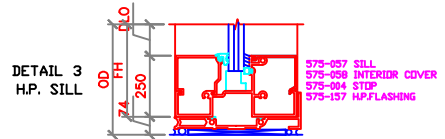

DETAIL 3  
H.P. SILL

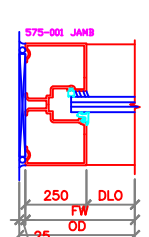

DETAIL 4  
JAMB

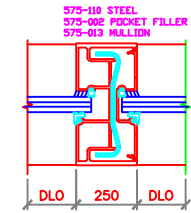


DETAIL 5  
VERTICAL MULLION


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DETAIL 1  
HEAD




DETAIL 2  
HORIZONTAL

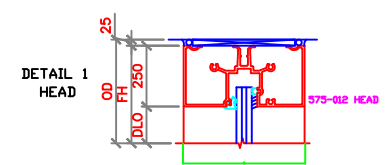ISSUED FOR TENDER

IMPLEMENTOR		UNITED NATIONS DEVELOPMENT PROGRAM	
PROJECT: CHECK POINT BUILDING			
DRAWING TITLE: BLAST RESISTANT WINDOWS & DOOR			
DESIGNED:		DRAWING NO. A-10	REV. 0
DRAWN:	SHEET SIZE: A3		
CHECKED:	SCALE: 1:20		
APPROVED:	DATE:		
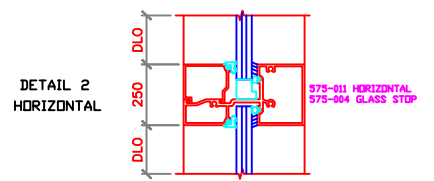
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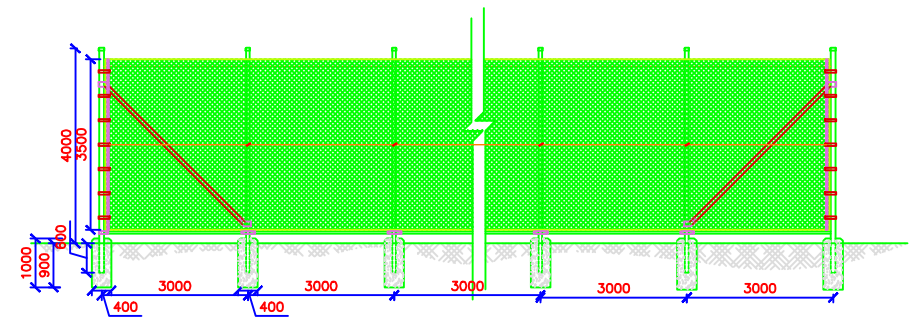
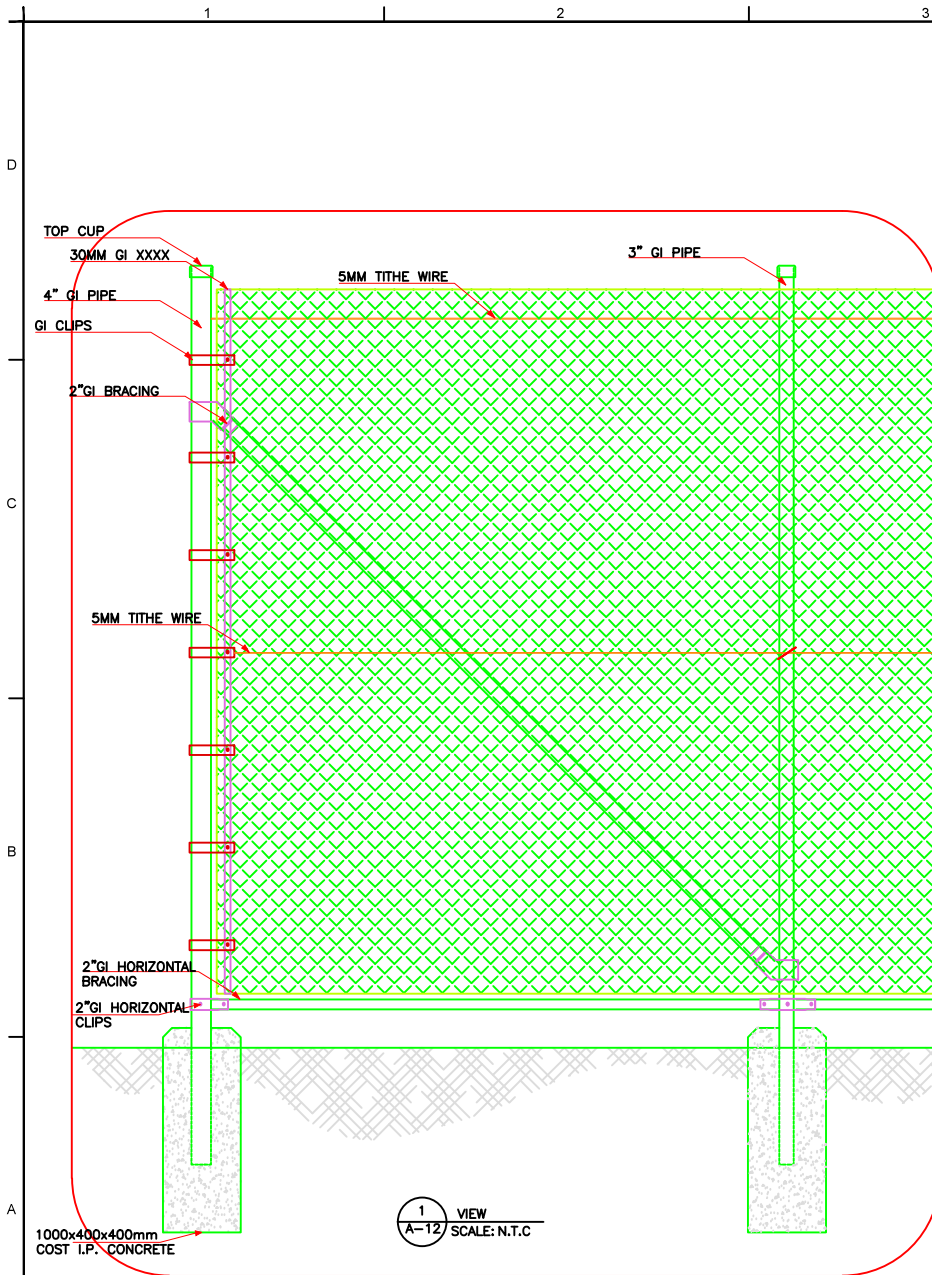
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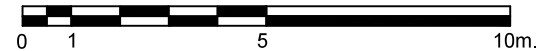
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ISSUED FOR TENDER

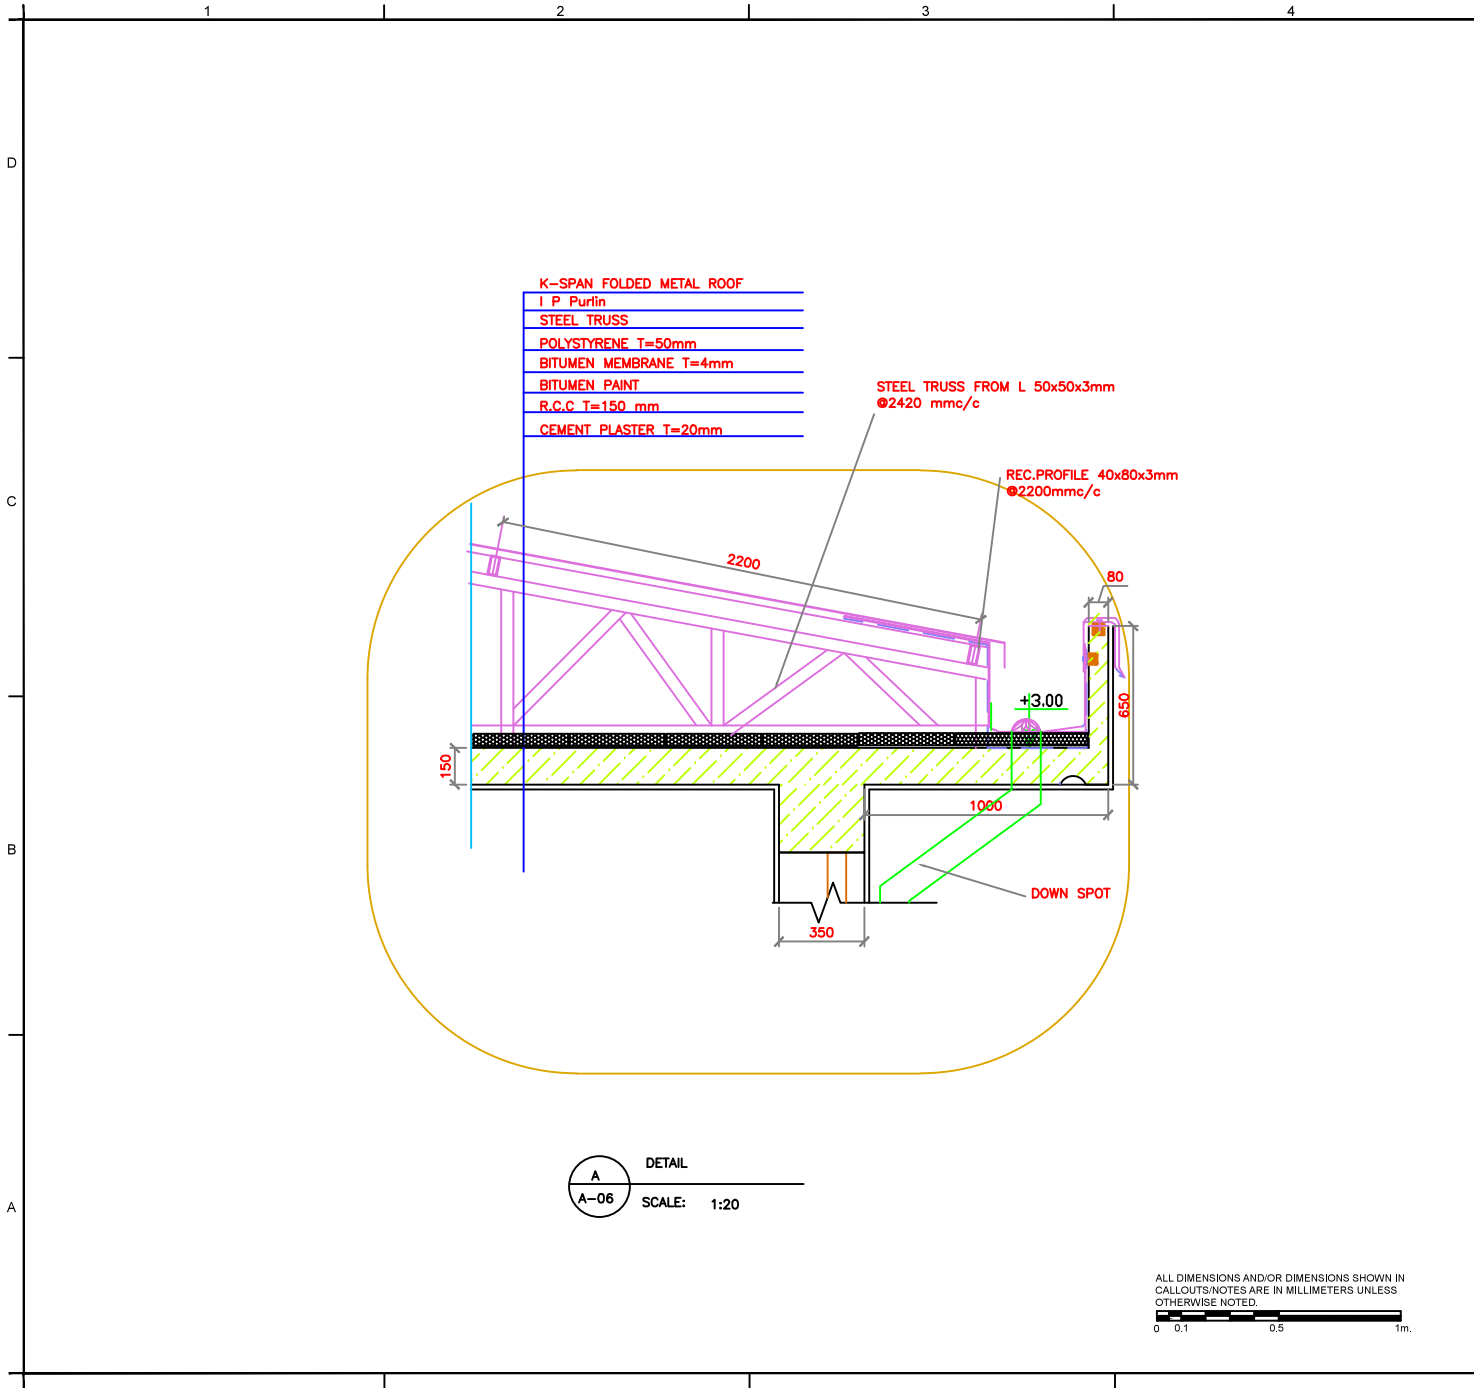IMPLEMENTOR			
UNITED NATIONS DEVELOPMENT PROGRAM			
PROJECT: CHECK POINT BUILDING			
DRAWING TITLE: ROOF DETAILS			
DESIGNED:	PROJECT NO:	DRAWING NO. A-11	REV. 0
DRAWN:	SHEET SIZE: A3		
CHECKED:	SCALE: 1:20		
APPROVED:	DATE:		



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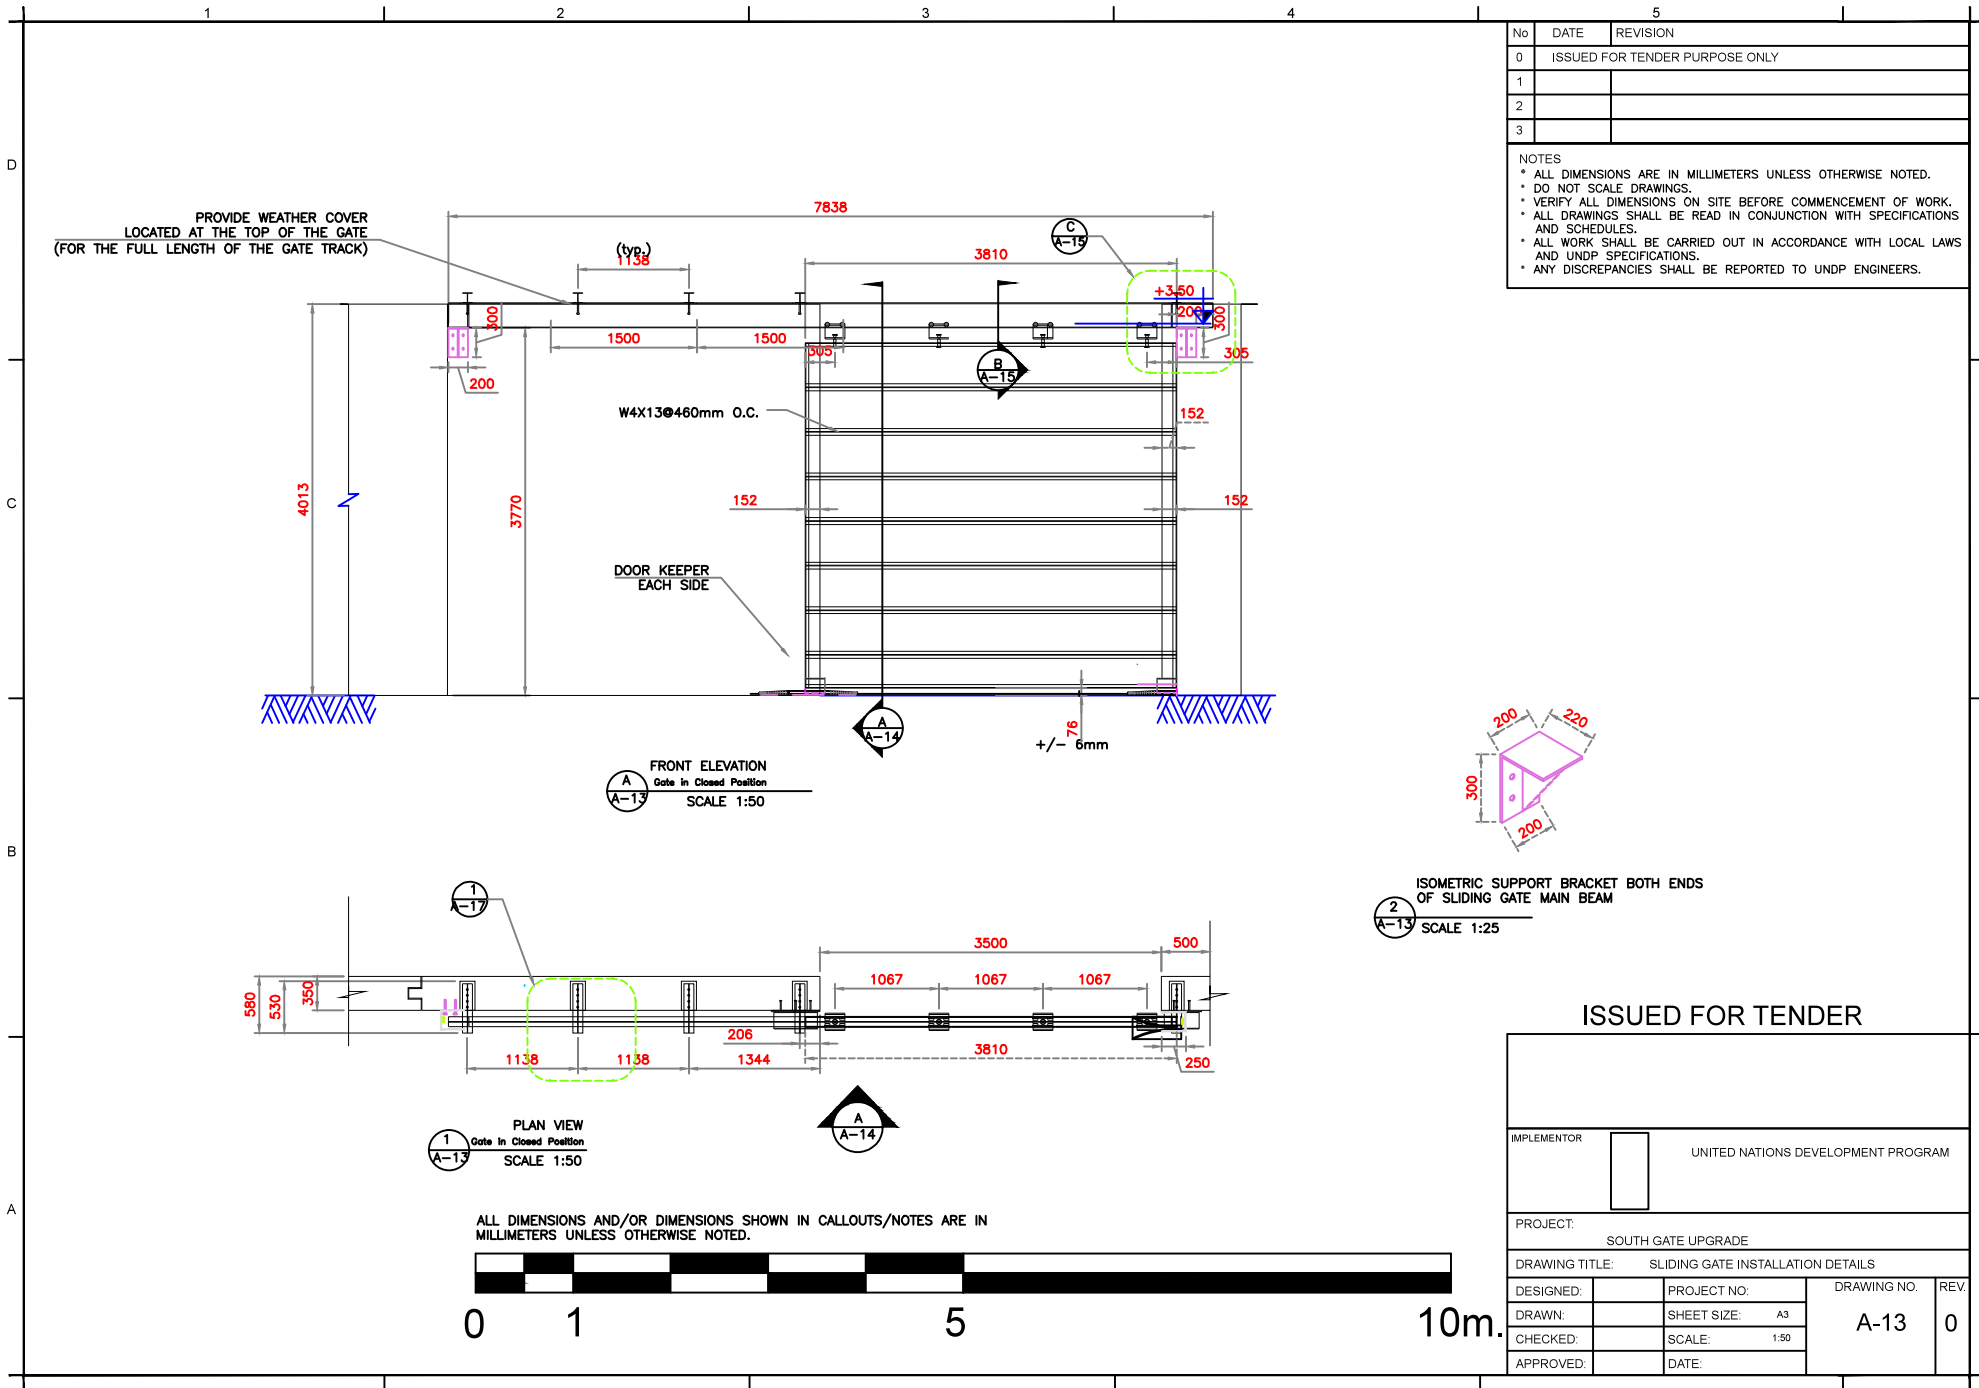
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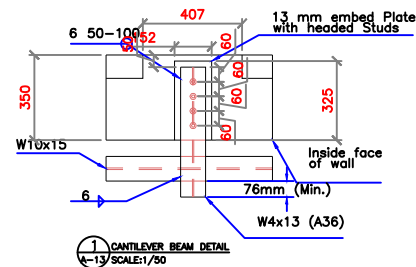
NOTES

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
ISSUED FOR TENDER

IMPLEMENTOR		UNITED NATIONS DEVELOPMENT PROGRAM		
PROJECT:				
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DESIGNED:		PROJECT NO:	DRAWING NO.	REV.
DRAWN:		SHEET SIZE: A3	A-12	0
CHECKED:		SCALE: 1:100		
APPROVED:		DATE:		





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0 0.1 0.5 1m

NOTES


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IMPLEMENTOR		UNITED NATIONS DEVELOPMENT PROGRAM		
PROJECT:				
DRAWING TITLE: SLIDING GATE DETAILS FOR INSTALLATION				
DESIGNED:		PROJECT NO.	DRAWING NO. A-16	REV. 0
DRAWN:		SHEET SIZE: A3		
CHECKED:		SCALE: 1:20		
APPROVED:		DATE:		


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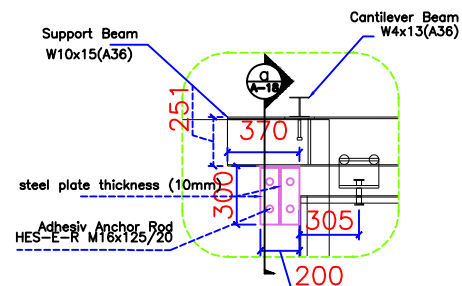
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① Support Beam - Rolling Assembly. Connection  
A-16 Elevation View.




② DETAIL  
A-17 SCALE: N.T.S

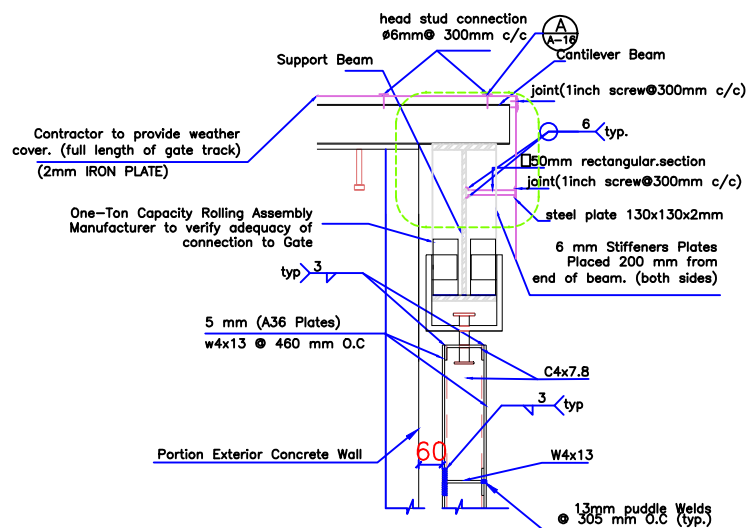


③ DETAIL  
A-18 SCALE: 1:25

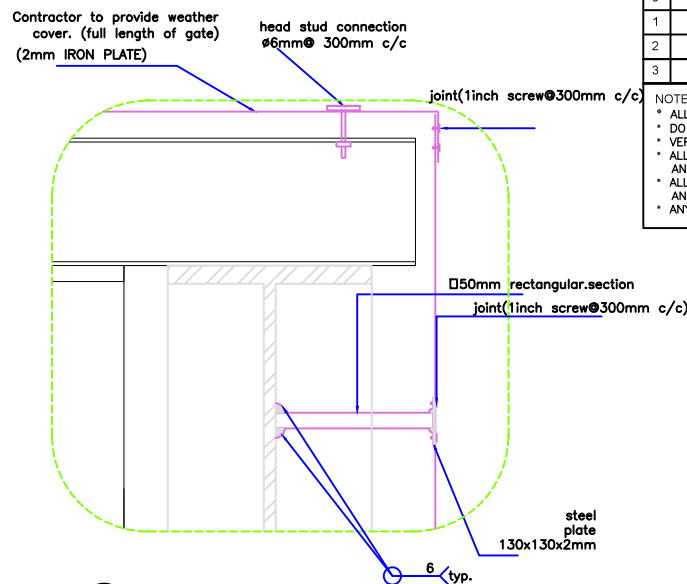ISSUED FOR TENDER

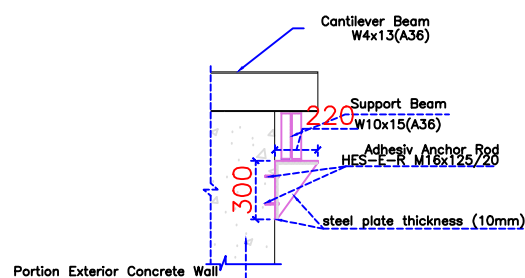

④ SECTION  
A-16 SCALE: 1:25

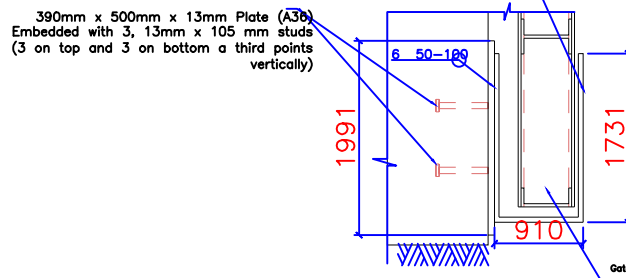


⑤ DOOR KEEPER  
A-16 ELEVATION VIEW. SCALE 1MM : 7.5MM

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IMPLEMENTOR				UNITED NATIONS DEVELOPMENT PROGRAM	
PROJECT:					
DRAWING TITLE: GATE DETAILS					
DESIGNED:	PROJECT NO.	DRAWING NO.		REV.	
DRAWN:	SHEET SIZE: A3	A-17		0	
CHECKED:	SCALE: 1:50				
APPROVED:	DATE:				



No	DATE	REVISION
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- NOTES
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NOTE:  
DOOR FIXING MUST BE FIXED AS  
PER DOOR MANUFACTURE DOOR DETAIL

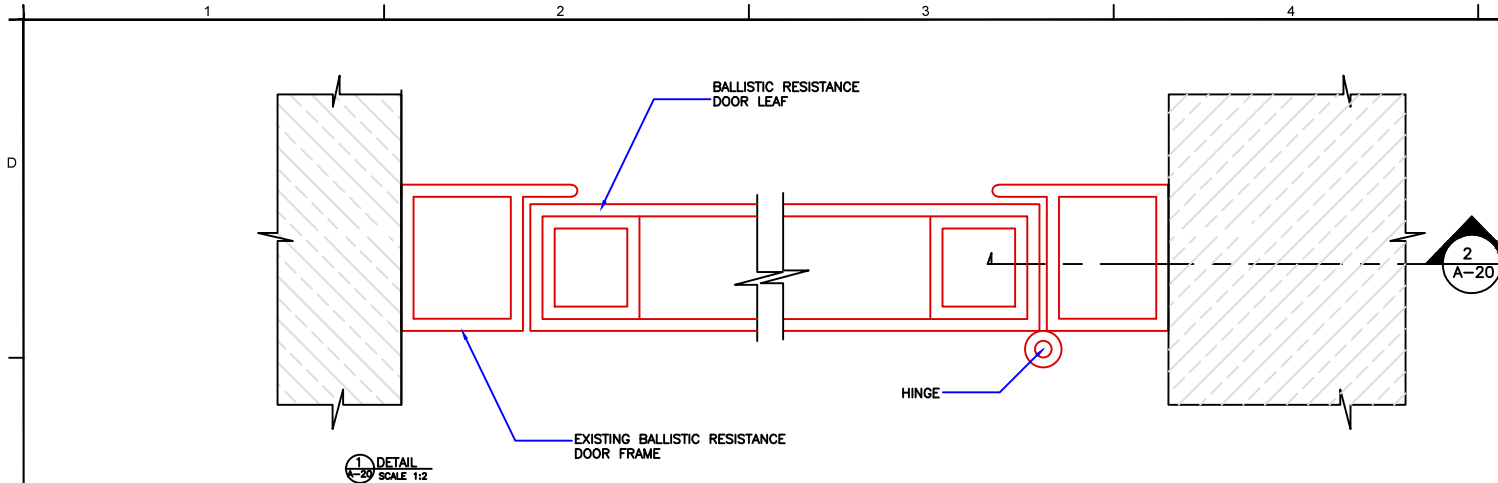EXISTING DOOR SCHEDULE


Location	Type	Size	Remarks
A	2	1.065mx 2.05 m	60 Minute Forced Entry UL 752 Level 5 Ballistic Resistant Outward swing Electronic locking mechanism (coordinate with security contractor) Finish appropriate for high use environment Clear opening 0.914 m
B	2	1.065mx 2.05 m	60 Minute Forced Entry UL 752 Level 5 Ballistic Resistant Outward swing Electronic locking mechanism (coordinate with security contractor) Finish appropriate for high use environment Clear opening 0.914 m
C	2	1.065mx 2.05 m	60 Minute Forced Entry UL 752 Level 5 Ballistic Resistant Outward swing Electronic locking mechanism (coordinate with security contractor) Finish appropriate for high use environment Clear opening 0.914 m
D	2	1.5mx 2.05 m	60 Minute Forced Entry UL 752 Level 5 Ballistic Resistant Double Leaf, Removable Central Astragal Outward swing Electronic locking mechanism (coordinate with security contractor) Finish appropriate for high use environment
E	6	4m x 3.5 m	Double swing gate ballistic hardened Double Leaf Outward swing The overall thickness of steel whether in one or two layers needs to be 14mm thick of mild steel
F	6	0.85 m x 2.05 m	Hollow metal door Single leaf, Outward swing, Electric locking mechanism (coordinate with security contractor) Finish appropriate for high use, exterior environment Provide 300mm x 300mm vision opening with laminated glass
G	6	0.85m x 2.05m	UL 752 Level 5 Ballistic Resistant Single leaf Outward swing Standard locking mechanism Finish appropriate for high use, exterior environment
K	5	1m x 2.05m	60 Minute Forced Entry UL 752 Level 5 Ballistic Resistant Single leaf Inward swing Electronic locking mechanism with unlock capabilities exterior only (coordinate with security contractor) Finish appropriate for high use, exterior environment

R.C.C.WALL

STEEL DOOR FRAME

2 SECTION  
A-20  
SCALE 1:2


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DIMENSIONS SHOWN IN  
CALLOUTS/NOTES ARE IN  
MILLIMETERS UNLESS OTHERWISE  
NOTED.

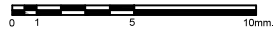

ISSUED FOR TENDER

IMPLEMENTOR		UNITED NATIONS DEVELOPMENT PROGRAM	
PROJECT: SOUTH GATE UPGRADE			
DRAWING TITLE: Heavy Duty Doors			
DESIGNED:	PROJECT NO:	DRAWING NO. A-20	REV. 0
DRAWN:	SHEET SIZE: A3		
CHECKED:	SCALE: 1:50		
APPROVED:	DATE:		



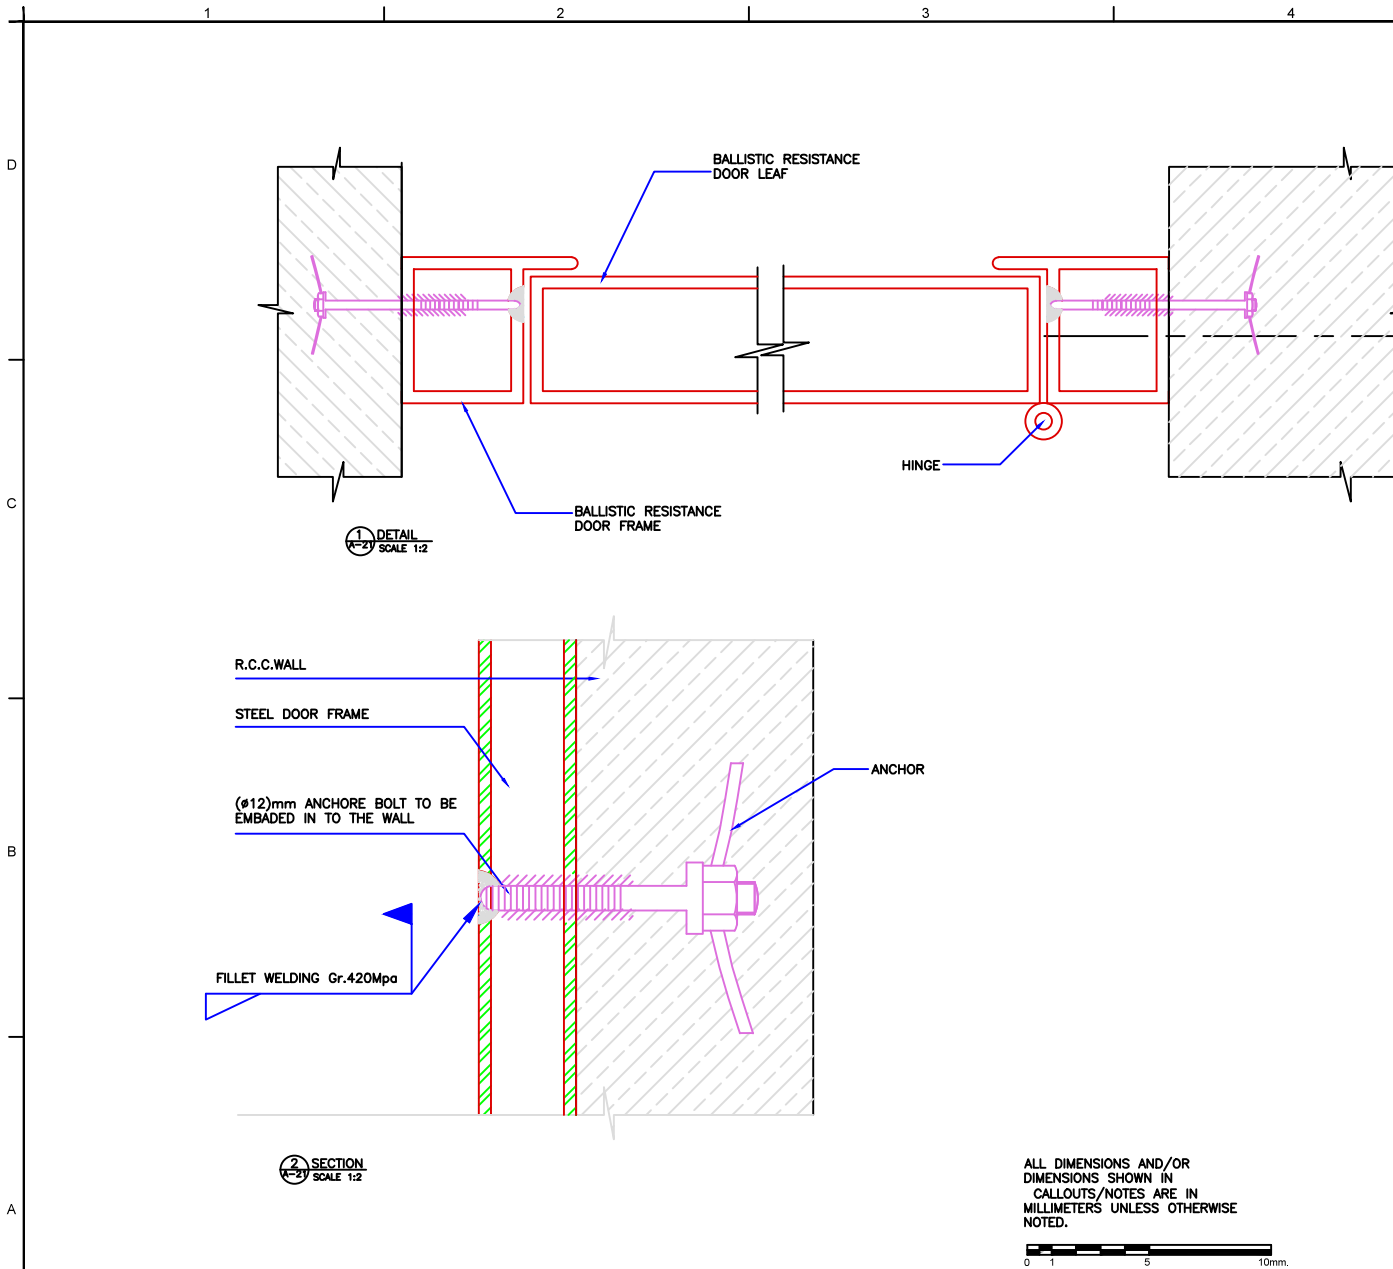

No	DATE	REVISION
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2  
A-21

#### ISSUED FOR TENDER

IMPLEMENTOR				UNITED NATIONS DEVELOPMENT PROGRAM	
PROJECT:					
DRAWING TITLE: DOORS INSTALLATION DETAILS					
DESIGNED:		PROJECT NO:		DRAWING NO.	REV.
DRAWN:		SHEET SIZE:	A3	A-21	0
CHECKED:		SCALE:	1:02		
APPROVED:		DATE:			

