


EXISTING PARTITION WALL - TO BE DEMOLISHED






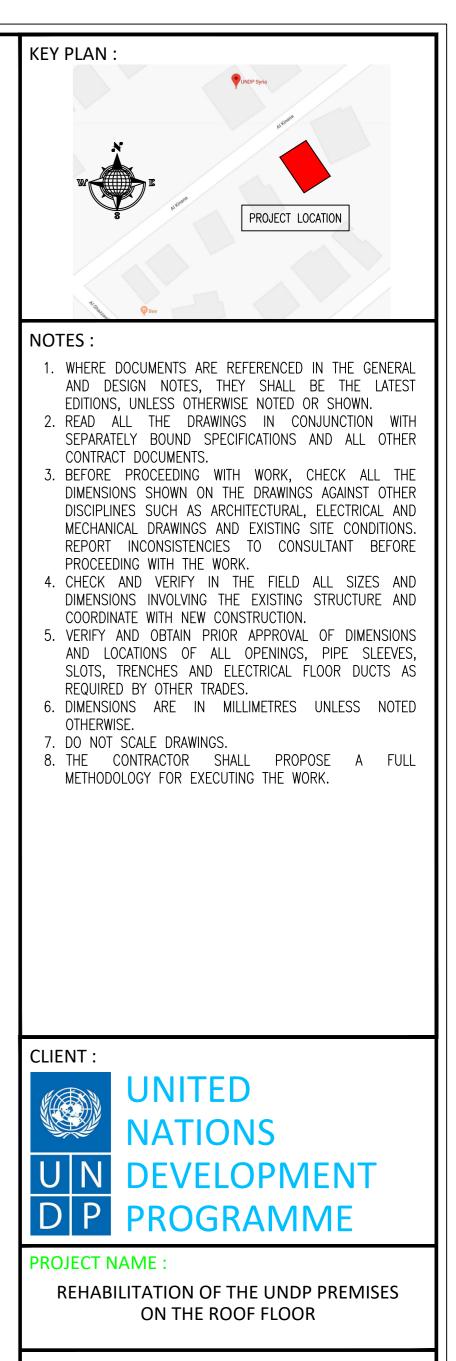


DRAWING TITLE :

ROOF PLAN LAYOUT - AS-BUILT


DESIGNED BY:	A.H.	DRAWING NO. :	A-100
APPROVED BY:	A.A.R.	SCALE :	1:50
DATE:	15/09/2018	REV NO. :	00

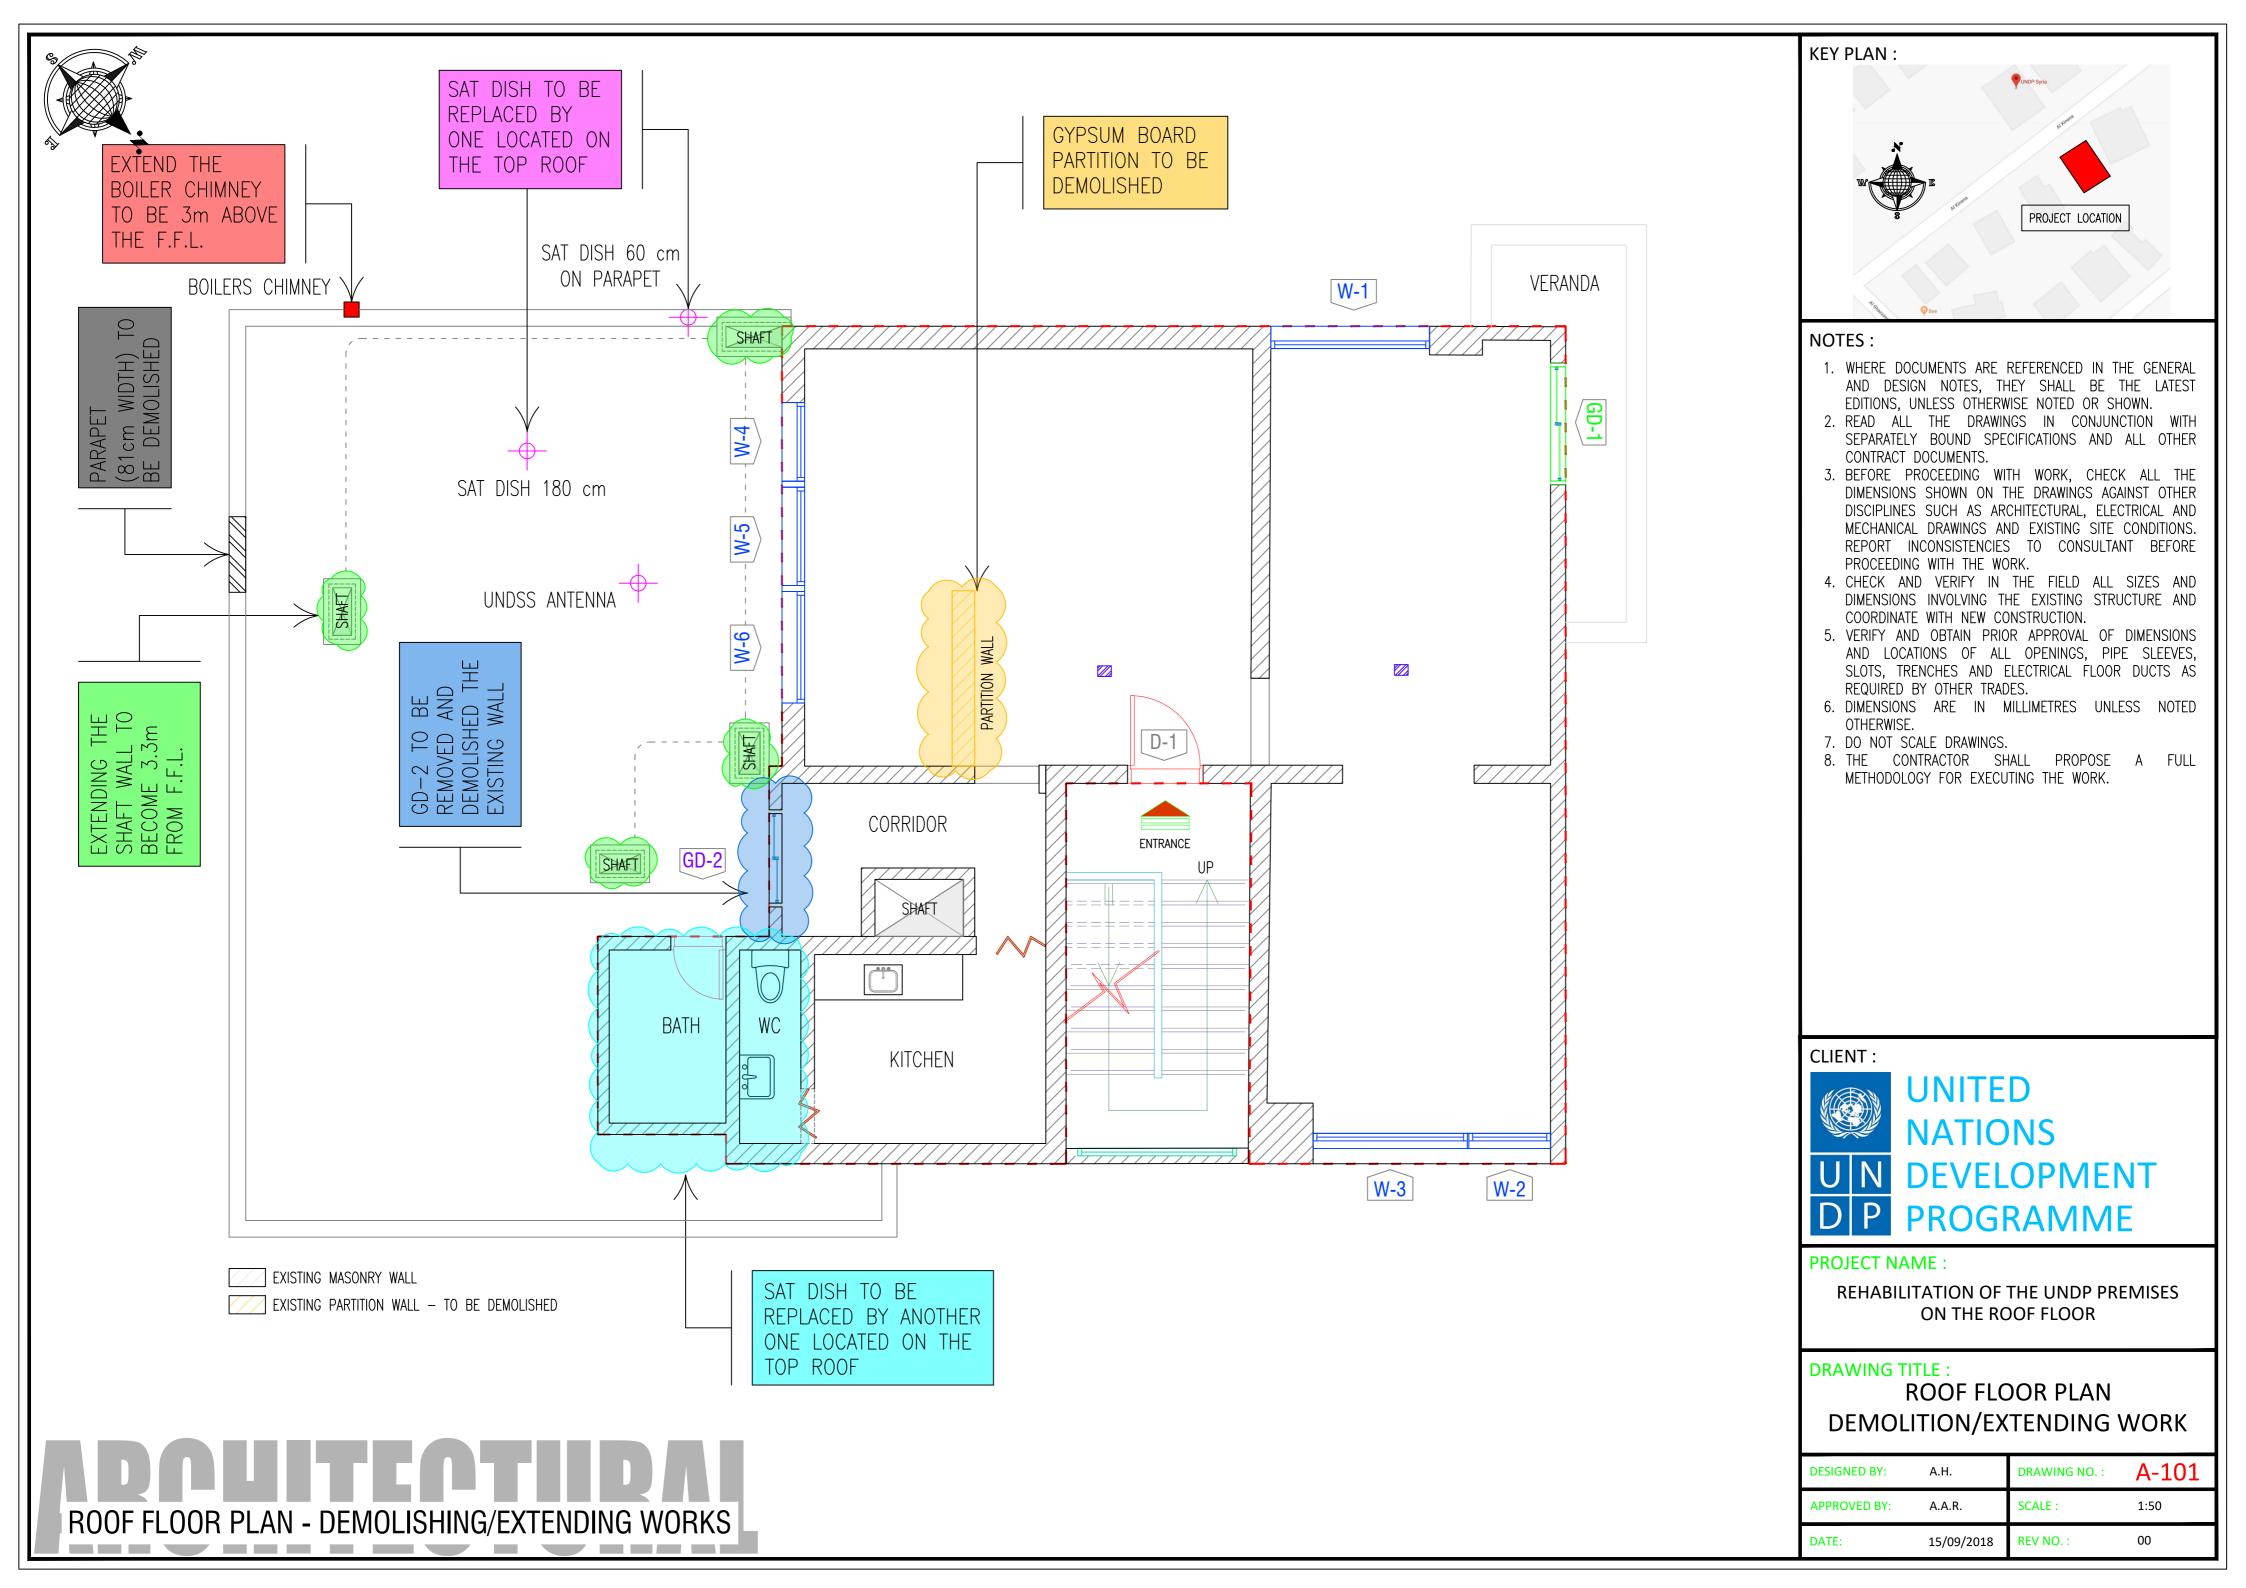

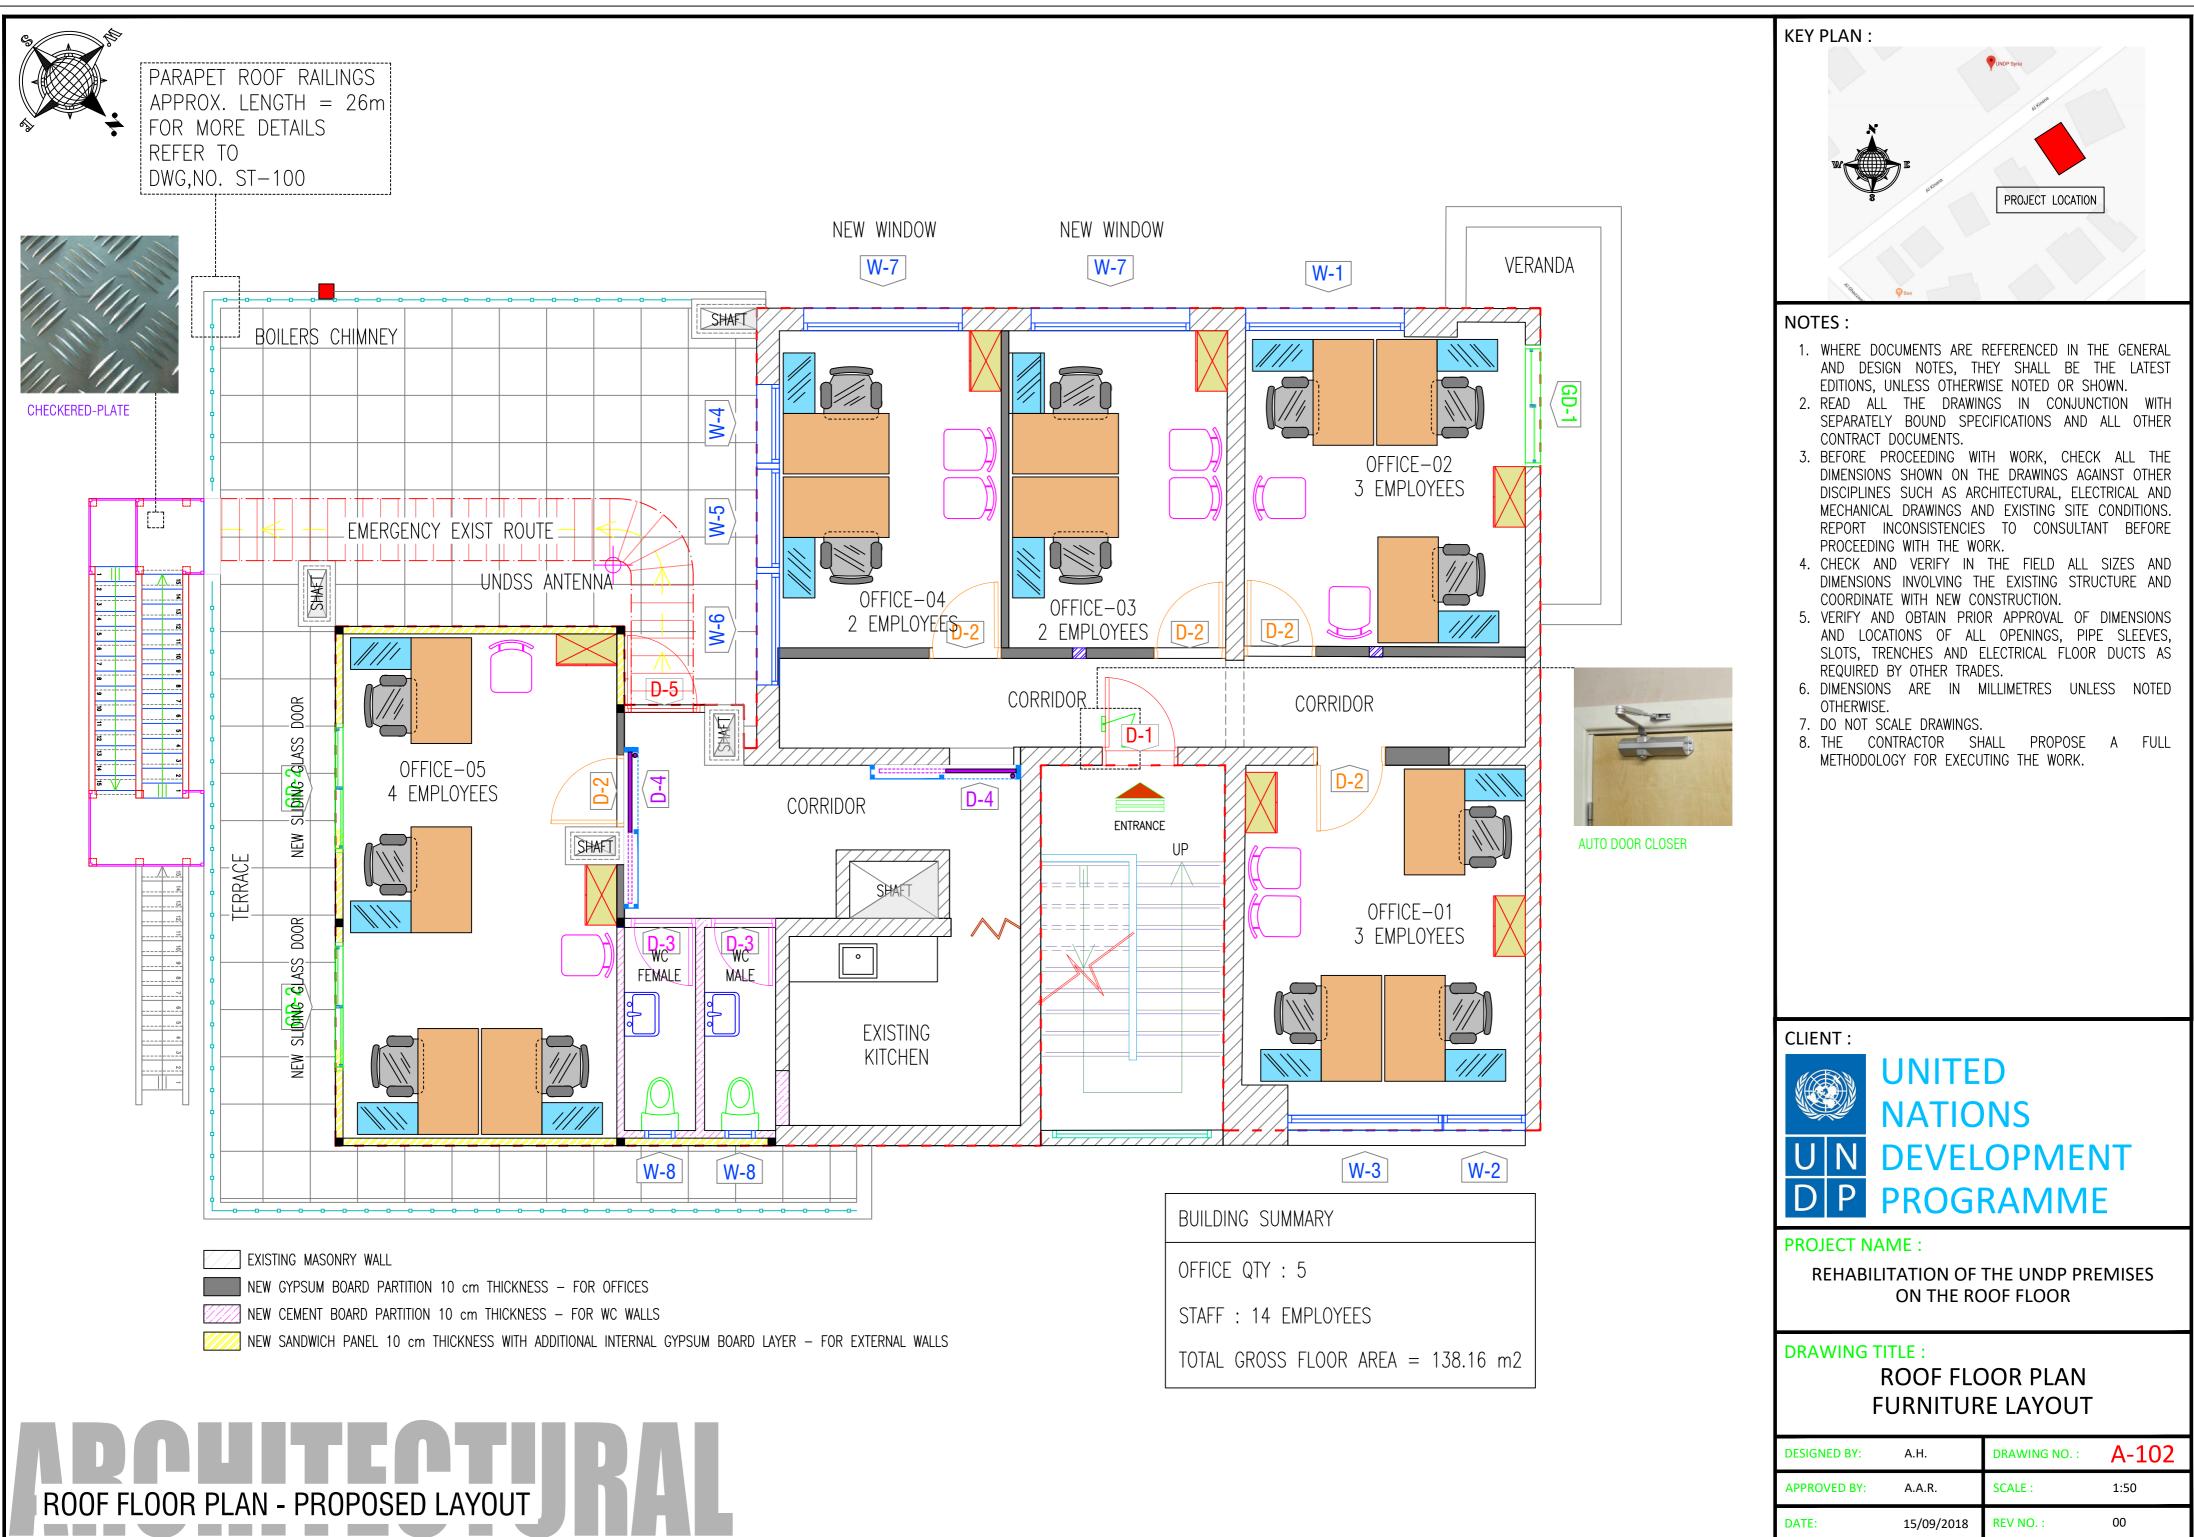

DESIGNED BY:	A.H.	DRAWING NO. :	A-102
APPROVED BY:	A.A.R.	SCALE :	1:50
DATE:	15/09/2018	REV NO. :	00



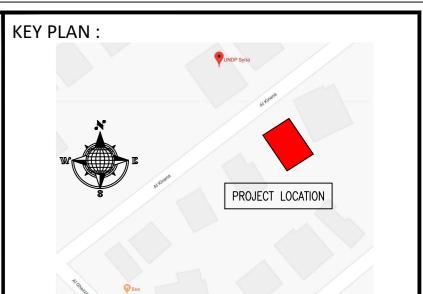

NOTES :

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CLIENT :




PROJECT NAME :


REHABILITATION OF THE UNDP PREMISES ON THE ROOF FLOOR


DRAWING TITLE :

ROOF FLOOR PLAN 3D PERSPECTIVES


DESIGNED BY:	A.H.	DRAWING NO. :	A-103
APPROVED BY:	A.A.R.	SCALE :	1:50
DATE:	15/09/2018	REV NO. :	00

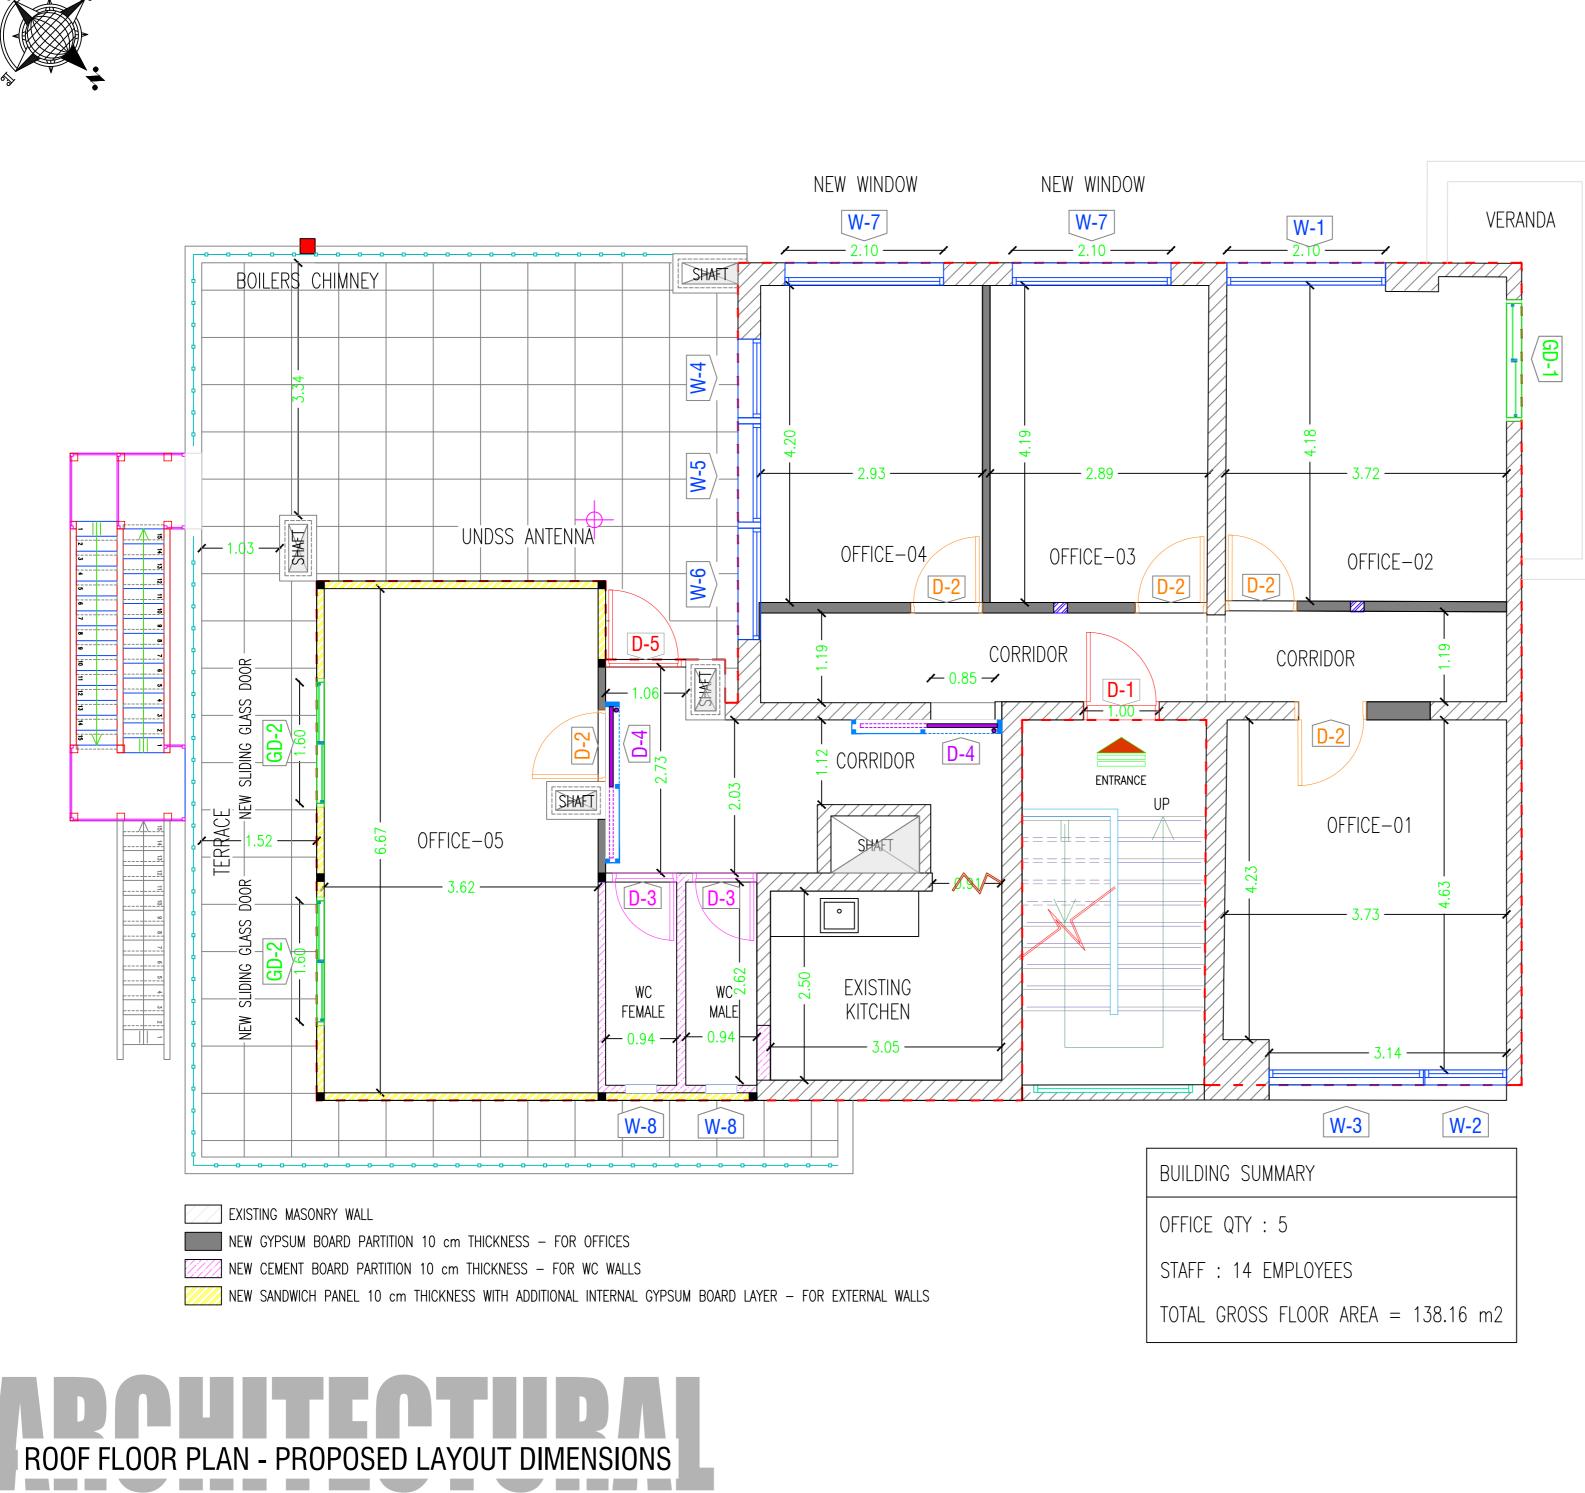


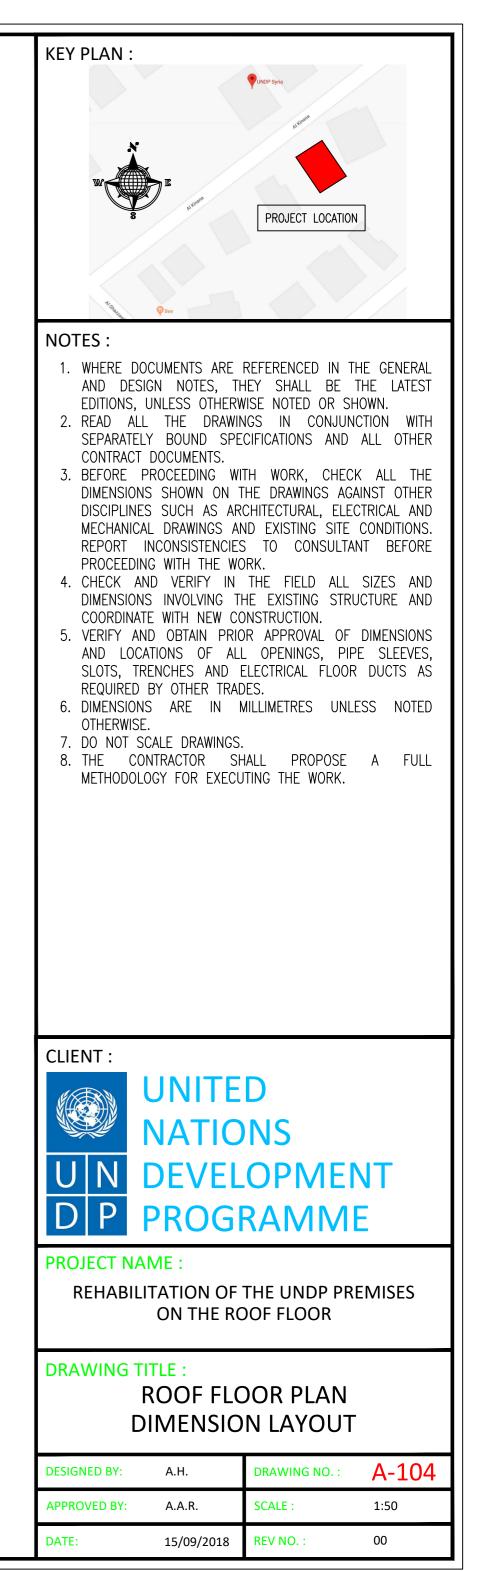

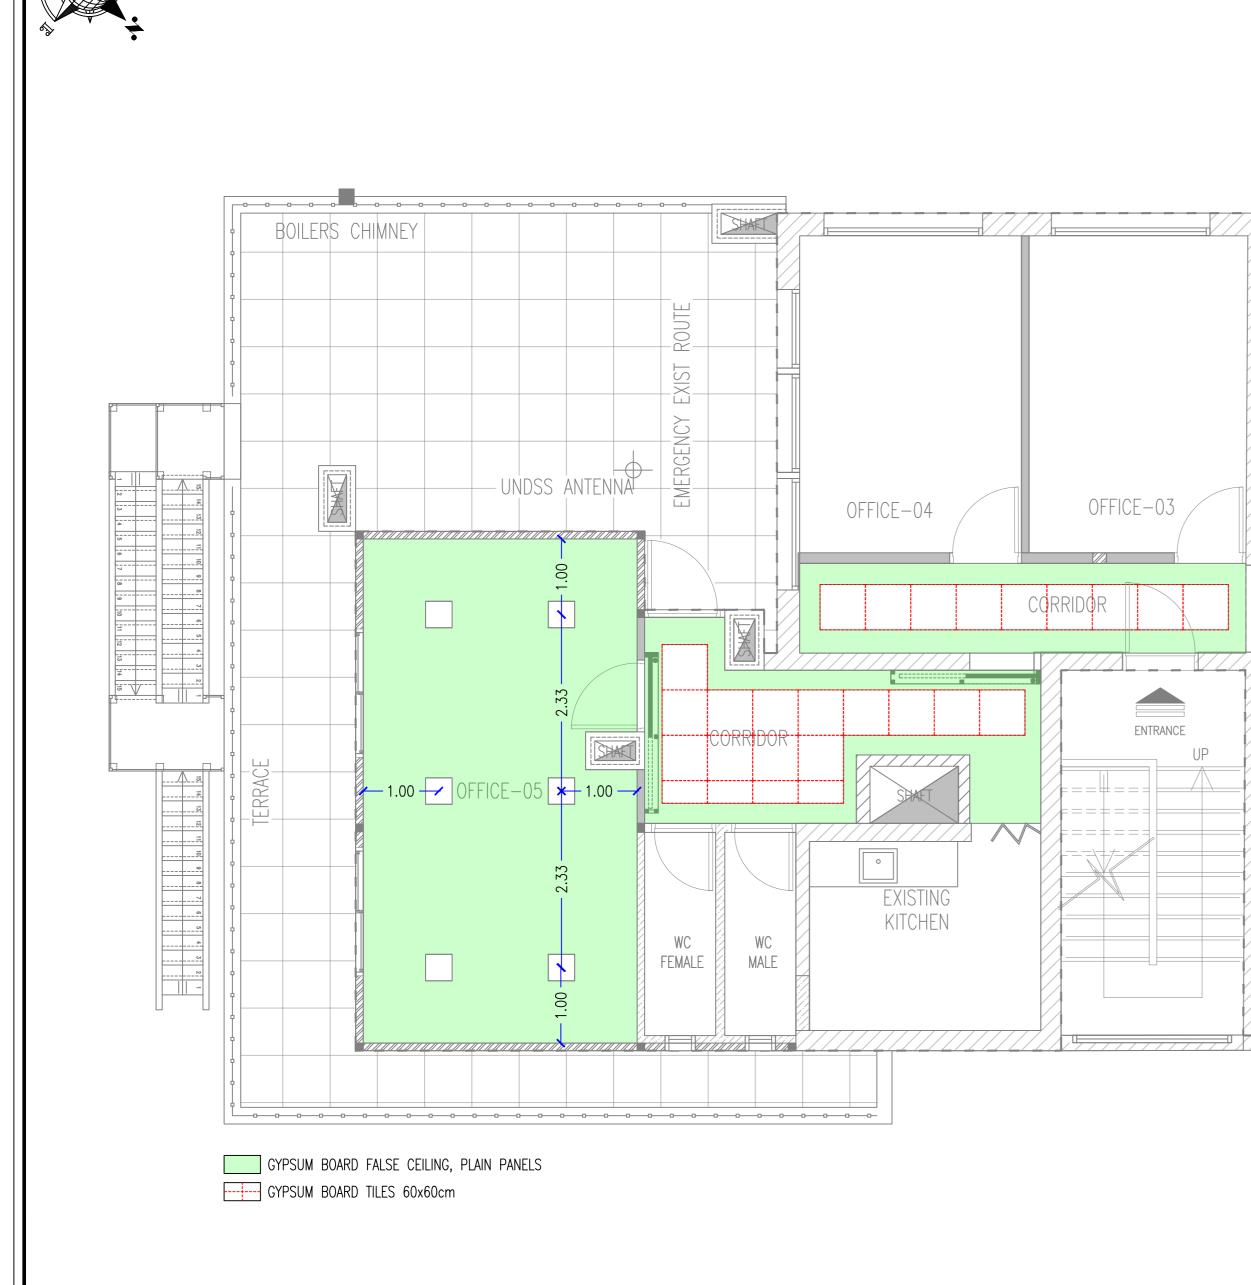



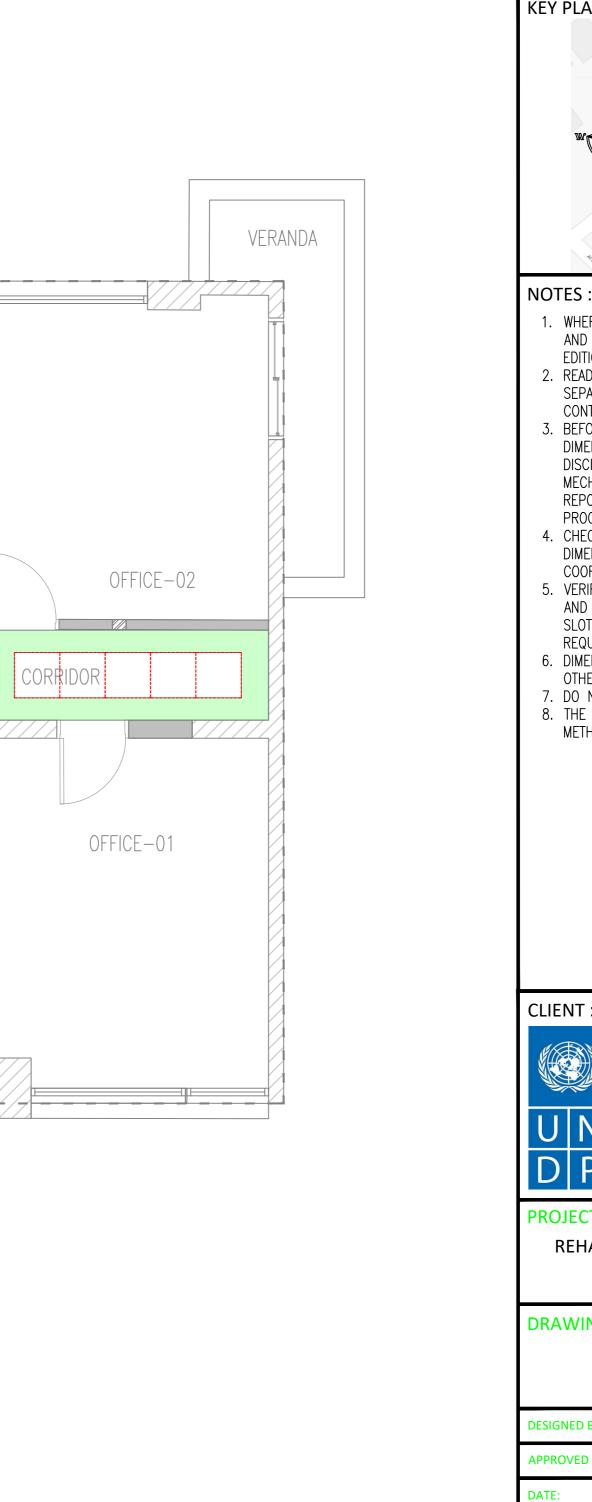


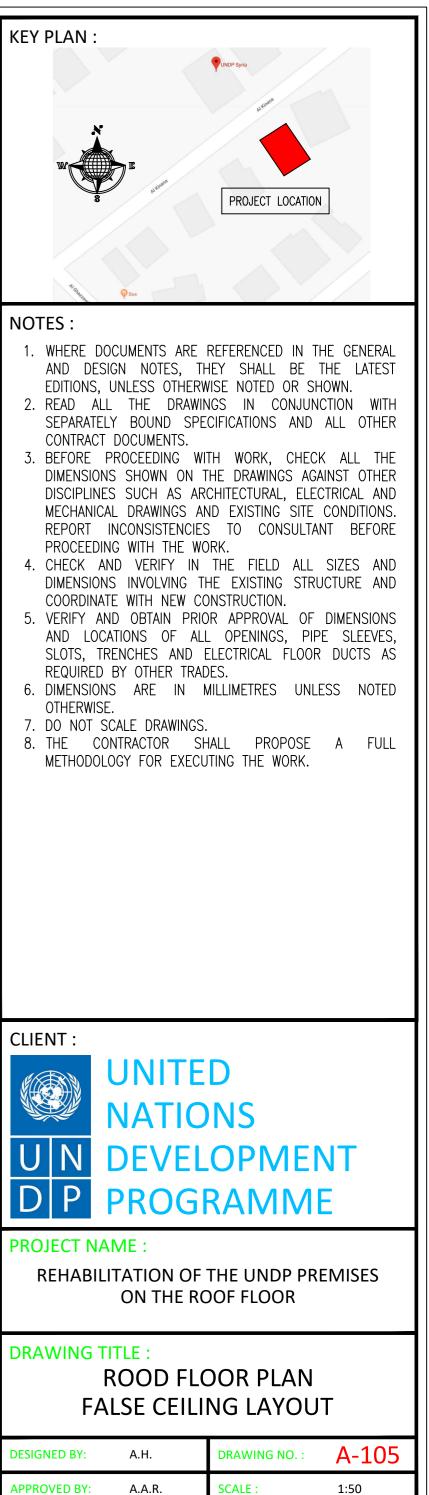

15/09/2018


REV NO. :

00

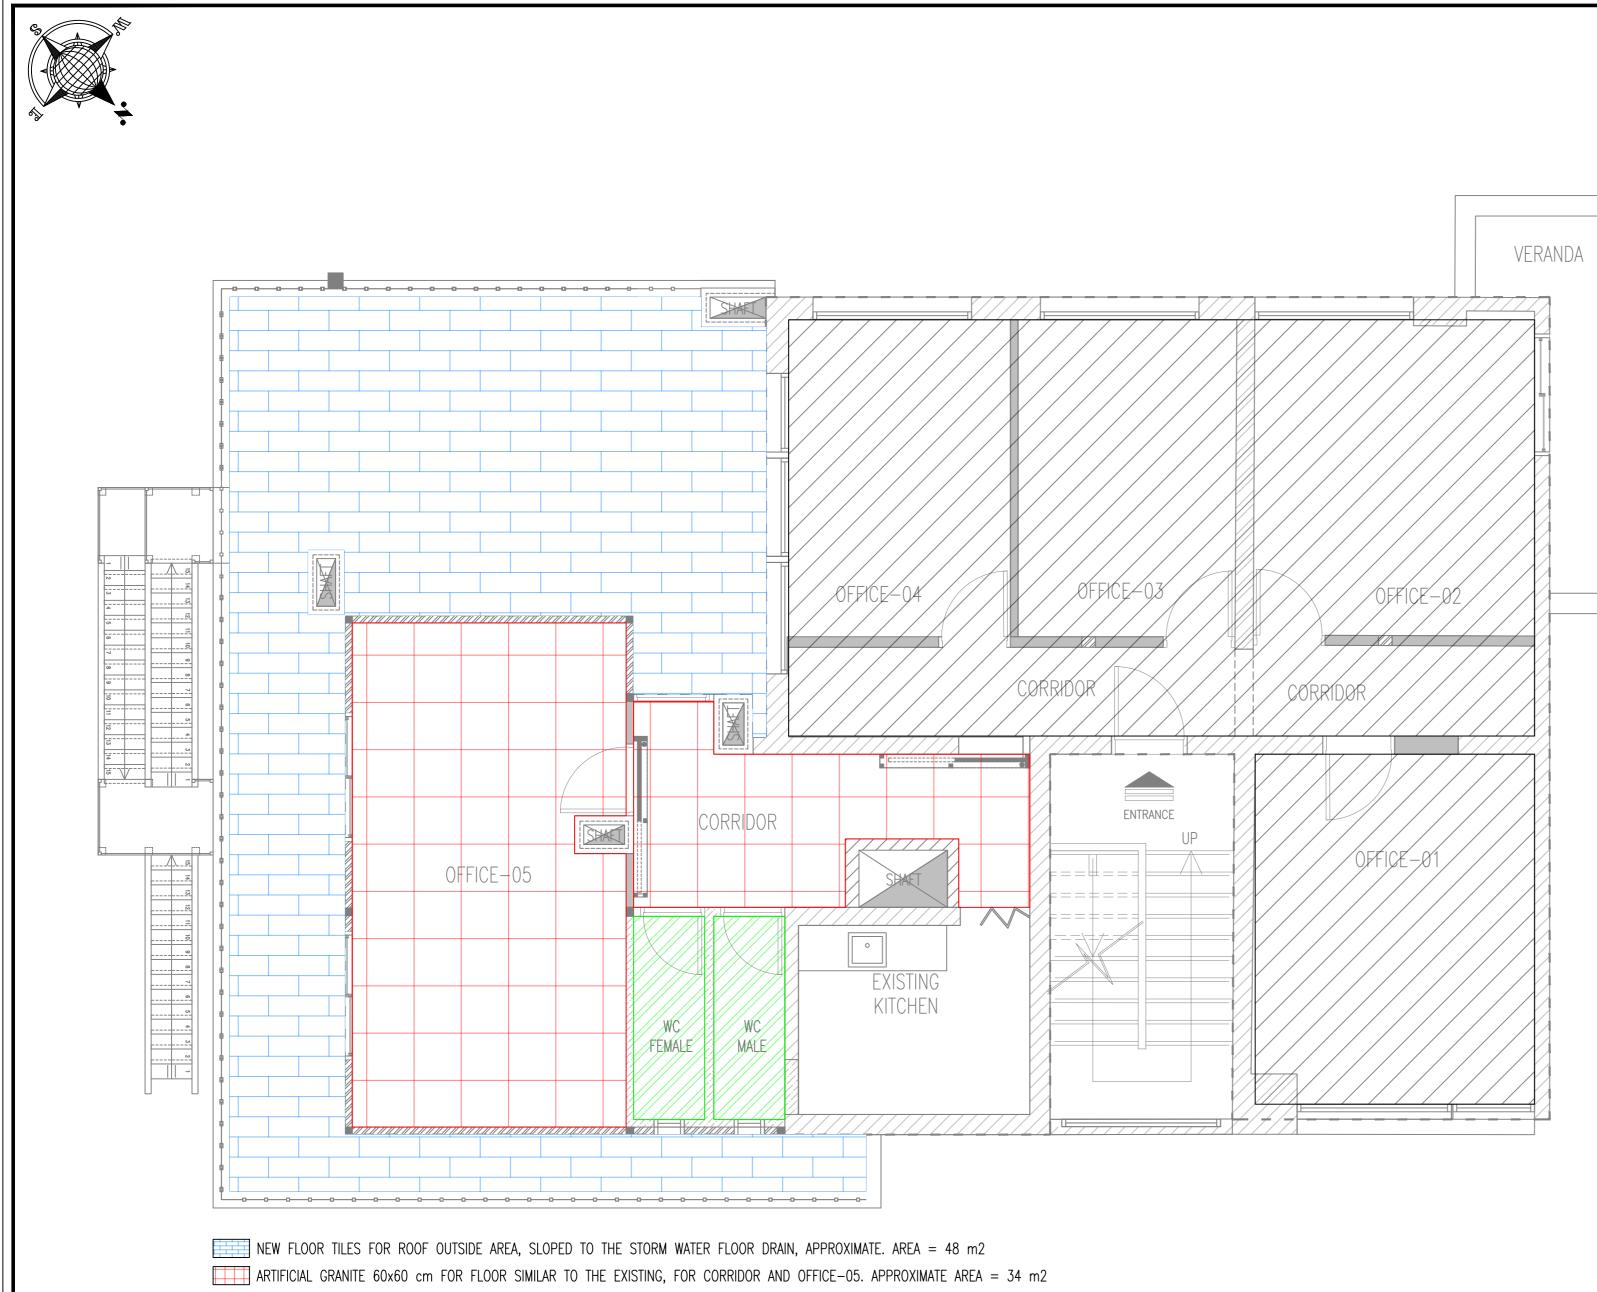


ARTIFICIAL GRANITE 60x60 cm FOR FLOOR SIMILAR TO THE EXISTING, FOR CORRIDOR AND OFFICE-05. APPROXIMATE AREA = 34 m2 CERAMIC FLOOR TILES, SPECIFIED DIMENSION AS THE APPROVED SAMPLES PROVIDED BY THE CONTRACTOR. APPROXIMATE ARE = 5 m2 EXISTING FLOORING AREA, REMAINS AS IT IS, UNLESS MAINTENANCE IS REQUIRED.




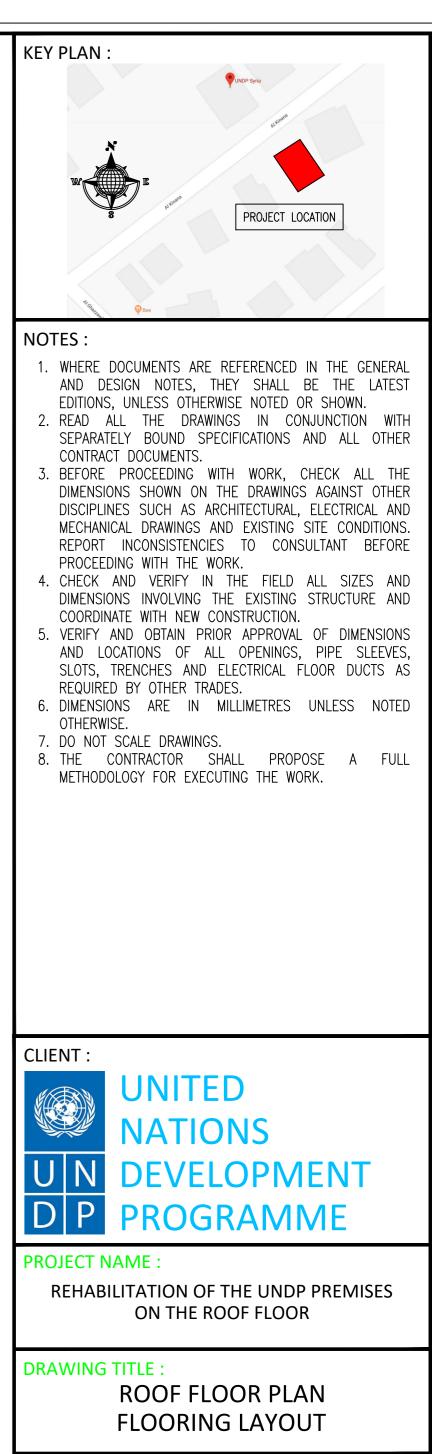


DESIGNED BY:	A.H.	DRAWING NO. :	A-106
APPROVED BY:	A.A.R.	SCALE :	1:50
DATE:	15/09/2018	REV NO. :	00

NOTE: THE SANDWICH PANEL ROOF SHALL BE OFFSET FROM THE BUILDING BOUNDARY WITH 30cm

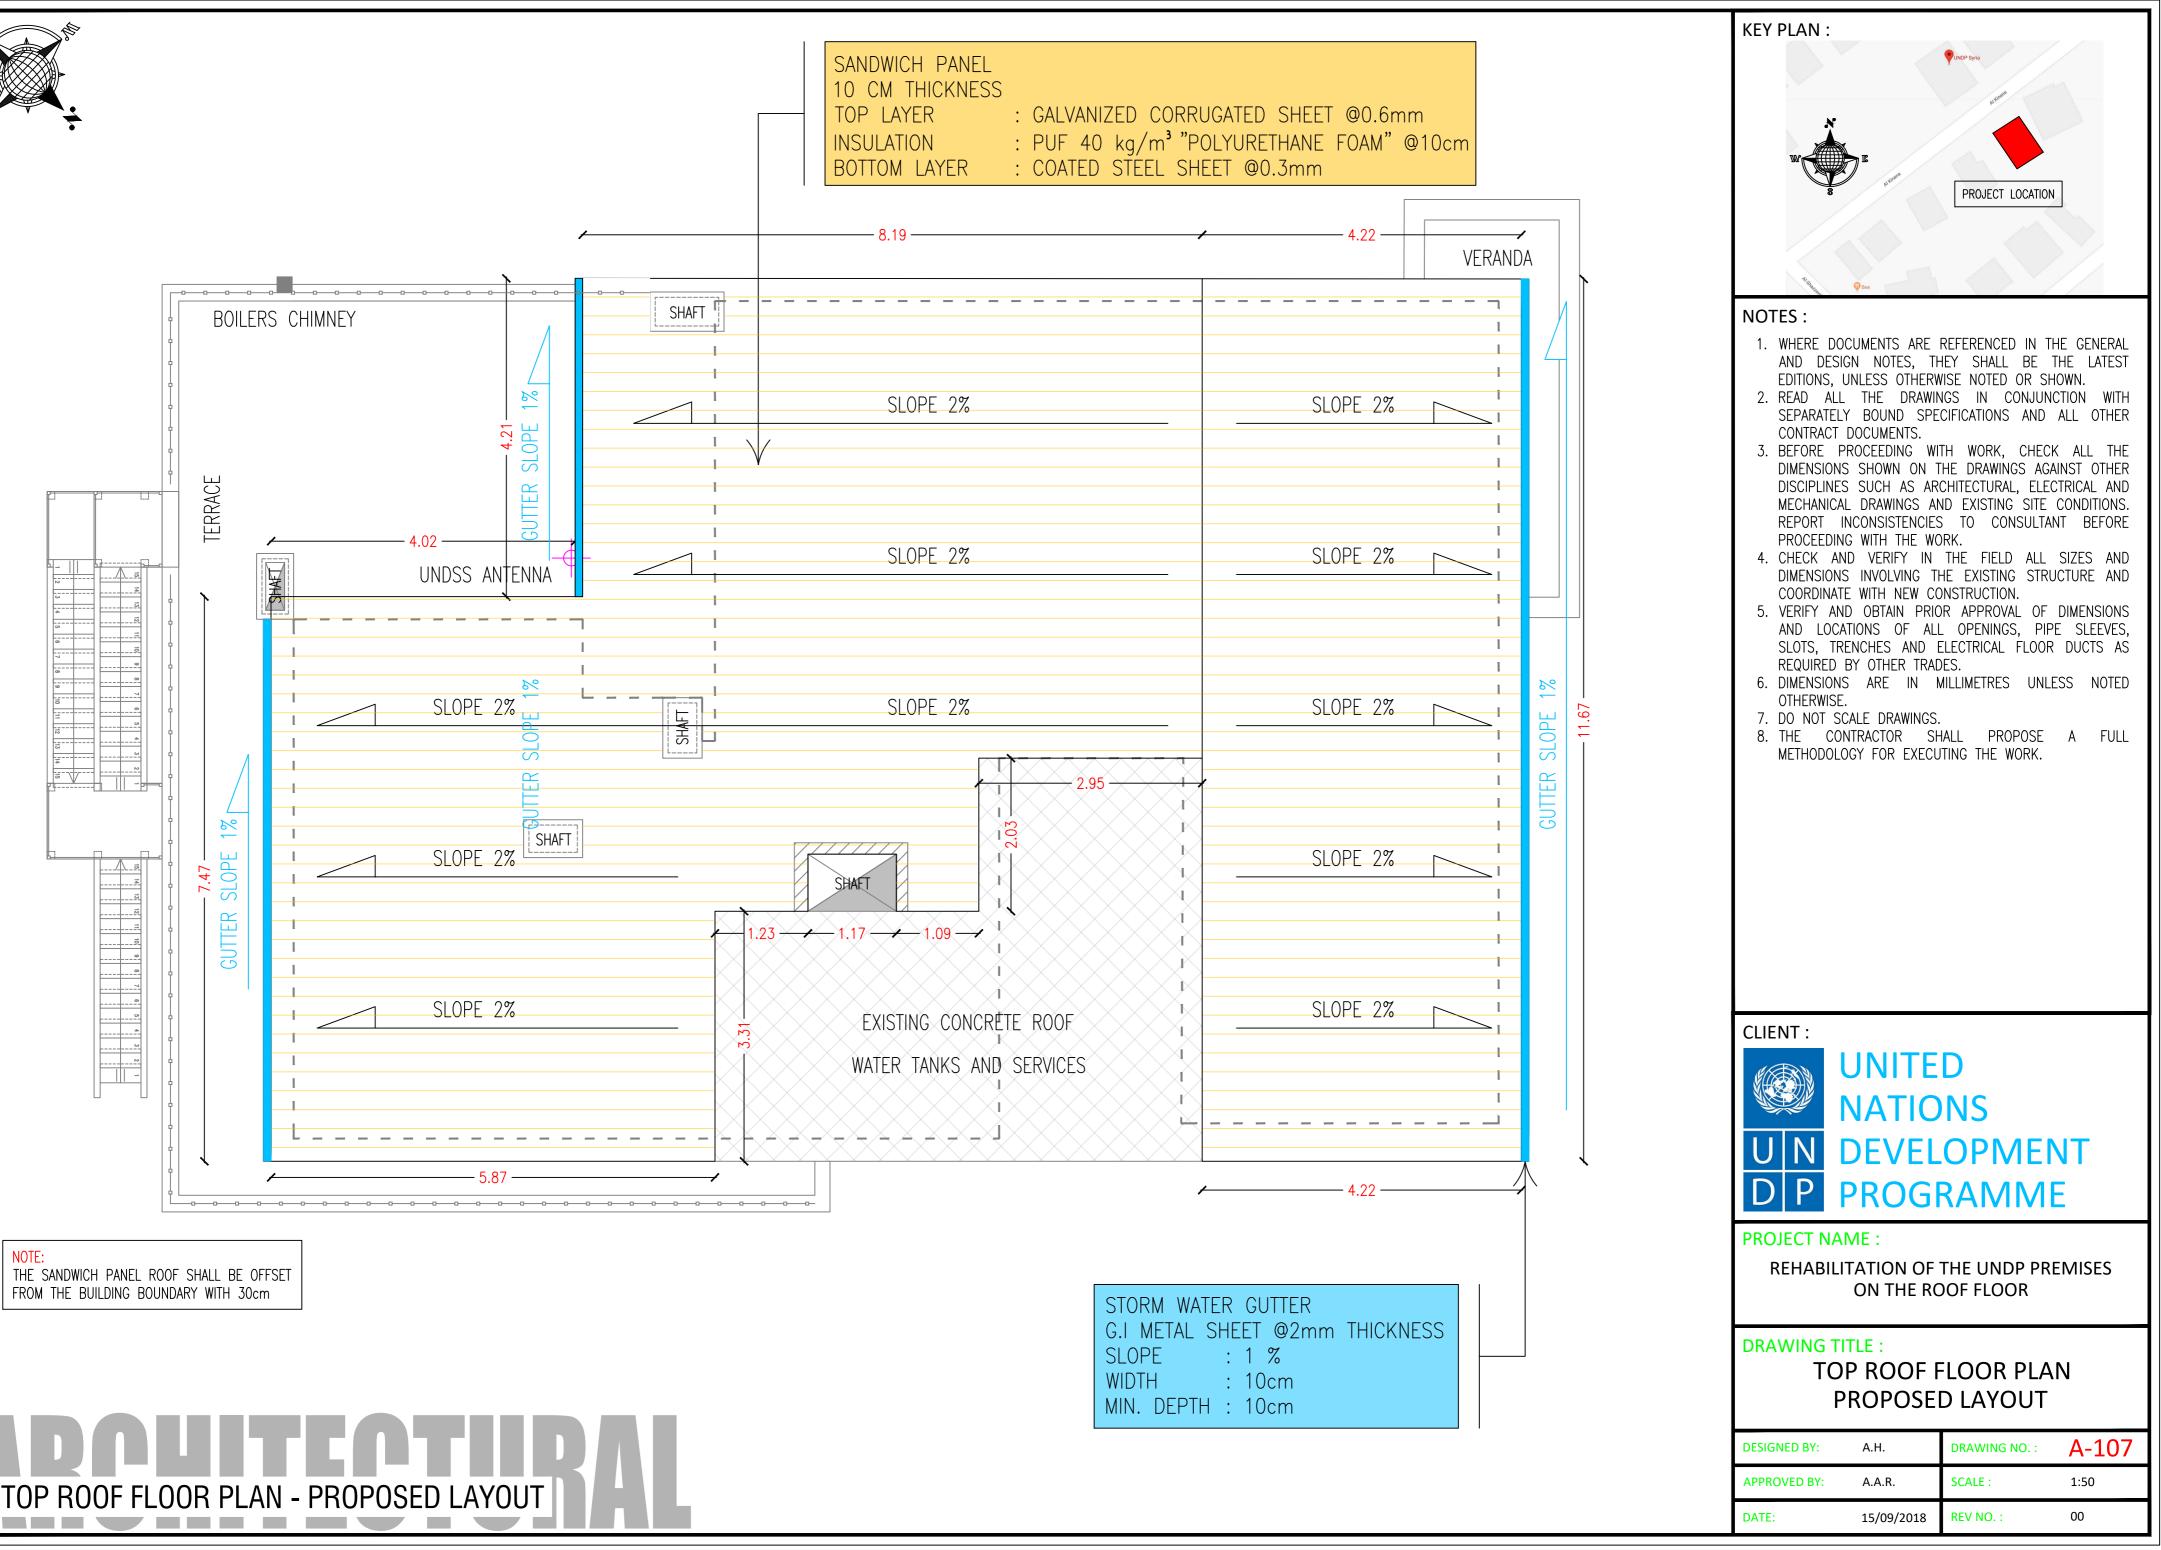


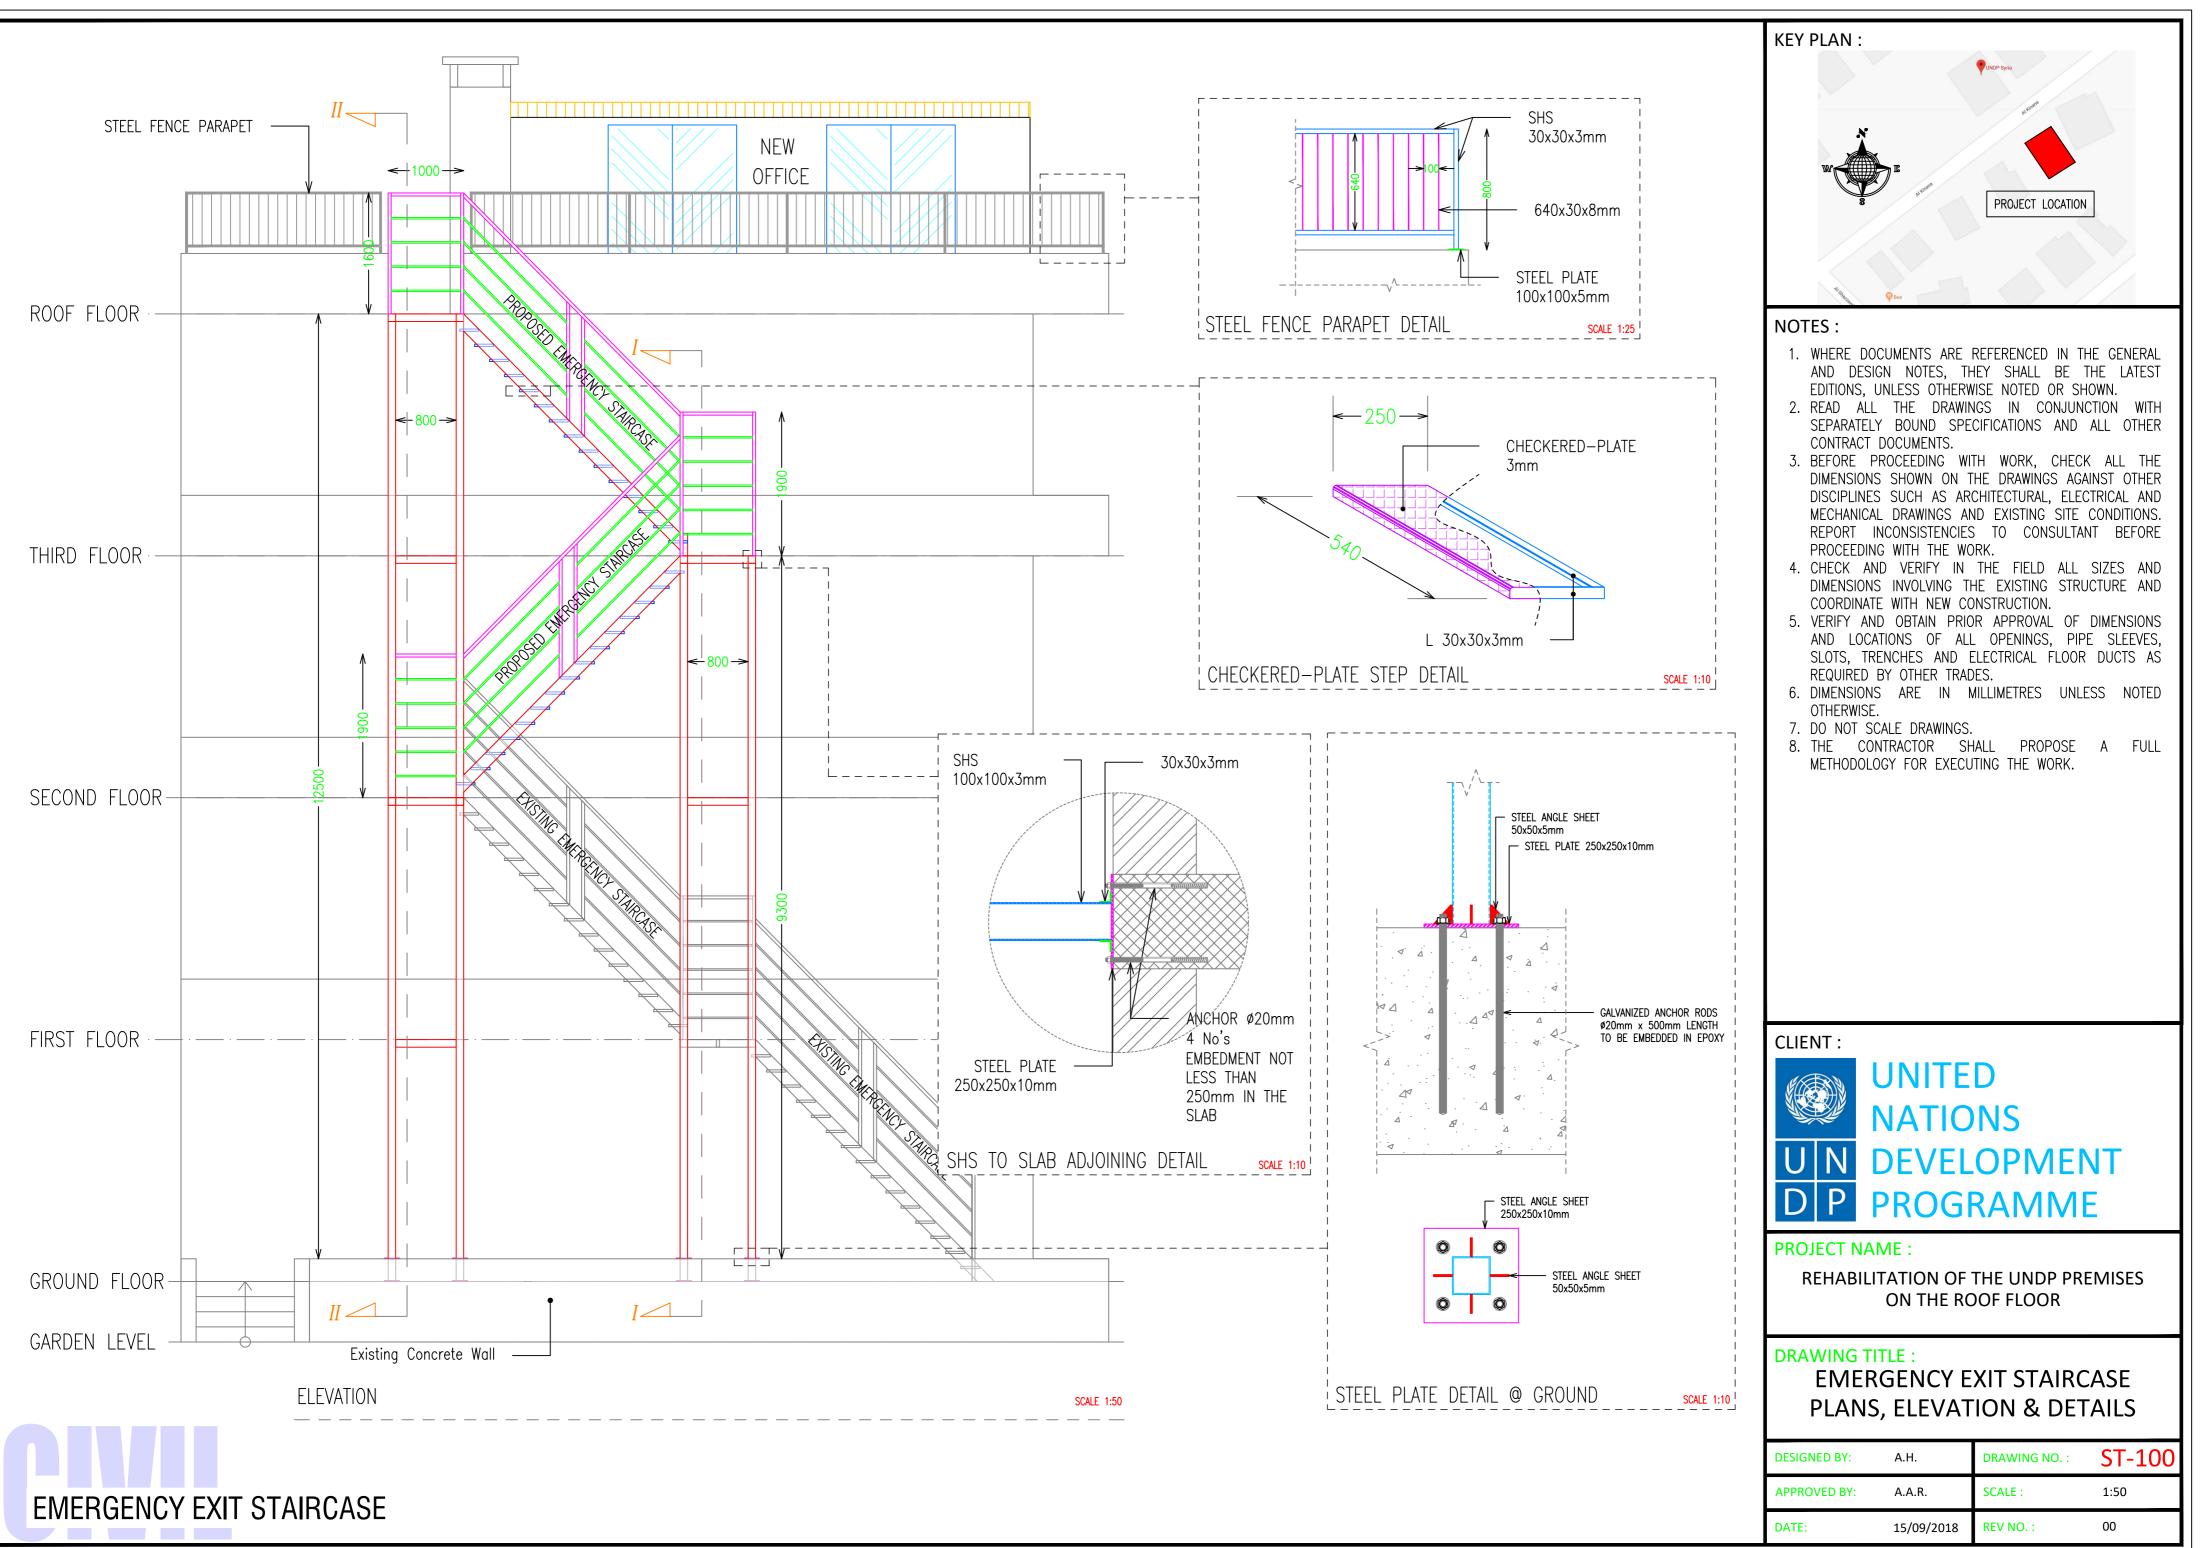

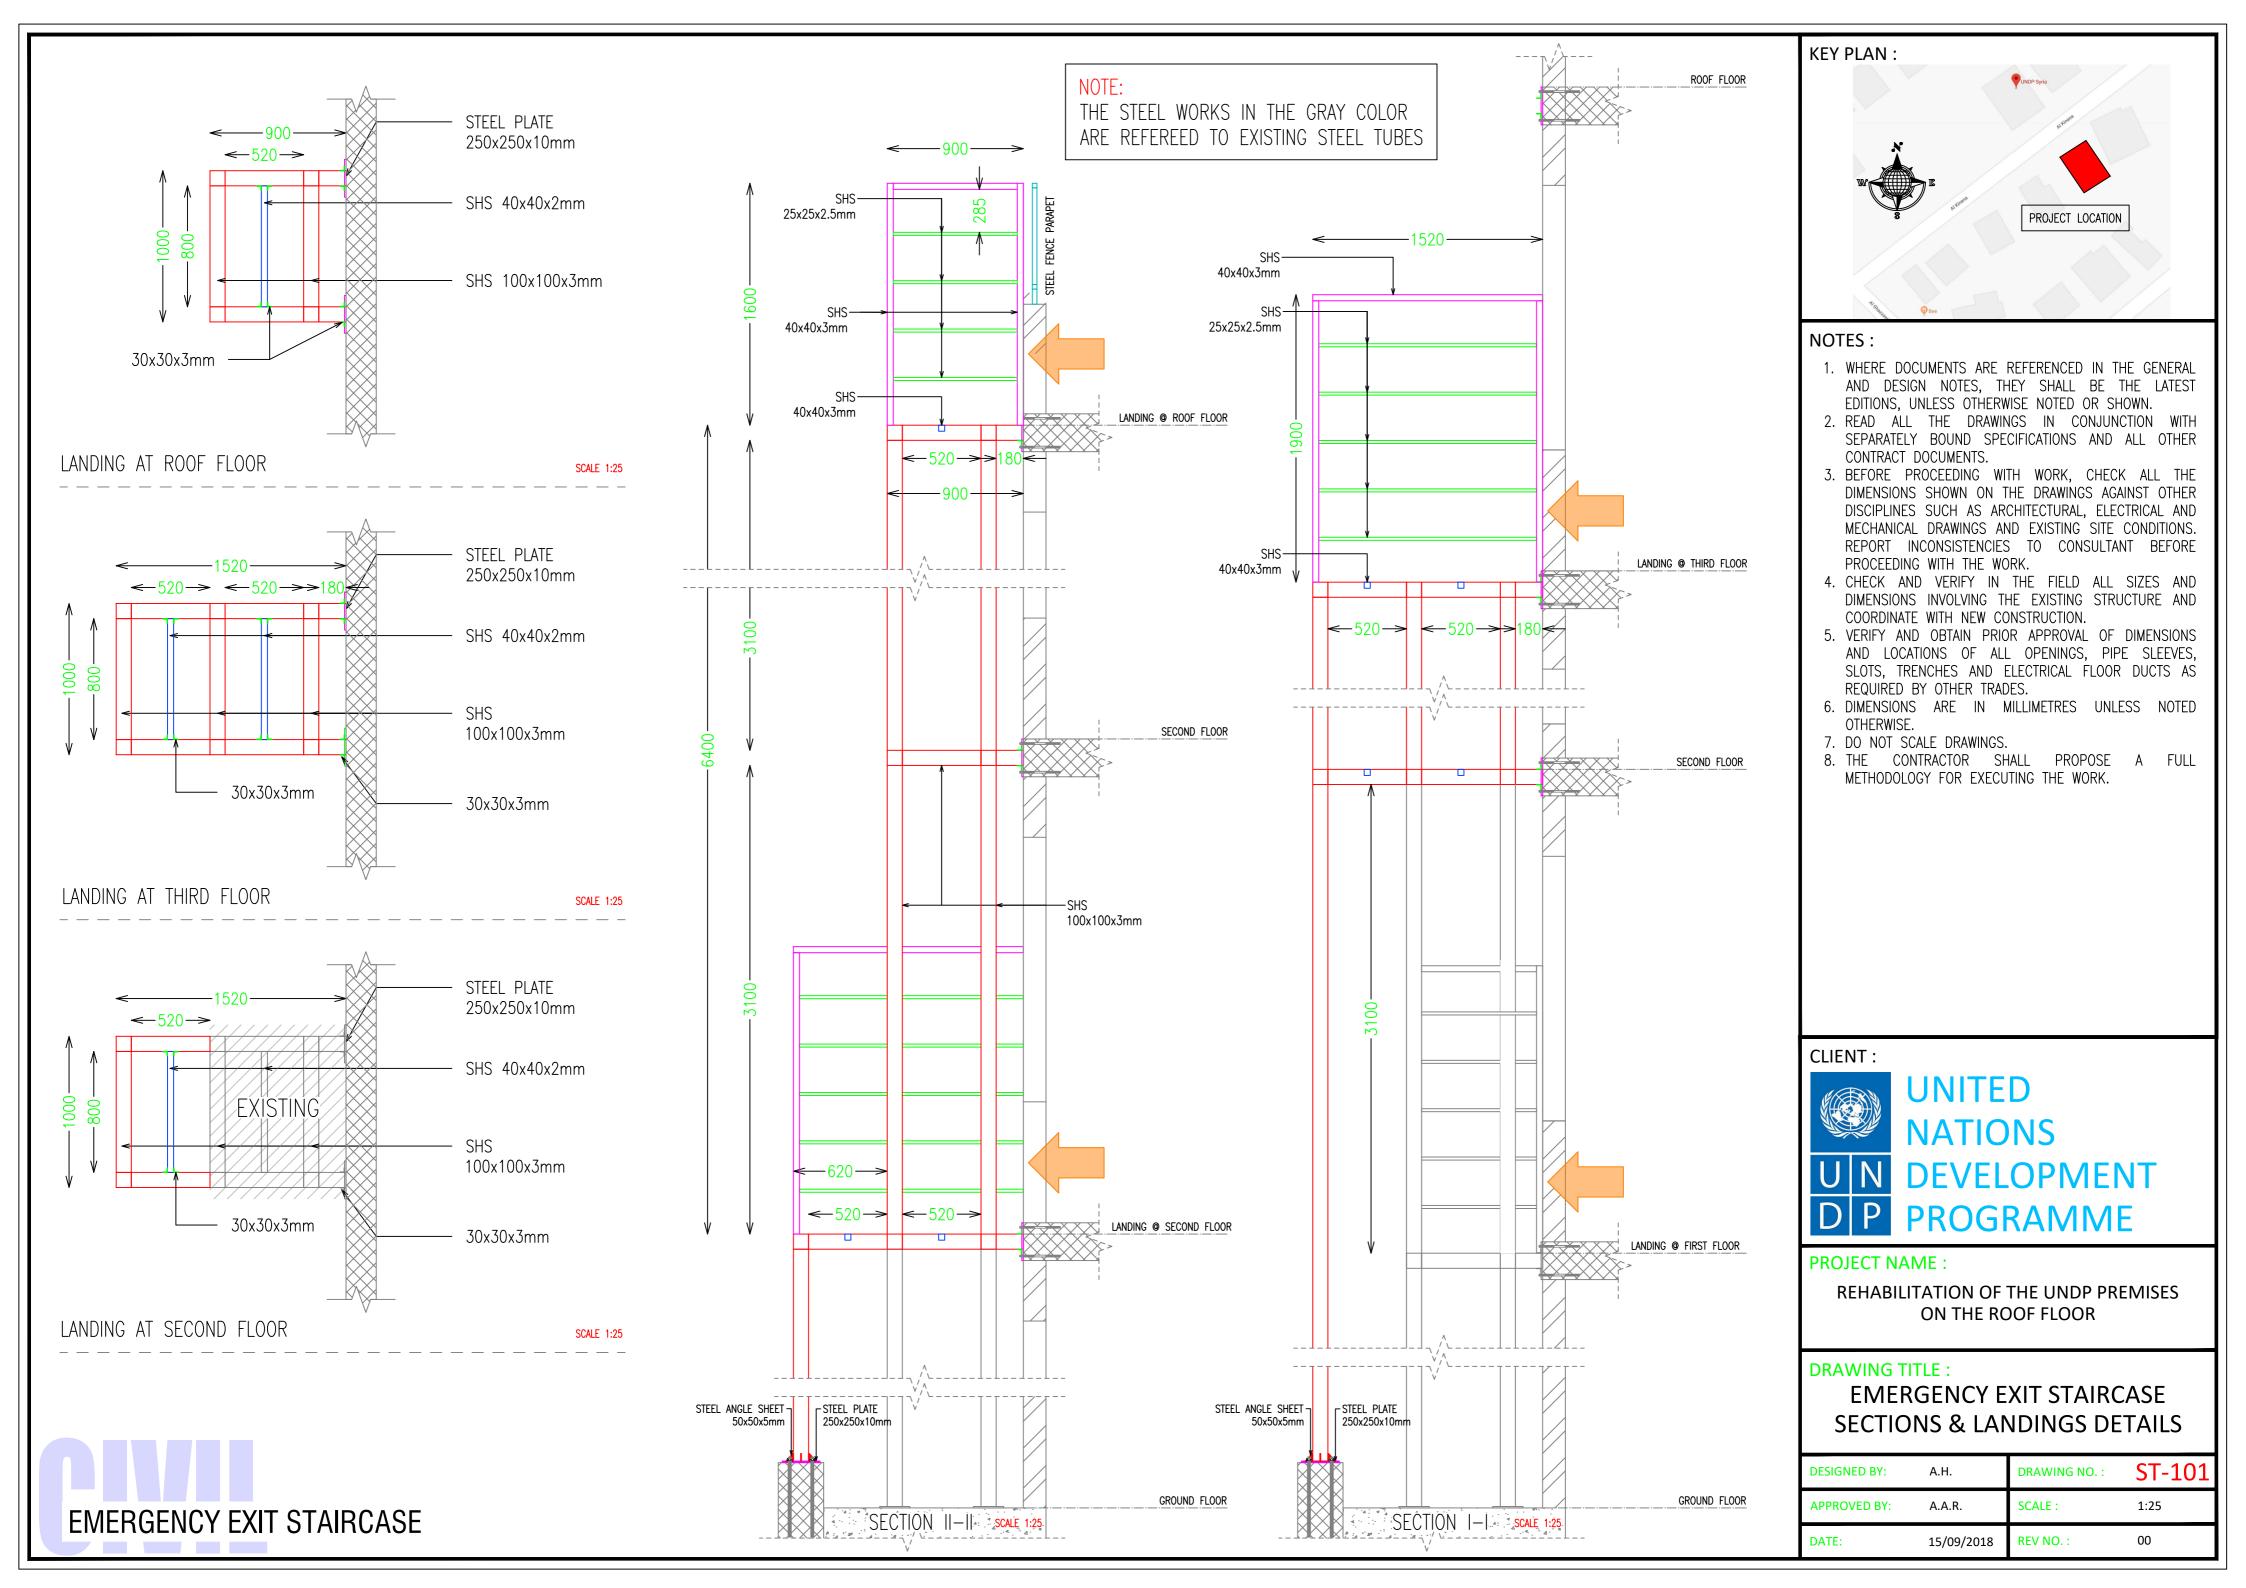





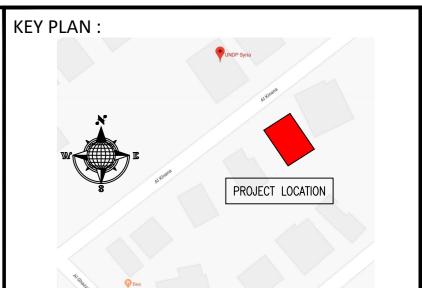

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CLIENT :





PROJECT NAME :

REHABILITATION OF THE UNDP PREMISES ON THE ROOF FLOOR

DRAWING TITLE : EMERGENCY EXIT STAIRCASE 3D PERSPECTIVES

DESIGNED BY:	A.H.	DRAWING NO. :	ST-102
APPROVED BY:	A.A.R.	SCALE :	1:25
DATE:	15/09/2018	REV NO. :	00

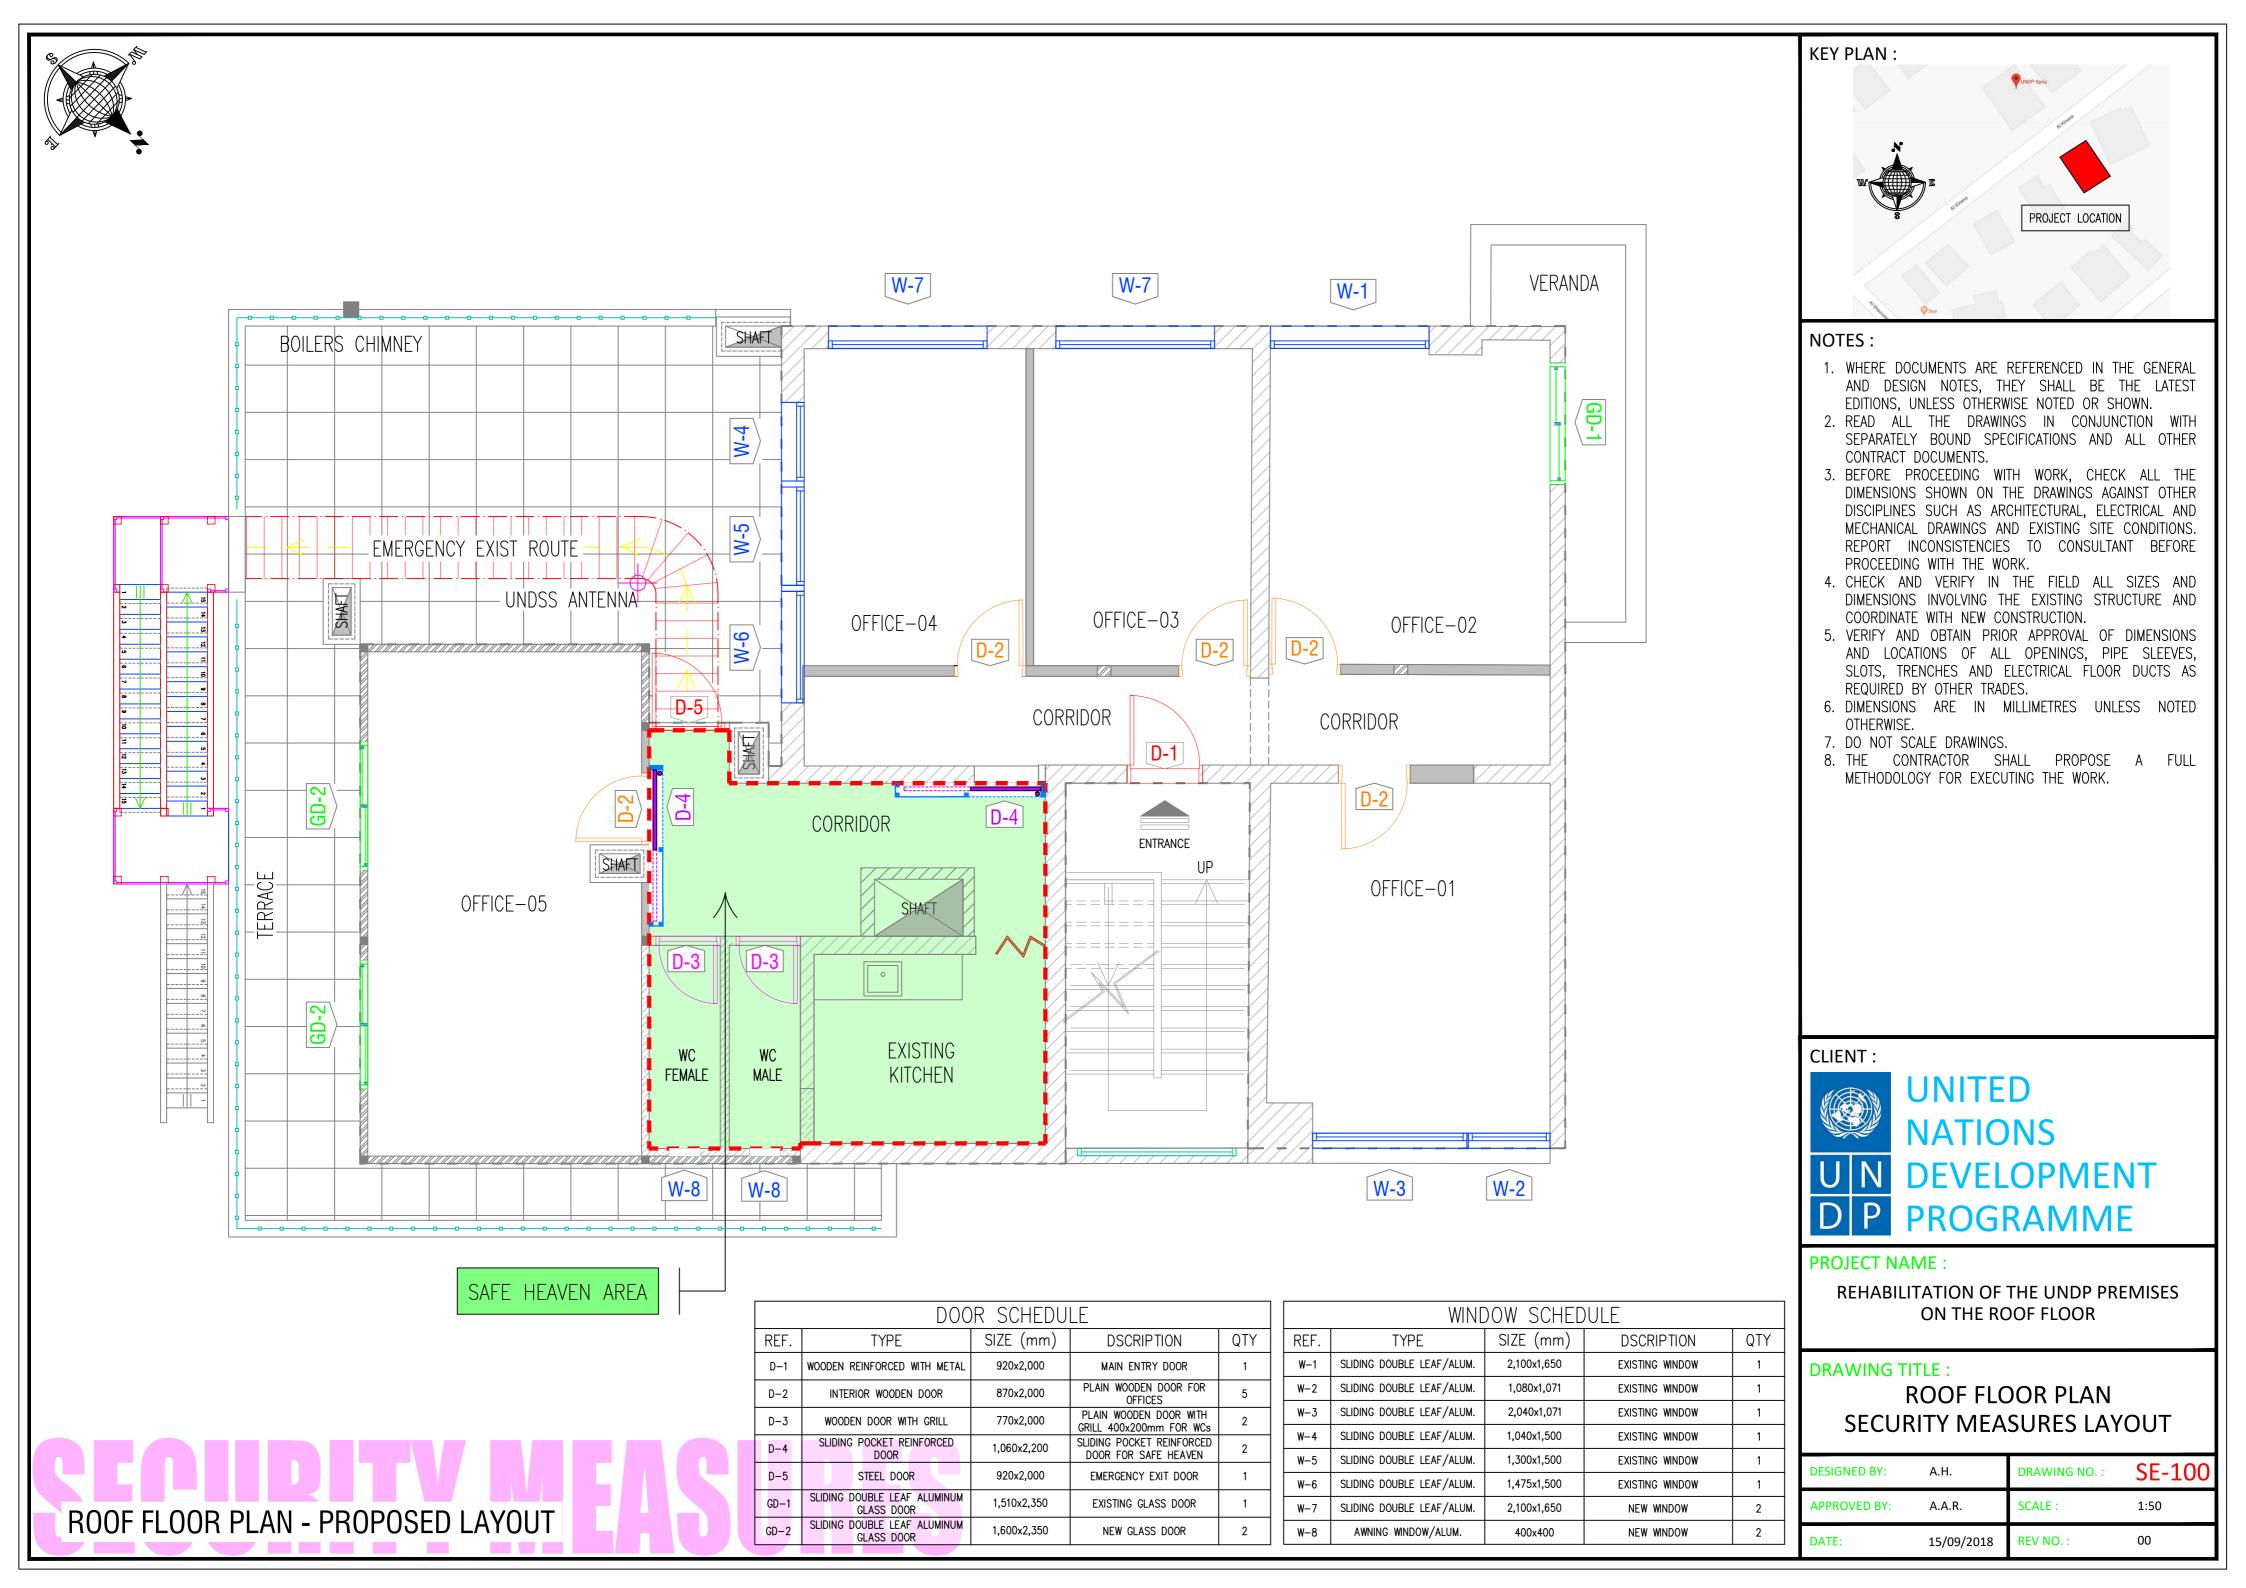


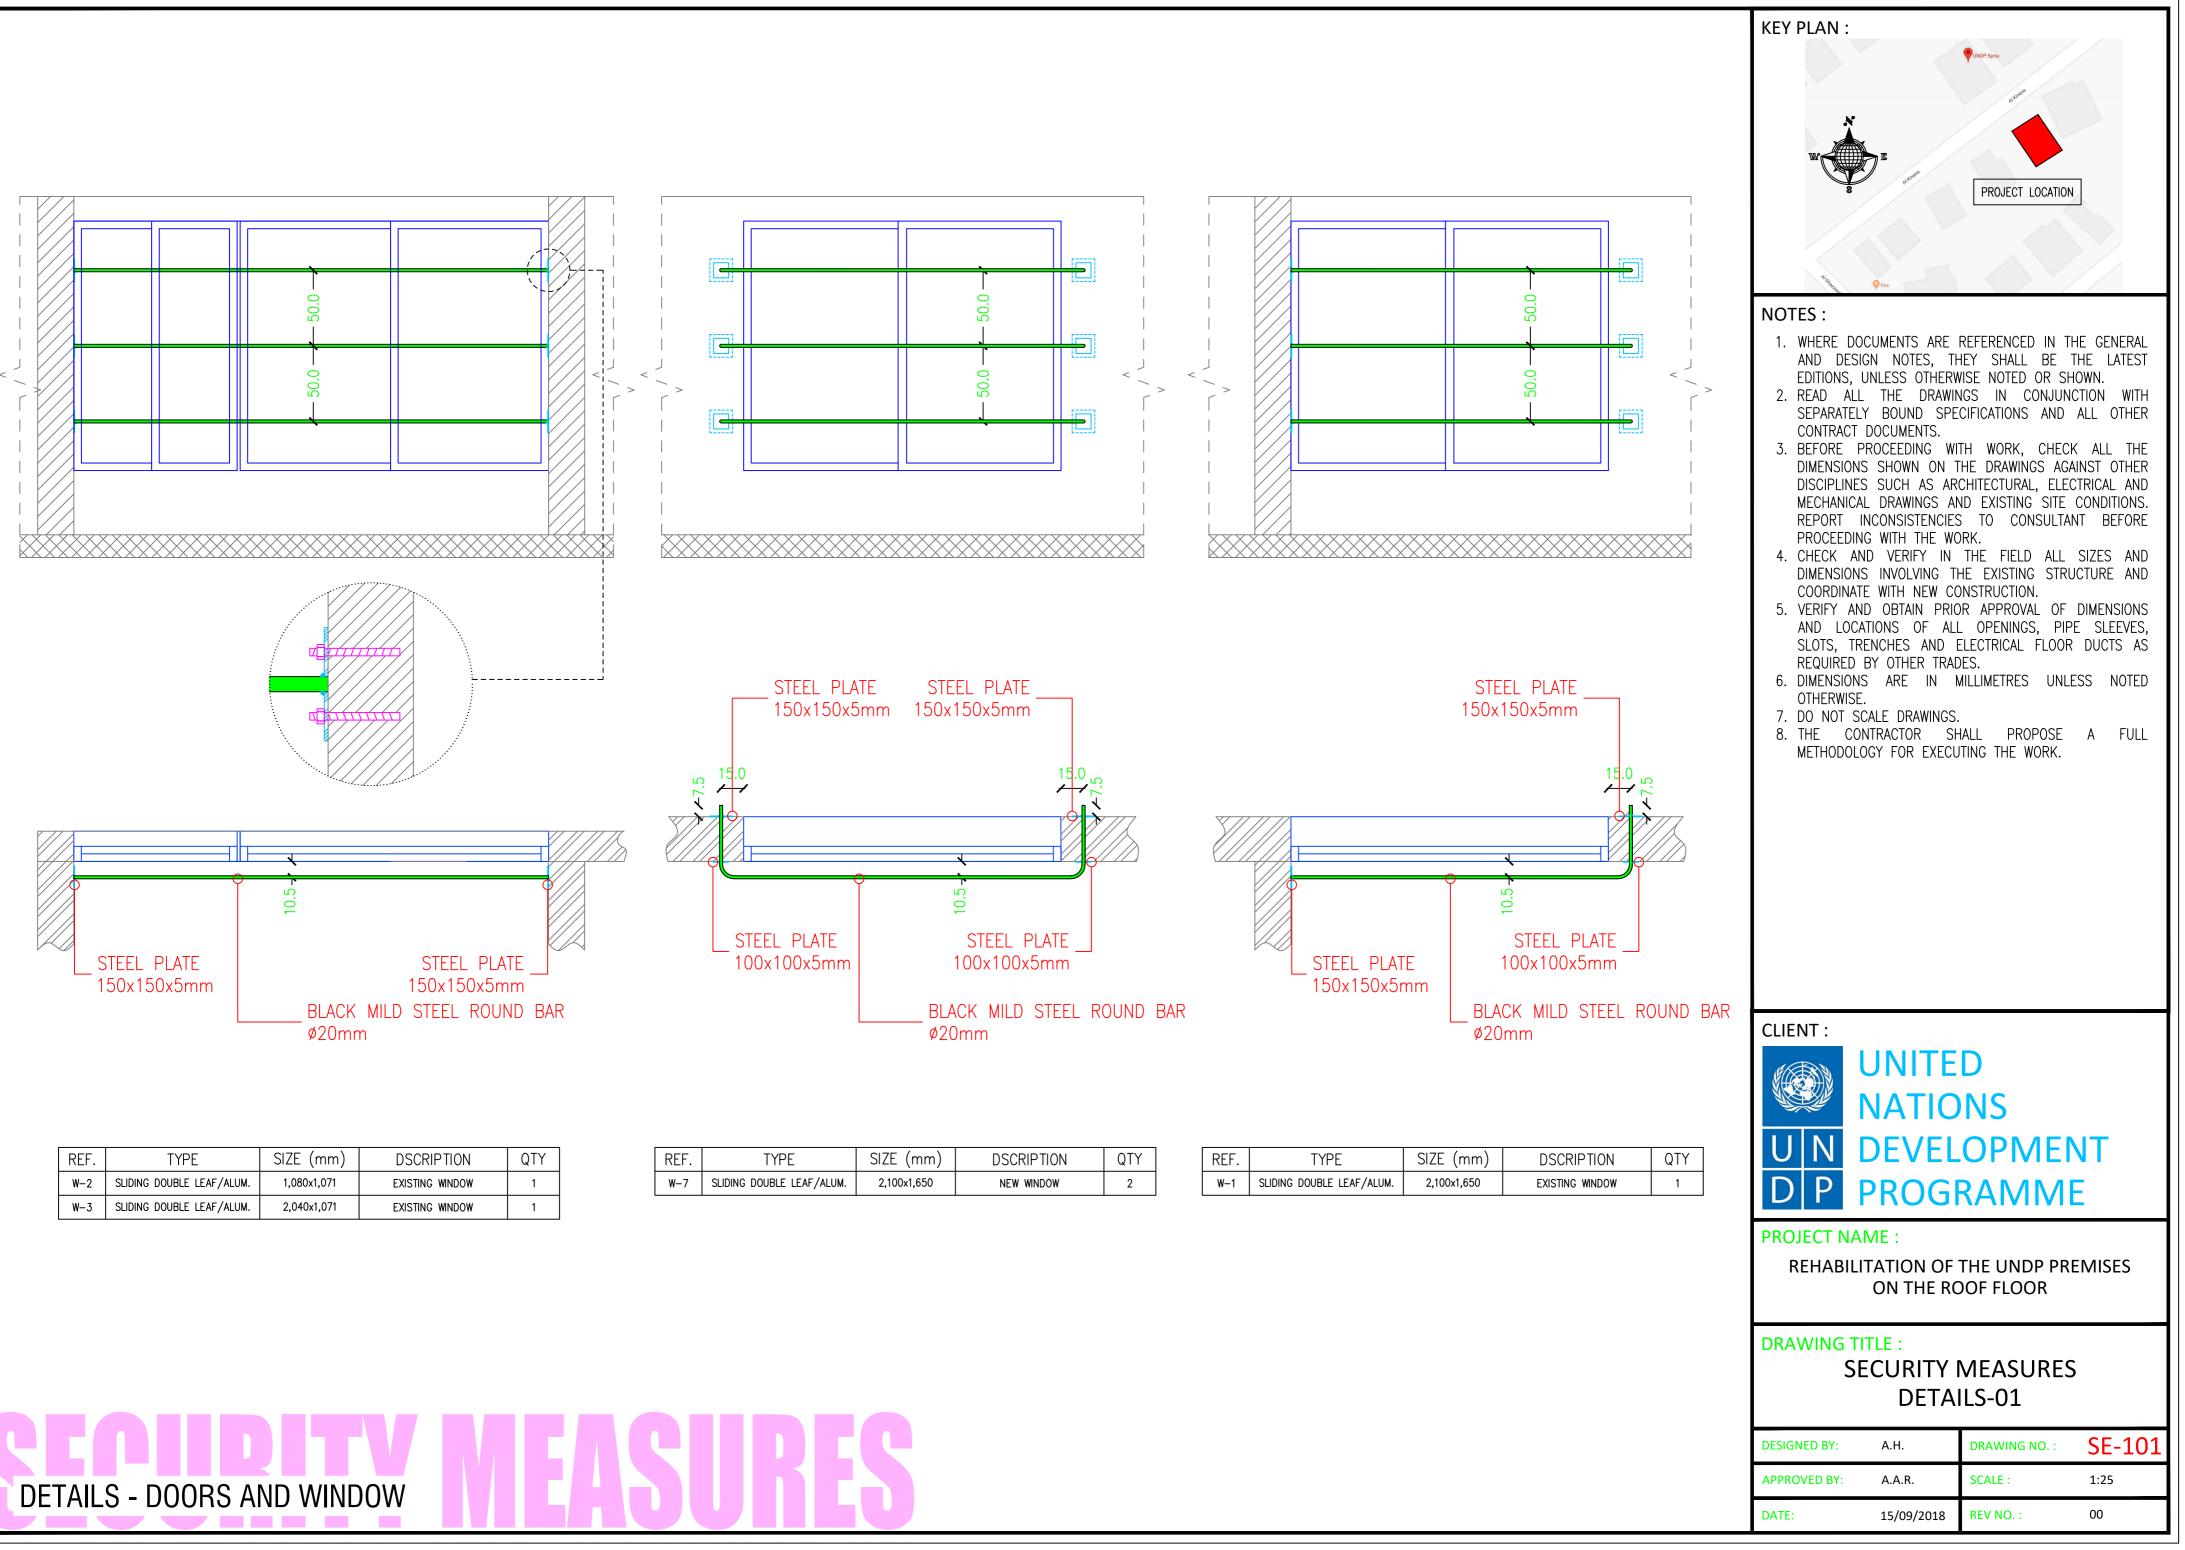



REF.	TYPE	SIZE (mm)	DSCRIPTION	QTY
₩-2	SLIDING DOUBLE LEAF/ALUM.	1,080x1,071	EXISTING WINDOW	1
₩-3	SLIDING DOUBLE LEAF/ALUM.	2,040x1,071	EXISTING WINDOW	1


REF.	TYPE	SIZE (mm)	DSCRIPTION	QTY
W-7	SLIDING DOUBLE LEAF/ALUM.	2,100x1,650	NEW WINDOW	2



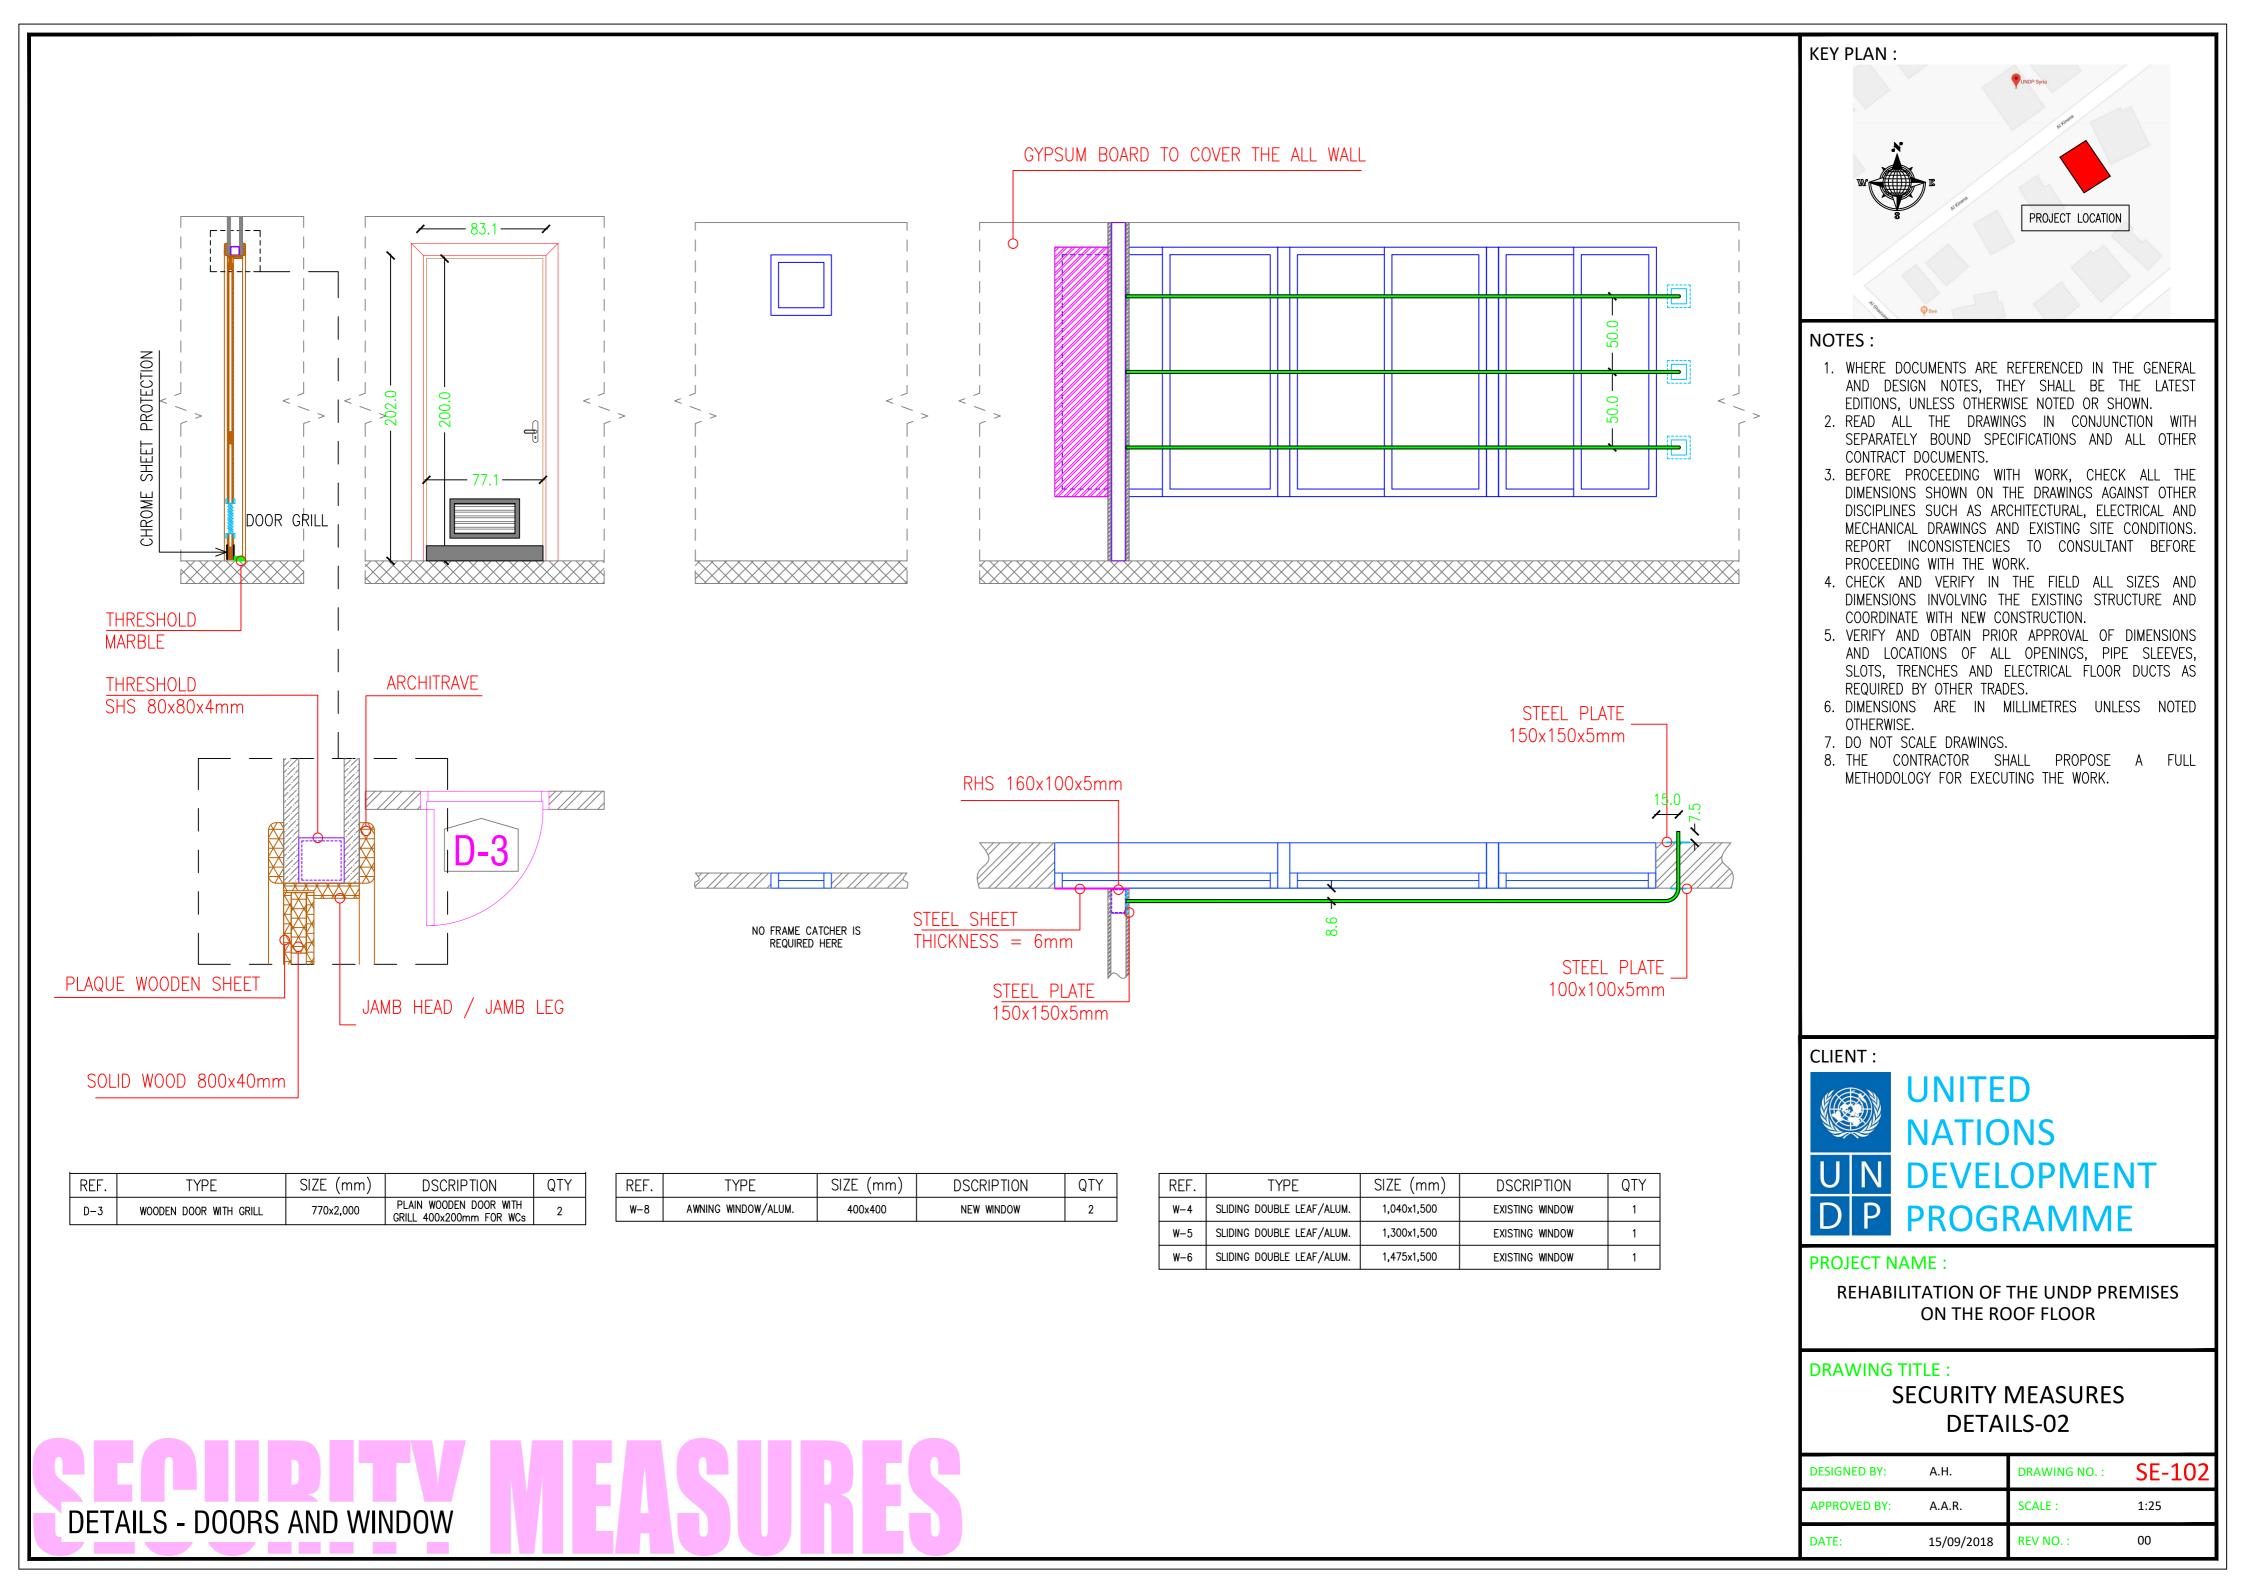

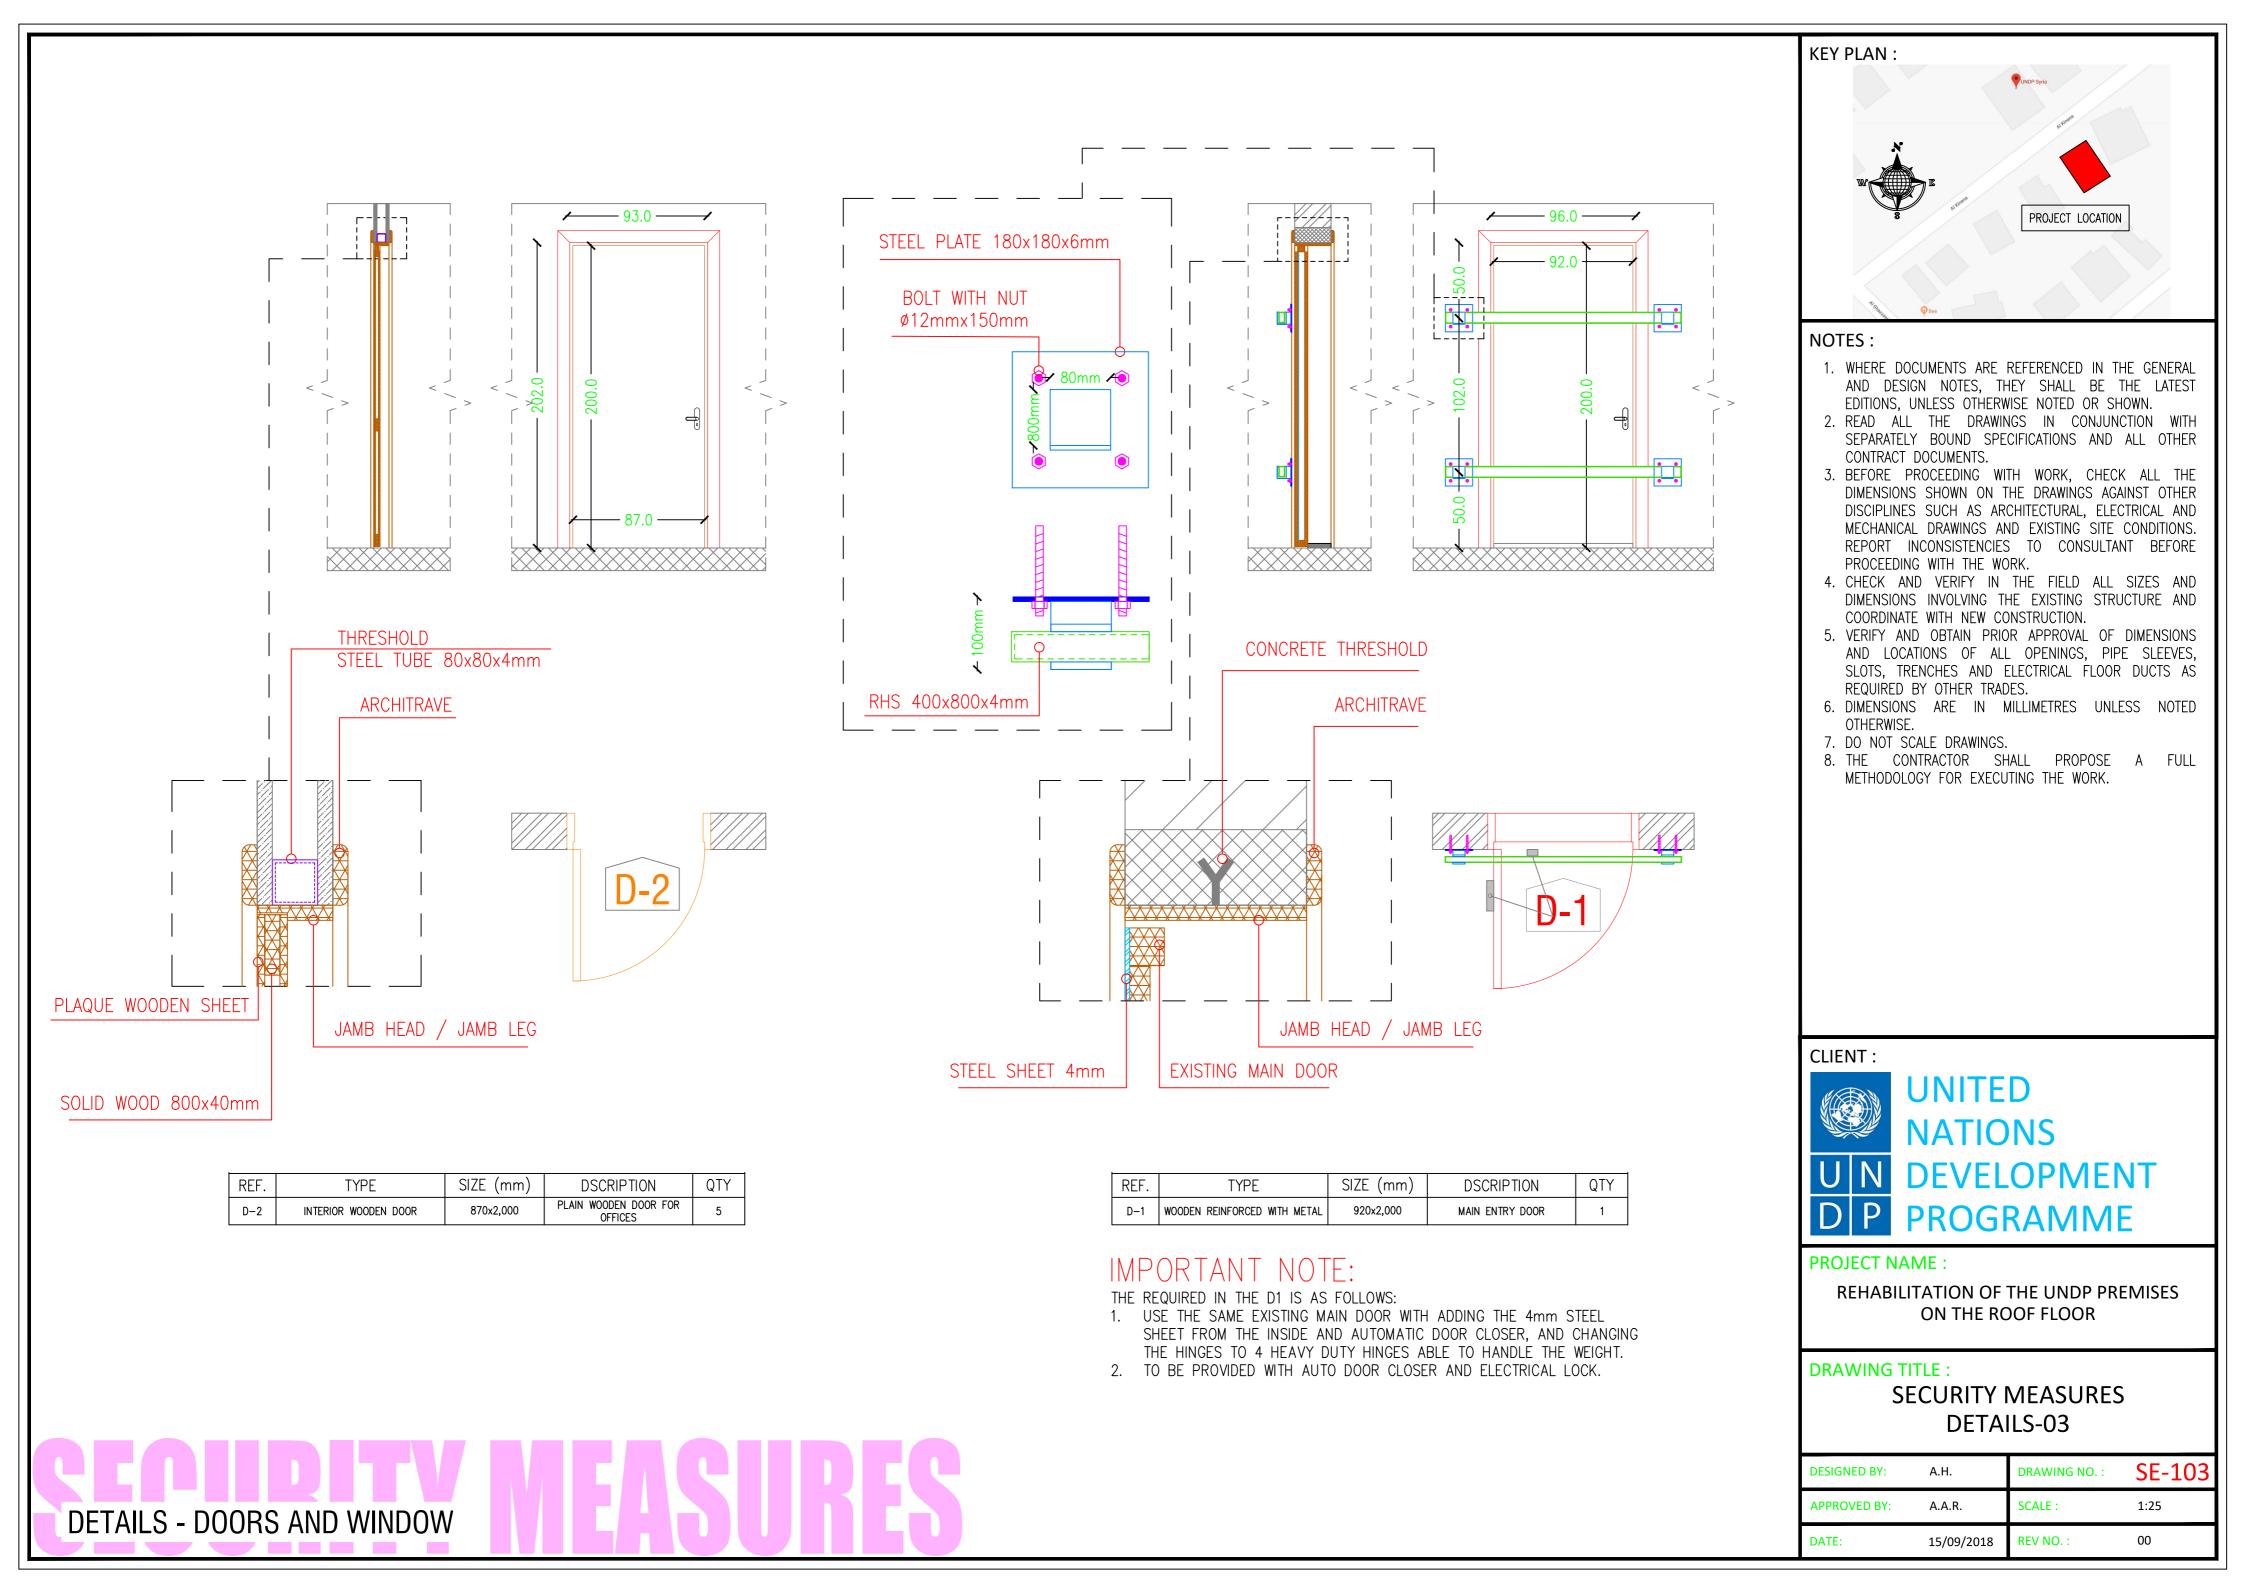


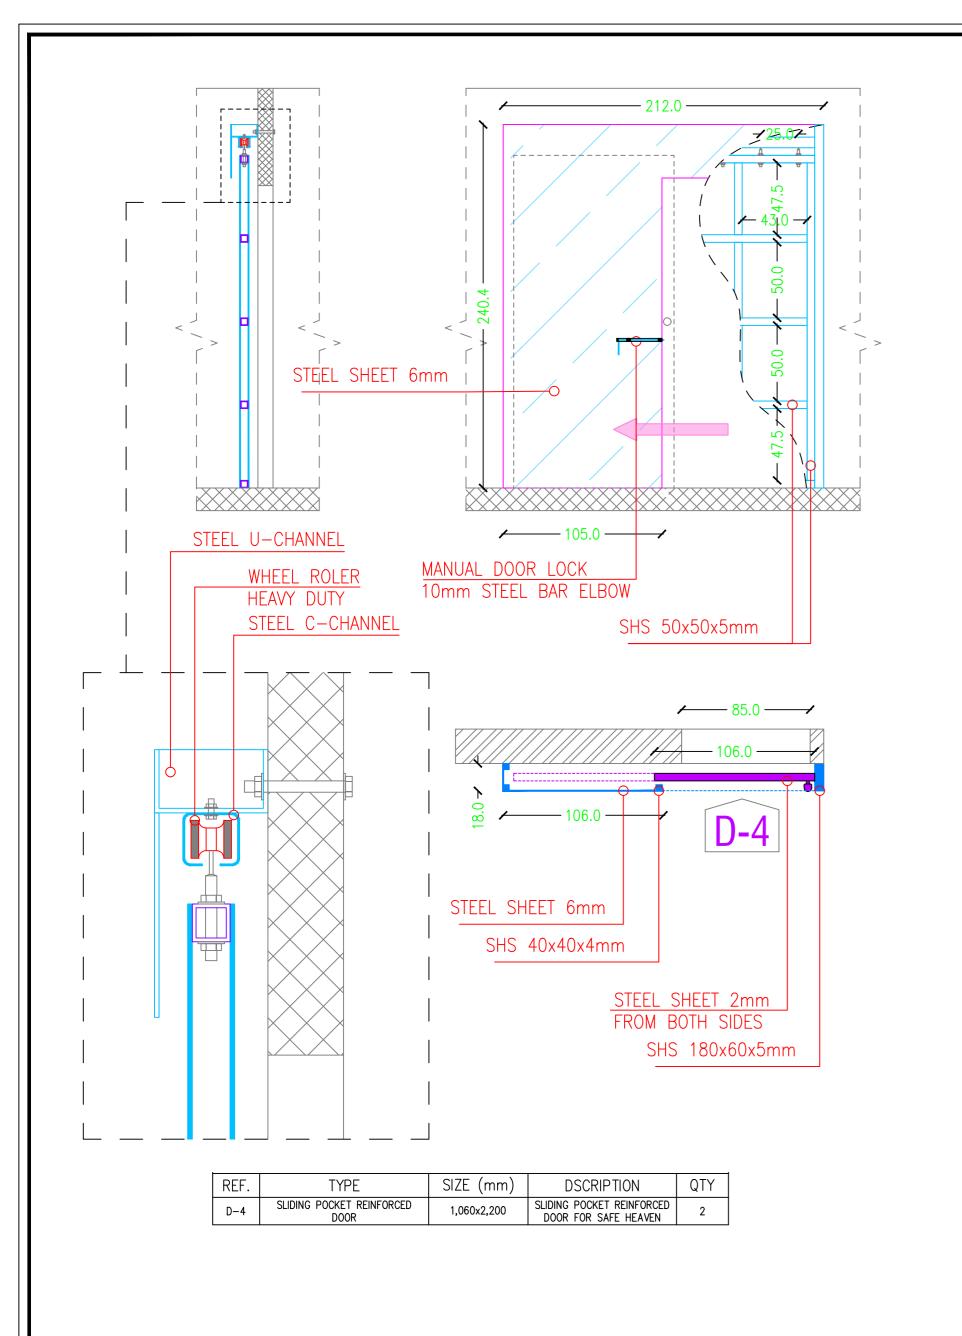

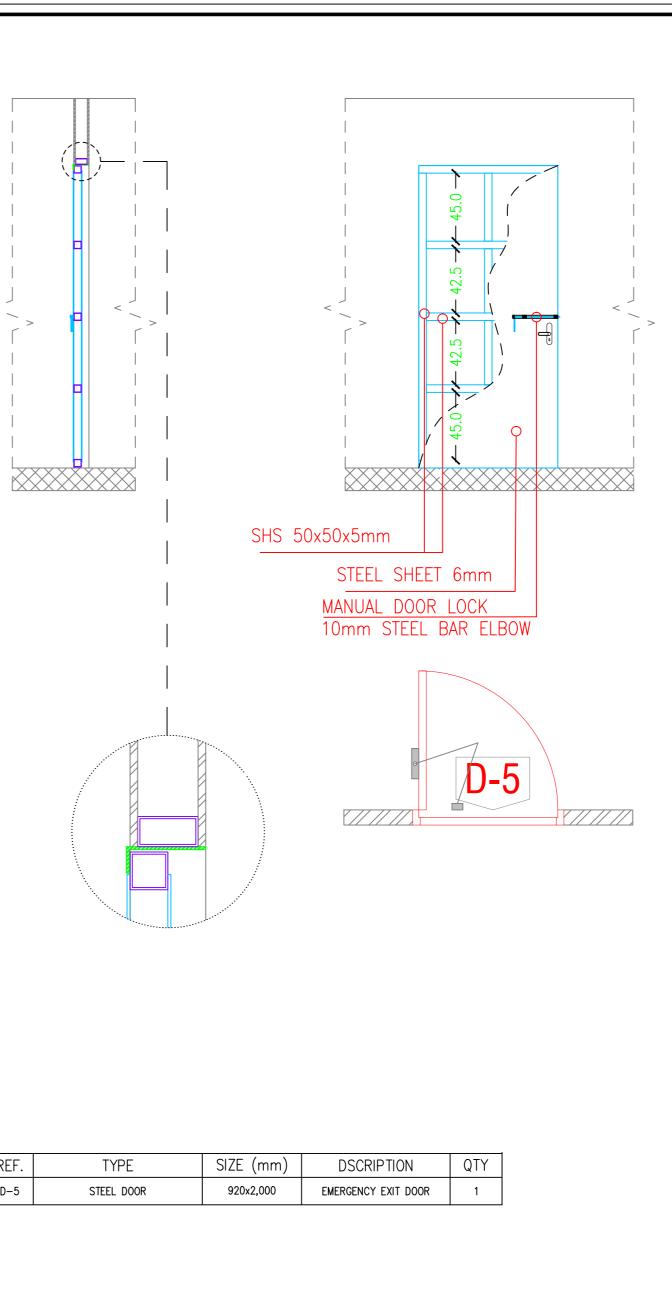

REF.	T
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CLIENT :

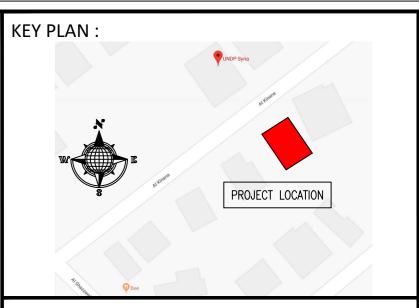



PROJECT NAME :

REHABILITATION OF THE UNDP PREMISES ON THE ROOF FLOOR

DRAWING TITLE : SECURITY MEASURES DETAILS-04

DESIGNED BY:	A.H.	DRAWING NO. :	SE-104
APPROVED BY:	A.A.R.	SCALE :	1:25
DATE:	15/09/2018	REV NO. :	00

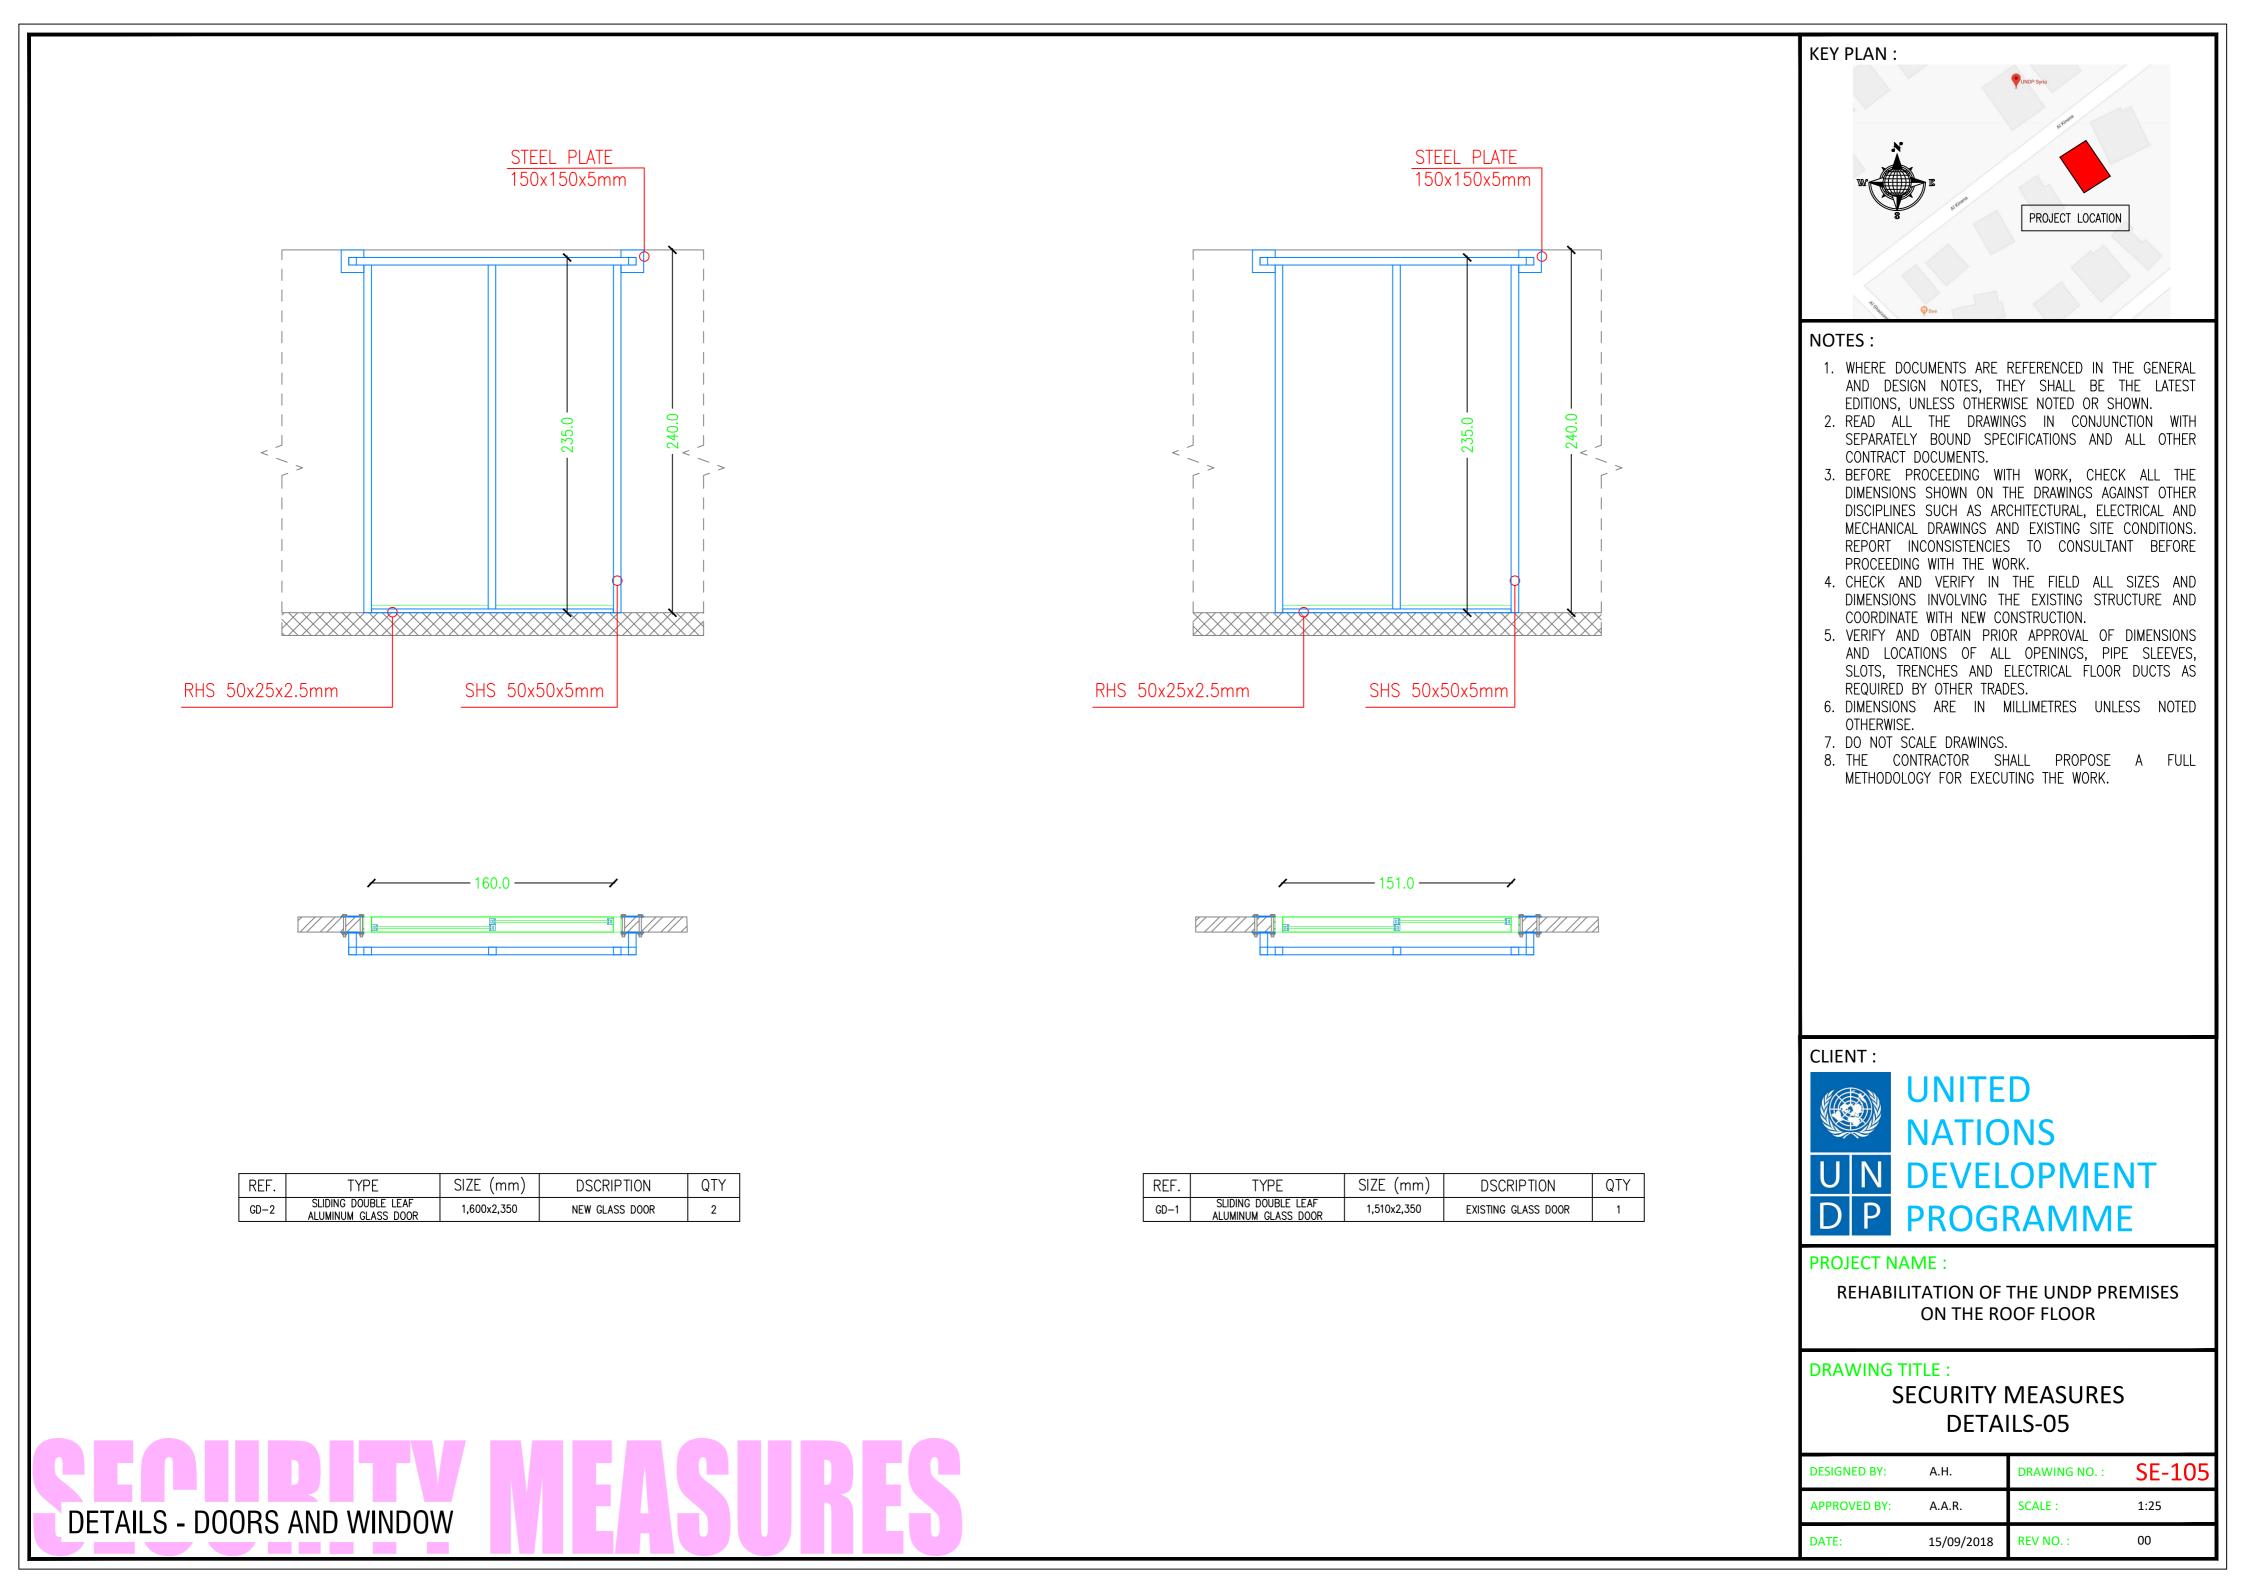

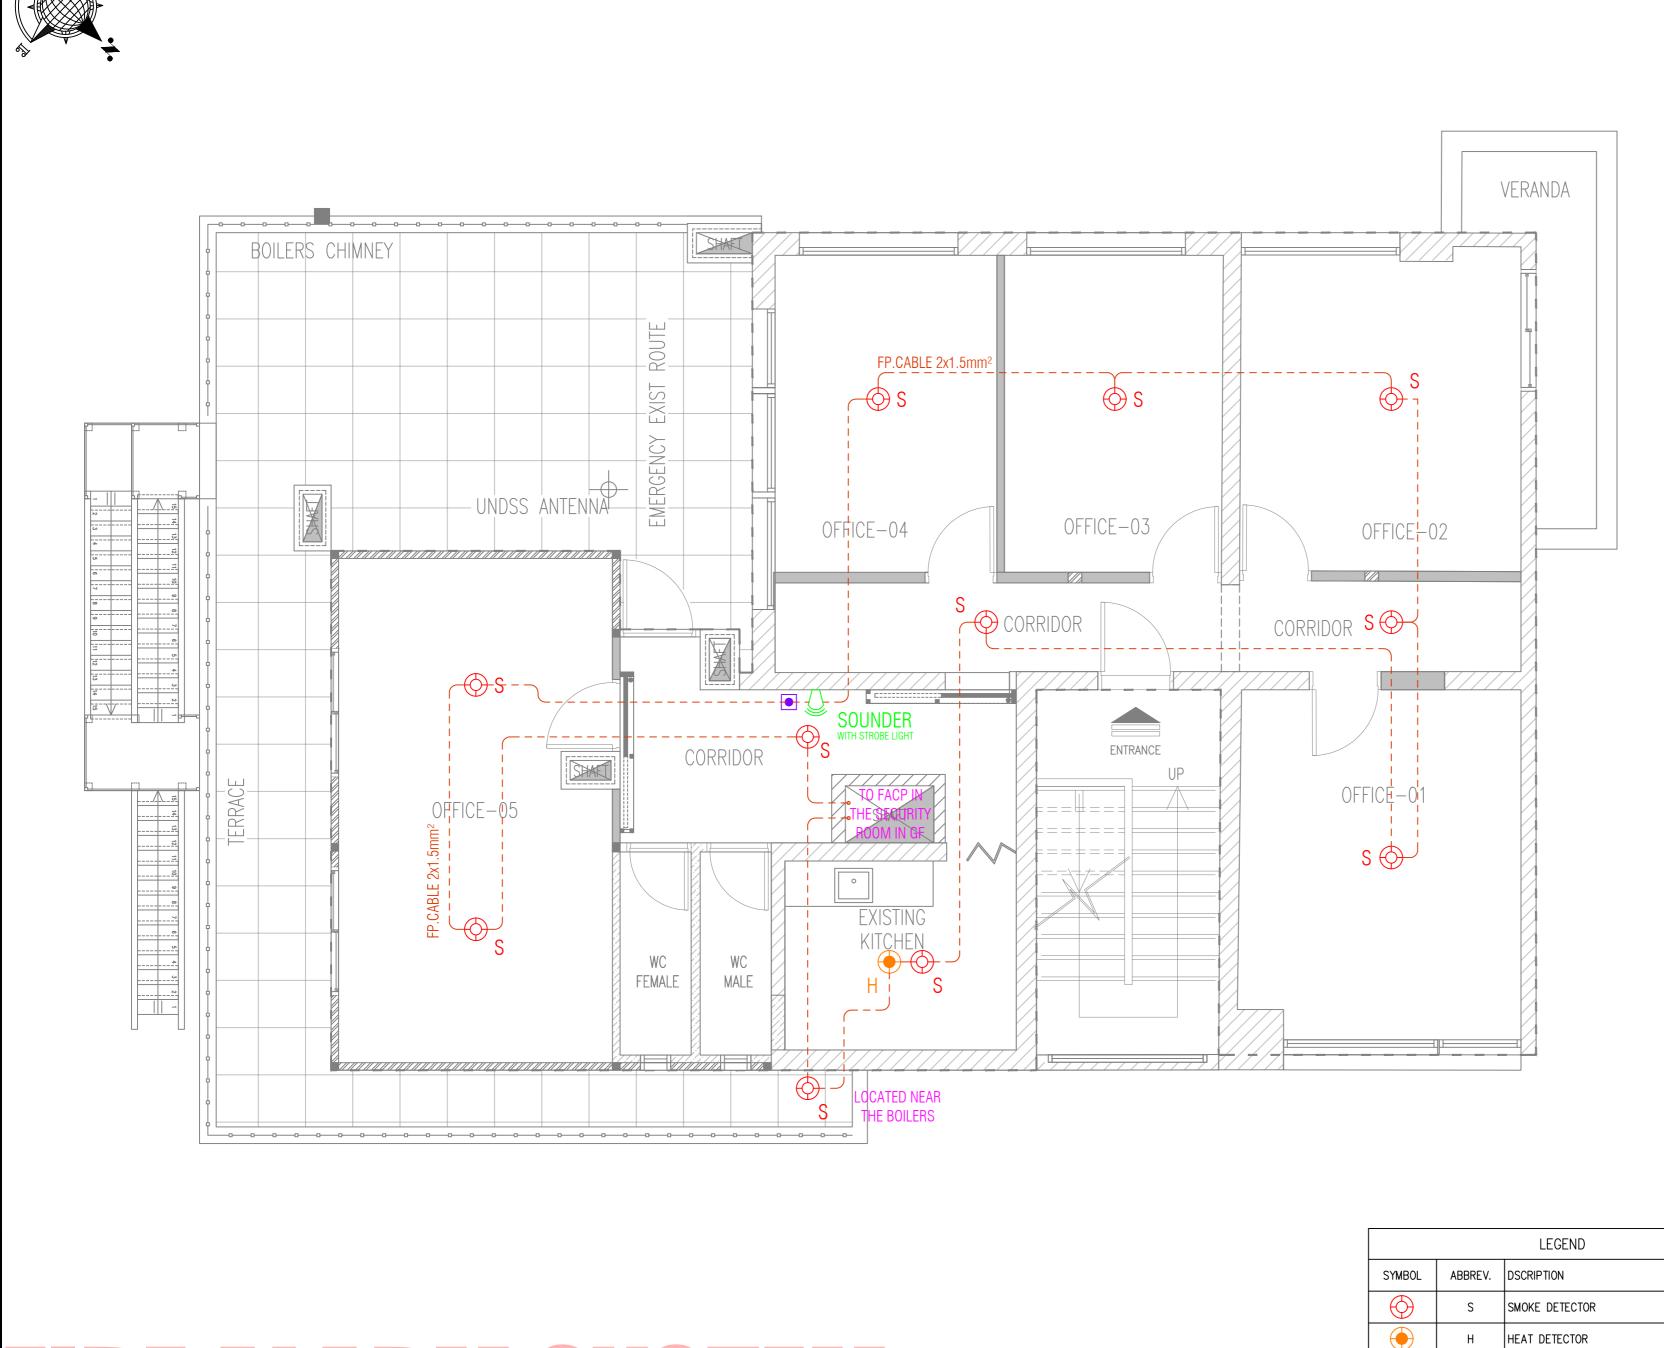



KEY PLAN :	VINDP Syria				
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8 Discont	PROJECT LOCATION				
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NOTES :					
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	CHITECTURAL, ELECTRICAL AND ND EXISTING SITE CONDITIONS.				
	5 TO CONSULTANT BEFORE				
4. CHECK AND VERIFY IN	THE FIELD ALL SIZES AND HE EXISTING STRUCTURE AND				
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AND LOCATIONS OF ALL	OPENINGS, PIPE SLEEVES, ELECTRICAL FLOOR DUCTS AS				
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PROJECT NAME :					
	REHABILITATION OF THE UNDP PREMISES				
ON THE ROOF FLOOR					
DRAWING TITLE :					
	OOR PLAN				
FIRE ALARM SY	STEM LAYOUT				
DESIGNED BY: A.H.	DRAWING NO. : FA-100				
APPROVED BY: A.A.R.	SCALE : 1:50				
DATE: 15/09/2018	REV NO. : 00				

QTY

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N/A

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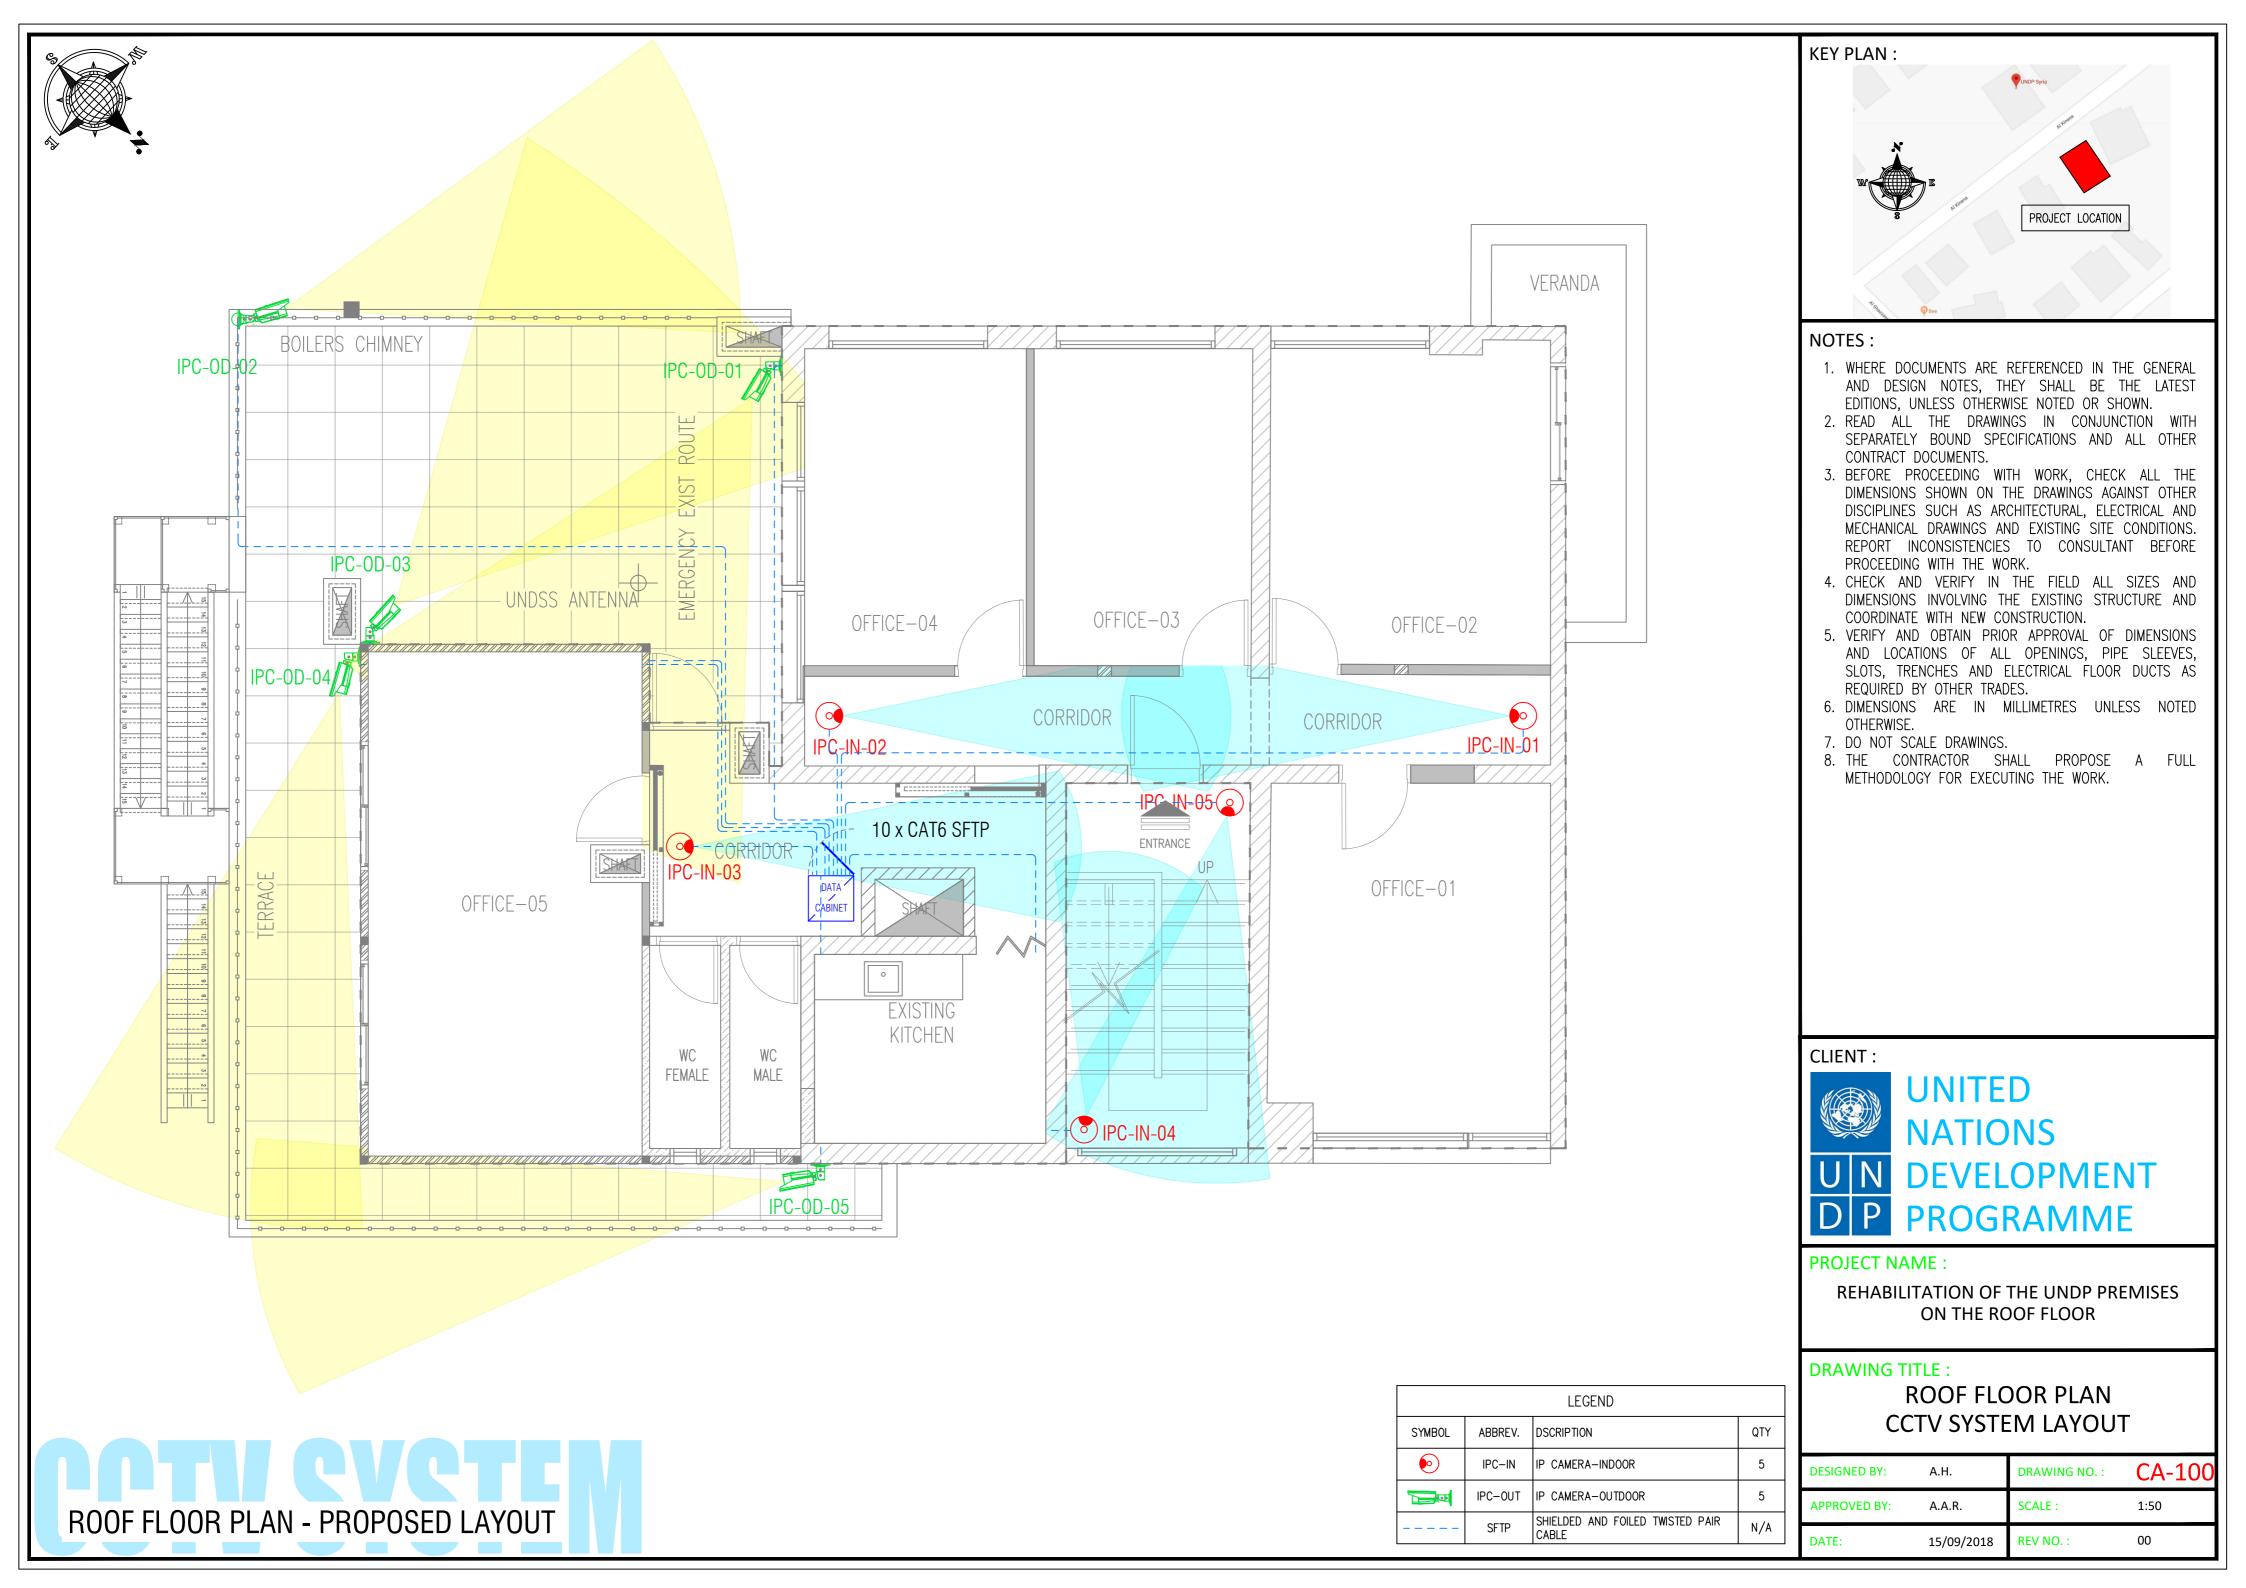
SOUNDER


FP

PUSH BUTTON ALARM


FIRE PROOF CABLE


SOUNDER WITH STROBE LIGHT - WALL MOUNTED



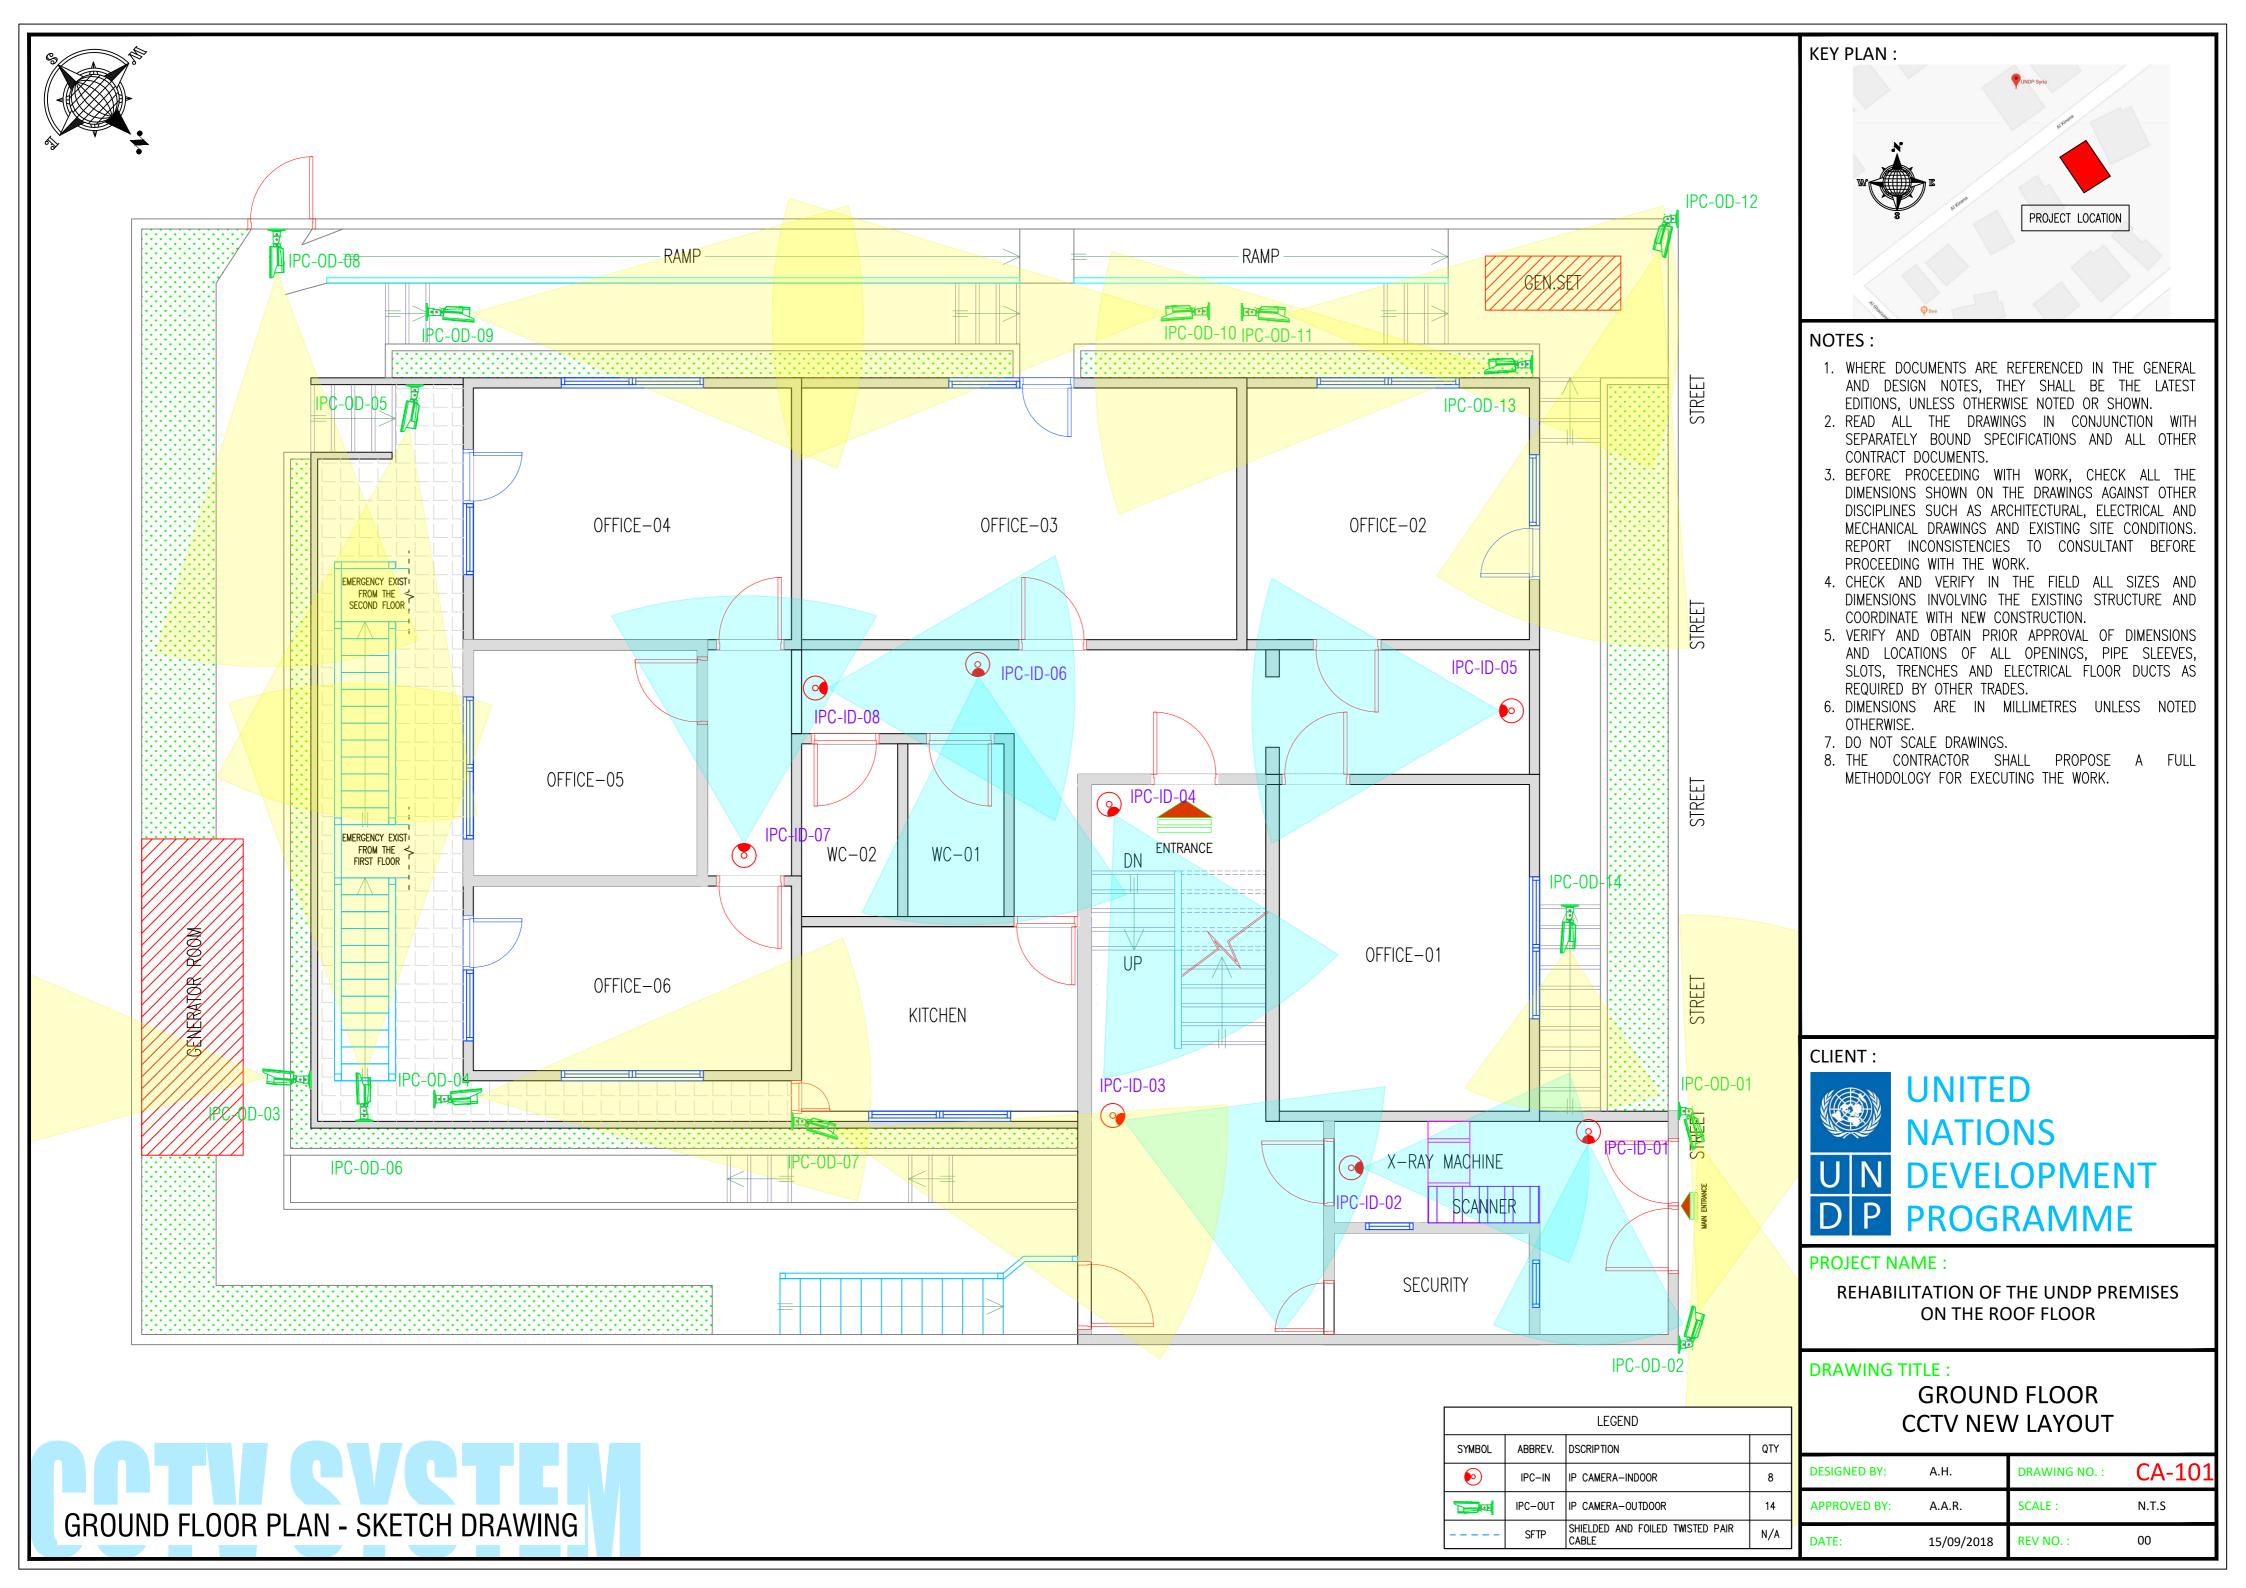


BASEMENT PLAN - SKETCH DRAWING

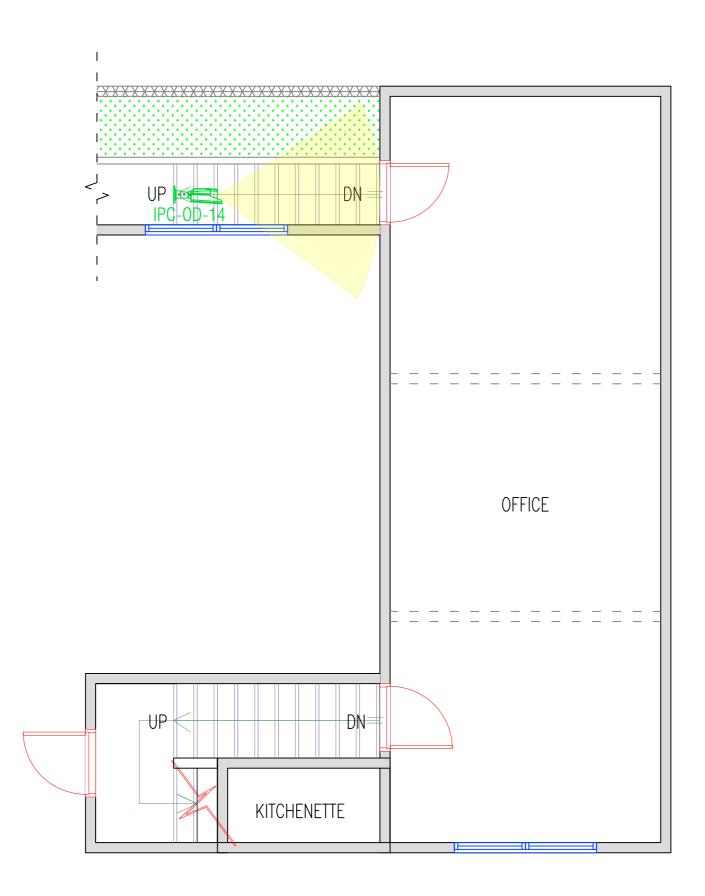

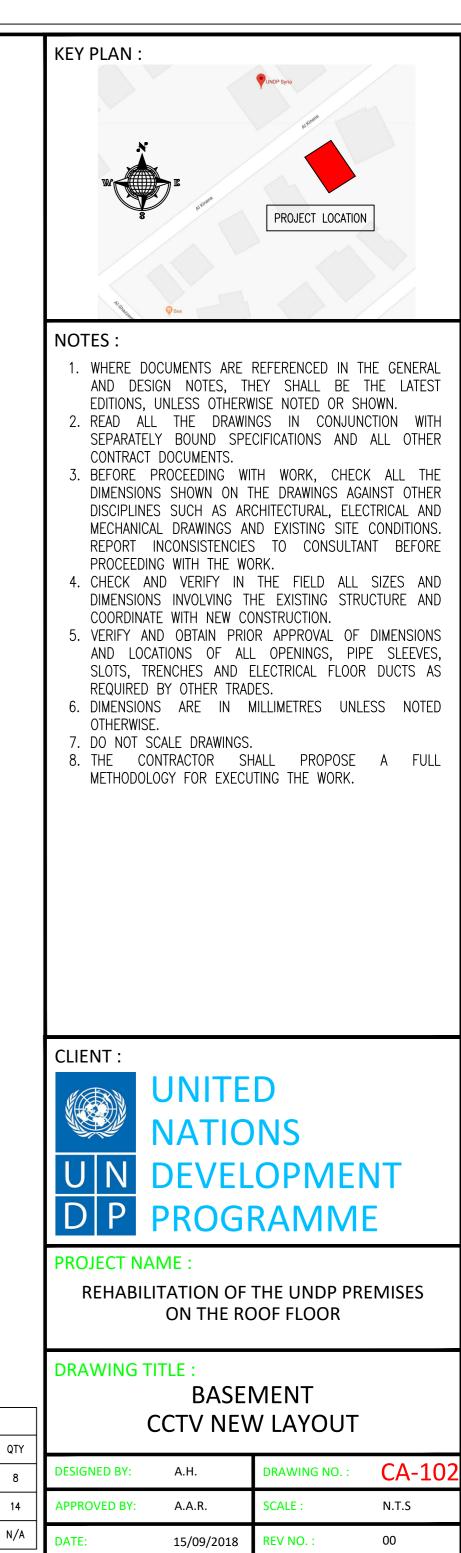

		LEGEND	
SYMBOL	ABBREV.	DSCRIPTION	
Ð	IPC-IN	IP CAMERA-INDOOR	
	IPC-OUT	IP CAMERA-OUTDOOR	
	SFTP	SHIELDED AND FOILED TWISTED PAIR CABLE	

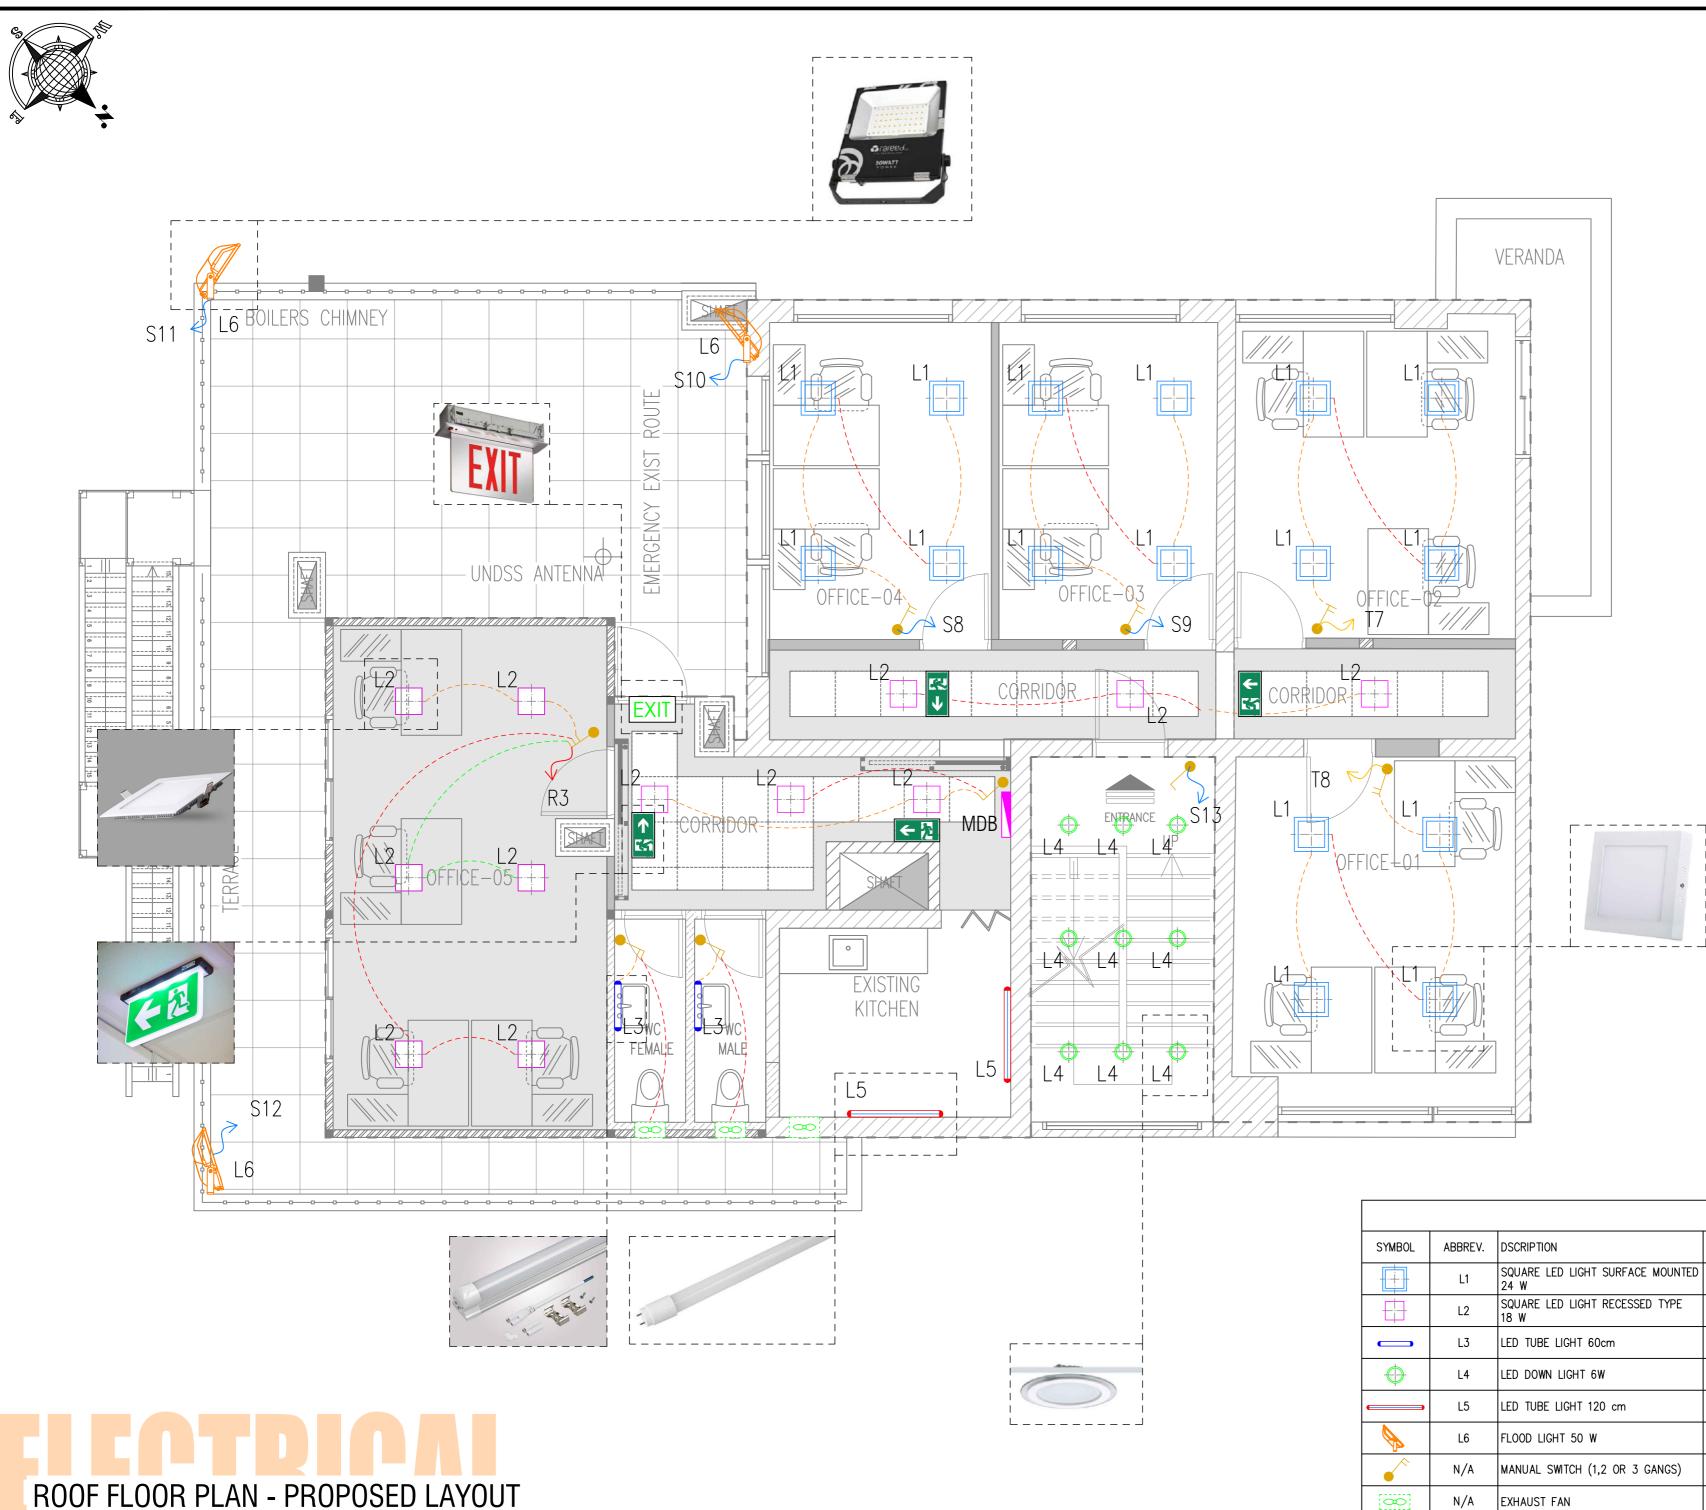


SYMBOL	ABBREV.	DSCRIPTION	QTY
	L1	SQUARE LED LIGHT SURFACE MOUNTED 24 W	16
	L2	SQUARE LED LIGHT RECESSED TYPE 18 W	12
	L3	LED TUBE LIGHT 60cm	2
Φ	L4	LED DOWN LIGHT 6W	9
	L5	LED TUBE LIGHT 120 cm	4
	L6	FLOOD LIGHT 50 W	3
	N/A	MANUAL SWITCH (1,2 OR 3 GANGS)	N/A
8	N/A	EXHAUST FAN	3
		•	


DATE:

15/09/2018

REV NO. :

00

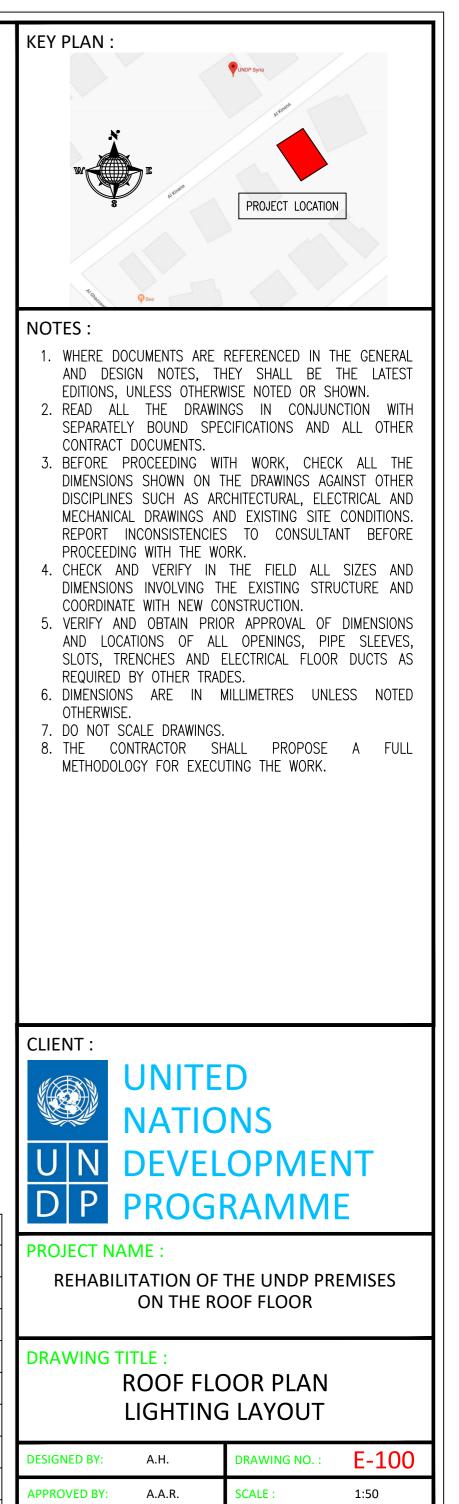

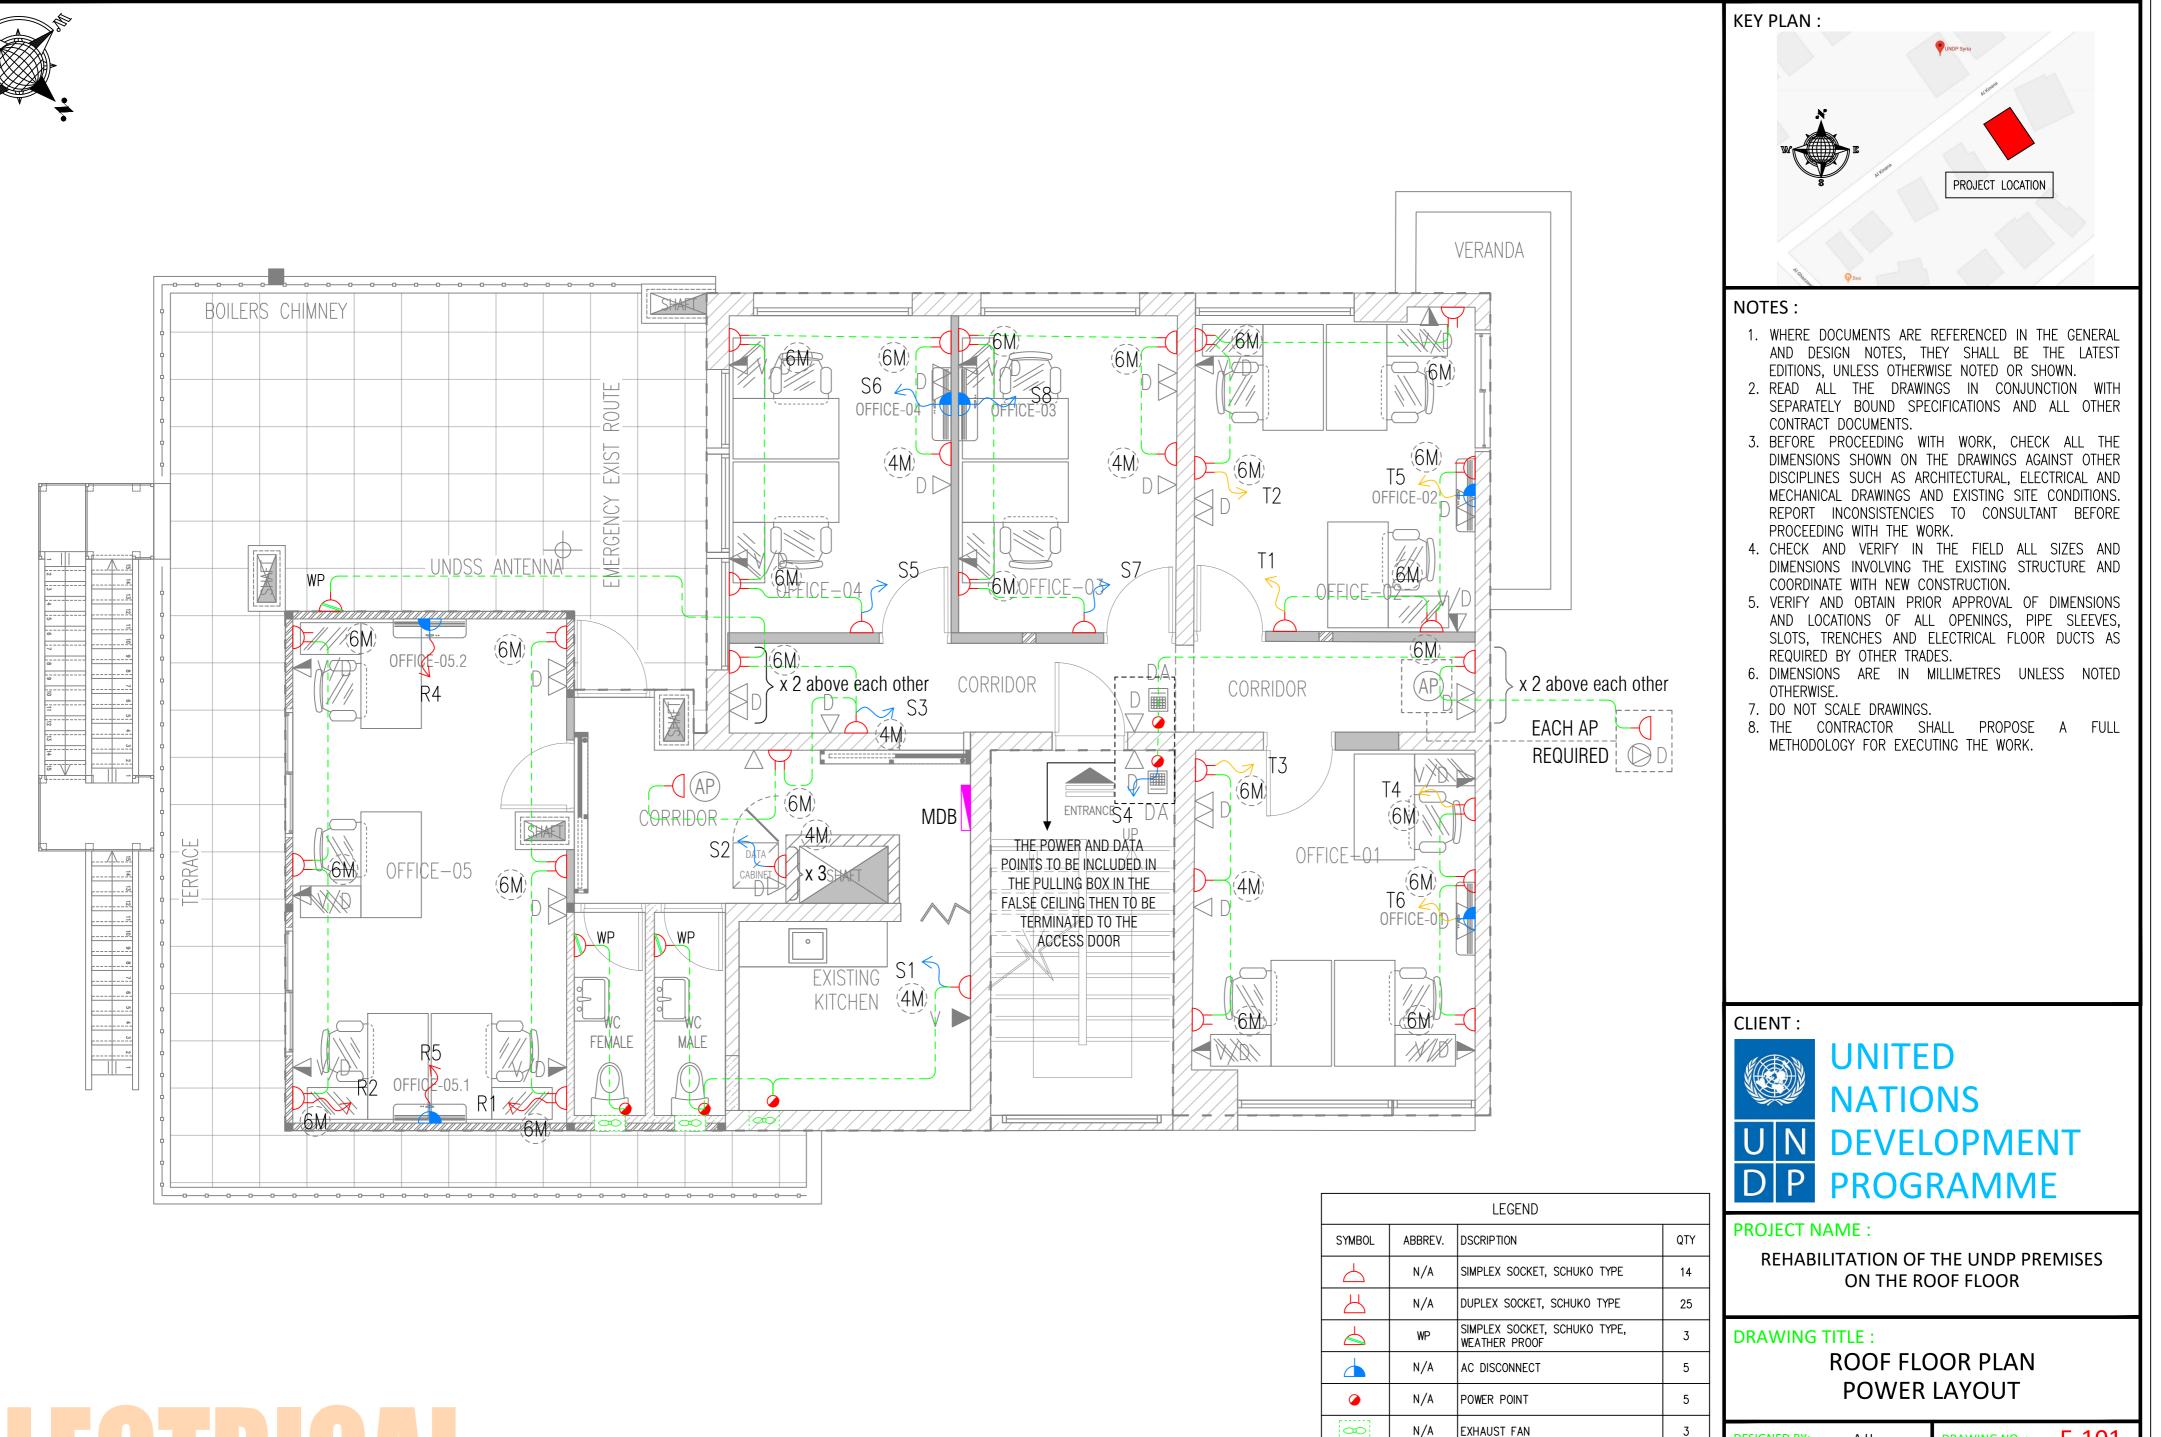

DESIGNED BY:	A.H.	DRAWING NO. :	E-101
APPROVED BY:	A.A.R.	SCALE :	1:50
DATE:	15/09/2018	REV NO. :	00

MAIN DISTRIBUTION BOARD

WEATHER PROOF


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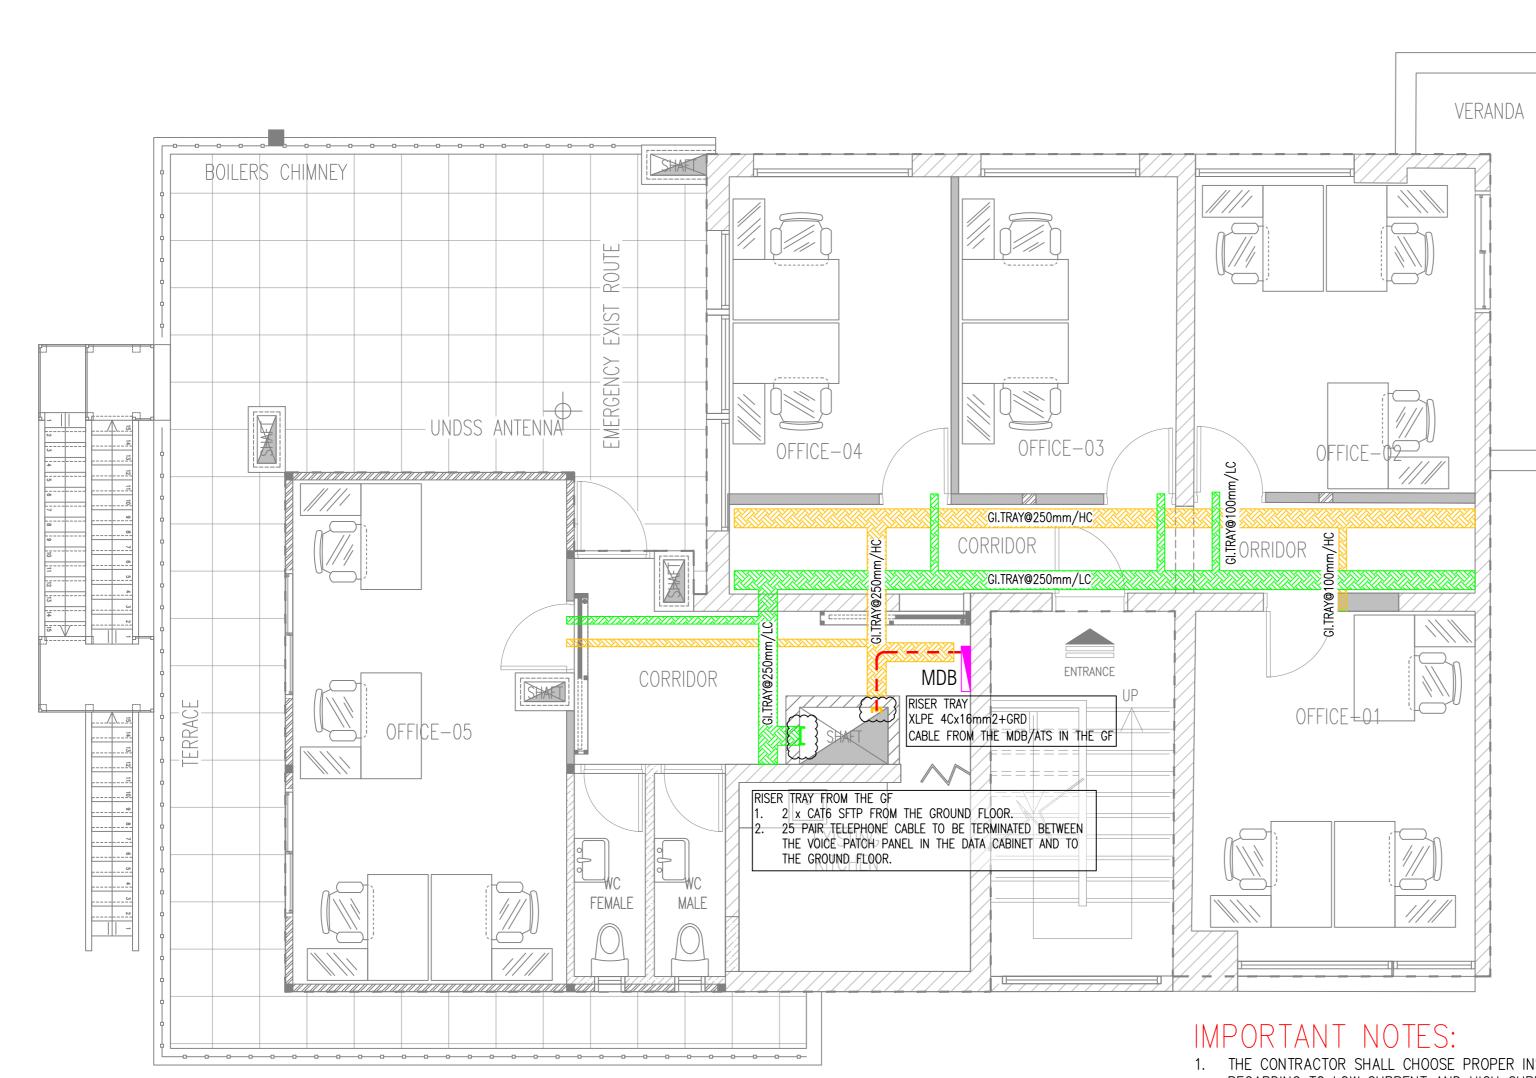
MDB

WP


N/A





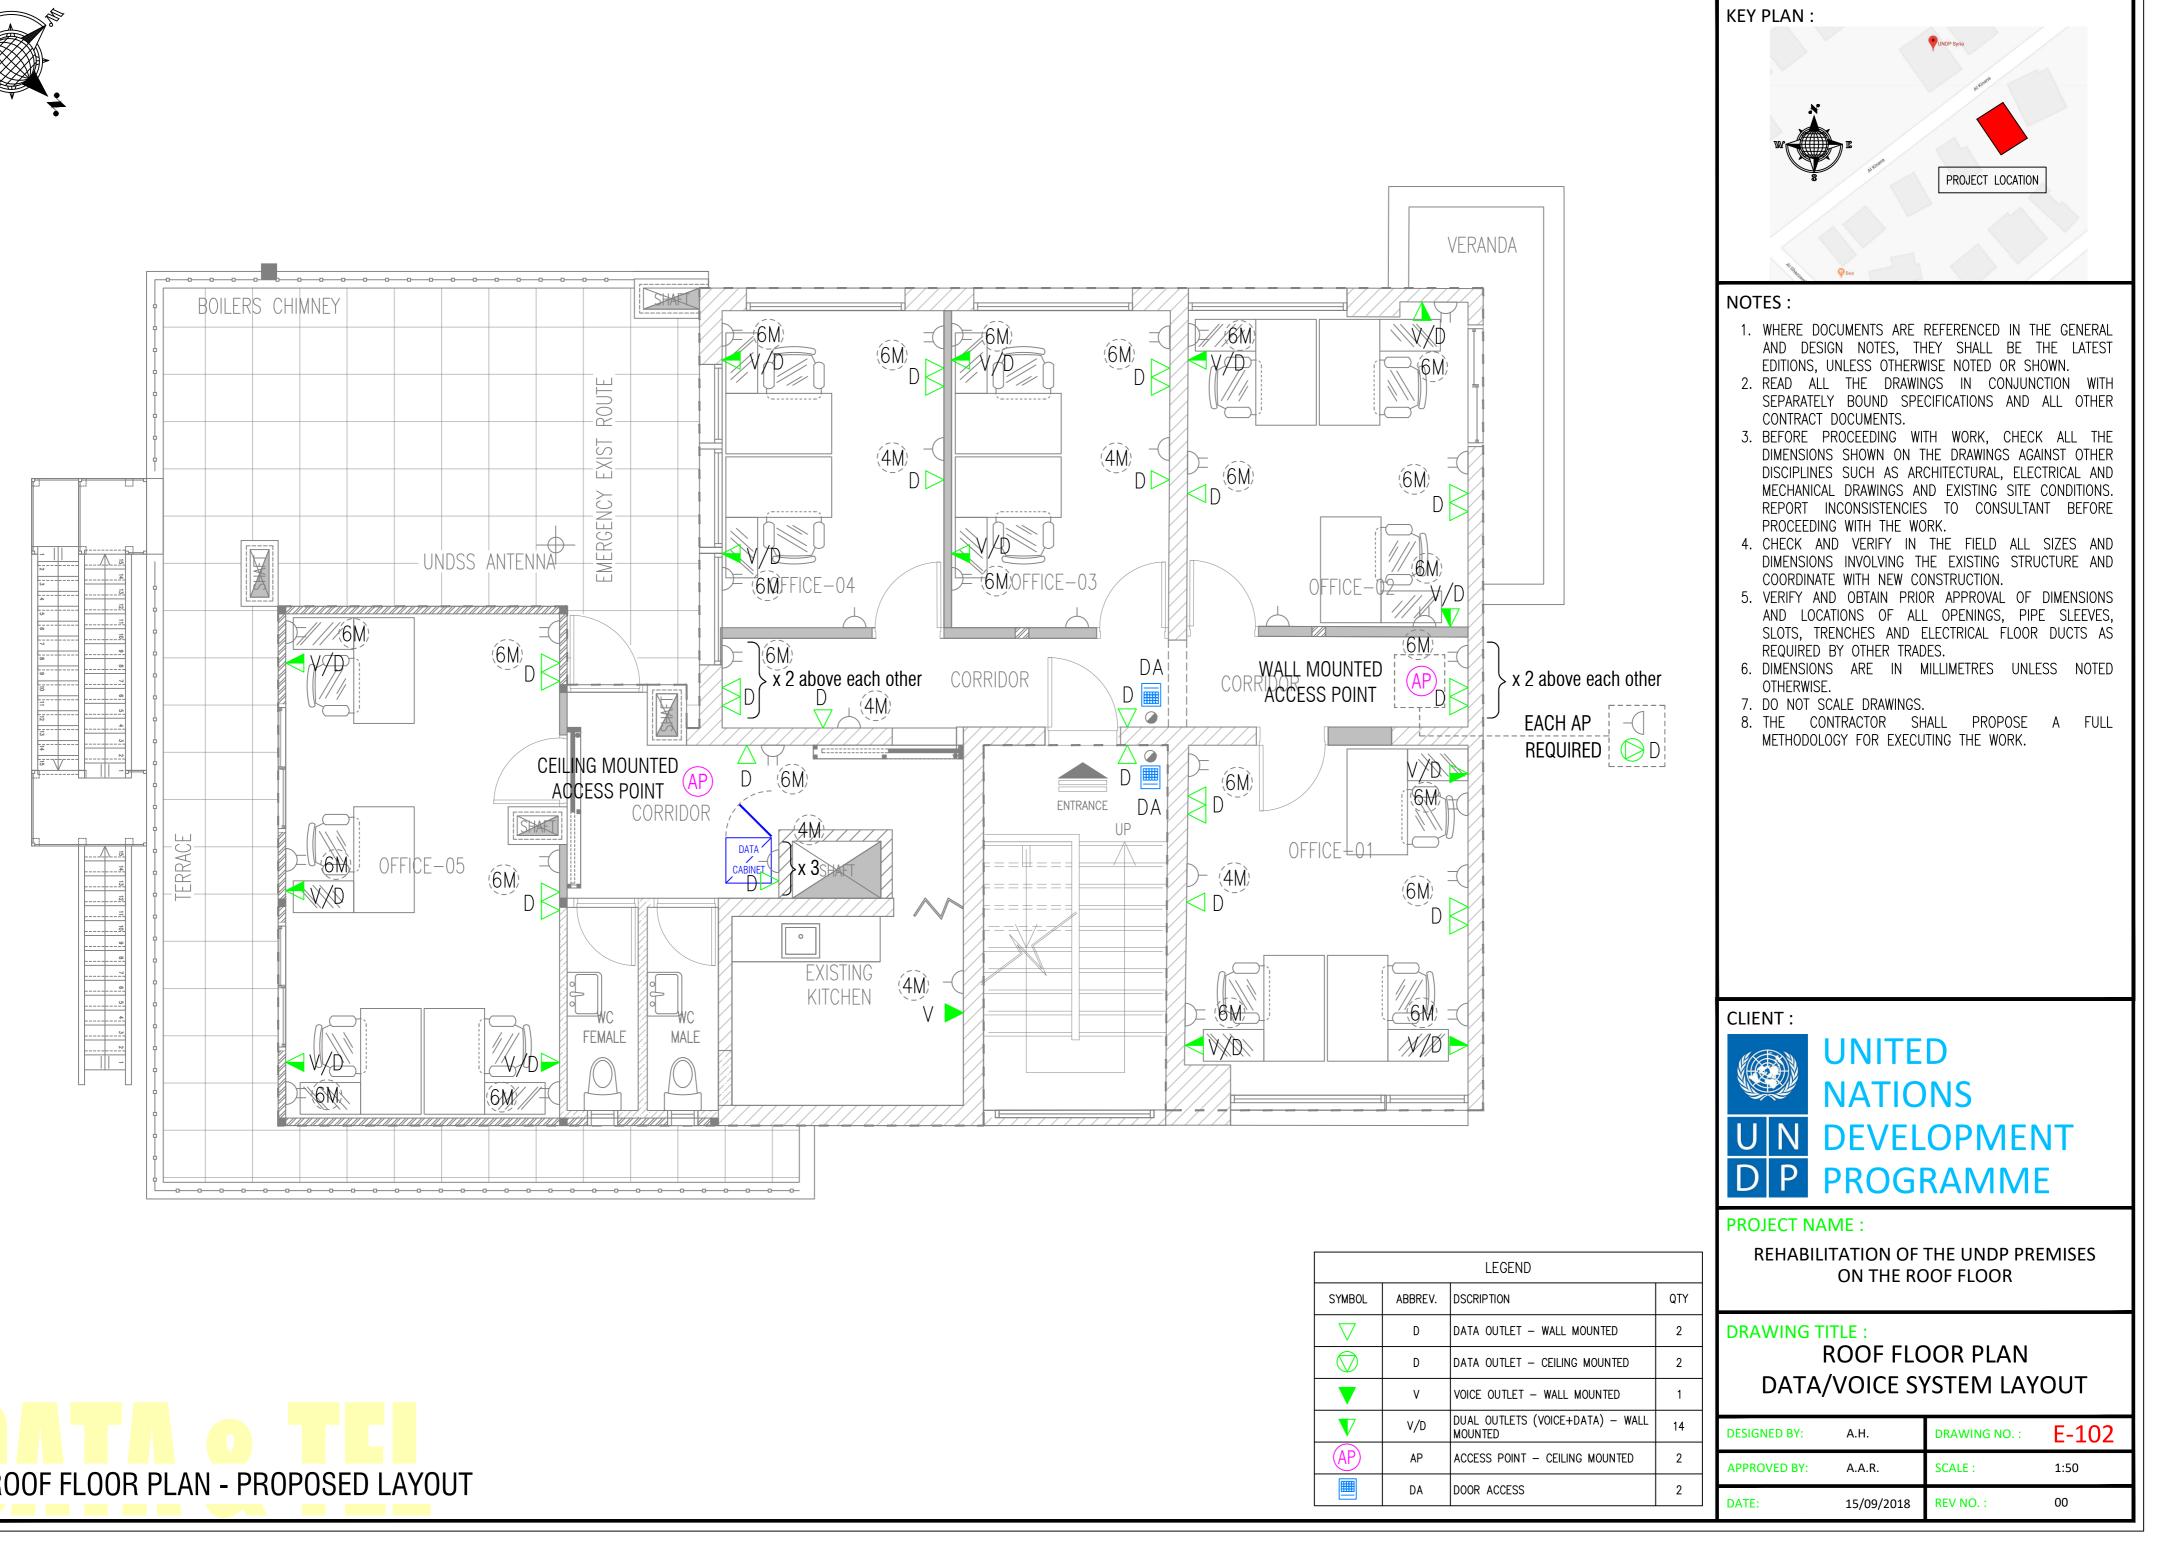

- THE CONTRACTOR SHALL CHOOSE PROPER INSTALLATION ROUTING REGARDING TO LOW CURRENT AND HIGH CURRENT CABLES.
- 2. THE DISTANCE BETWEEN THE LC AND HC CABLES NOT LESS THAN 25cm.
- THE CONTRACTOR SHALL INSTALL CABLES INVISIBLY IN THE GYPSUM 3. BOARD/CEMENT BOARD PARTITIONS.
- 4. WHERE THE VISIBLE INSTALLATION IS REQUIRED, THE CONTRACTOR SHALL USE PVC TRUNKING WITH A SIZE SUITABLE TO THE CABLES WITH DRAWING TITLE : ADDITION OF 50% FREE SPACE.
- 5. THE LC TRUNKING SHALL BE INSTALLED AT THE HIGH LEVEL OF THE ROOM ALONG THE WALL AND DOWN AT ANY ROOM CORNER @ 40cm F.F.L.
- 6. THE HC TRUNKING SHALL BE INSTALLED AT THE LOW LEVEL OF THE ROOM AT THE EDGE OF SKIRTING.

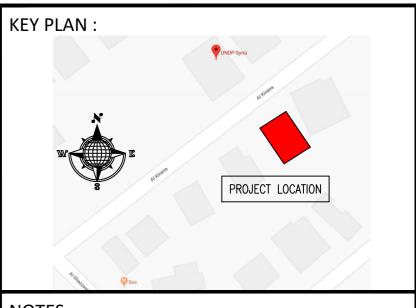

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CLIENT :



PROJECT NAME :

REHABILITATION OF THE UNDP PREMISES ON THE ROOF FLOOR


ROOF FLOOR PLAN CABLE TRAYS LAYOUT


DESIGNED BY:	A.H.	DRAWING NO. :	E-103
APPROVED BY:	A.A.R.	SCALE :	1:50
DATE:	15/09/2018	REV NO. :	00


SCHEMATIC LAYOUT

TO BE INSTALLED IN THE EXISTING 4" PVC CONDUIT IN THE STREET

UN BUILDING INCLUDING UNDP OFFICE IN THE ROOF FLOOR

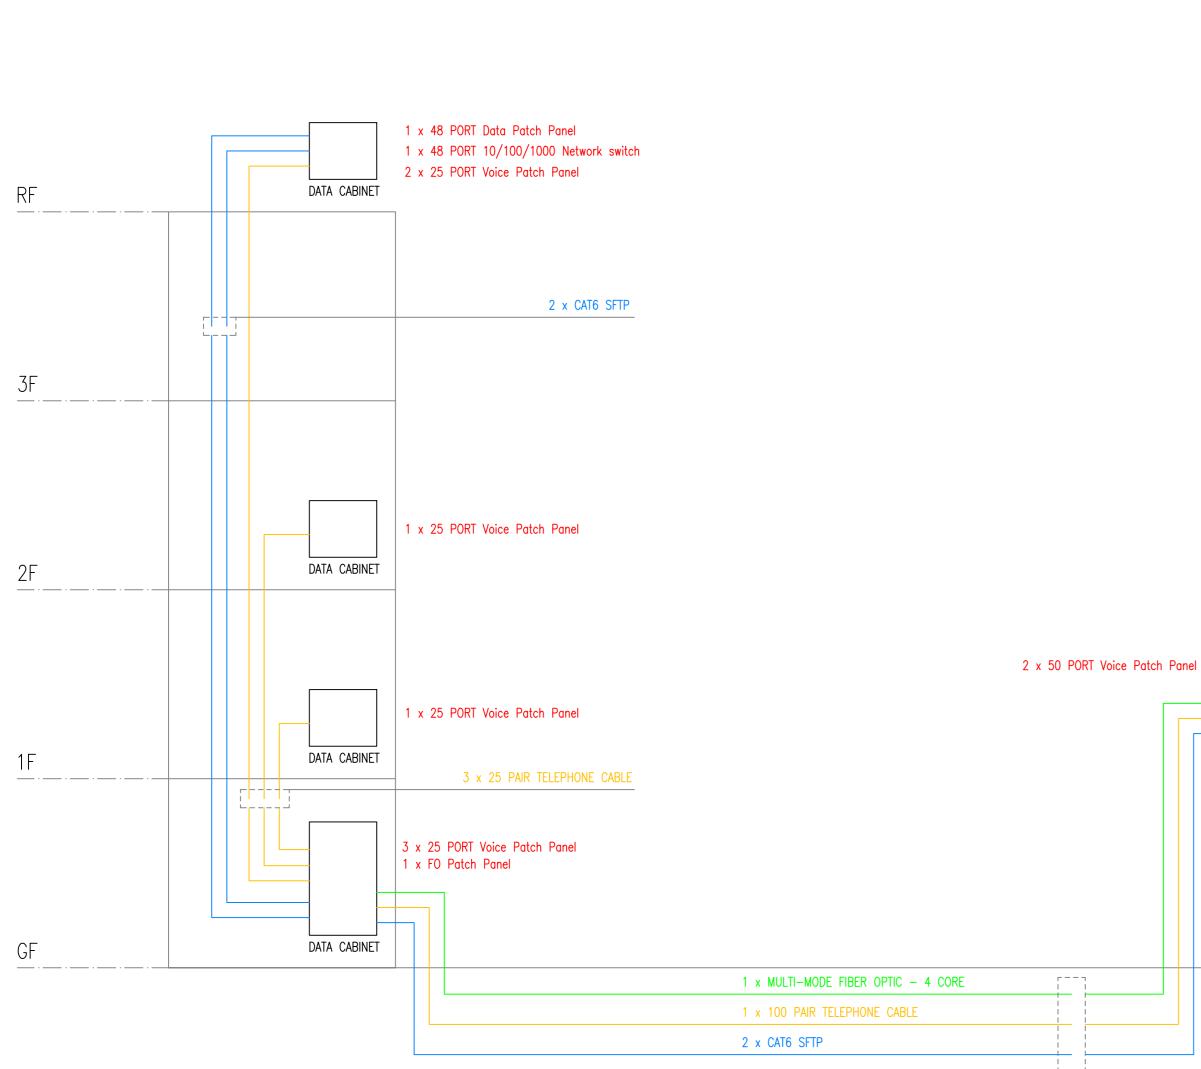

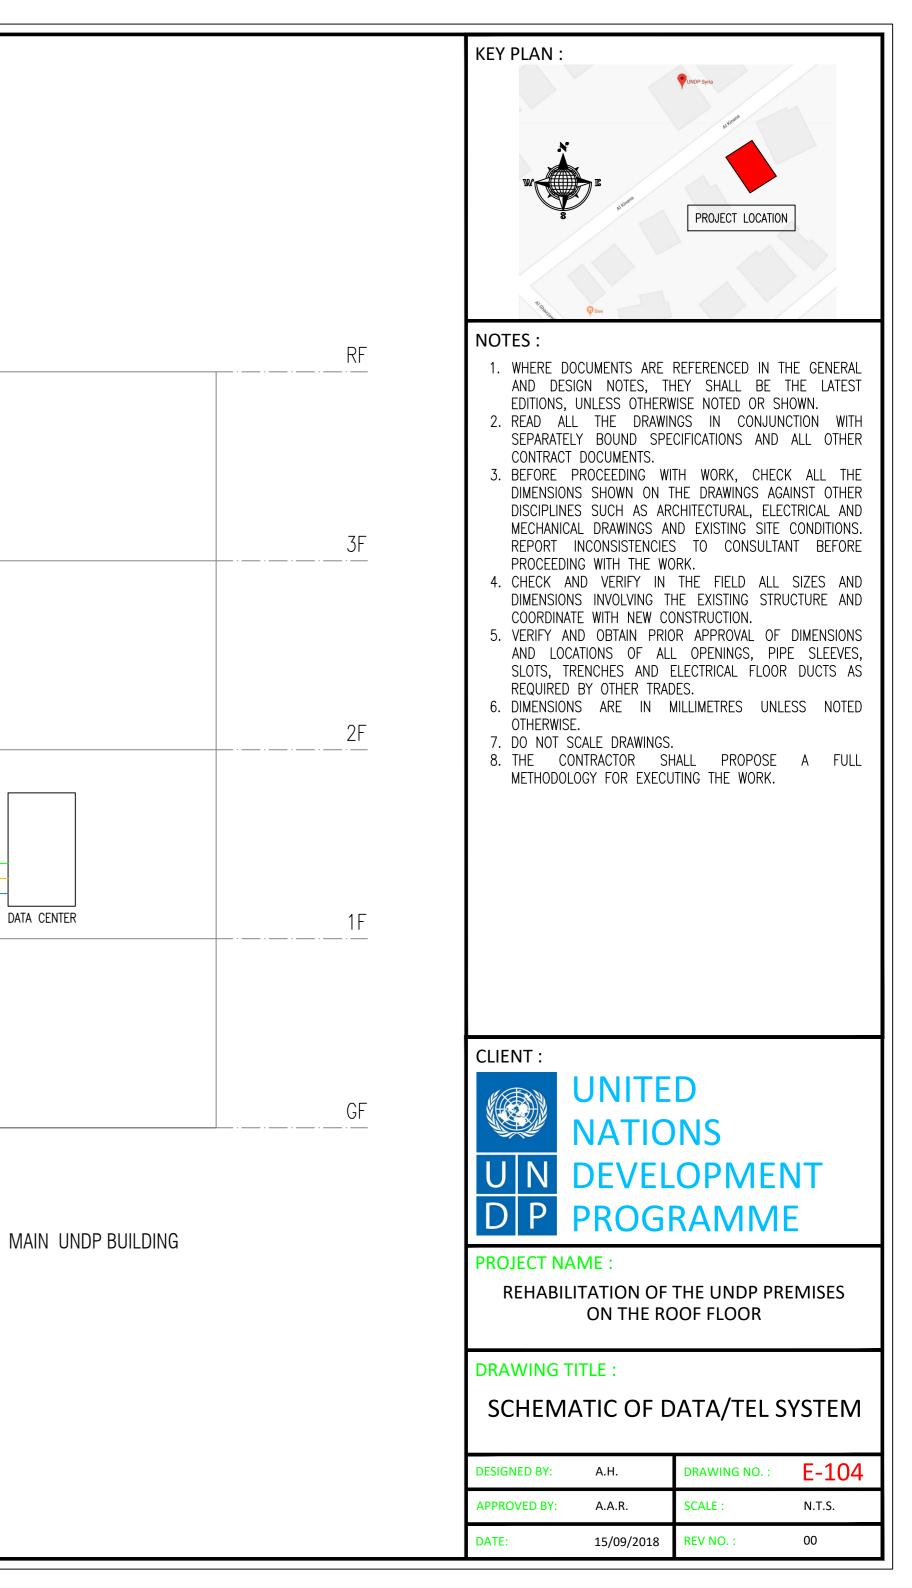

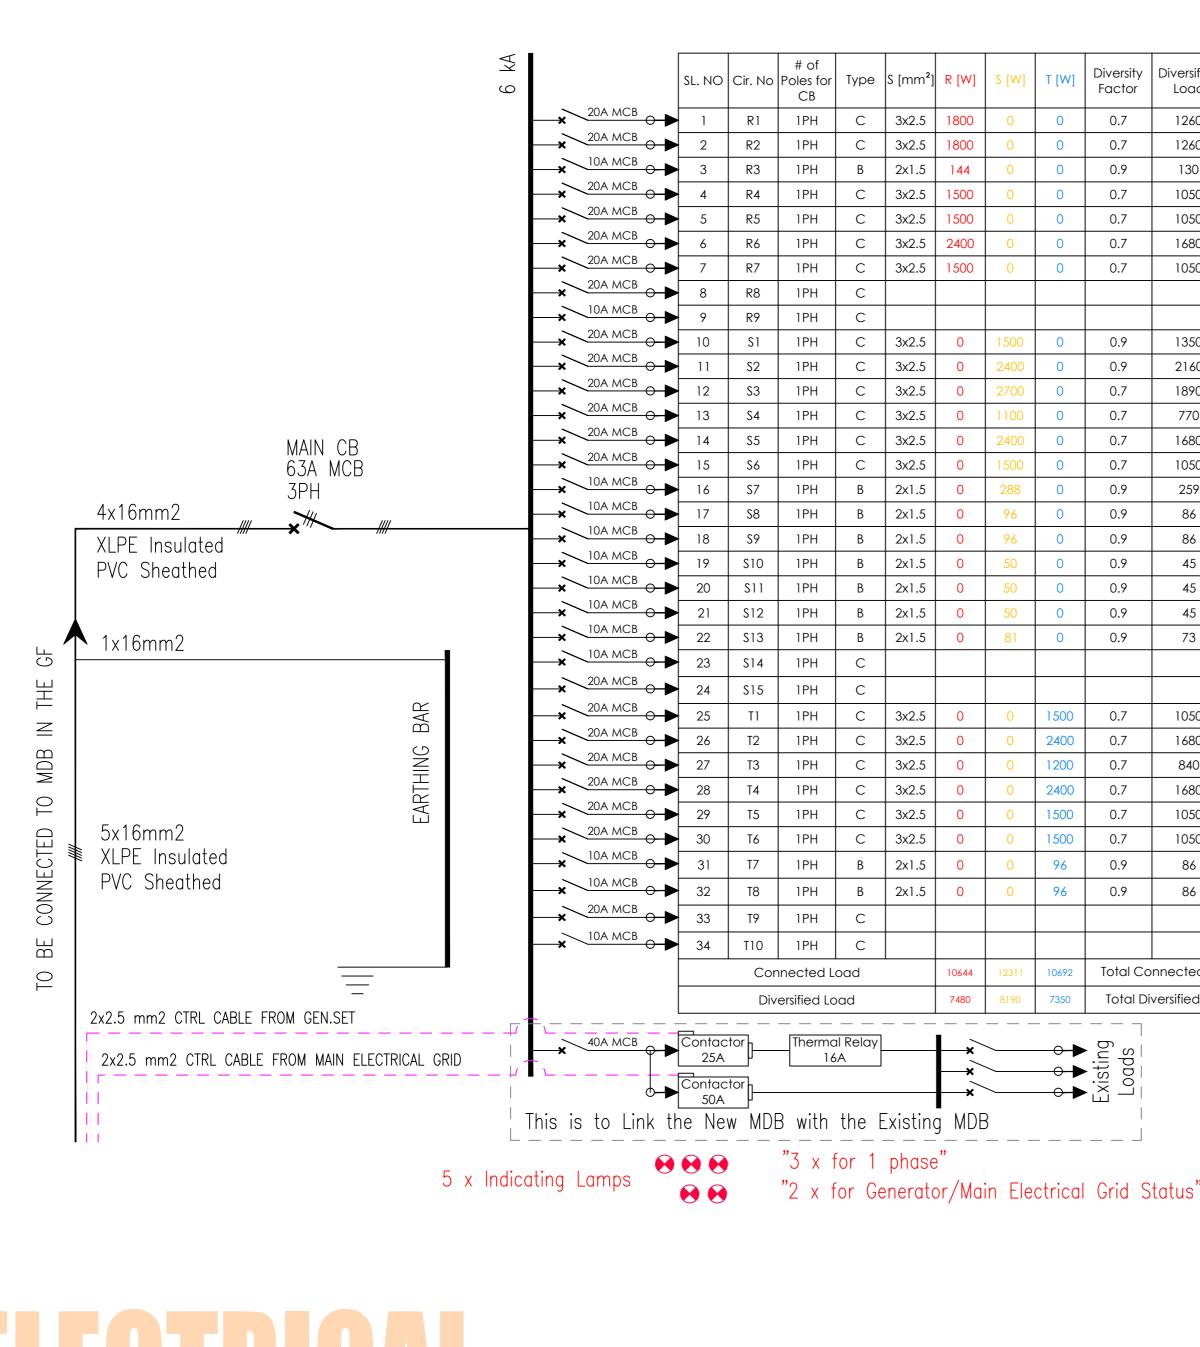


ELECTRICAL LOAD SCHEDULE & SLD

ity Diversified Load Location		Location		
or	Load	Туре	Localion	
	1260	POWER	OFFICE-05	
	1260	POWER	OFFICE-05	
	130	LIGHT	OFFICE-05	
	1050	MECH	OFFICE-05 - AC - OFFICE-5.2	
	1050	MECH	OFFICE-05 - AC - OFFICE-5.1	
	1680	POWER	OFFICE-04	
	1050	MECH	OFFICE-04 - AC - OFFICE-4	
			SPARE	
			SPARE	
	1350	POWER	WET AREA	
	2160	POWER	SERVER CABINET	
	1890	POWER	CORRIDOR	
	770	POWER	CORRIDOR	
	1680	POWER	OFFICE-03	
	1050	MECH	OFFICE-03	
	259	LIGHT	KITCHEN + CORRIDOR	
	86	LIGHT	OFFICE-04	
	86	LIGHT	OFFICE-03	
	45	LIGHT	EXTERNAL LIGHTING	
	45	LIGHT	EXTERNAL LIGHTING	
	45	LIGHT	EXTERNAL LIGHTING	
	73	LIGHT	ENTRANCE LIGHTING	
			Spare	
			Space	
	1050	POWER	OFFICE-02	
	1680	POWER	OFFICE-02	
	840	POWER	OFFICE-01	
	1680	POWER	OFFICE-01	
	1050	MECH	OFFICE-02	
	1050	MECH	OFFICE-01	
	86	LIGHT	OFFICE-02	
	86	LIGHT	OFFICE-02	
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Connected Logid Turt		nd [kw]	33.6470	
Connected Load [kW]				
II DI	versified Loa	ia [km]	23.0195	
			ALL THE ENLIPMENT WITH 20 9 SADCE	

TO FIT ALL THE EQUIPMENT WITH 20 % SAPCE Surface-mounted Type Metal With Cover and Lock 96 Modules IP40

Main Distribution Board - MDB

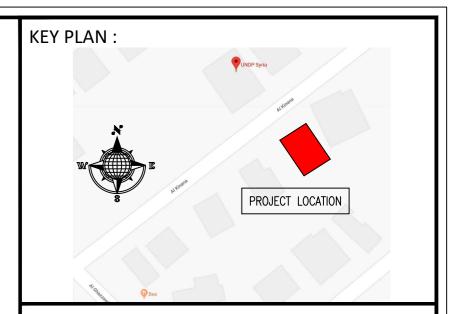

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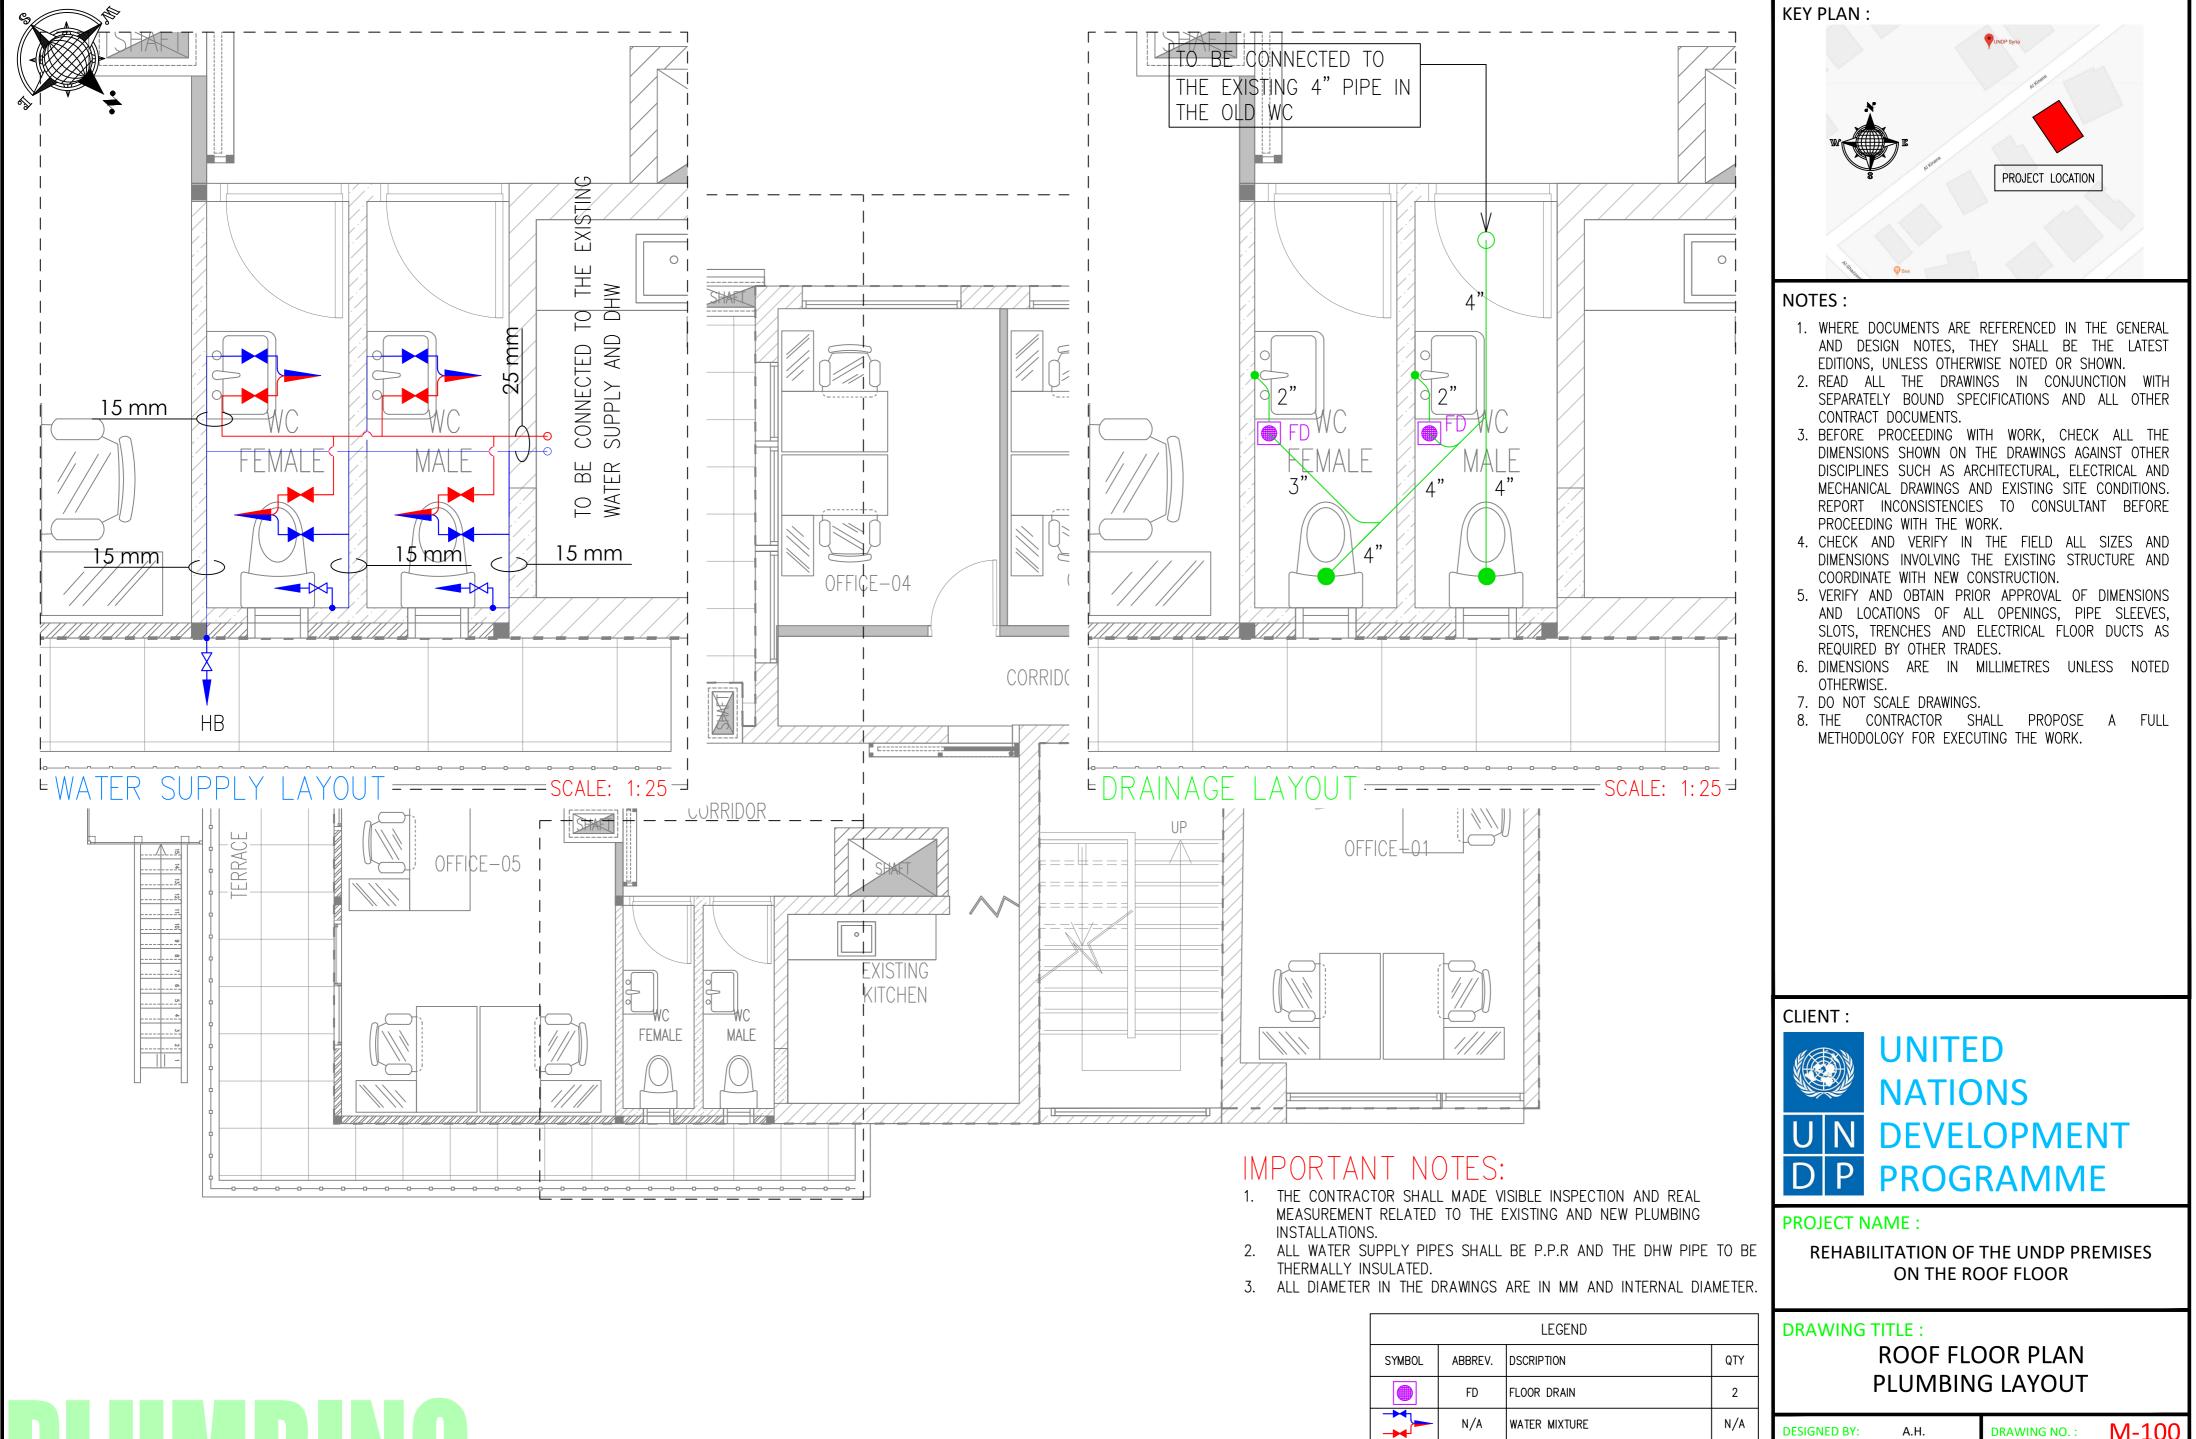
PROJECT NAME :

REHABILITATION OF THE UNDP PREMISES ON THE ROOF FLOOR

DRAWING TITLE :

ELECTRICAL LOAD SCHEDULE

DESIGNED BY:	A.H.	DRAWING NO. :	E-105
APPROVED BY:	A.A.R.	SCALE :	N.T.S.
DATE:	15/09/2018	REV NO. :	00



DESIGNED BY:	A.H.	DRAWING NO. :	M-100
APPROVED BY:	A.A.R.	SCALE :	1:50
DATE:	15/09/2018	REV NO. :	00

HOSE BIB

HOT WATER

COLD WATER SUPPLY / DOMESTIC

1

N/A

HB

N/A

->-

