


EXISTING PARTITION WALL - TO BE DEMOLISHED






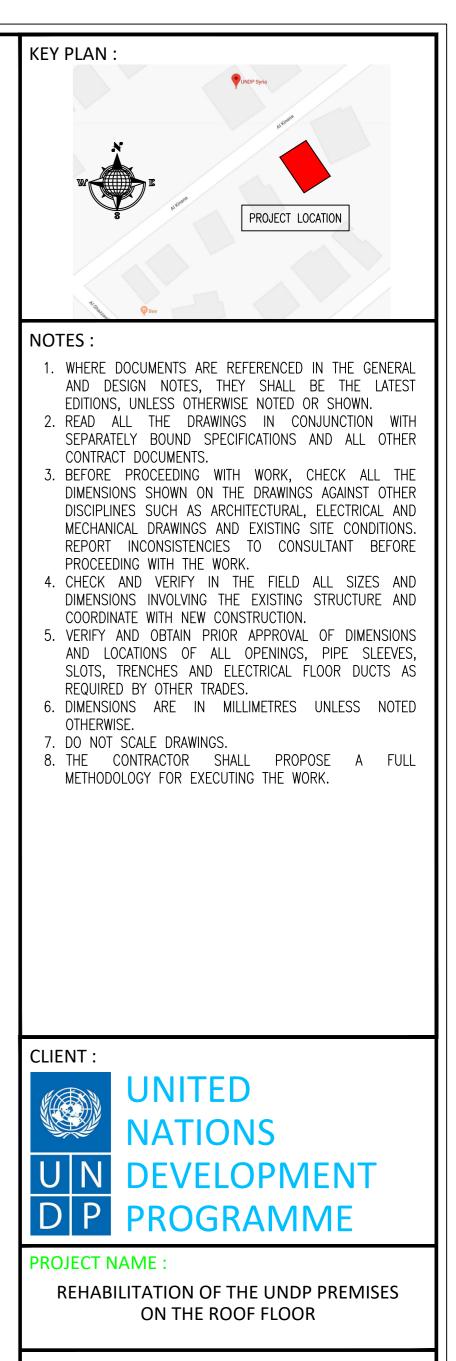


#### **DRAWING TITLE :**

### **ROOF PLAN LAYOUT - AS-BUILT**


DESIGNED BY:	A.H.	DRAWING NO. :	A-100
APPROVED BY:	A.A.R.	SCALE :	1:50
DATE:	15/09/2018	REV NO. :	00

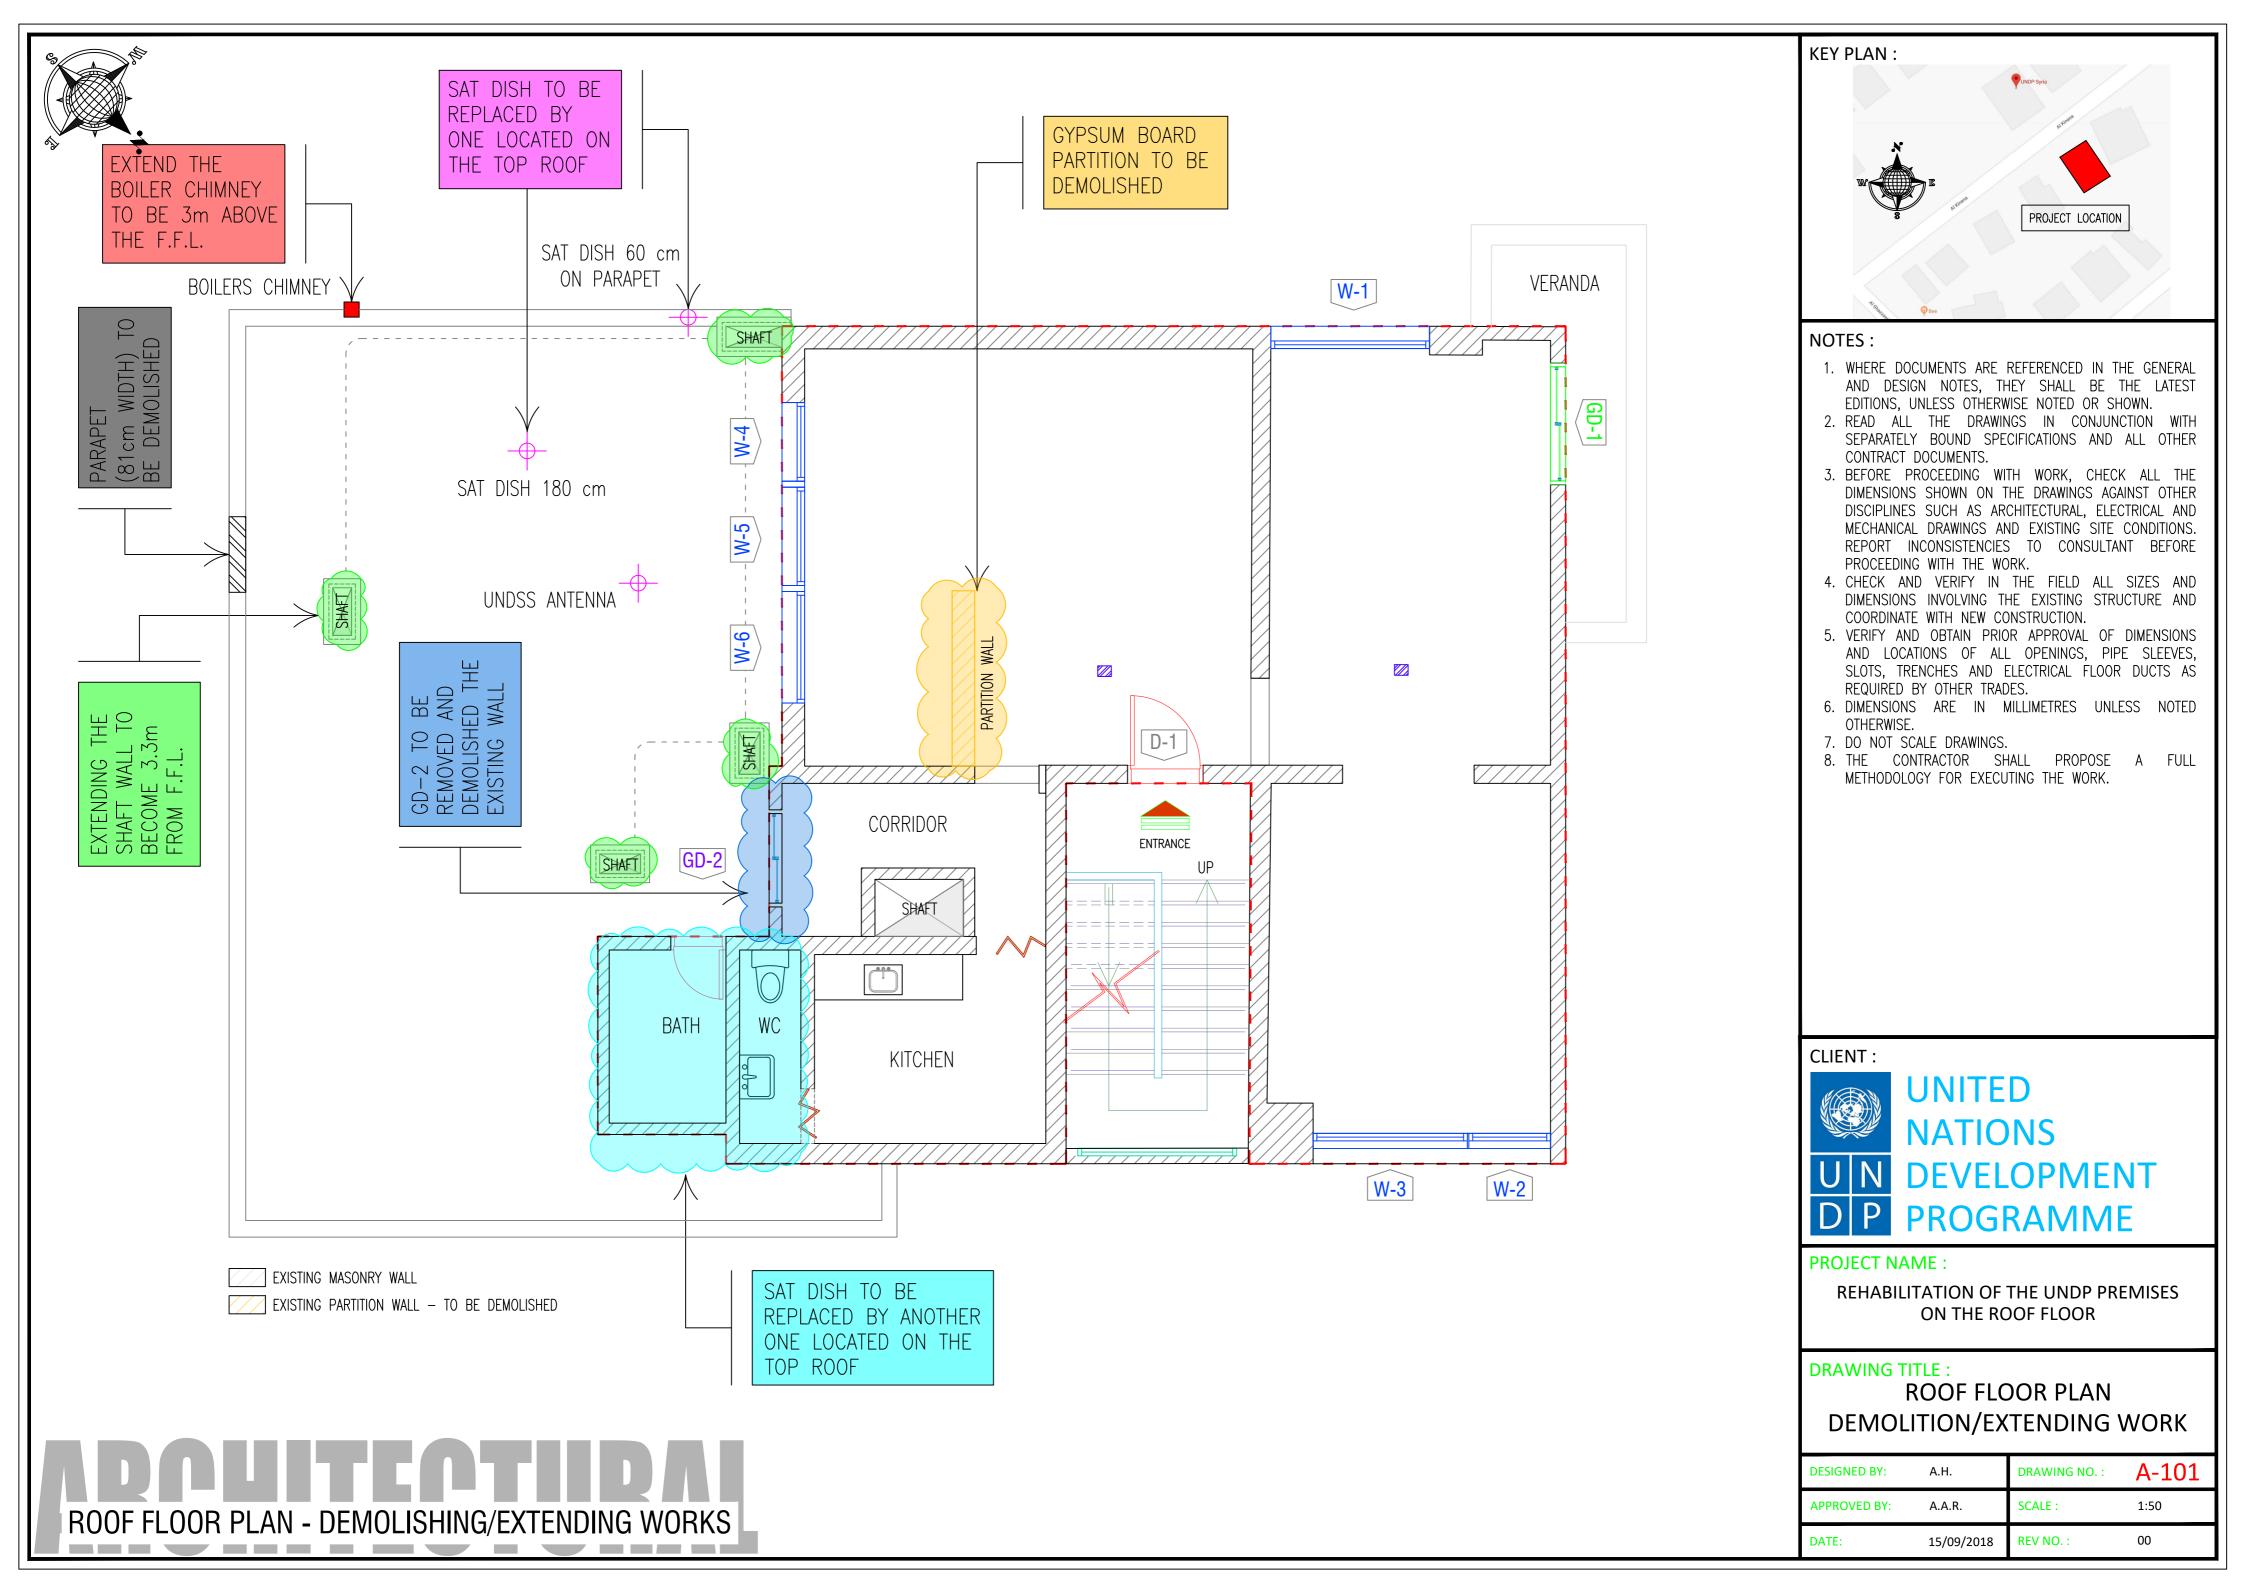

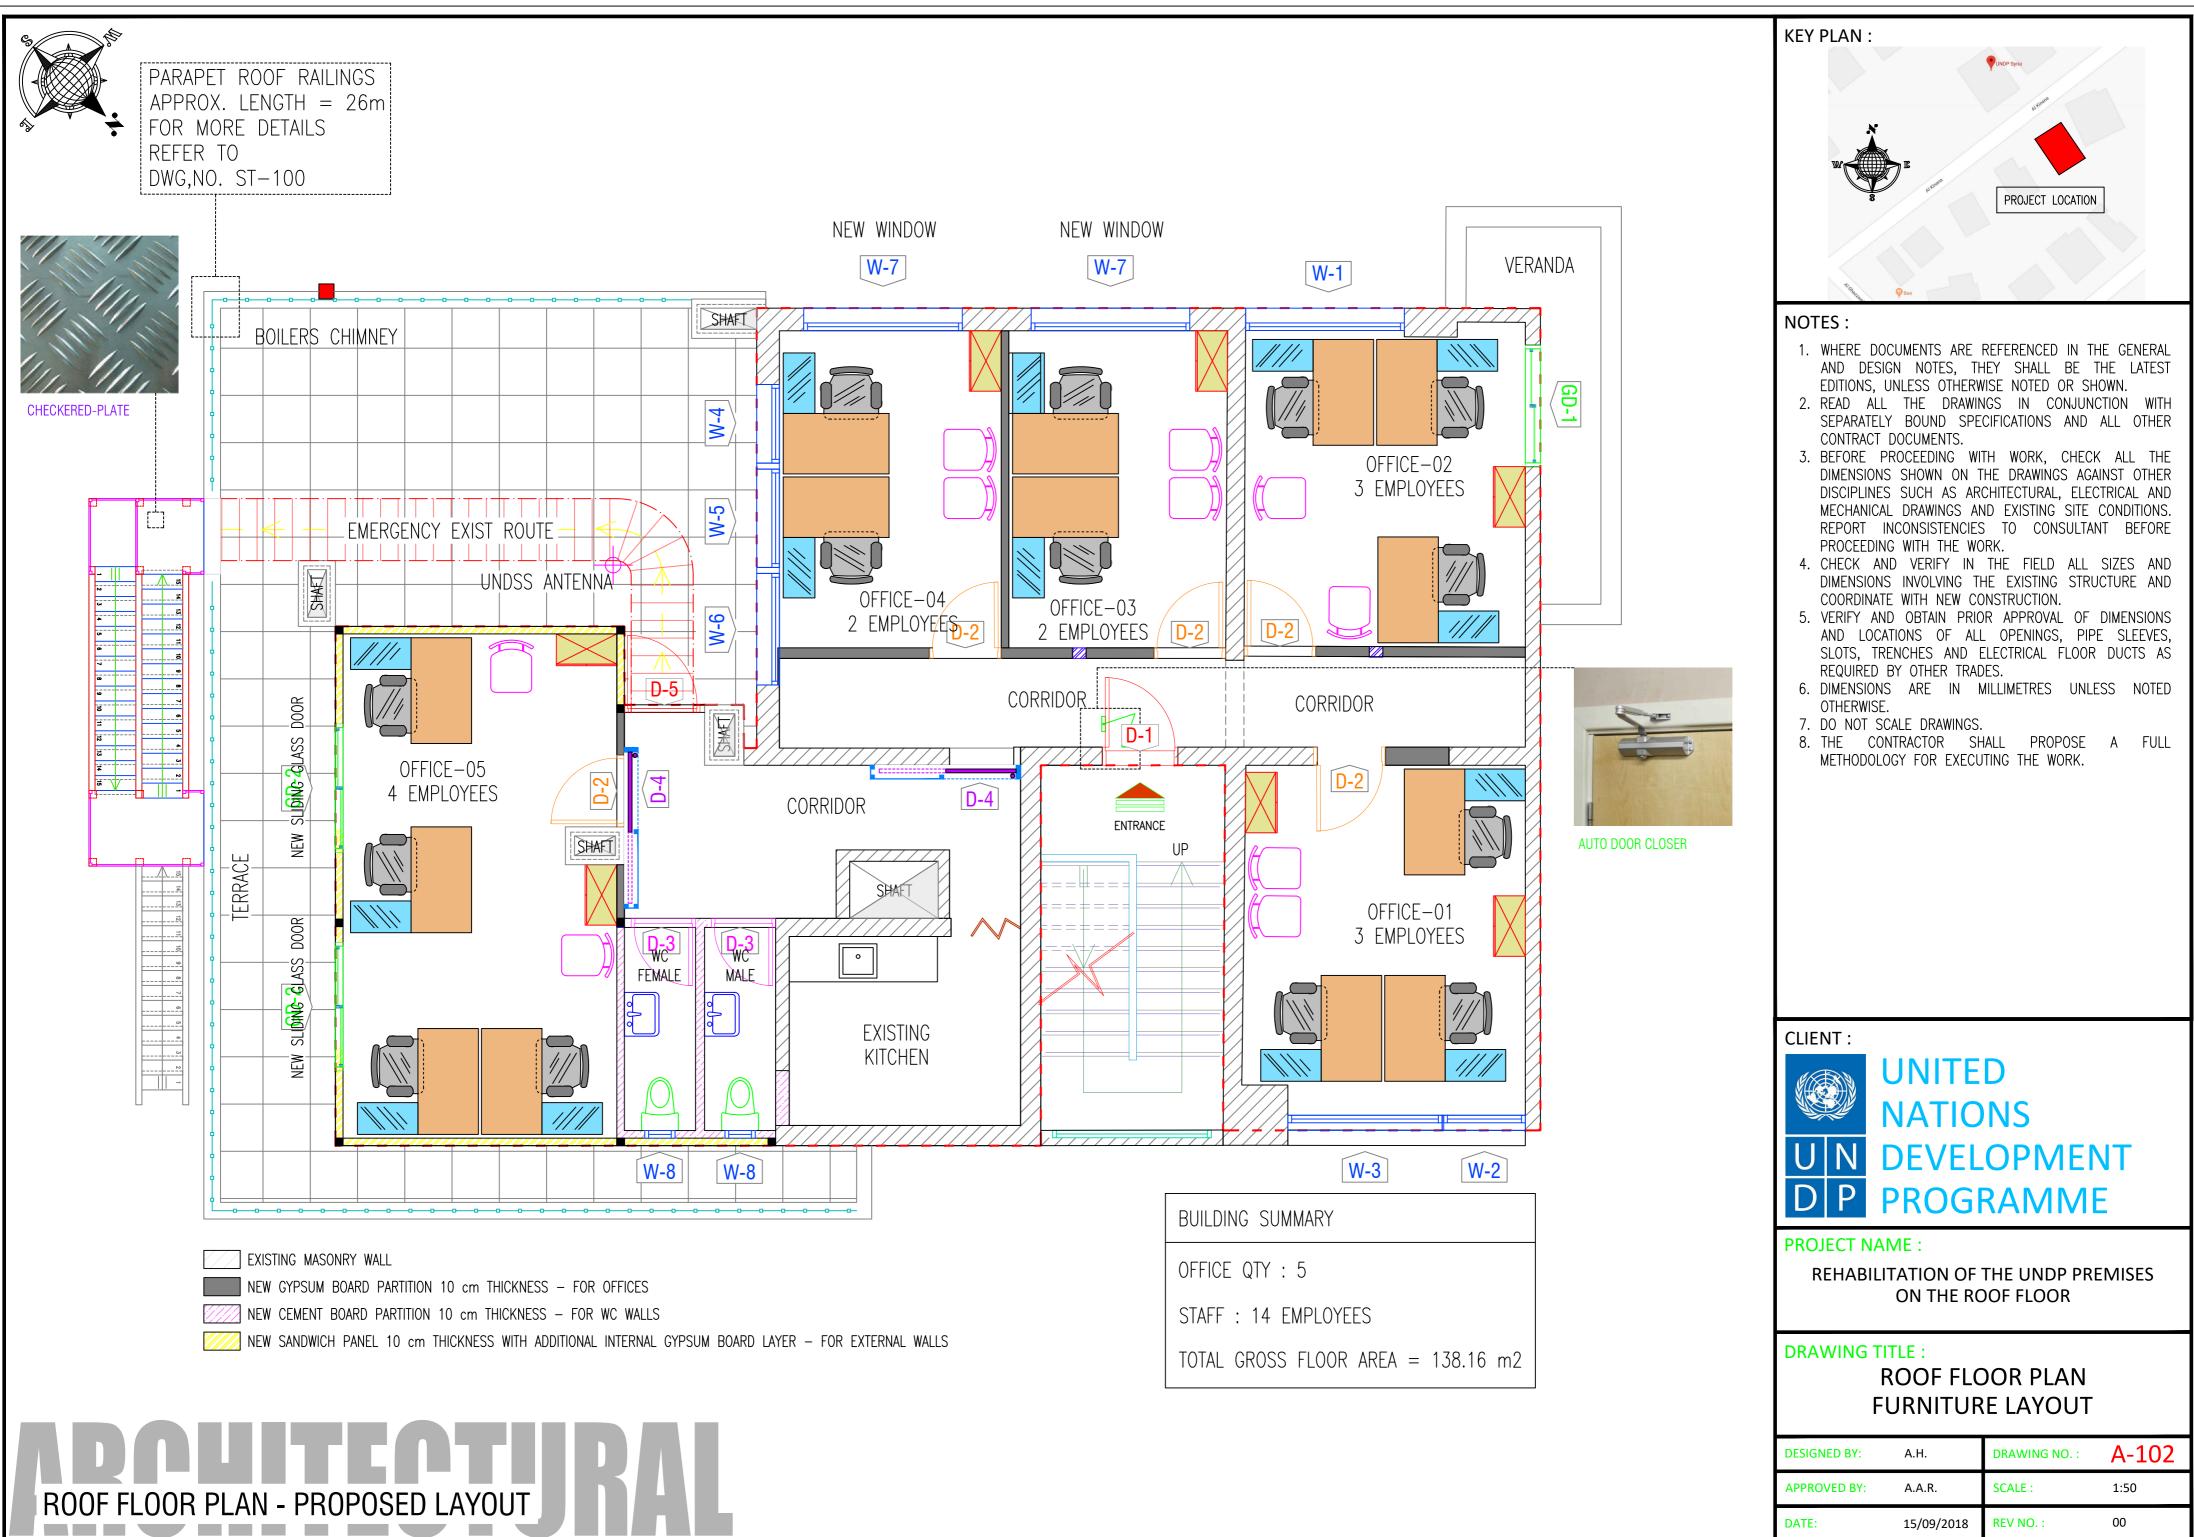

DESIGNED BY:	A.H.	DRAWING NO. :	A-102
APPROVED BY:	A.A.R.	SCALE :	1:50
DATE:	15/09/2018	REV NO. :	00



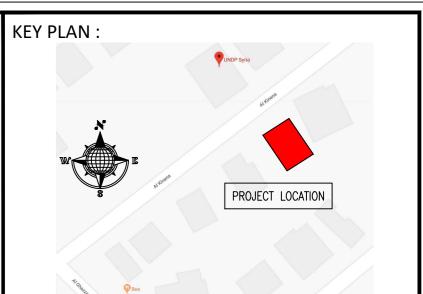

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### CLIENT :




### PROJECT NAME :


REHABILITATION OF THE UNDP PREMISES ON THE ROOF FLOOR


### DRAWING TITLE :

### ROOF FLOOR PLAN 3D PERSPECTIVES


DESIGNED BY:	A.H.	DRAWING NO. :	A-103
APPROVED BY:	A.A.R.	SCALE :	1:50
DATE:	15/09/2018	REV NO. :	00

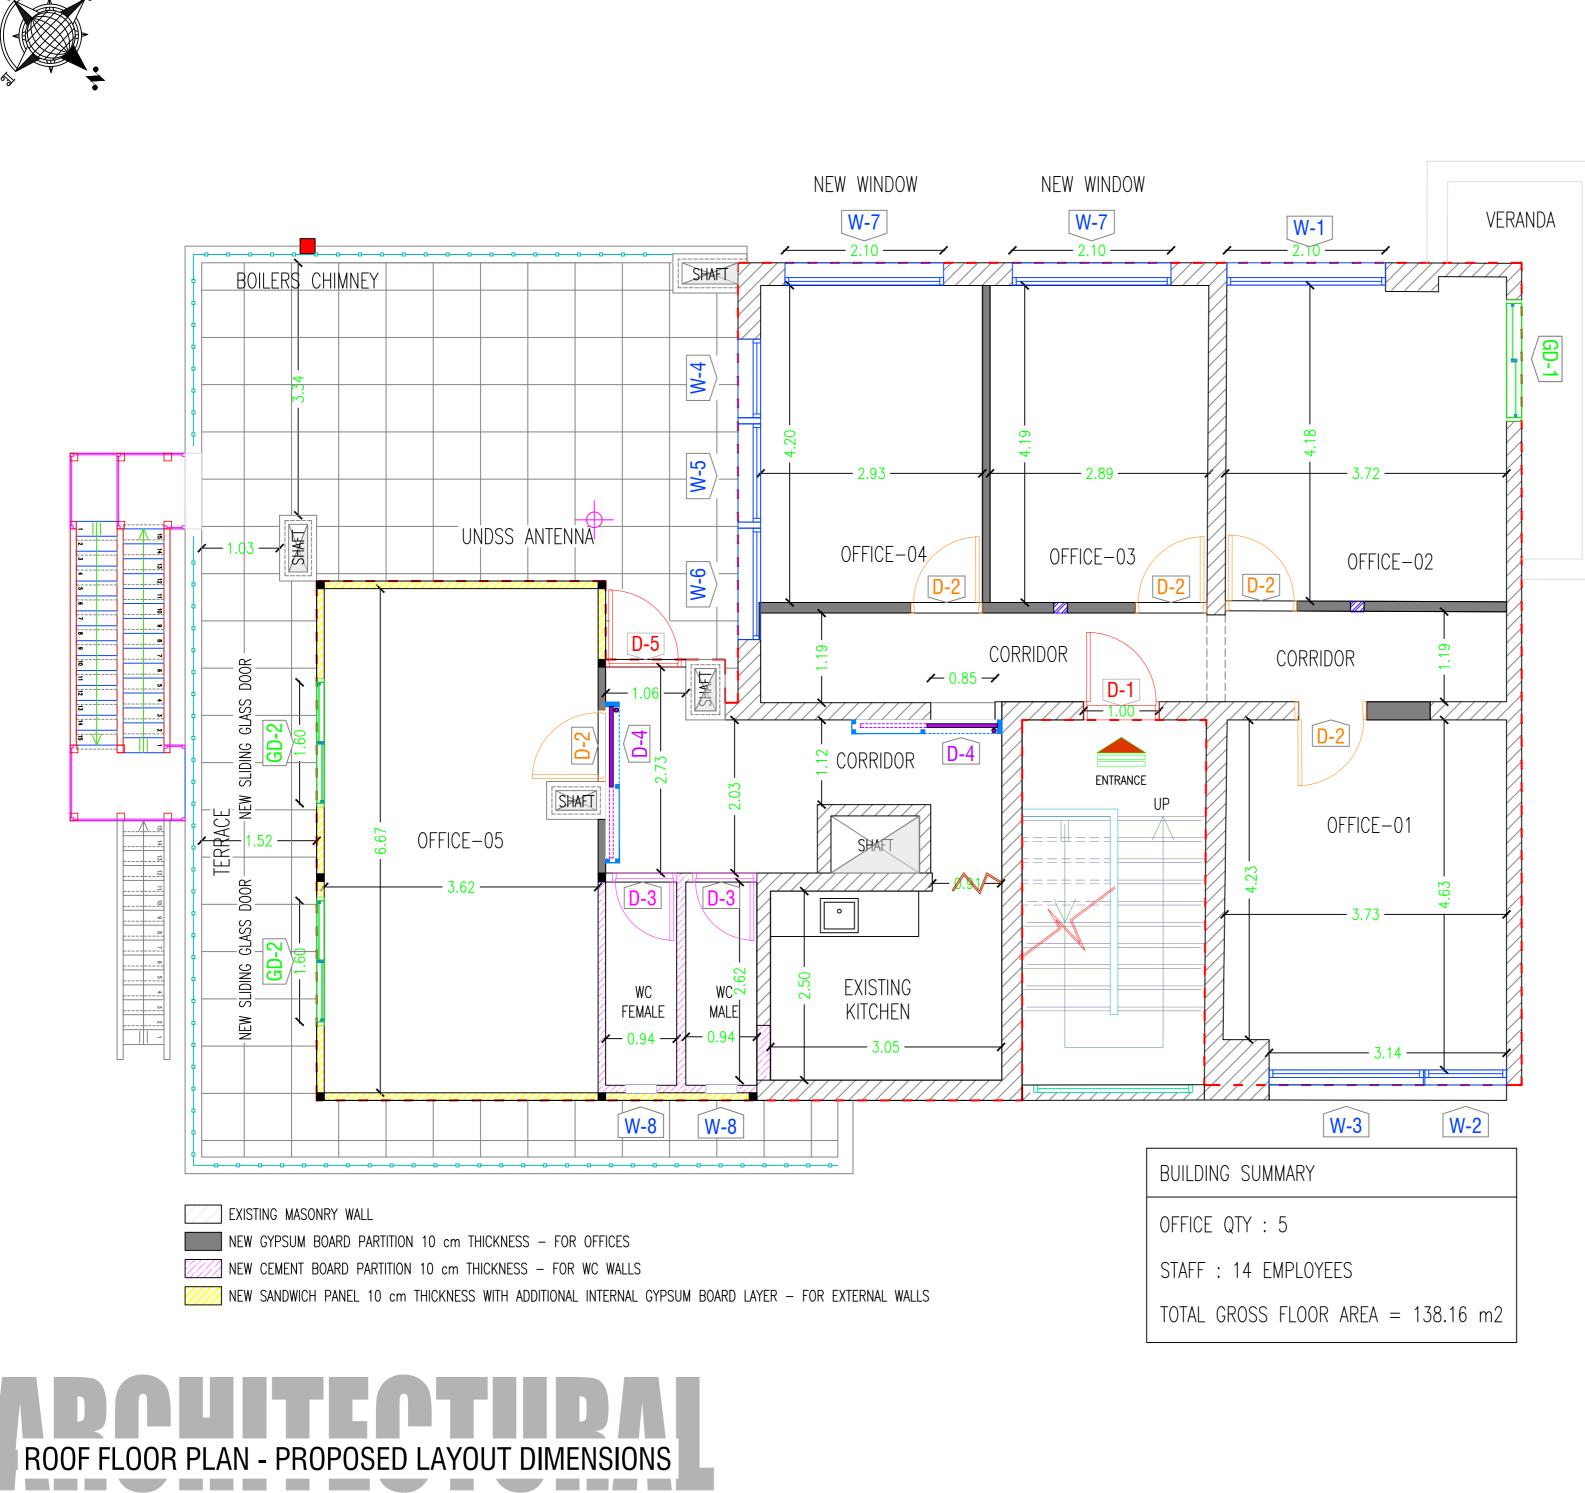


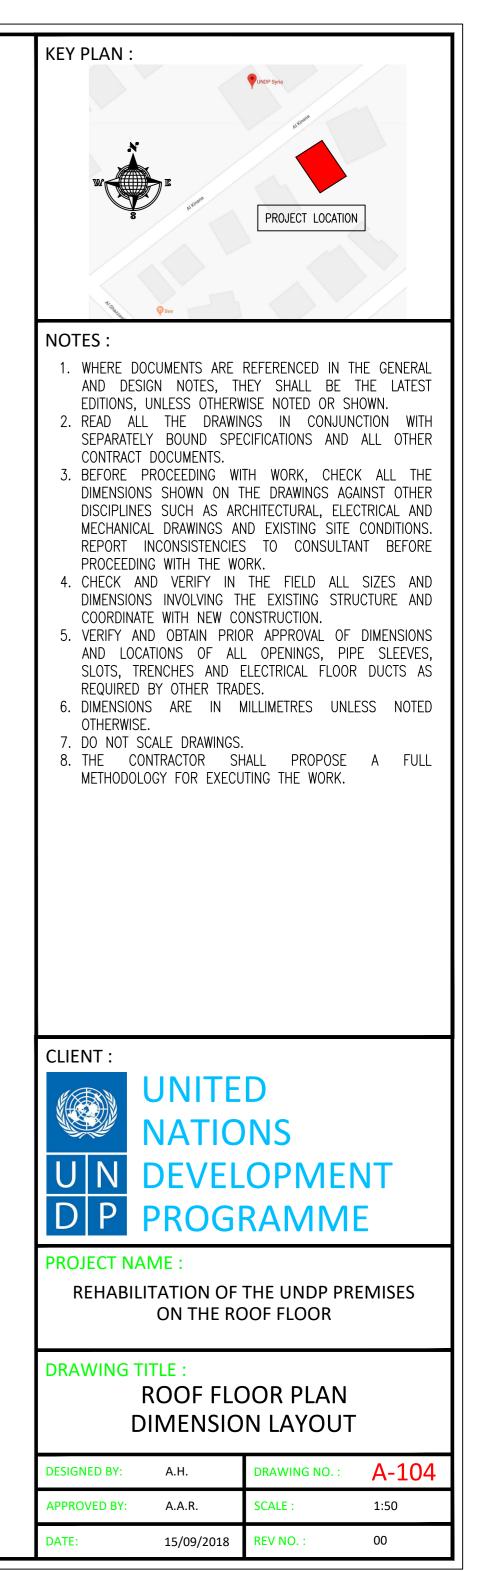

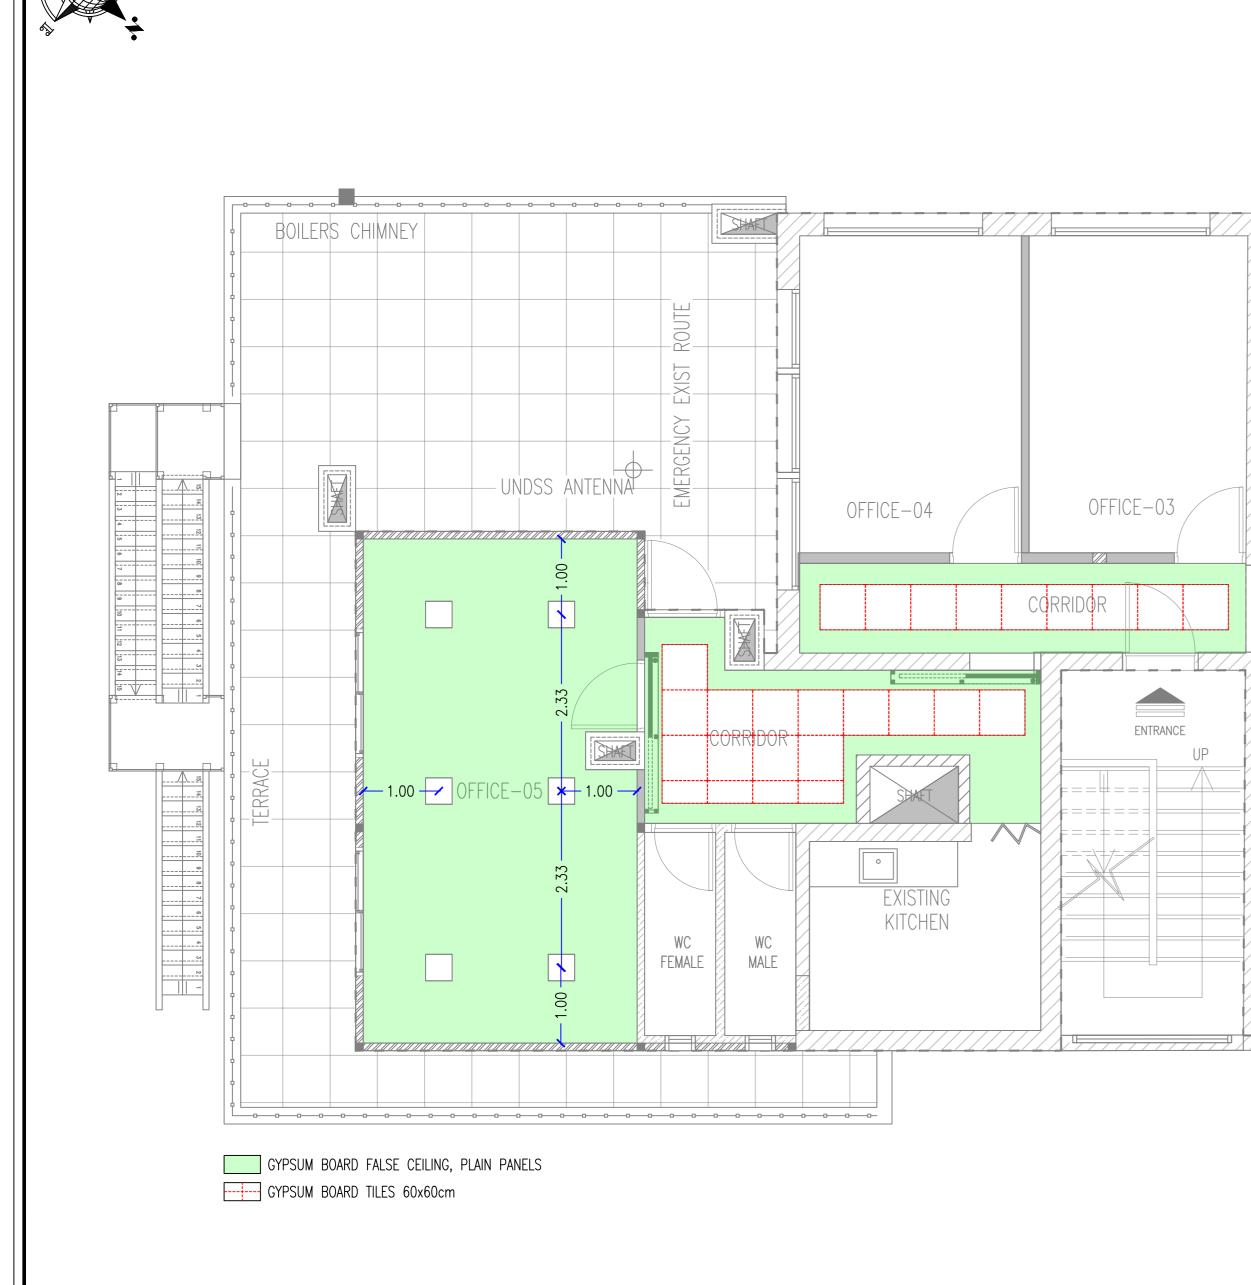



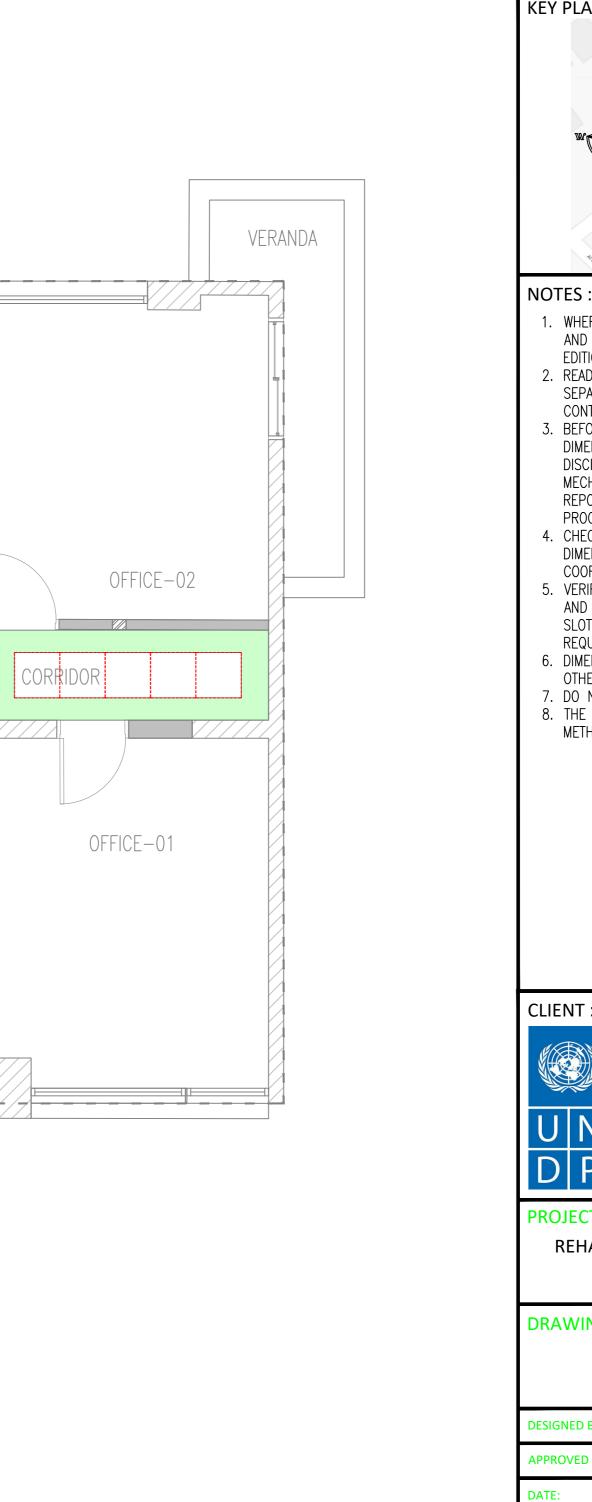


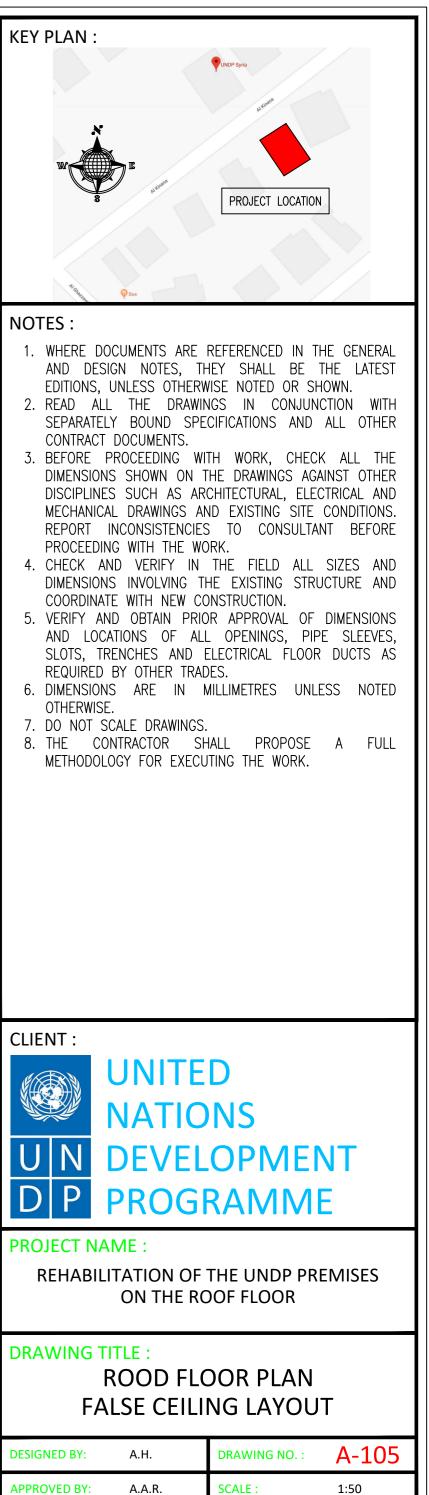

15/09/2018


REV NO. :

00

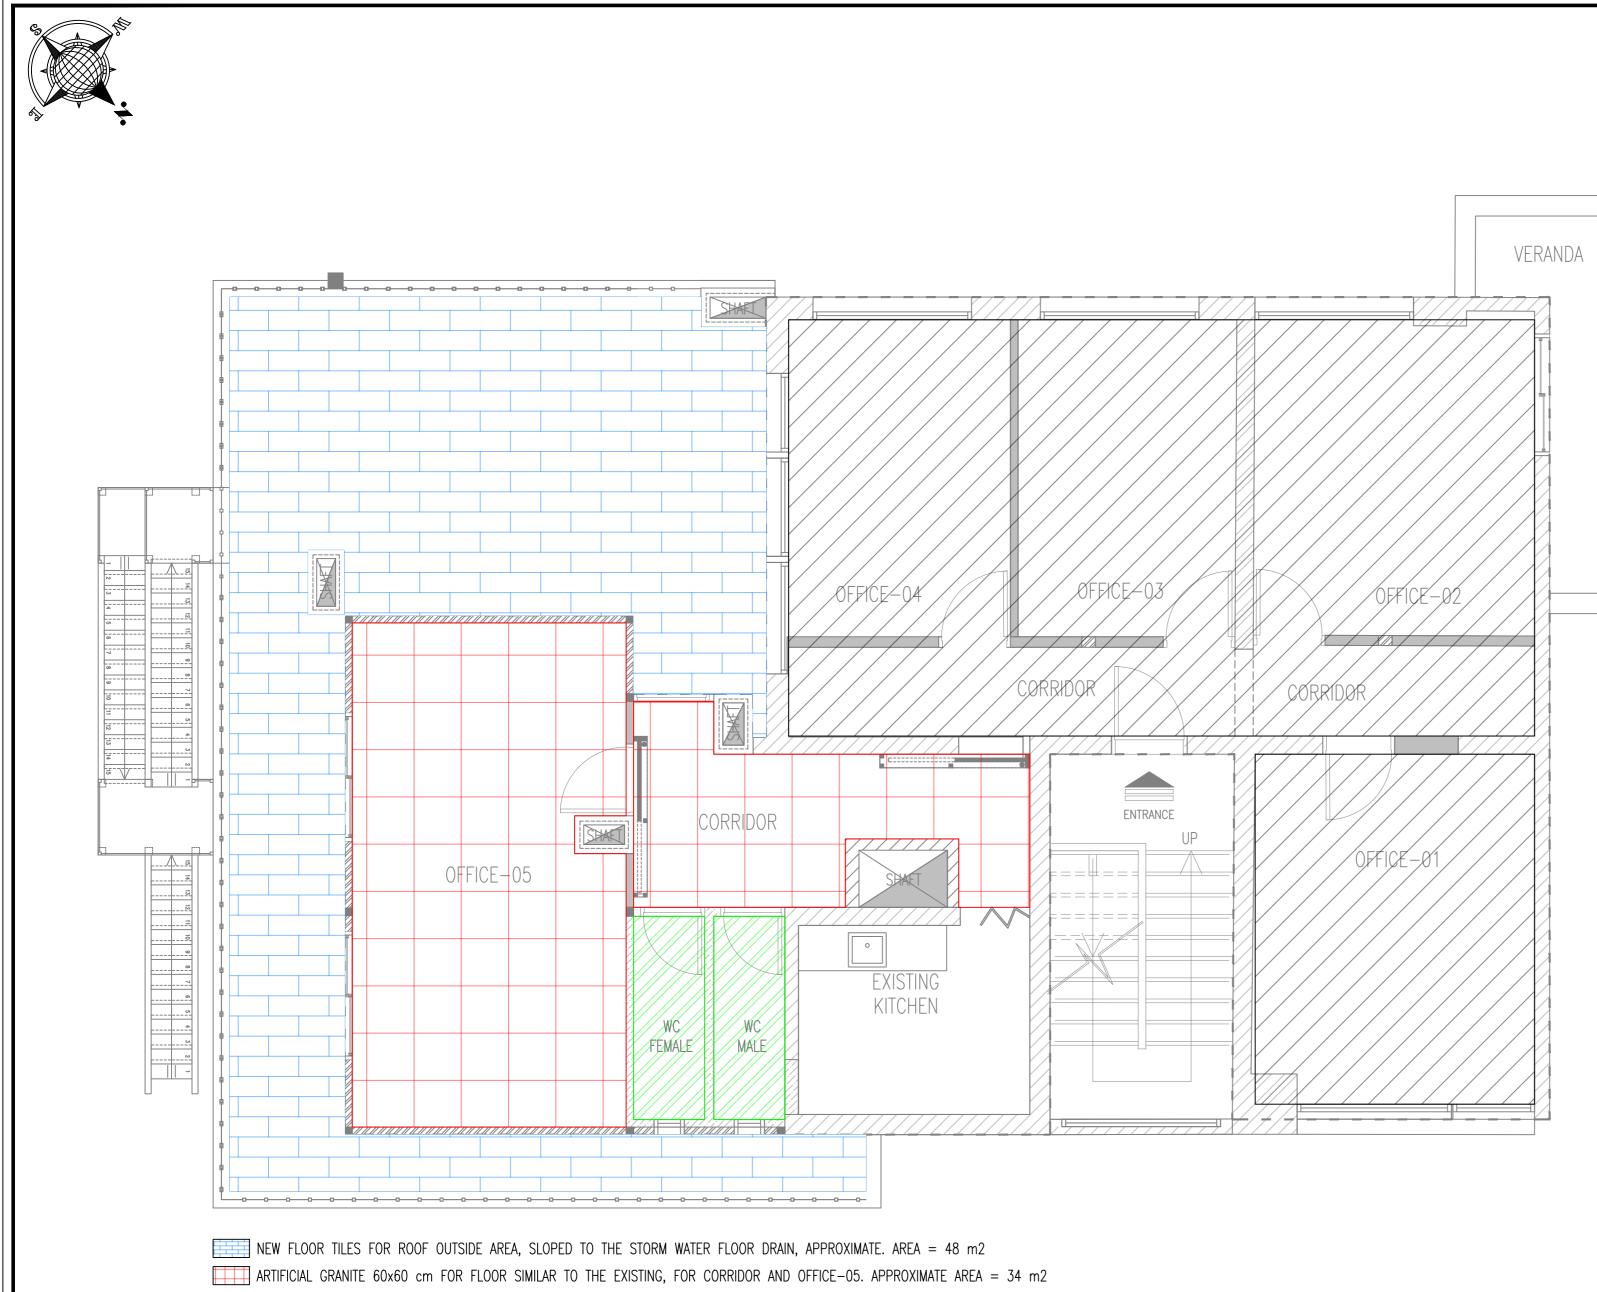


ARTIFICIAL GRANITE 60x60 cm FOR FLOOR SIMILAR TO THE EXISTING, FOR CORRIDOR AND OFFICE-05. APPROXIMATE AREA = 34 m2 CERAMIC FLOOR TILES, SPECIFIED DIMENSION AS THE APPROVED SAMPLES PROVIDED BY THE CONTRACTOR. APPROXIMATE ARE = 5 m2 EXISTING FLOORING AREA, REMAINS AS IT IS, UNLESS MAINTENANCE IS REQUIRED.




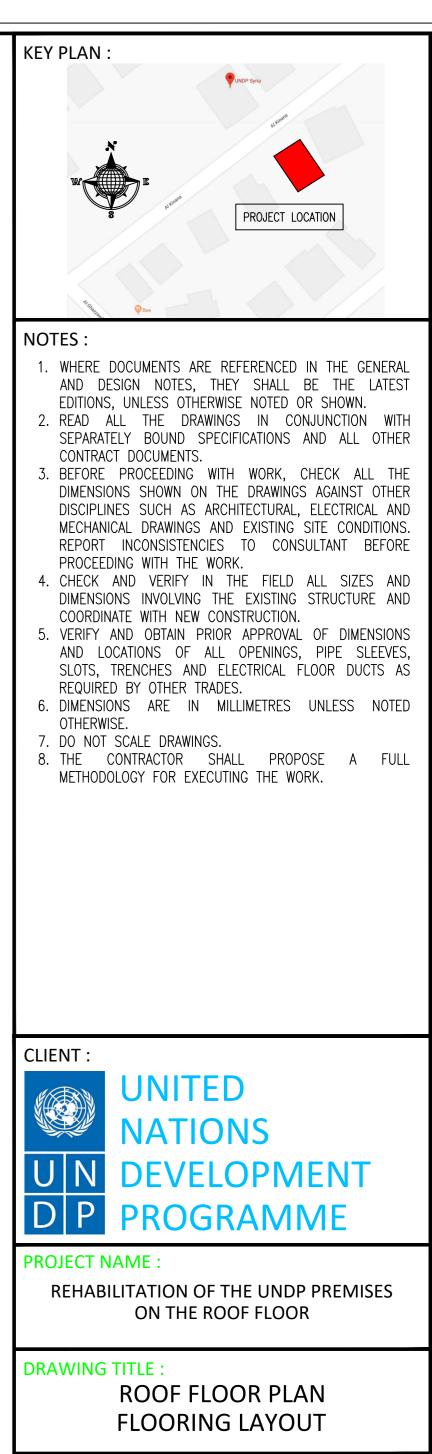


DESIGNED BY:	A.H.	DRAWING NO. :	A-106
APPROVED BY:	A.A.R.	SCALE :	1:50
DATE:	15/09/2018	REV NO. :	00

NOTE: THE SANDWICH PANEL ROOF SHALL BE OFFSET FROM THE BUILDING BOUNDARY WITH 30cm

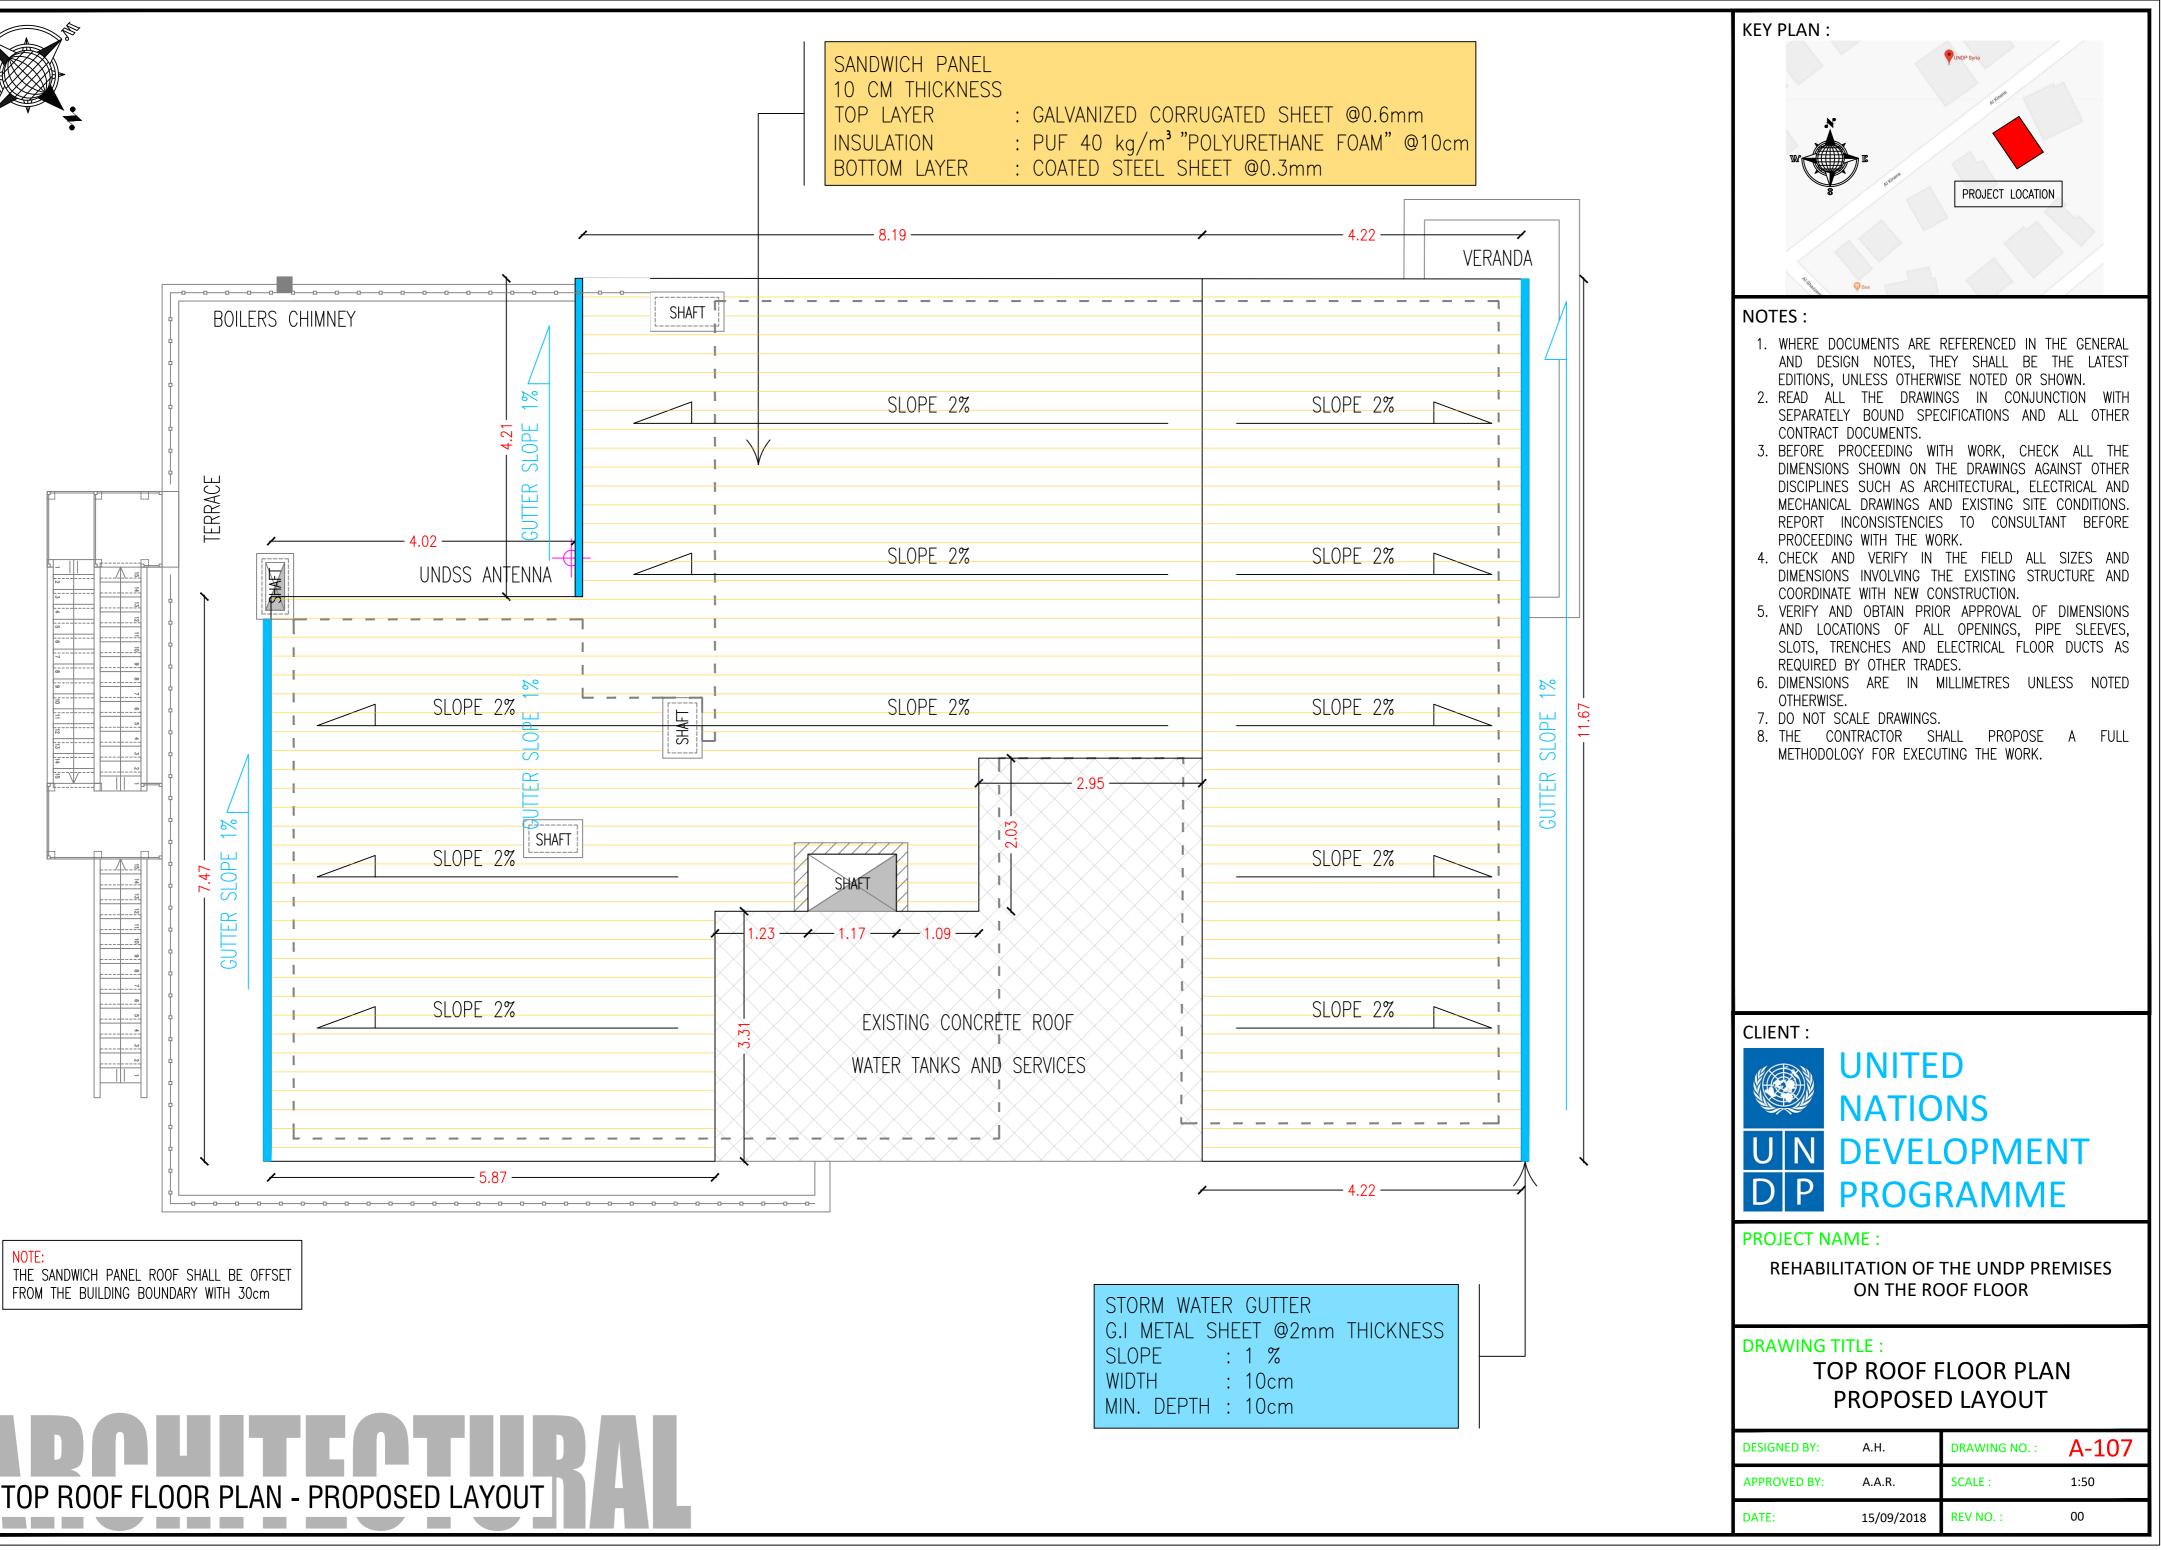


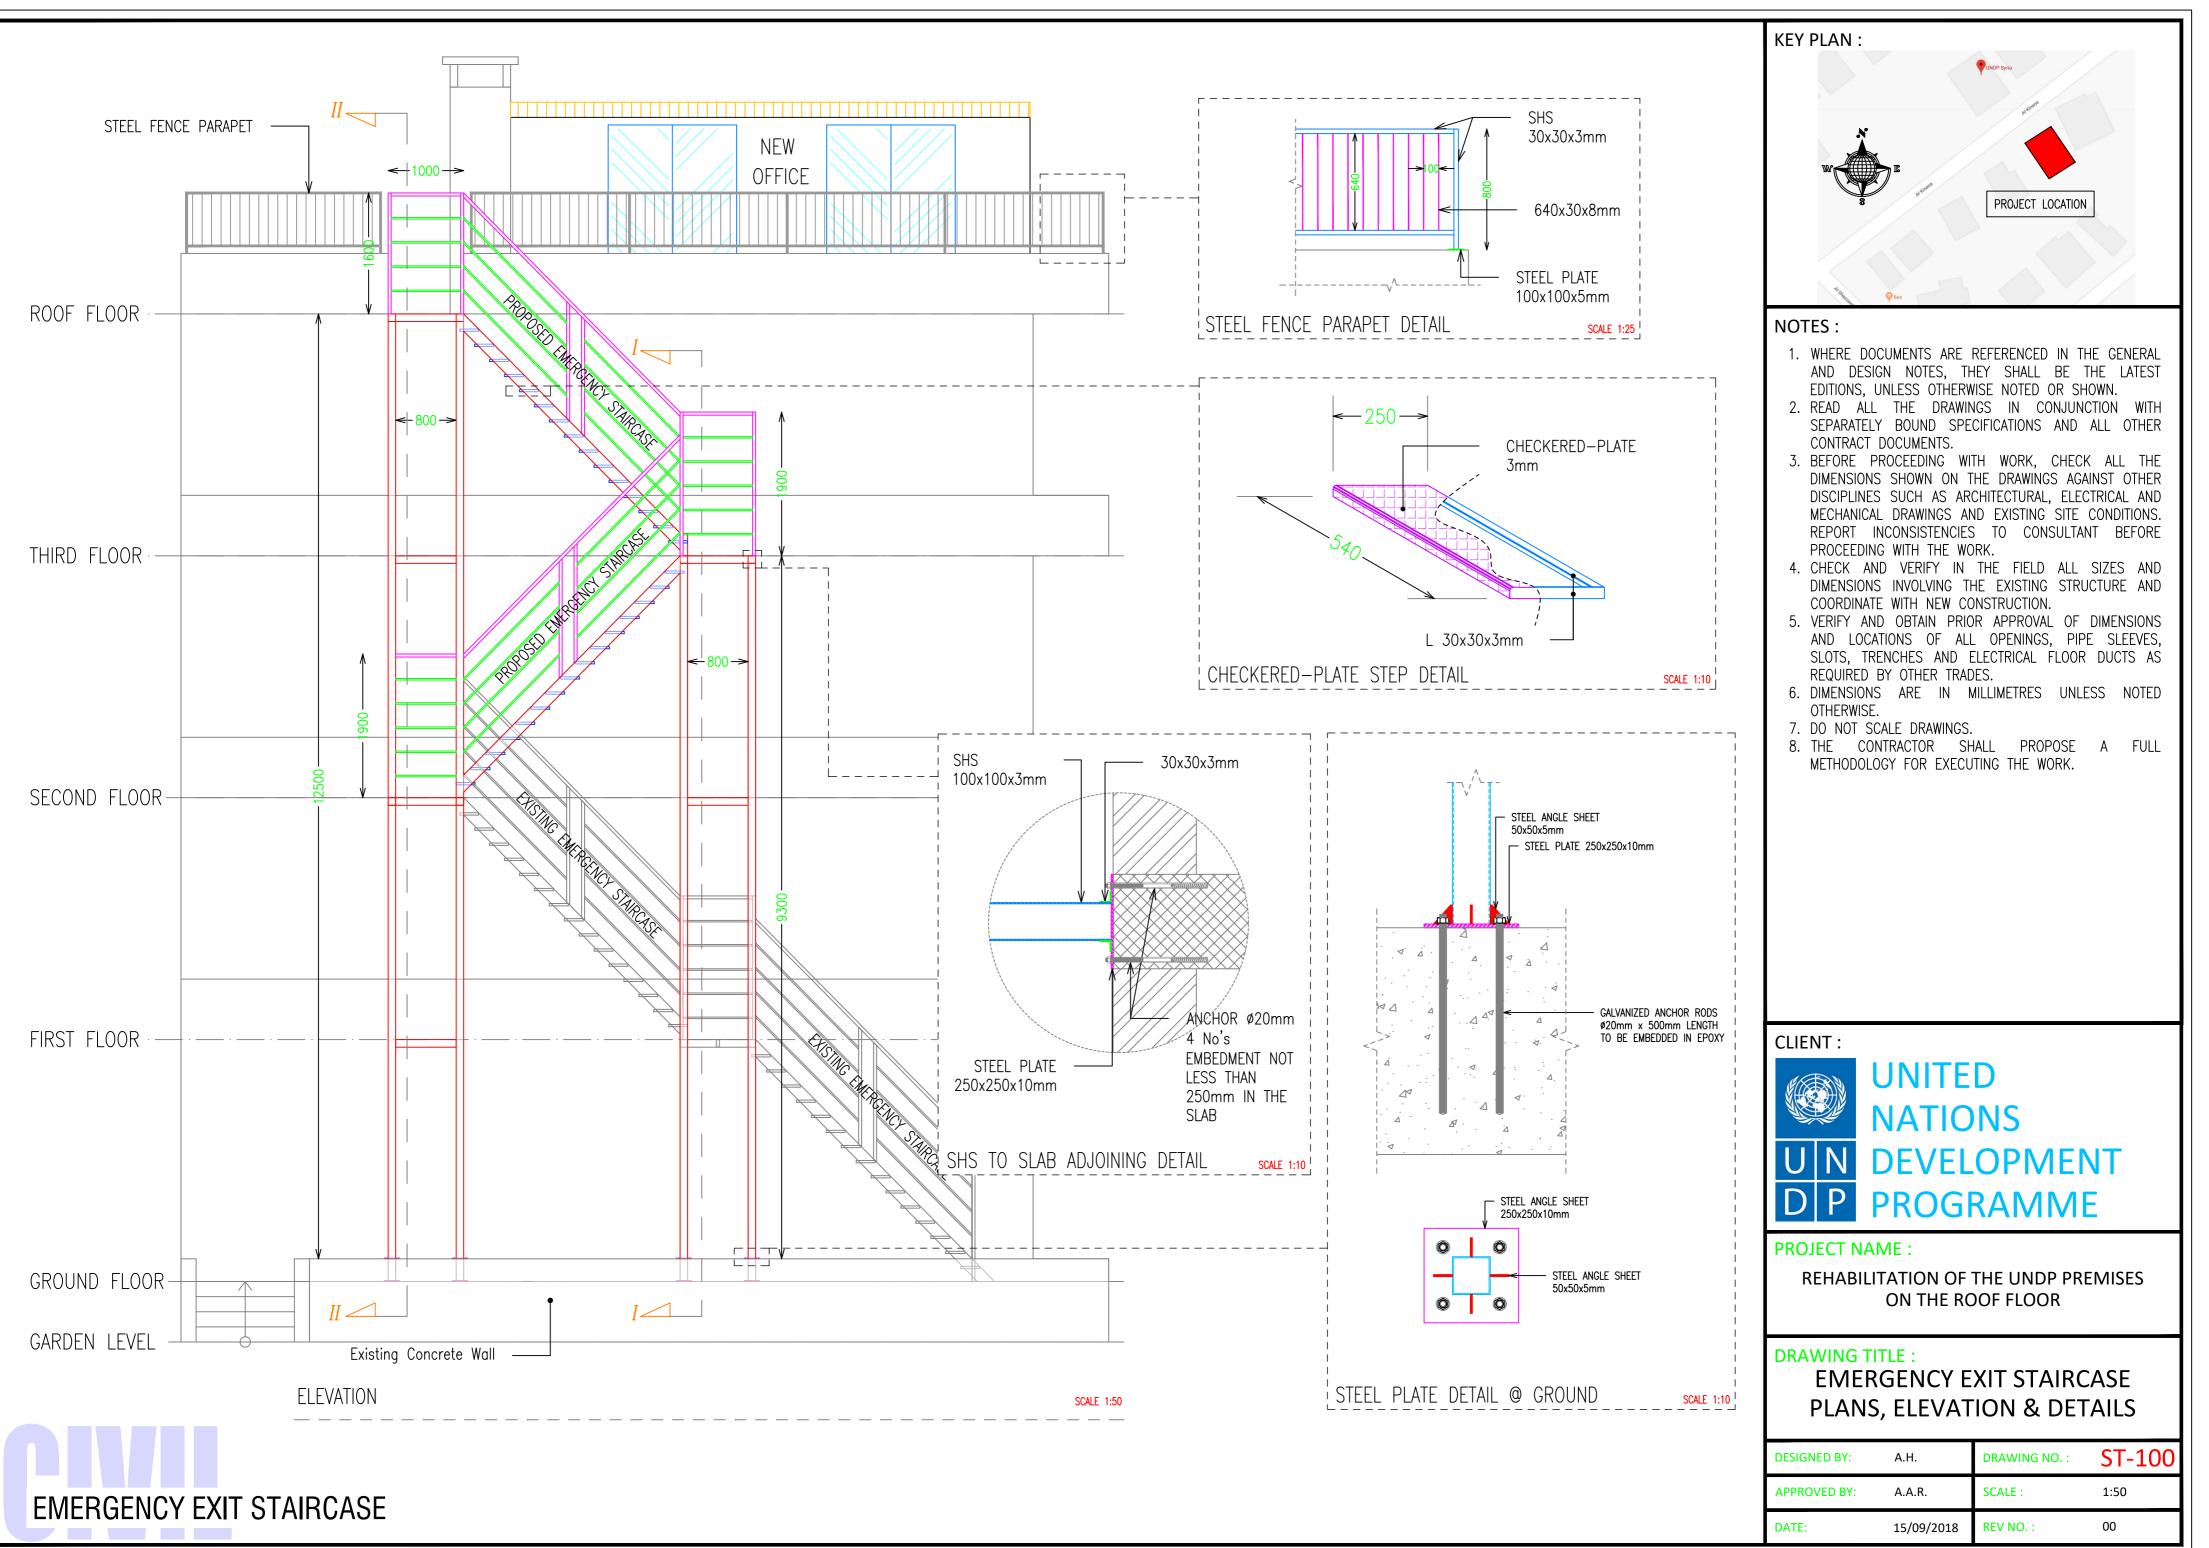

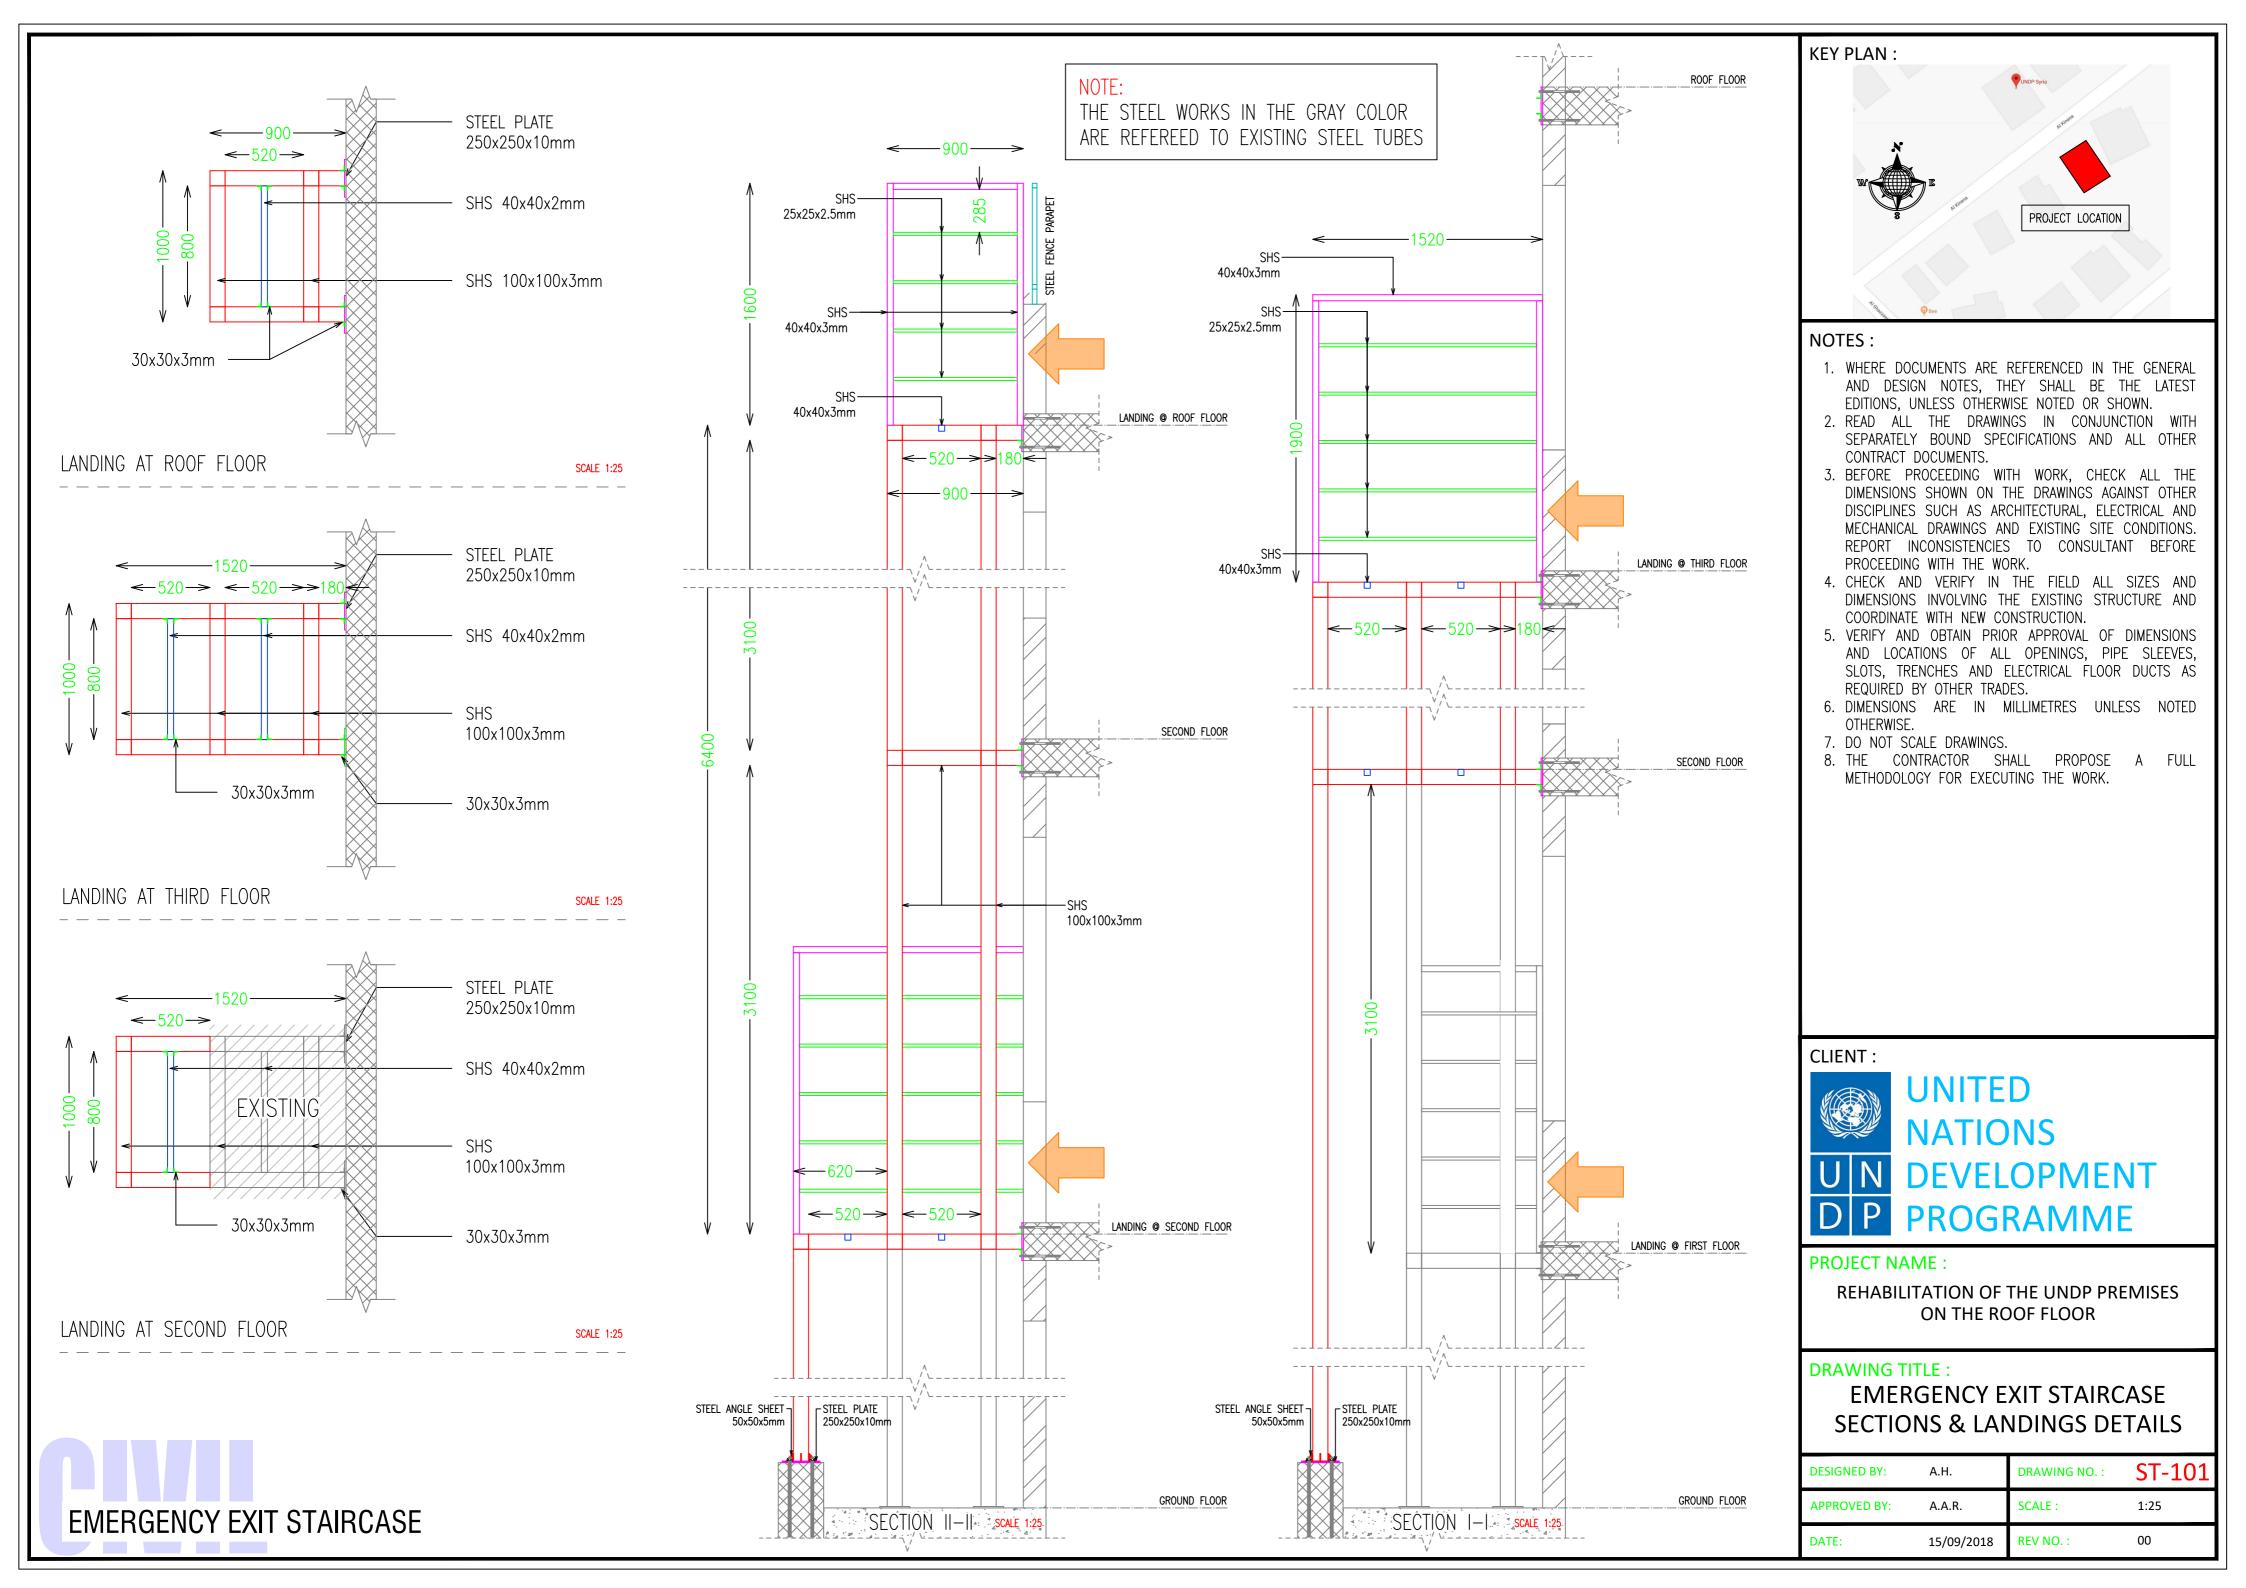





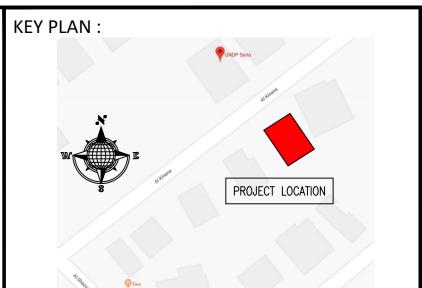

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### CLIENT :





#### PROJECT NAME :

REHABILITATION OF THE UNDP PREMISES ON THE ROOF FLOOR

### DRAWING TITLE : EMERGENCY EXIT STAIRCASE 3D PERSPECTIVES

DESIGNED BY:	A.H.	DRAWING NO. :	ST-102
APPROVED BY:	A.A.R.	SCALE :	1:25
DATE:	15/09/2018	REV NO. :	00

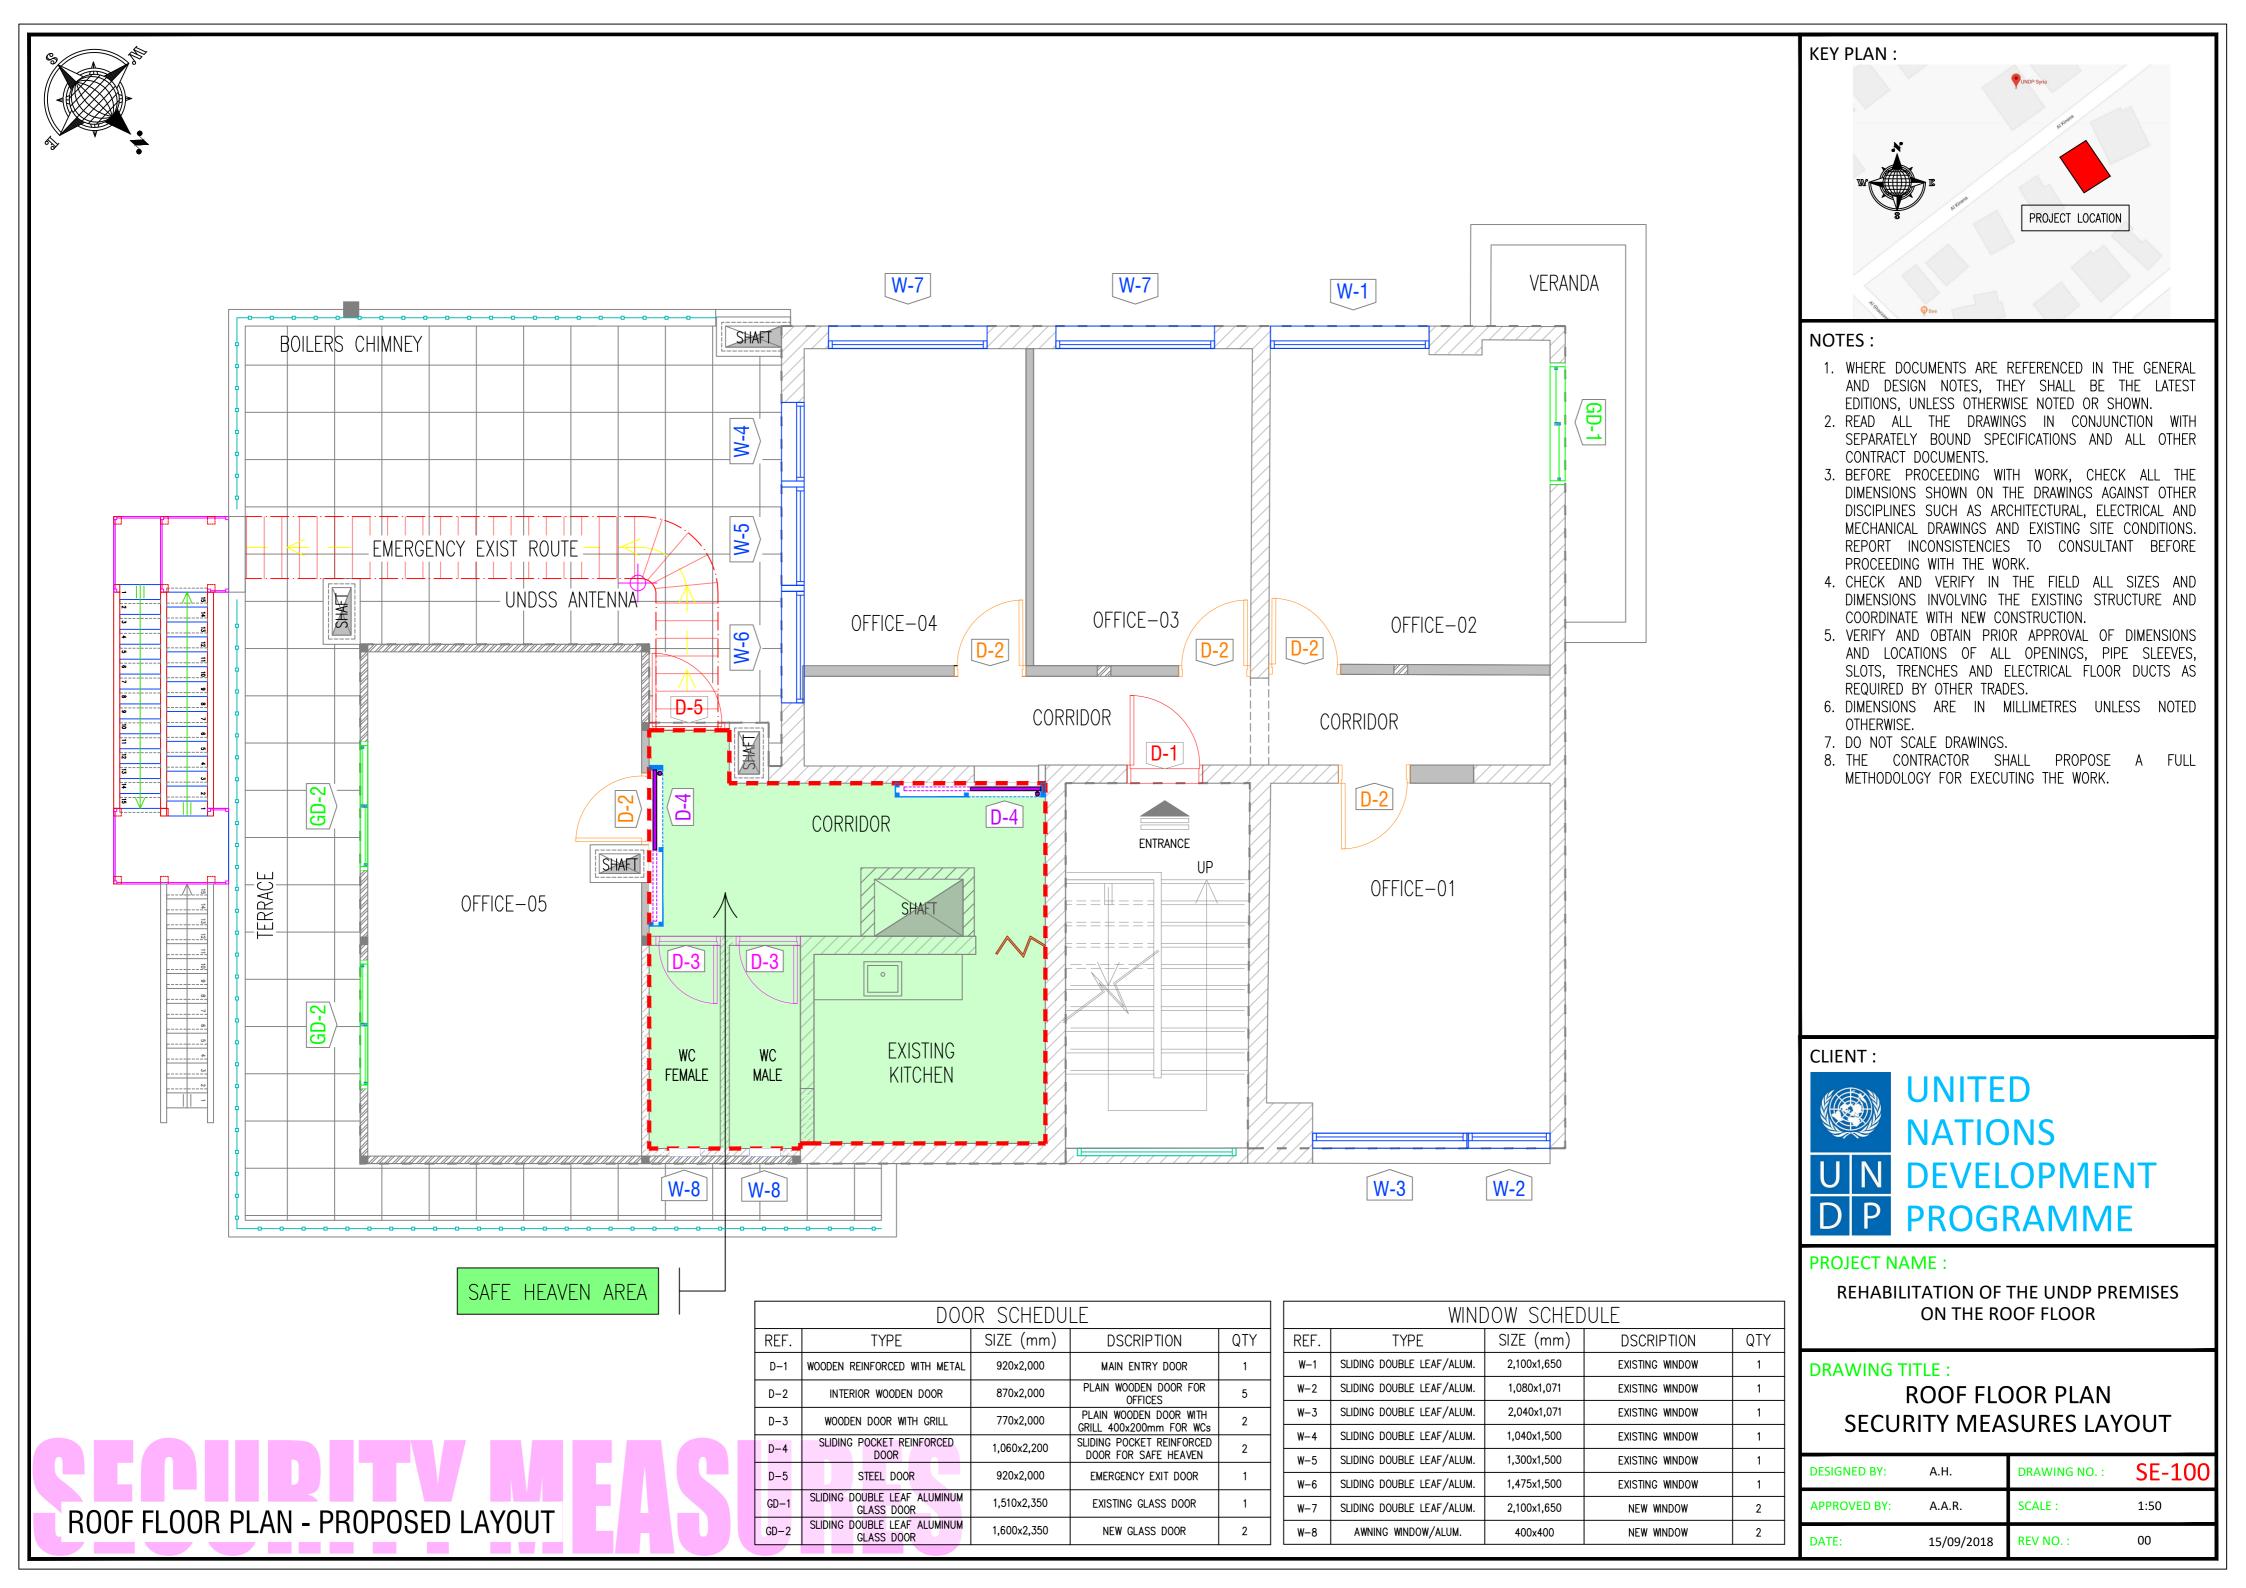


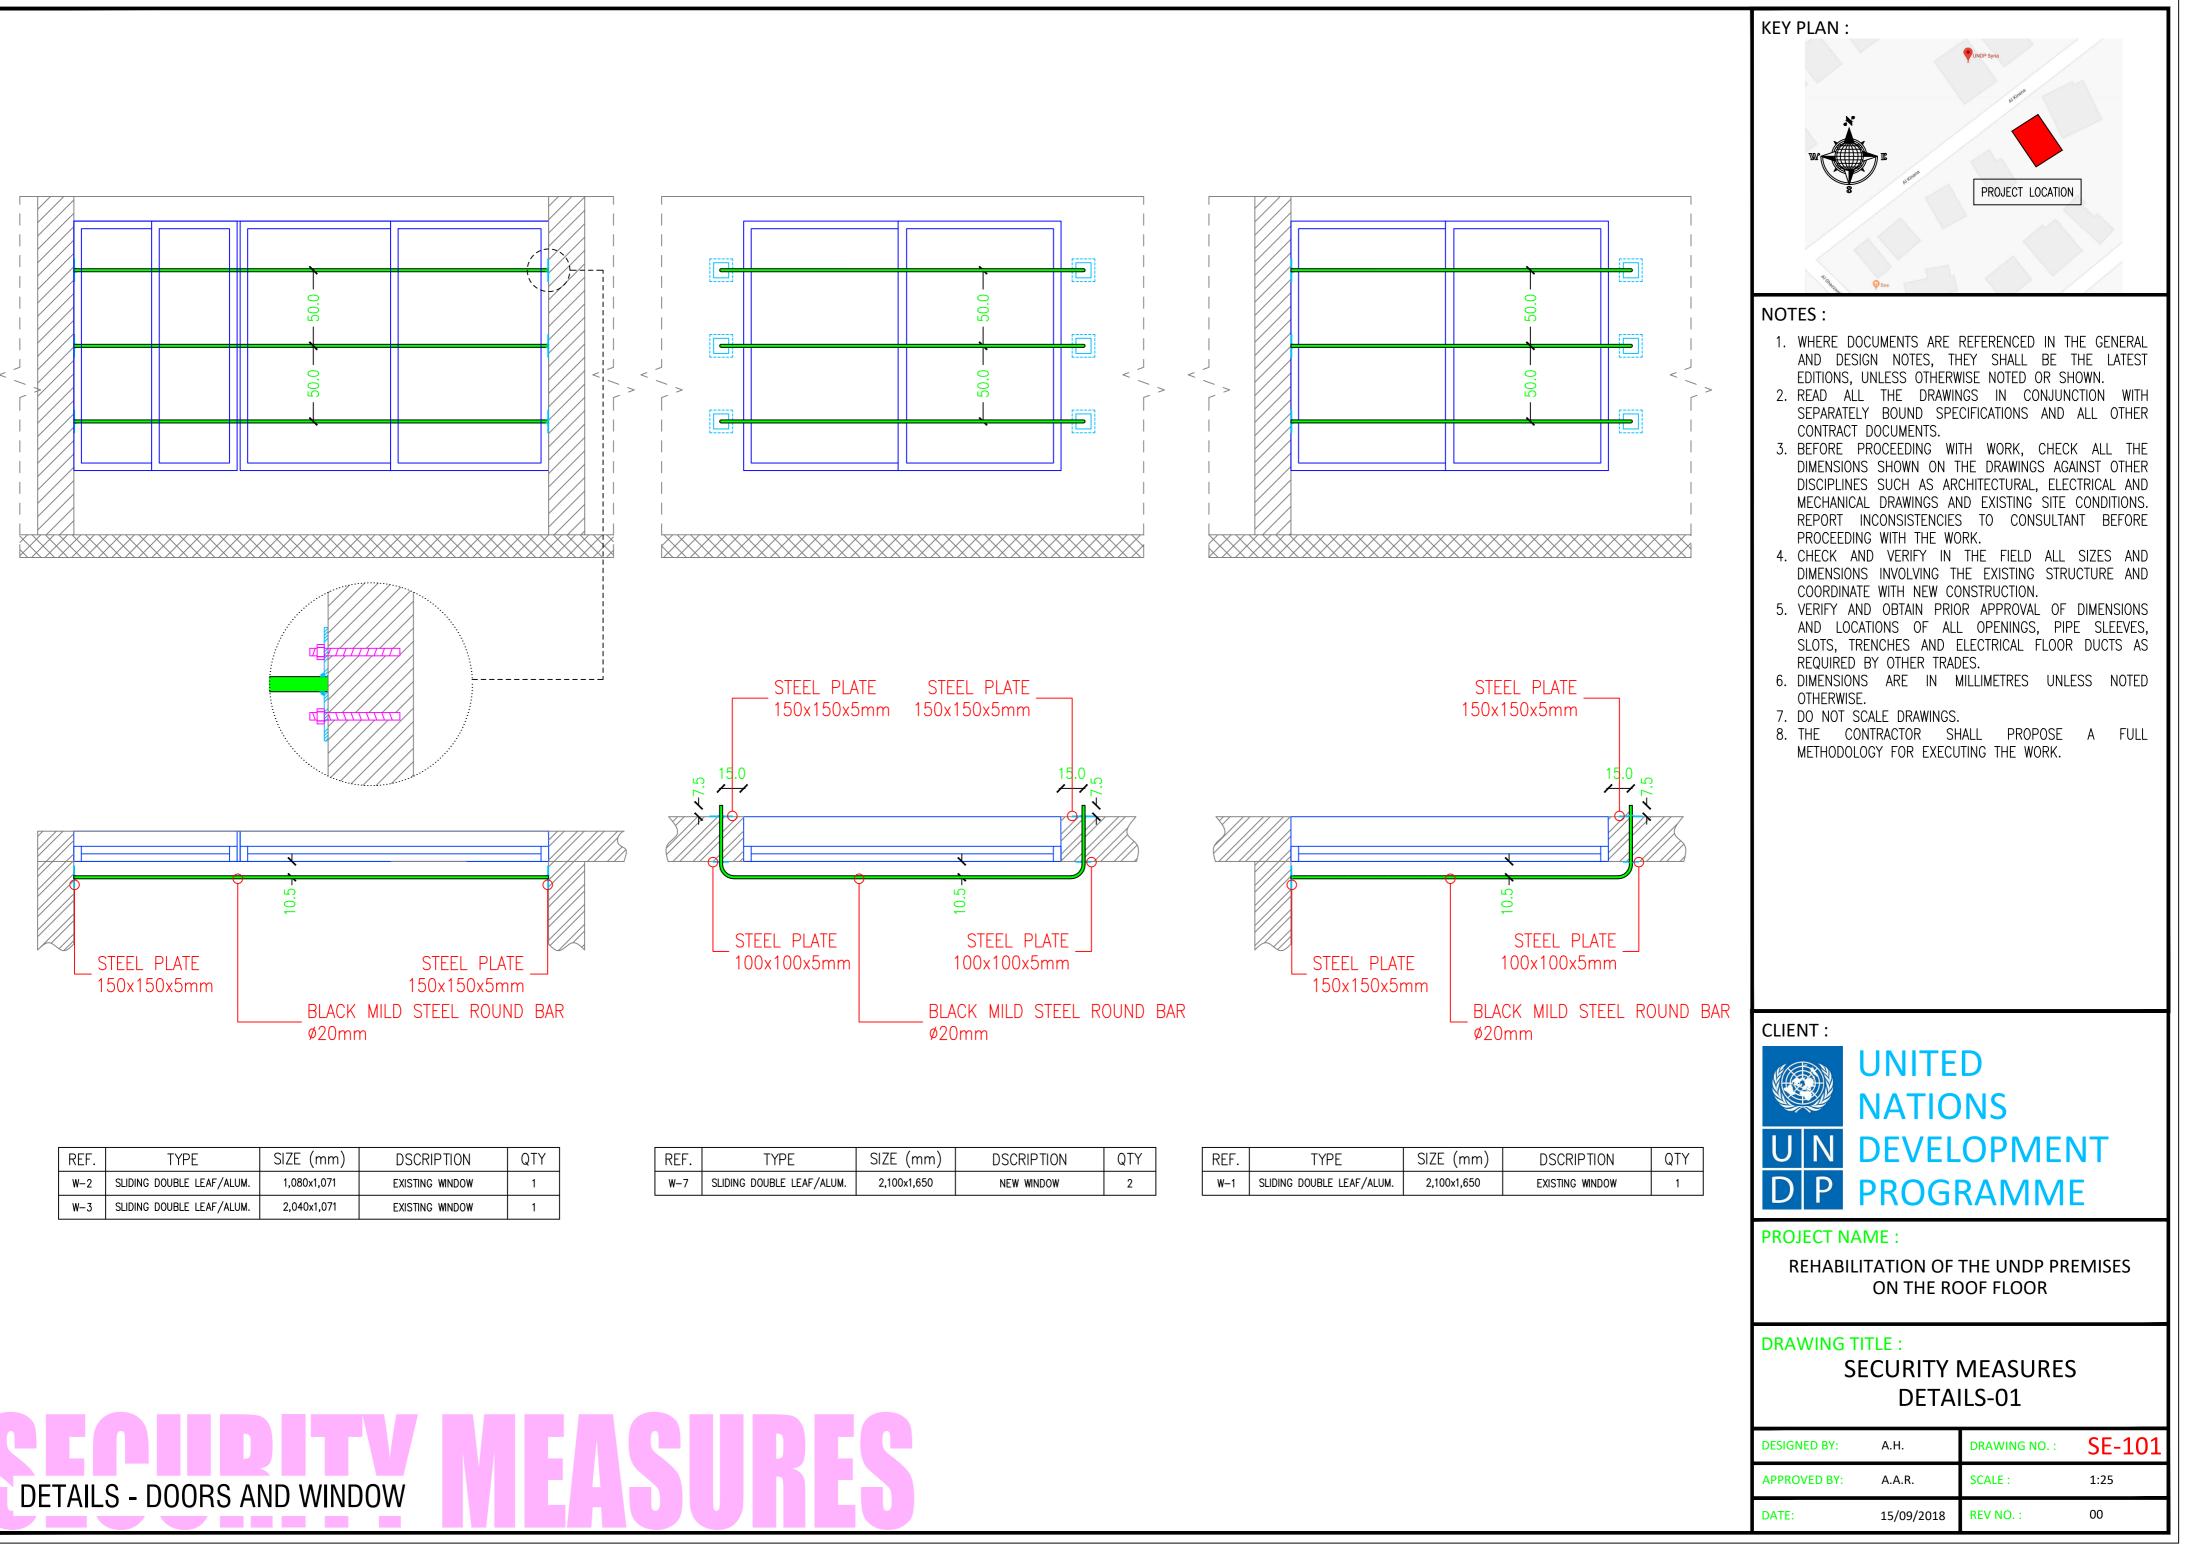



REF.	TYPE	SIZE (mm)	DSCRIPTION	QTY
₩-2	SLIDING DOUBLE LEAF/ALUM.	1,080x1,071	EXISTING WINDOW	1
₩-3	SLIDING DOUBLE LEAF/ALUM.	2,040x1,071	EXISTING WINDOW	1


REF.	TYPE	SIZE (mm)	DSCRIPTION	QTY
W-7	SLIDING DOUBLE LEAF/ALUM.	2,100x1,650	NEW WINDOW	2



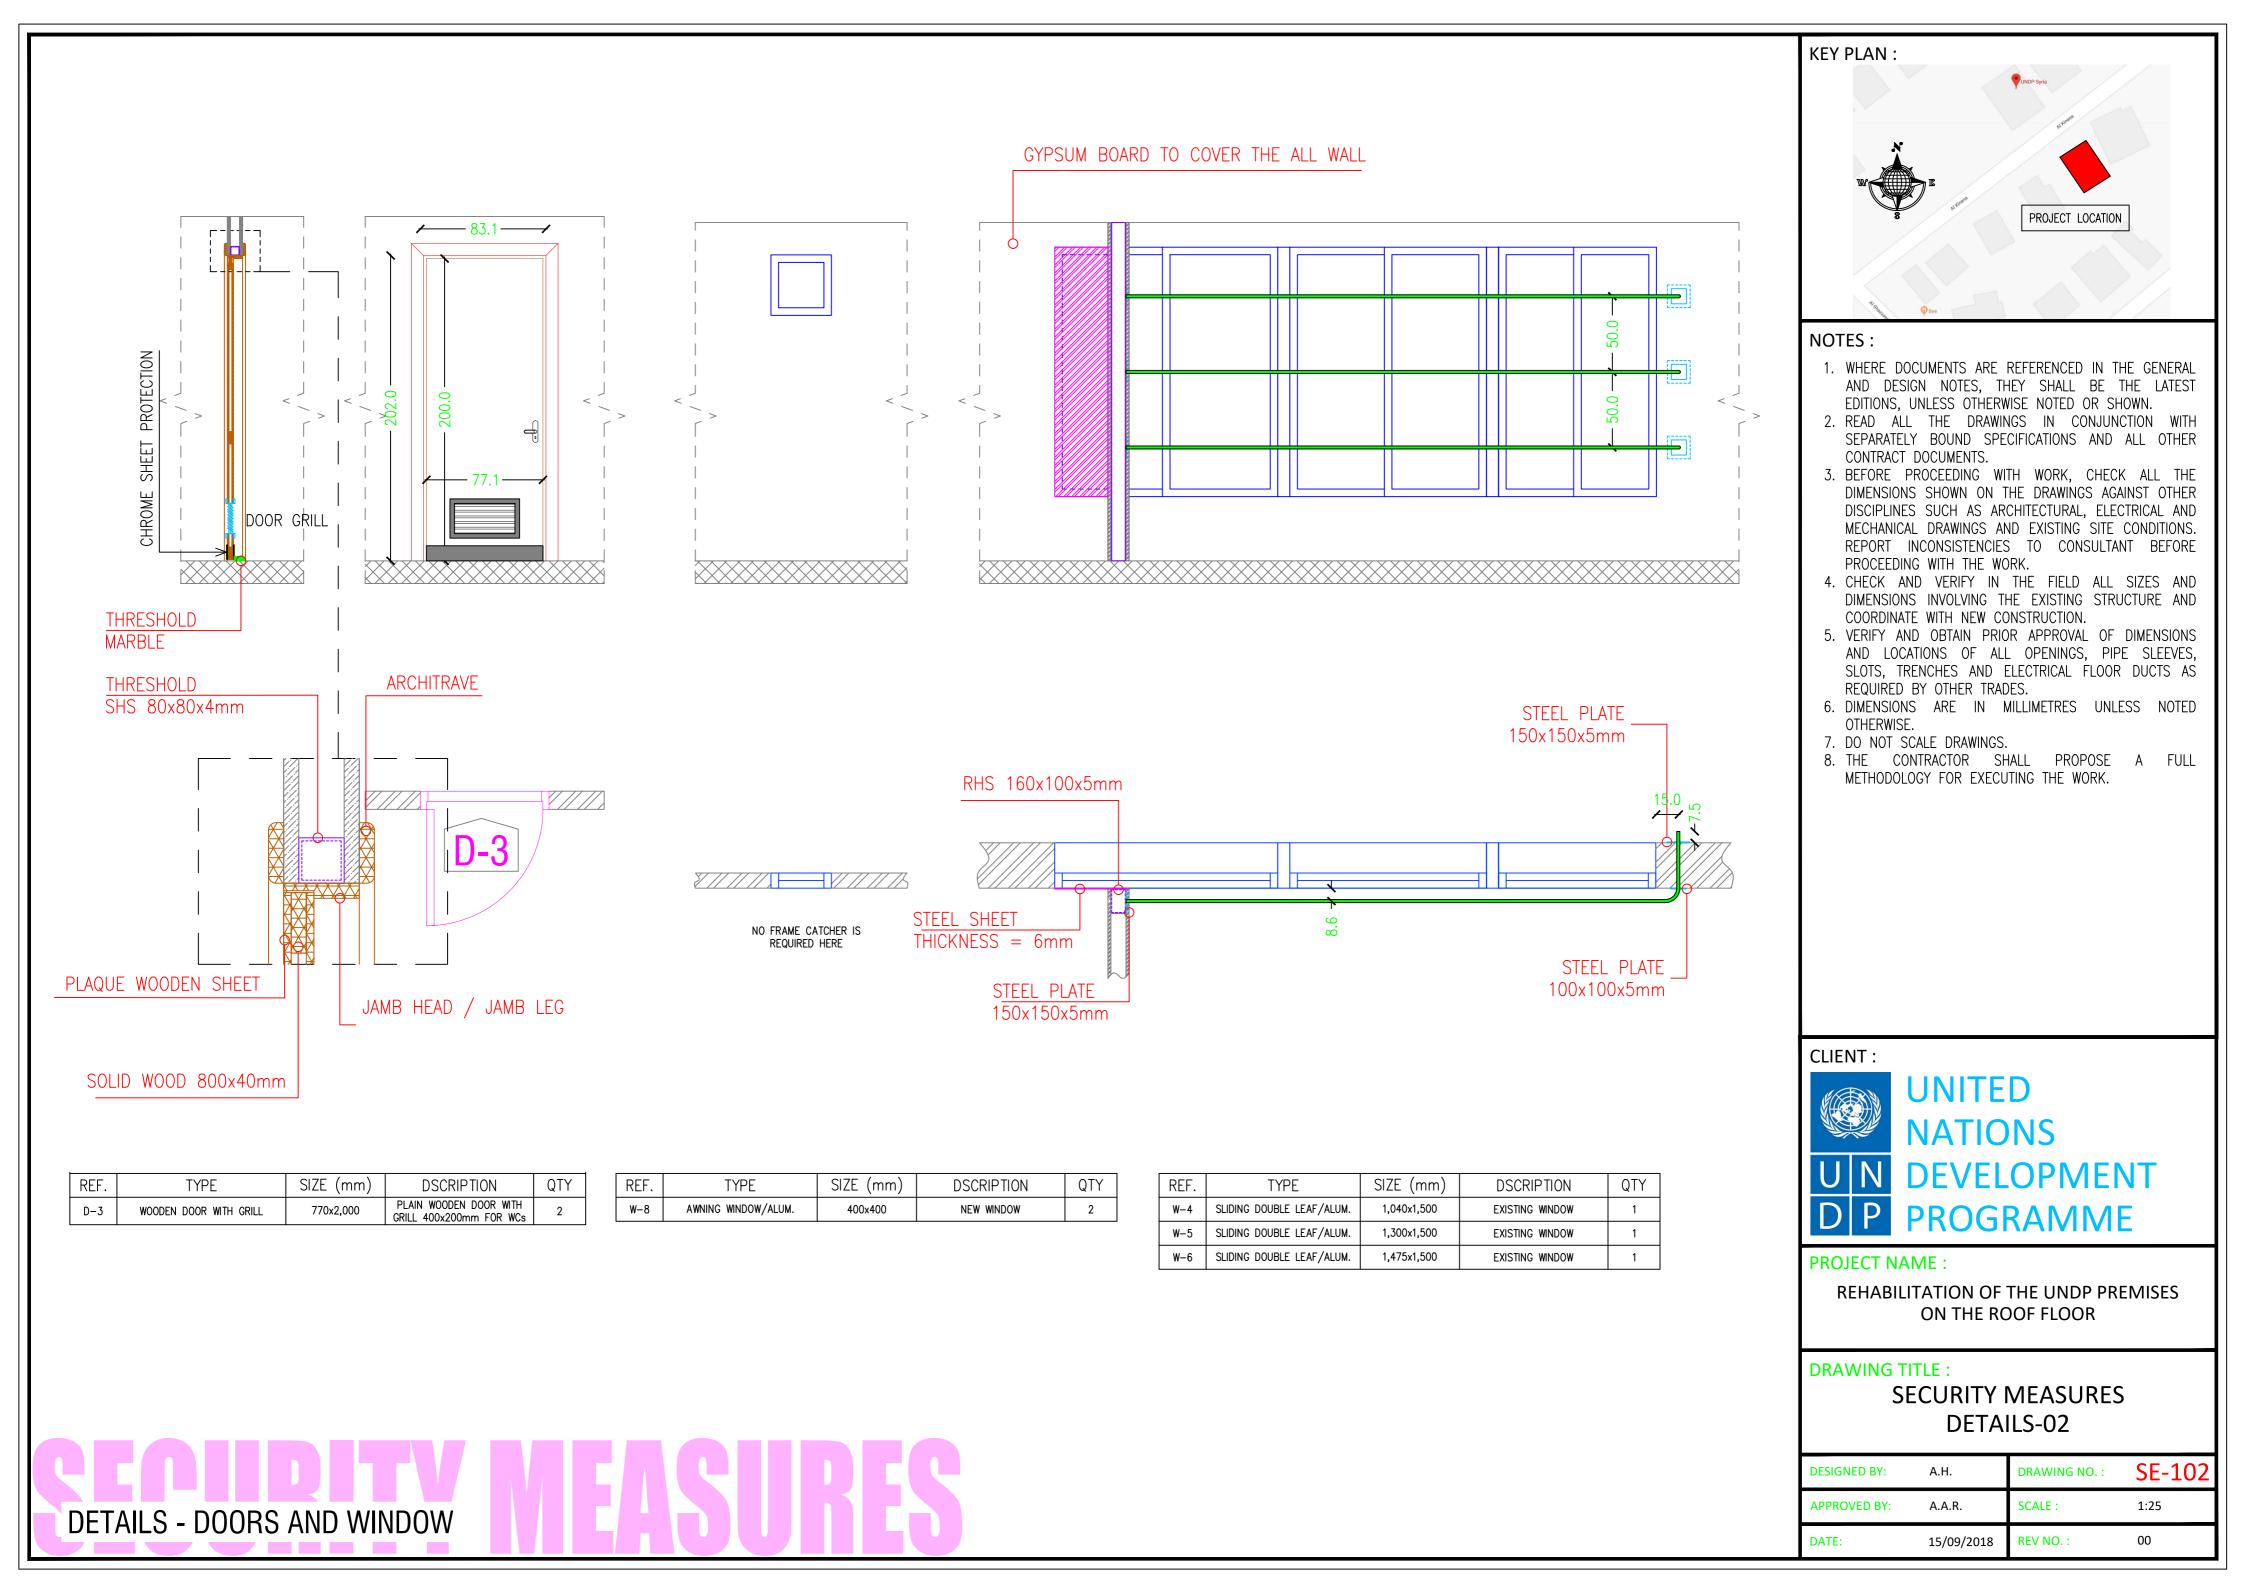

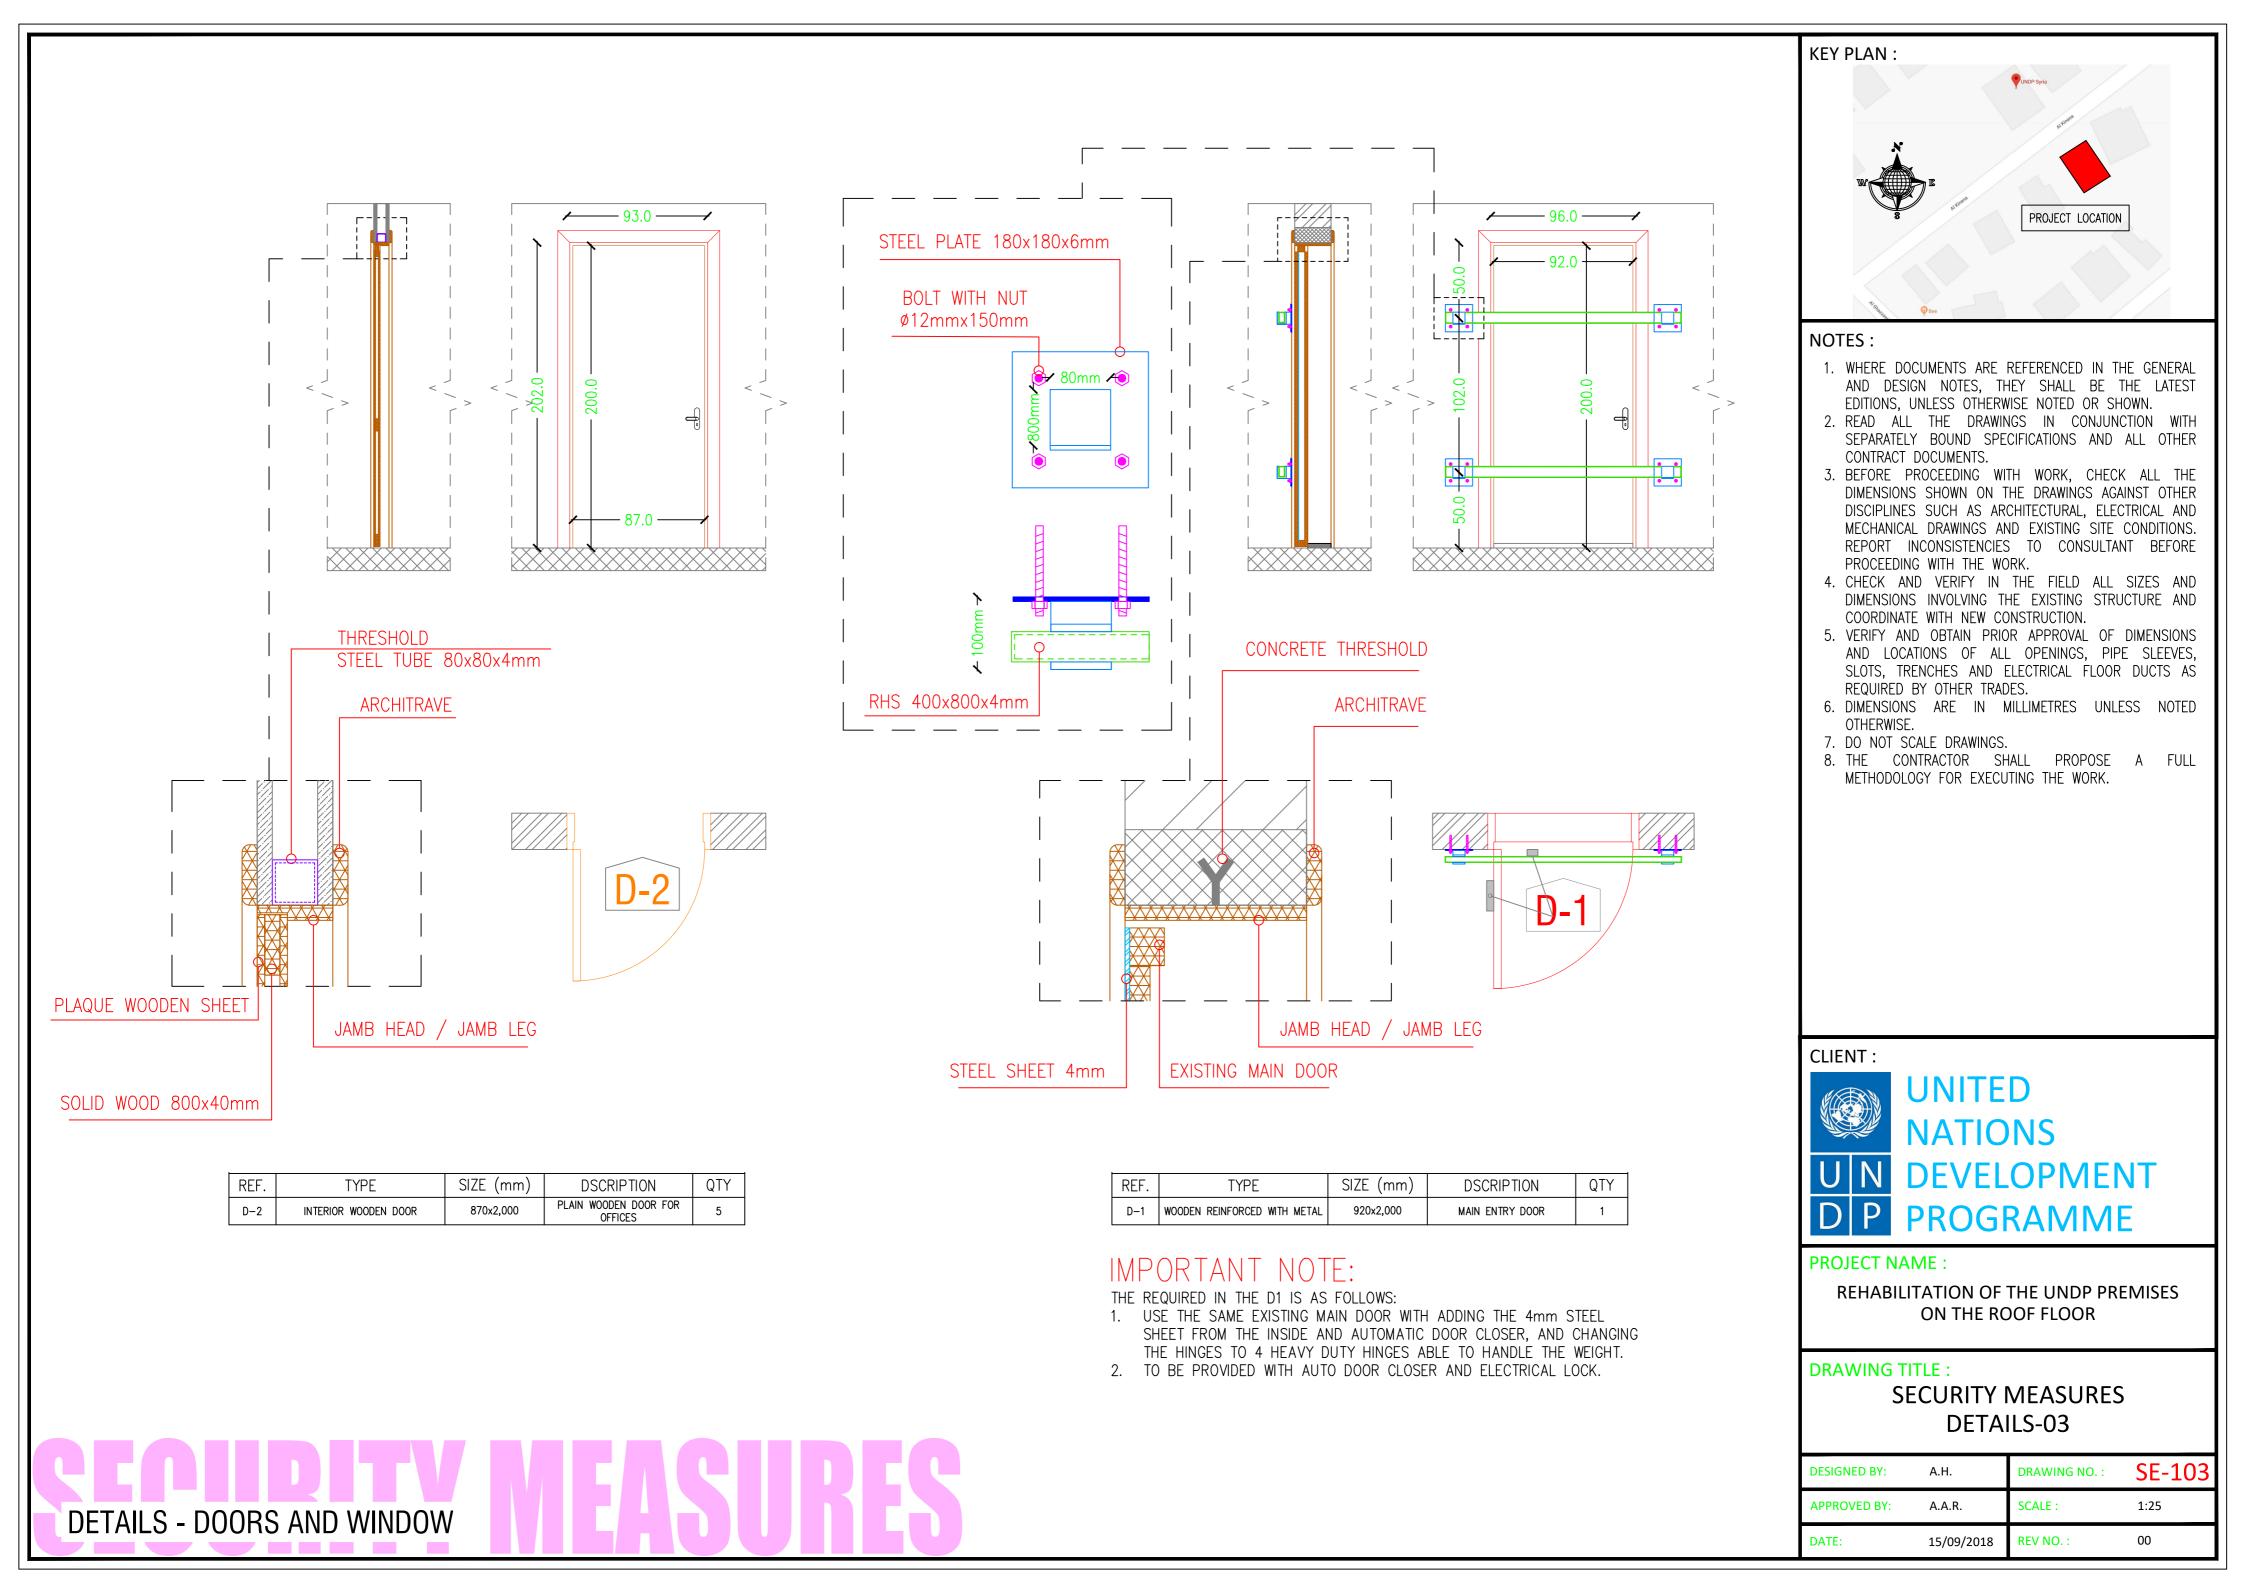


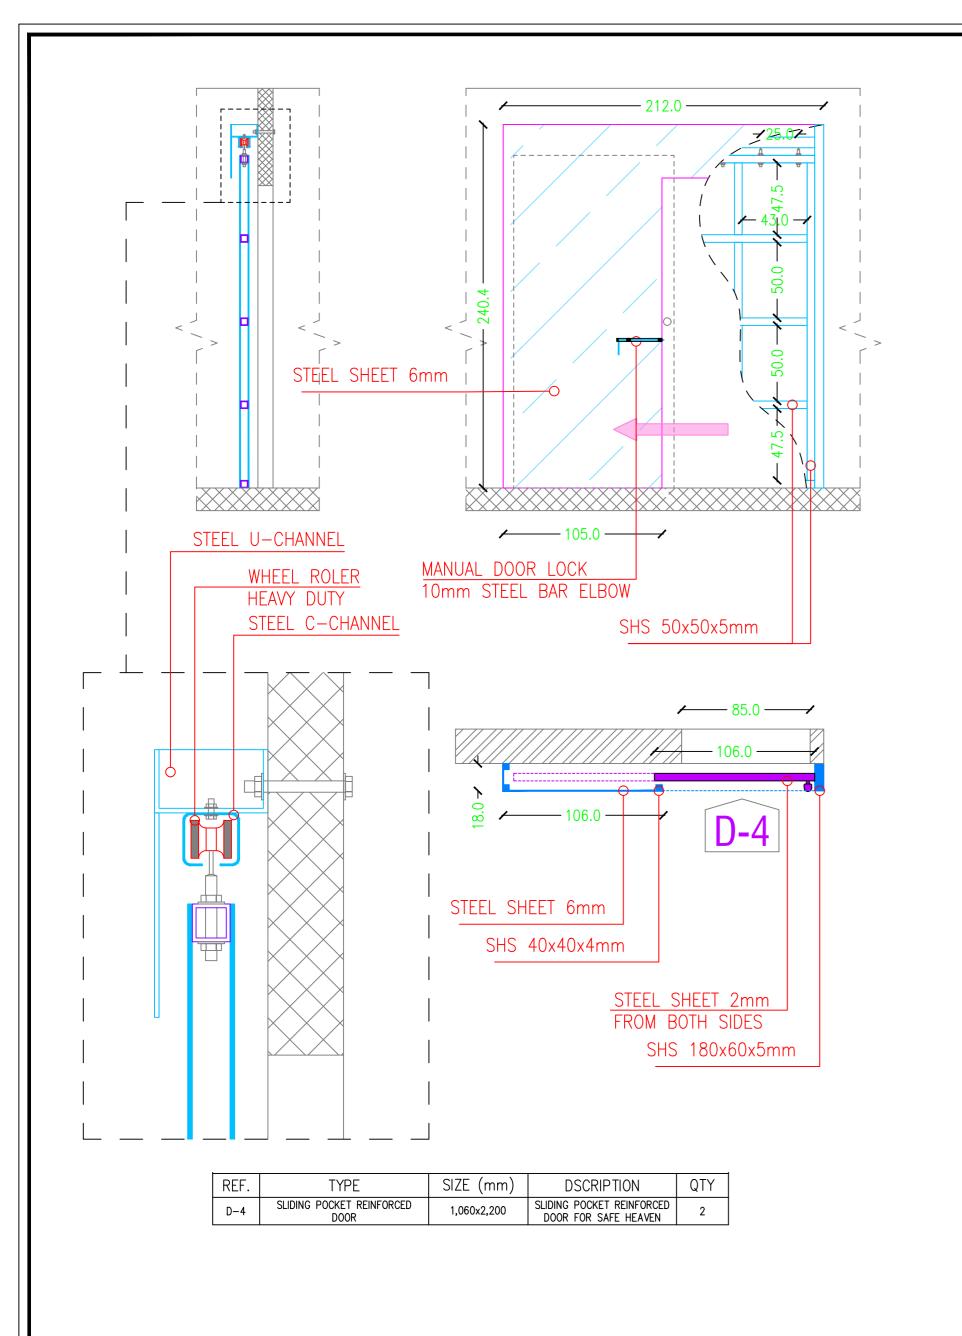

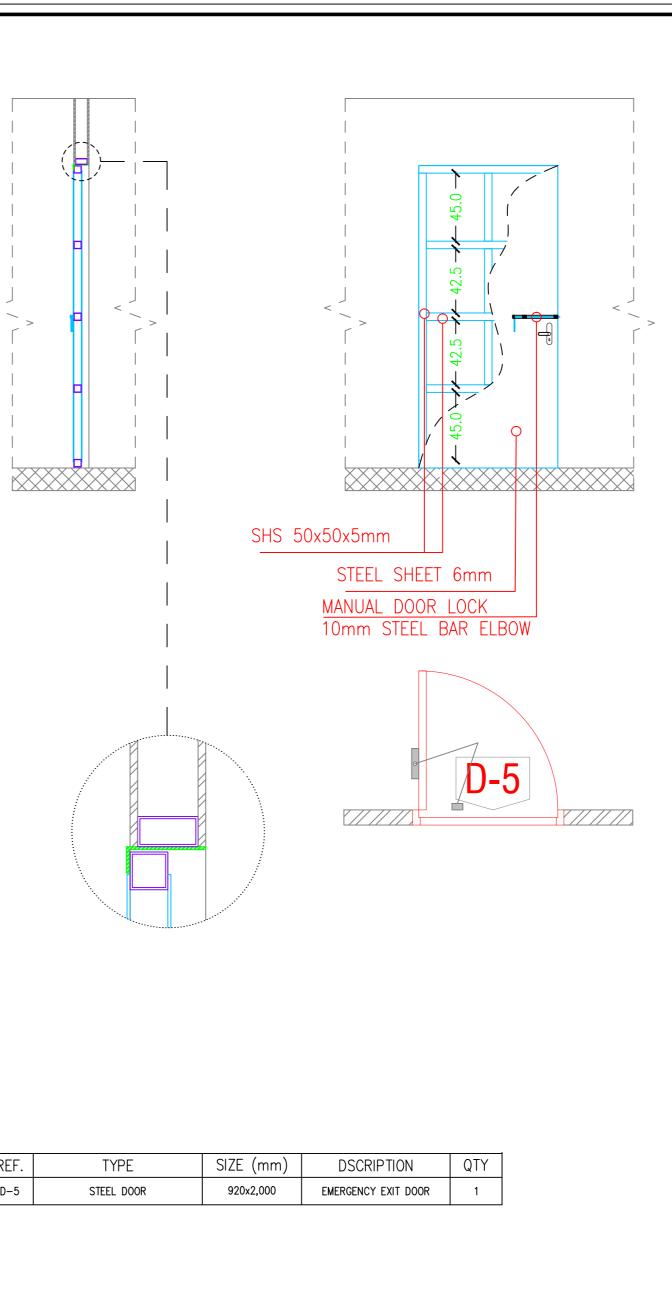

REF.	T
D-5	STEE



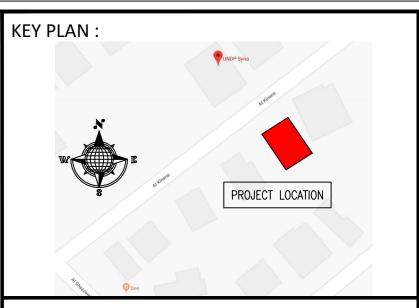

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### CLIENT :





### **PROJECT NAME :**

**REHABILITATION OF THE UNDP PREMISES** ON THE ROOF FLOOR

### **DRAWING TITLE :** SECURITY MEASURES DETAILS-04

DESIGNED BY:	A.H.	DRAWING NO. :	SE-104
APPROVED BY:	A.A.R.	SCALE :	1:25
DATE:	15/09/2018	REV NO. :	00

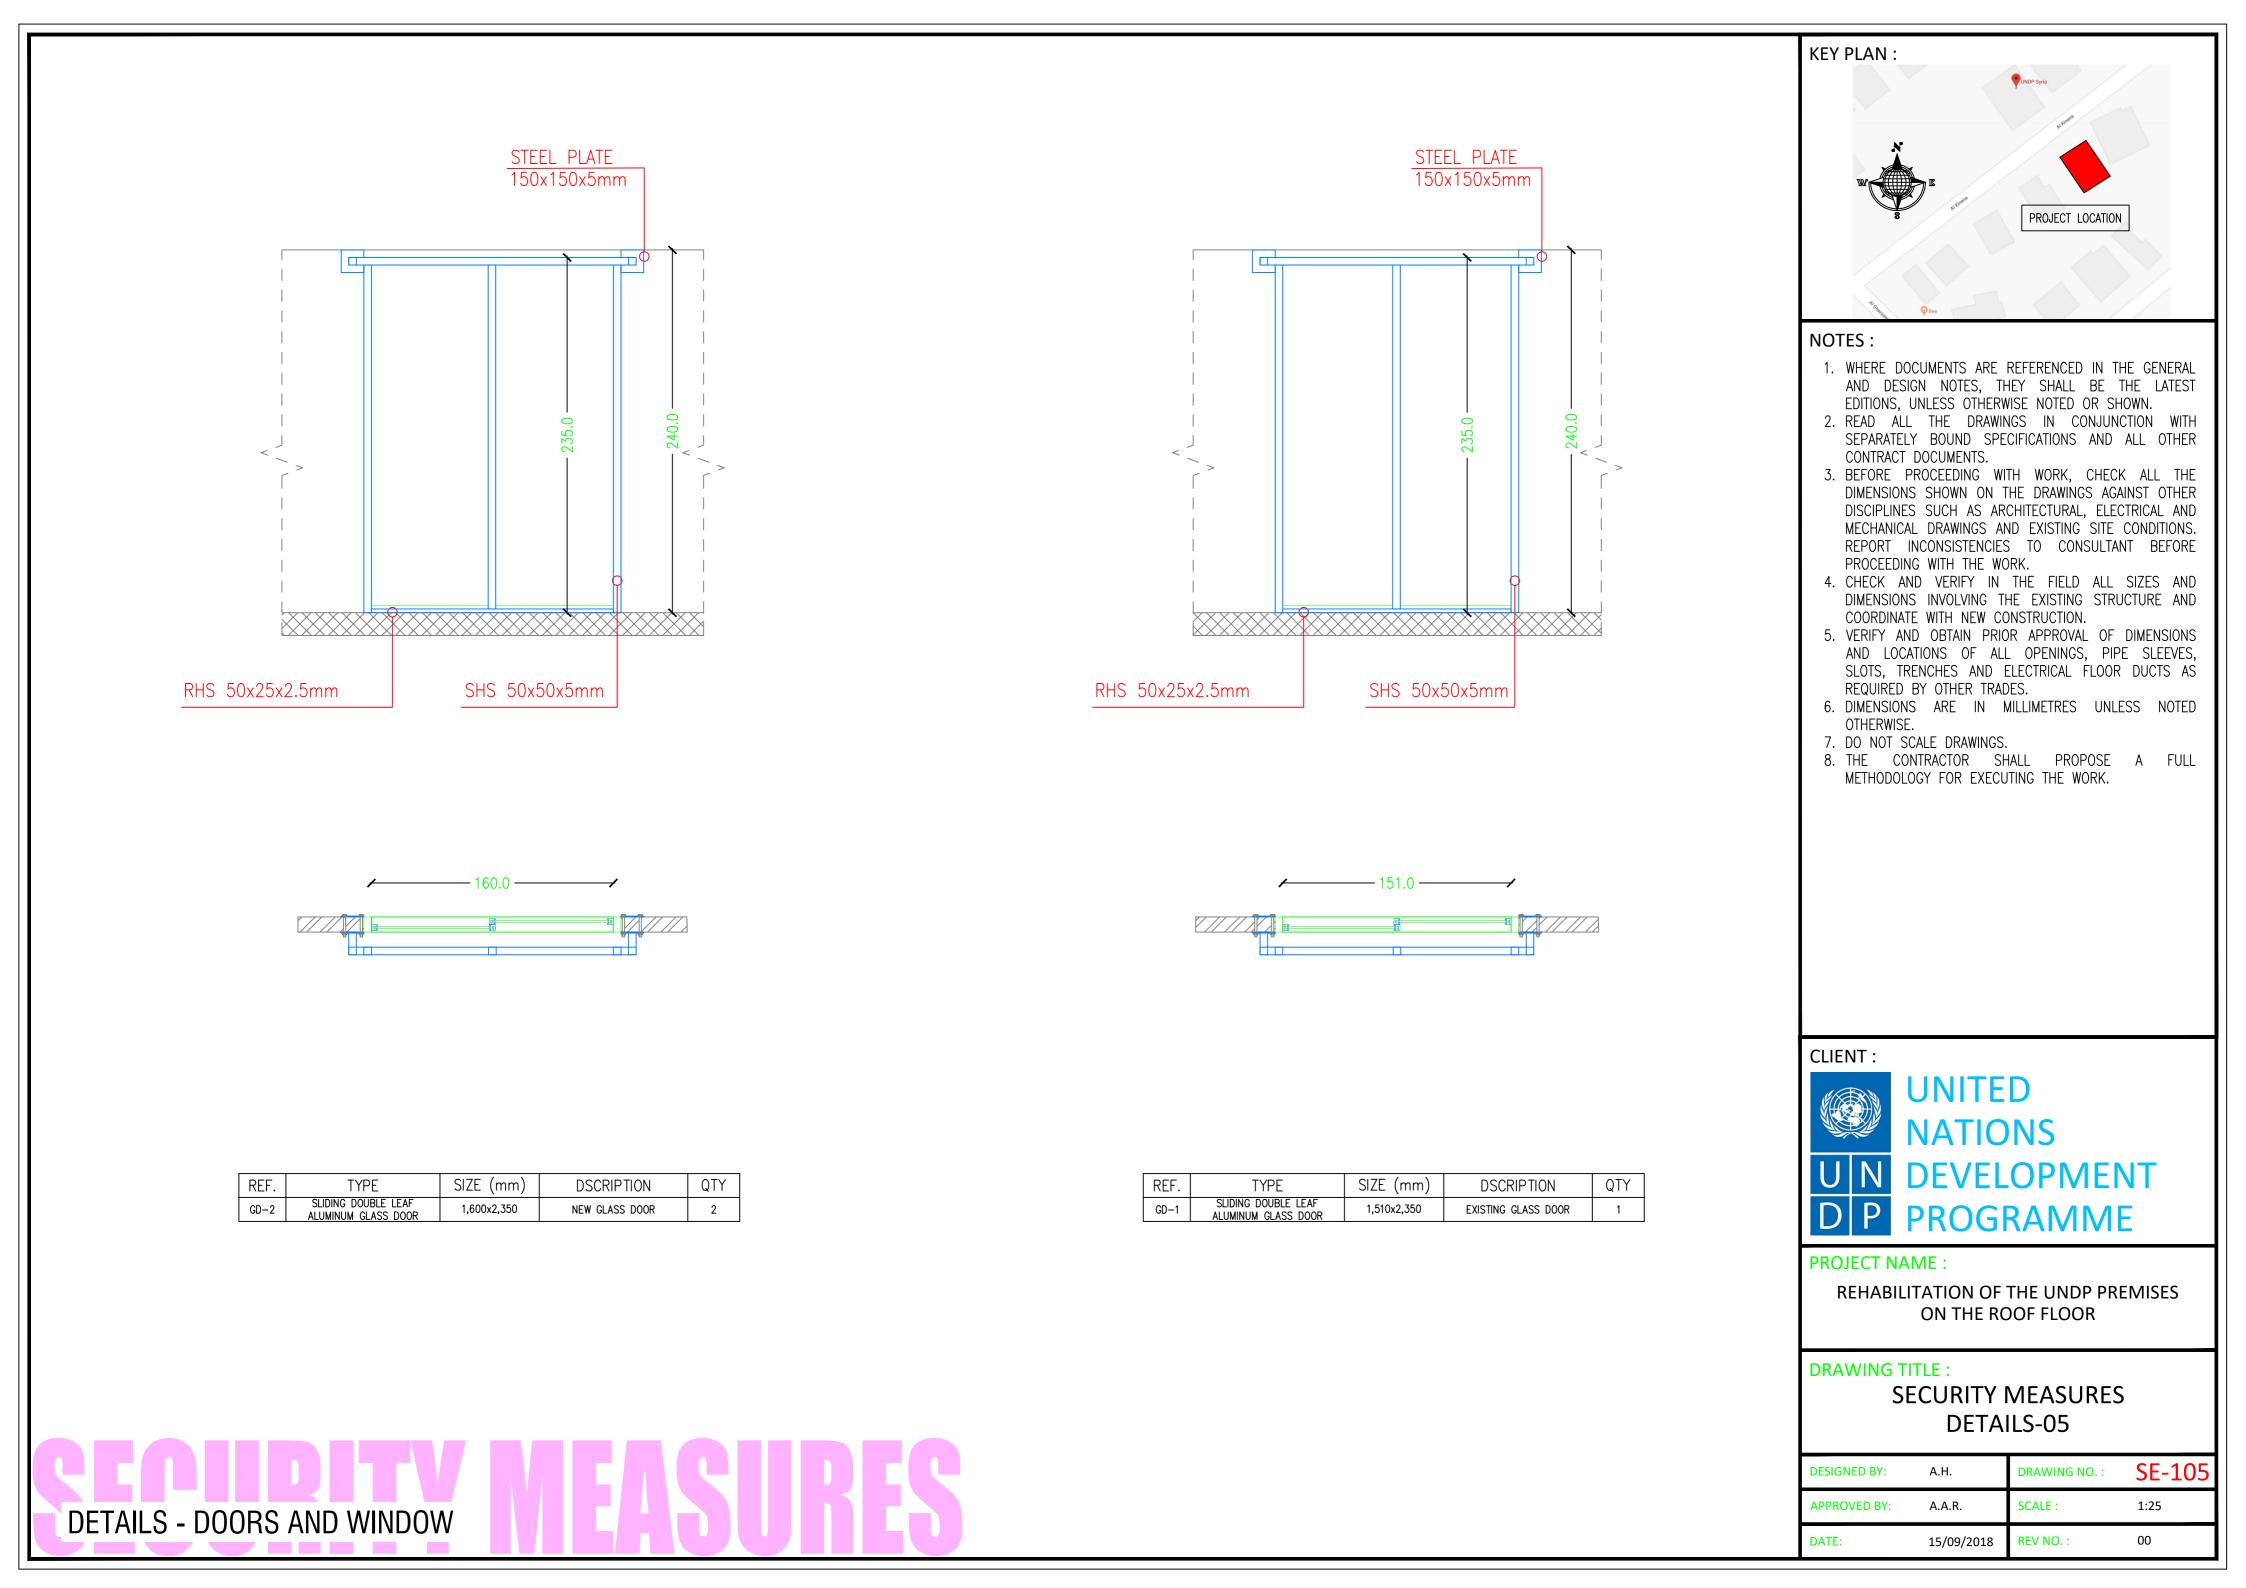

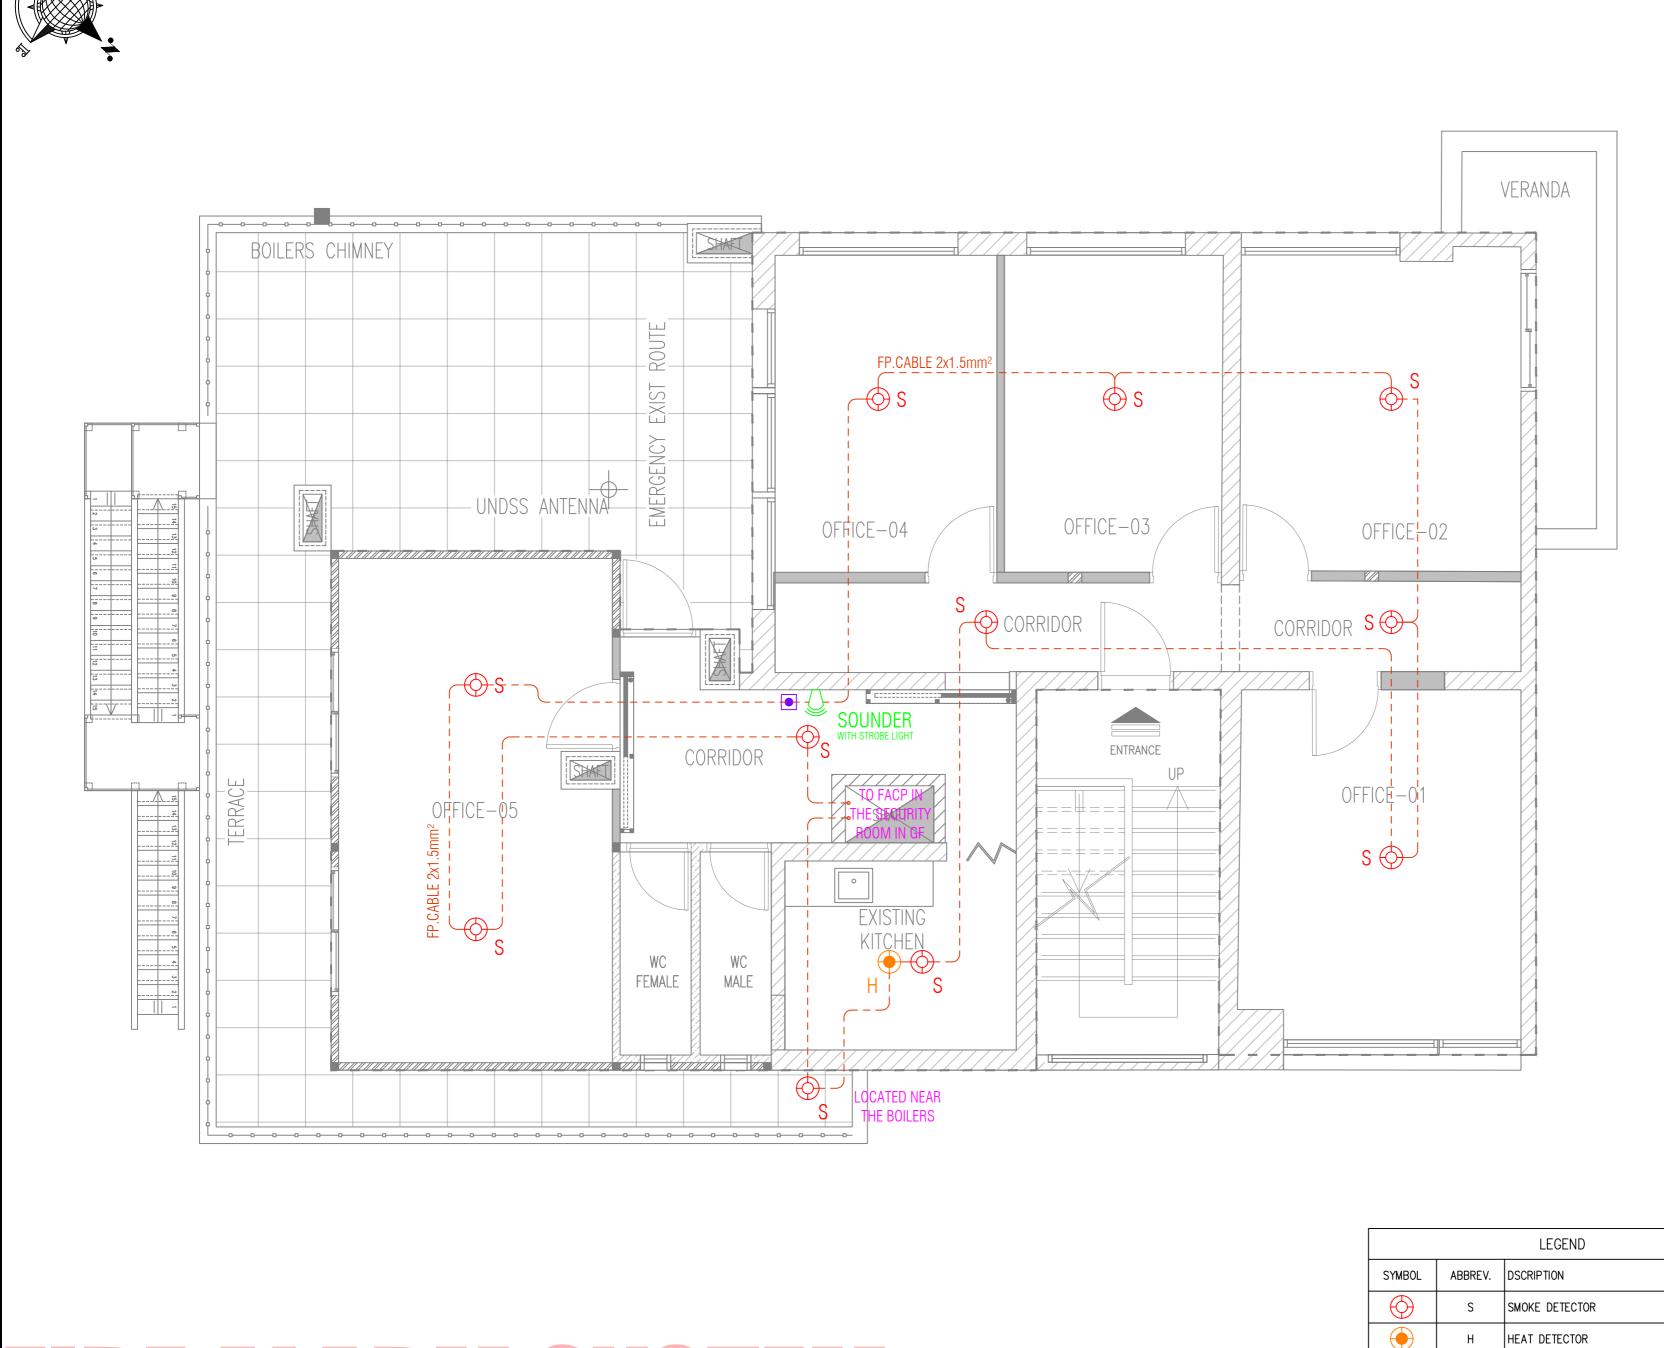



KEY PLAN :	VINDP Syria				
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8 Discont	PROJECT LOCATION				
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CONTRACT DOCUMENTS.	CIFICATIONS AND ALL OTHER				
	TH WORK, CHECK ALL THE THE DRAWINGS AGAINST OTHER				
	CHITECTURAL, ELECTRICAL AND ND EXISTING SITE CONDITIONS.				
	5 TO CONSULTANT BEFORE				
4. CHECK AND VERIFY IN	THE FIELD ALL SIZES AND HE EXISTING STRUCTURE AND				
COORDINATE WITH NEW CO 5. VERIFY AND OBTAIN PRIC	NSTRUCTION. DR APPROVAL OF DIMENSIONS				
AND LOCATIONS OF ALL	OPENINGS, PIPE SLEEVES, ELECTRICAL FLOOR DUCTS AS				
REQUIRED BY OTHER TRAD 6. DIMENSIONS ARE IN	DES.				
OTHERWISE. 7. DO NOT SCALE DRAWINGS.					
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PROJECT NAME :					
	REHABILITATION OF THE UNDP PREMISES				
ON THE ROOF FLOOR					
DRAWING TITLE :					
	OOR PLAN				
FIRE ALARM SY	STEM LAYOUT				
DESIGNED BY: A.H.	DRAWING NO. : FA-100				
APPROVED BY: A.A.R.	SCALE : 1:50				
DATE: 15/09/2018	REV NO. : 00				

QTY

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N/A

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N/A


SOUNDER


FP

PUSH BUTTON ALARM


FIRE PROOF CABLE


SOUNDER WITH STROBE LIGHT - WALL MOUNTED

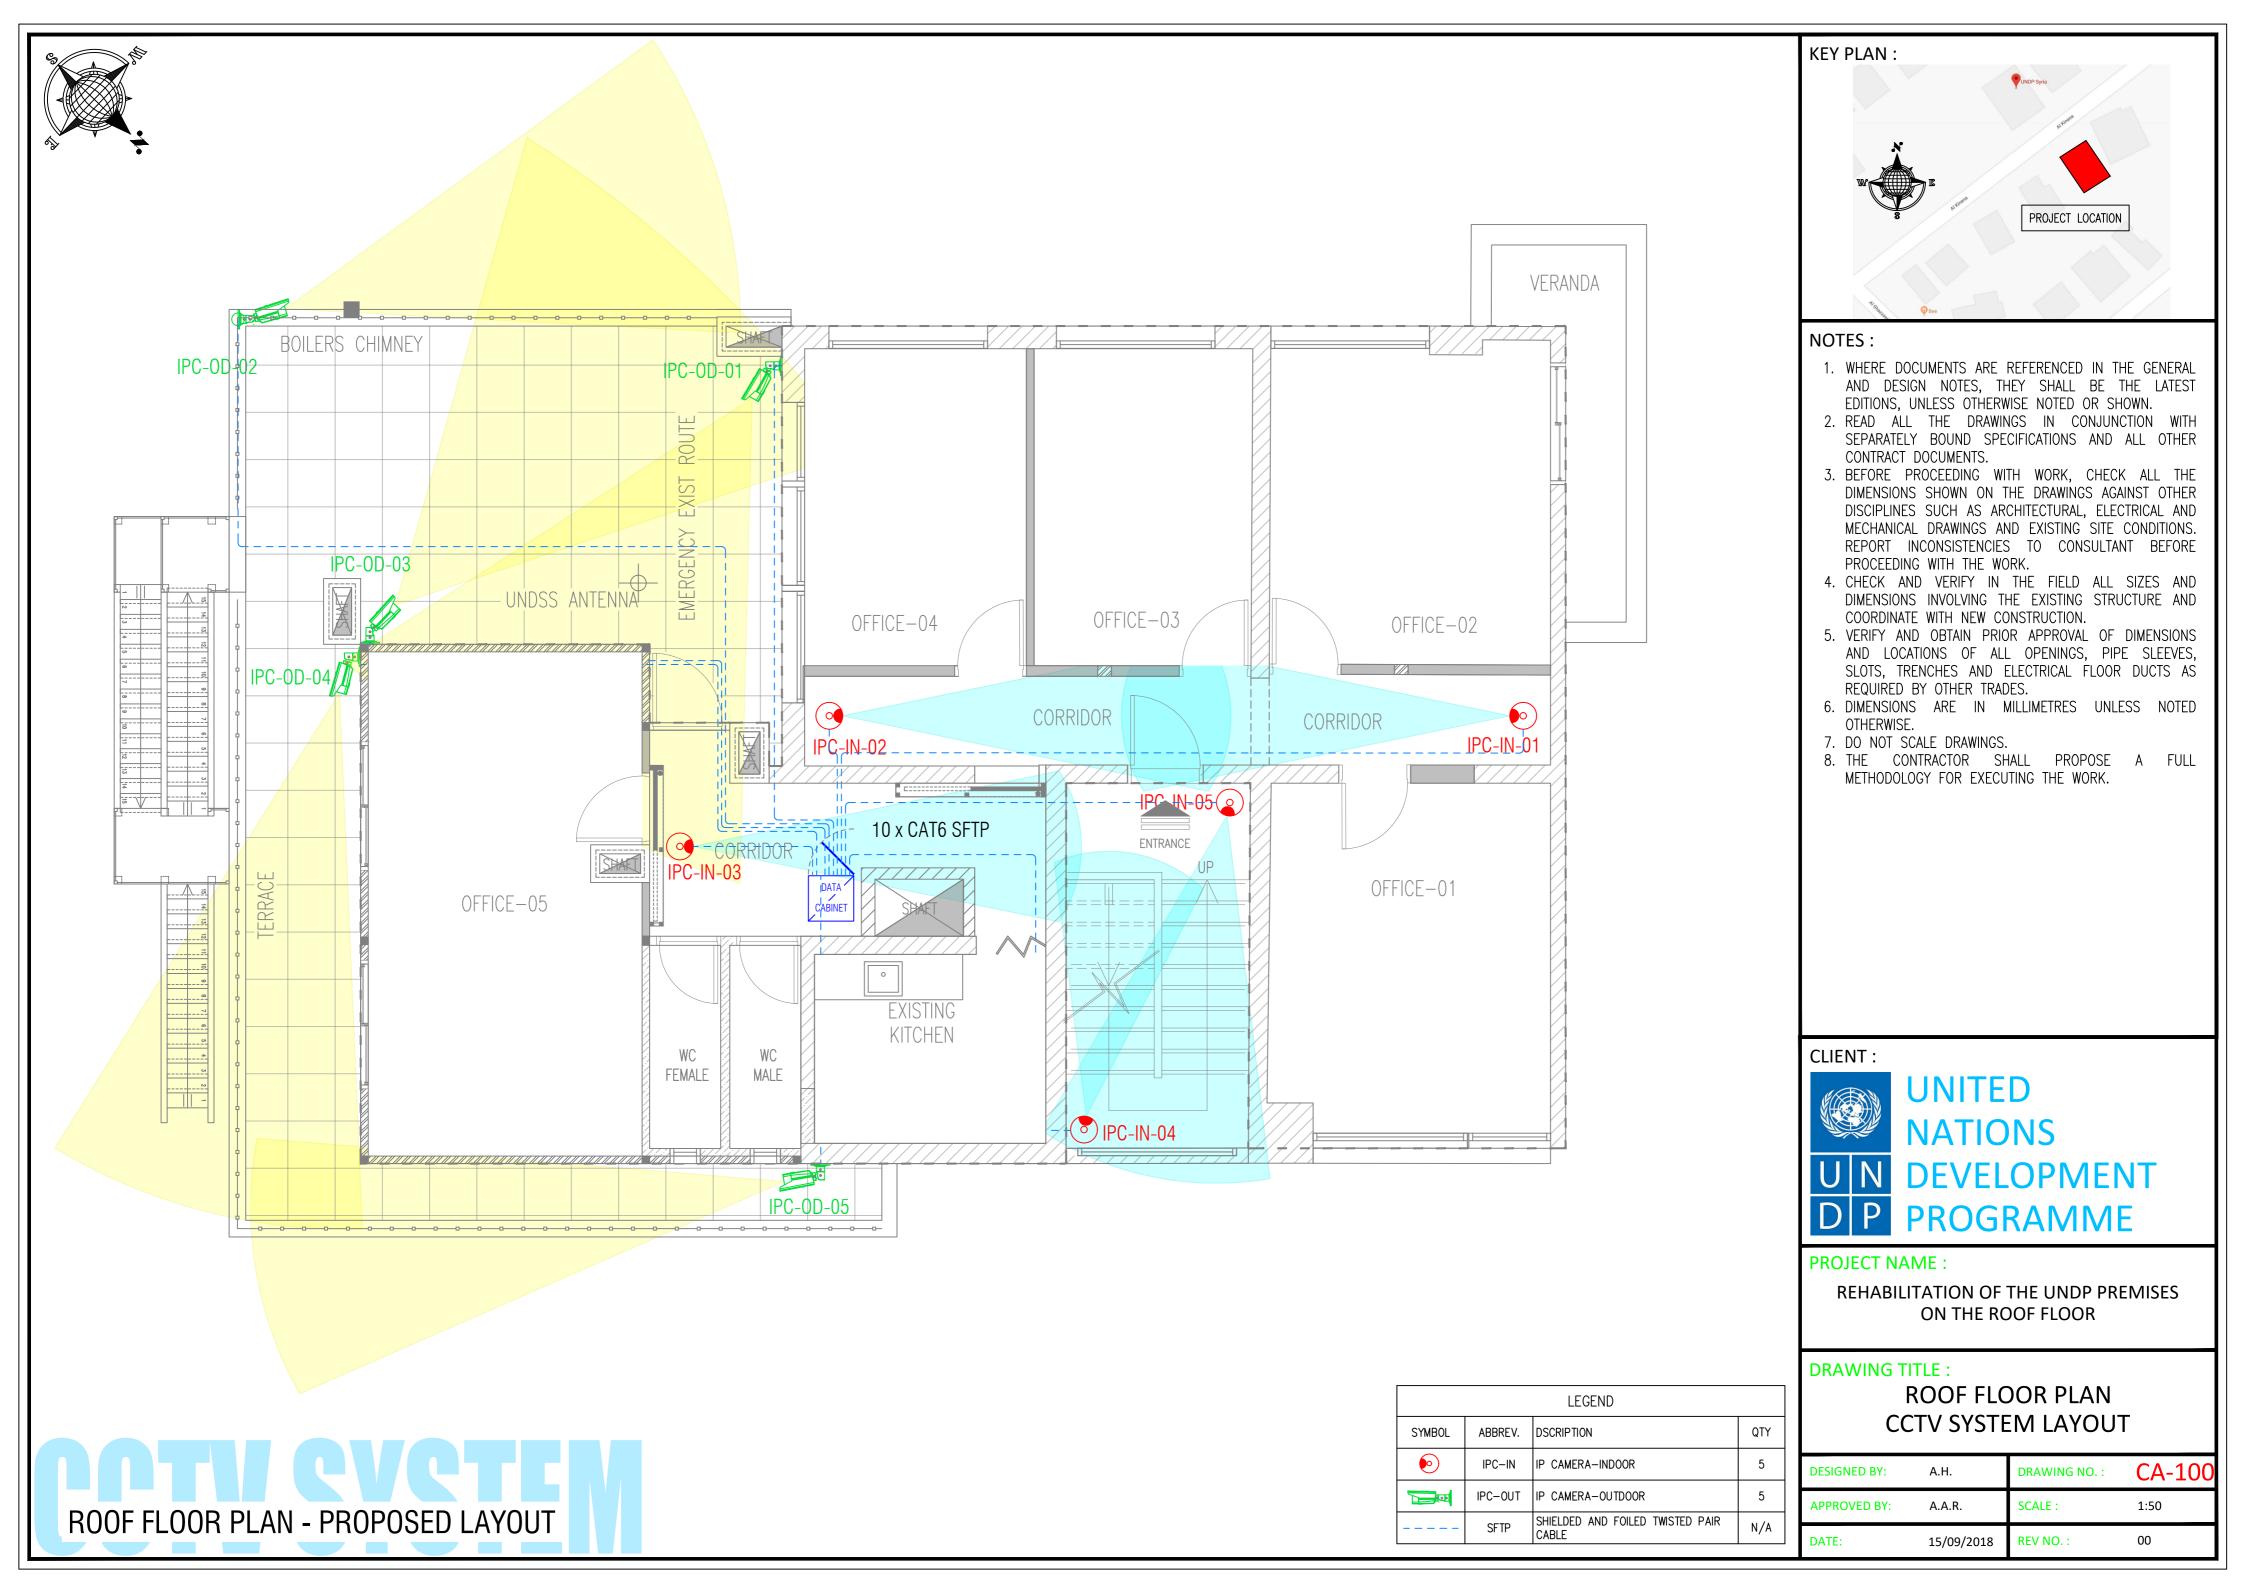

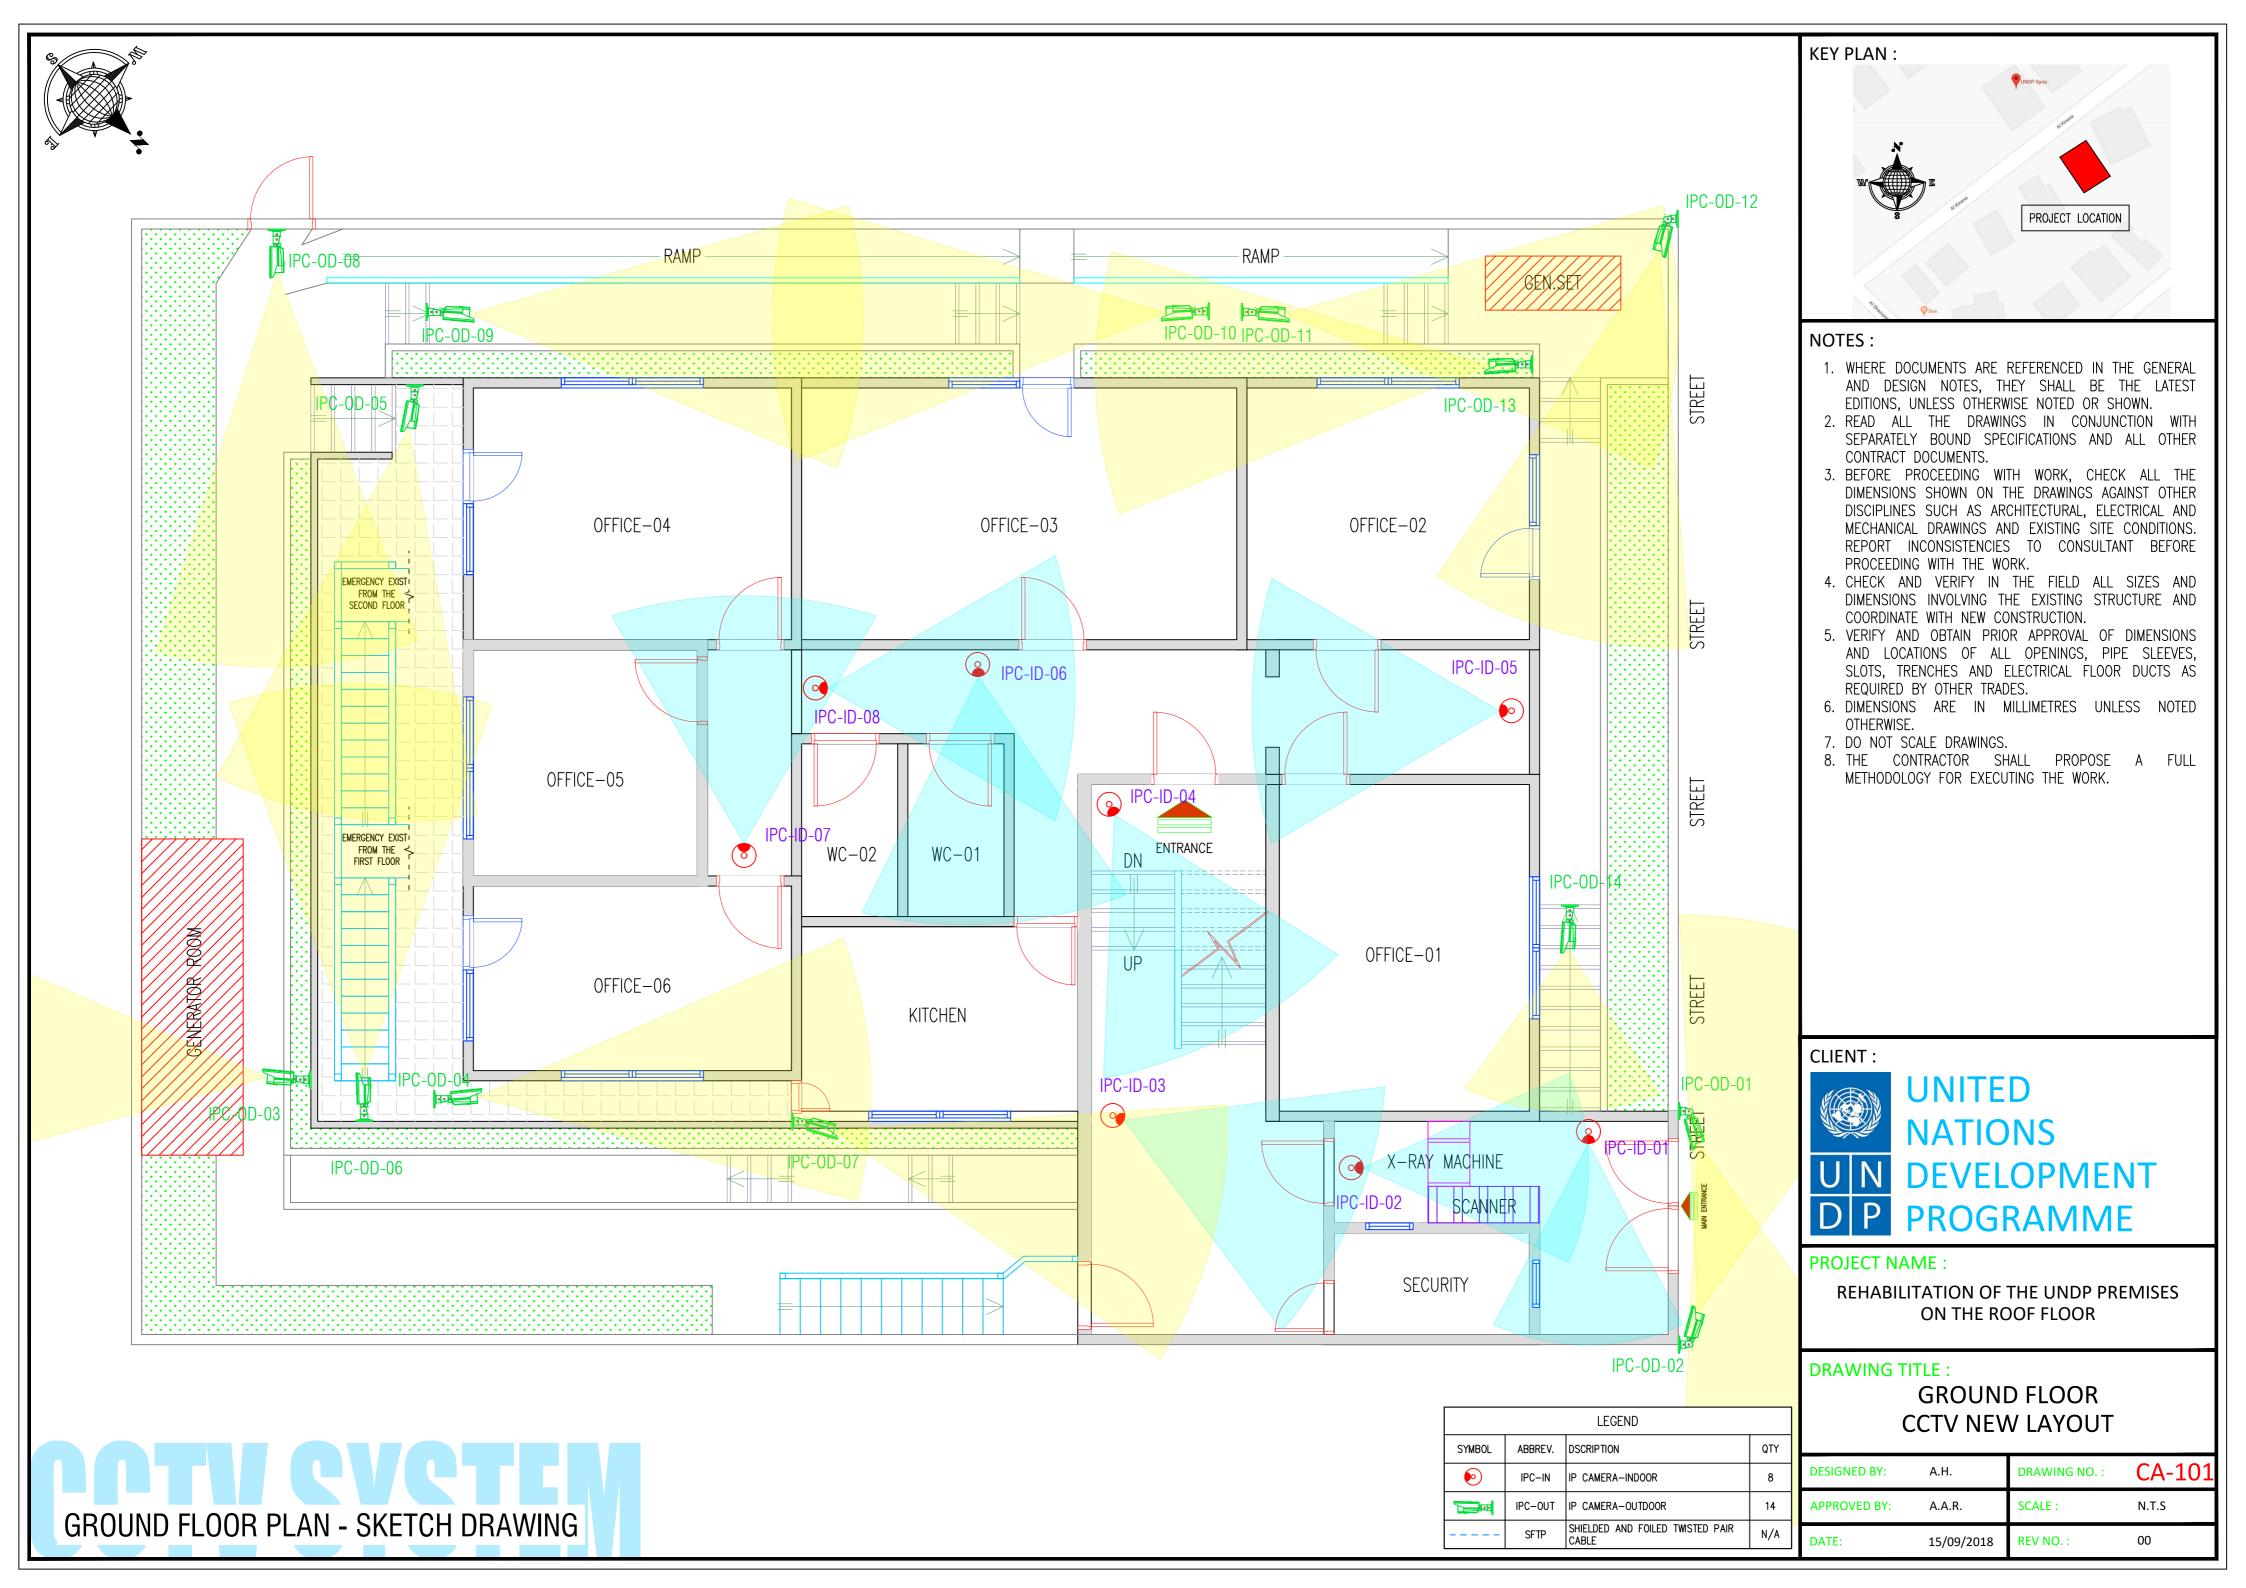


## BASEMENT PLAN - SKETCH DRAWING

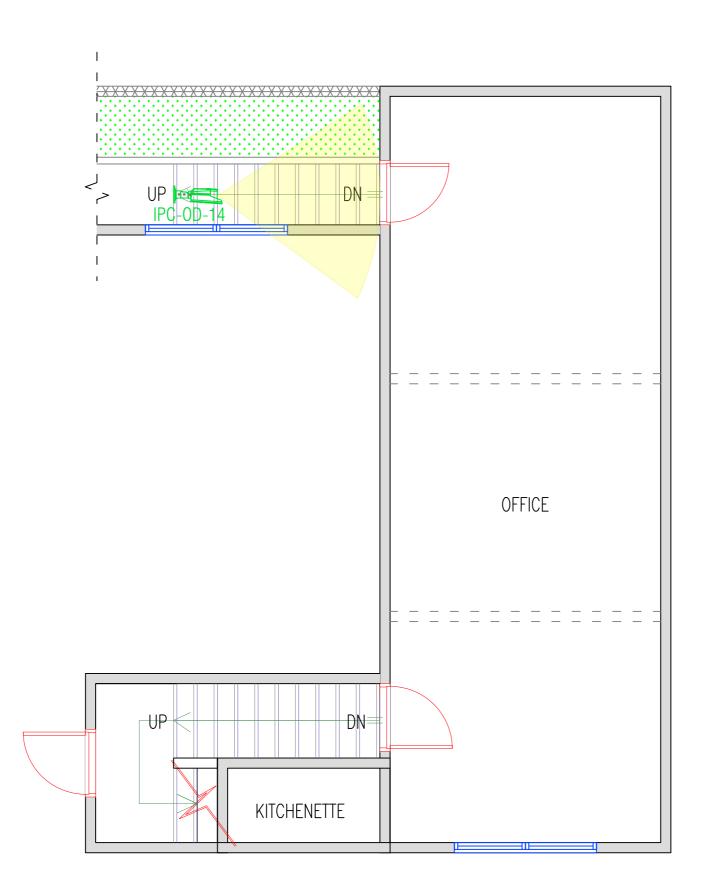

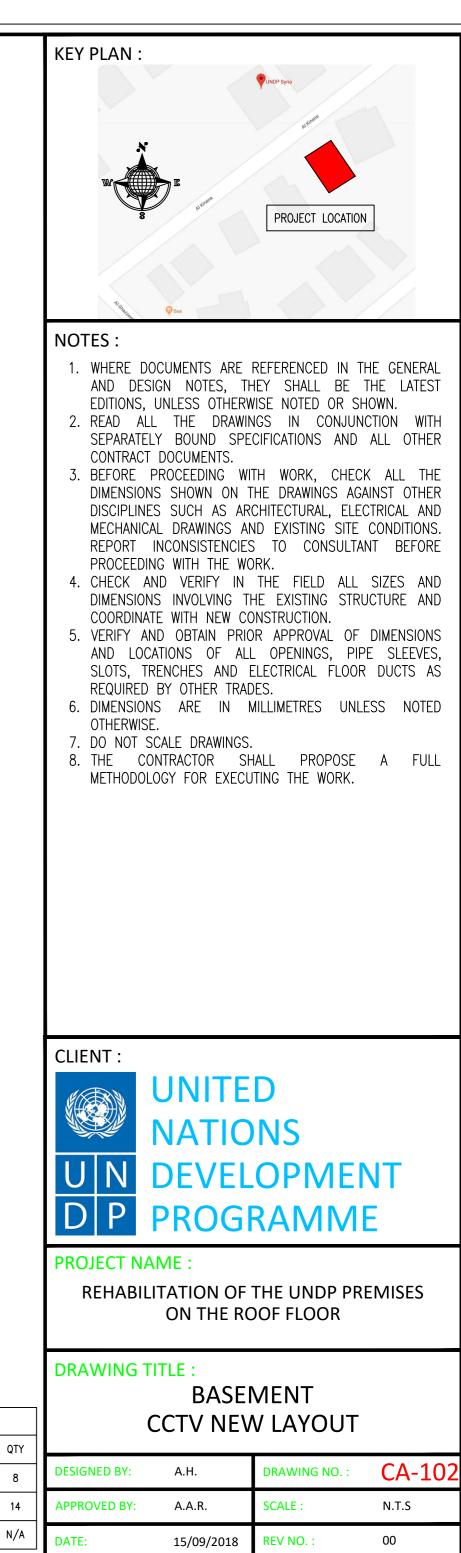

		LEGEND	
SYMBOL	ABBREV.	DSCRIPTION	
Ð	IPC-IN	IP CAMERA-INDOOR	
	IPC-OUT	IP CAMERA-OUTDOOR	
	SFTP	SHIELDED AND FOILED TWISTED PAIR CABLE	

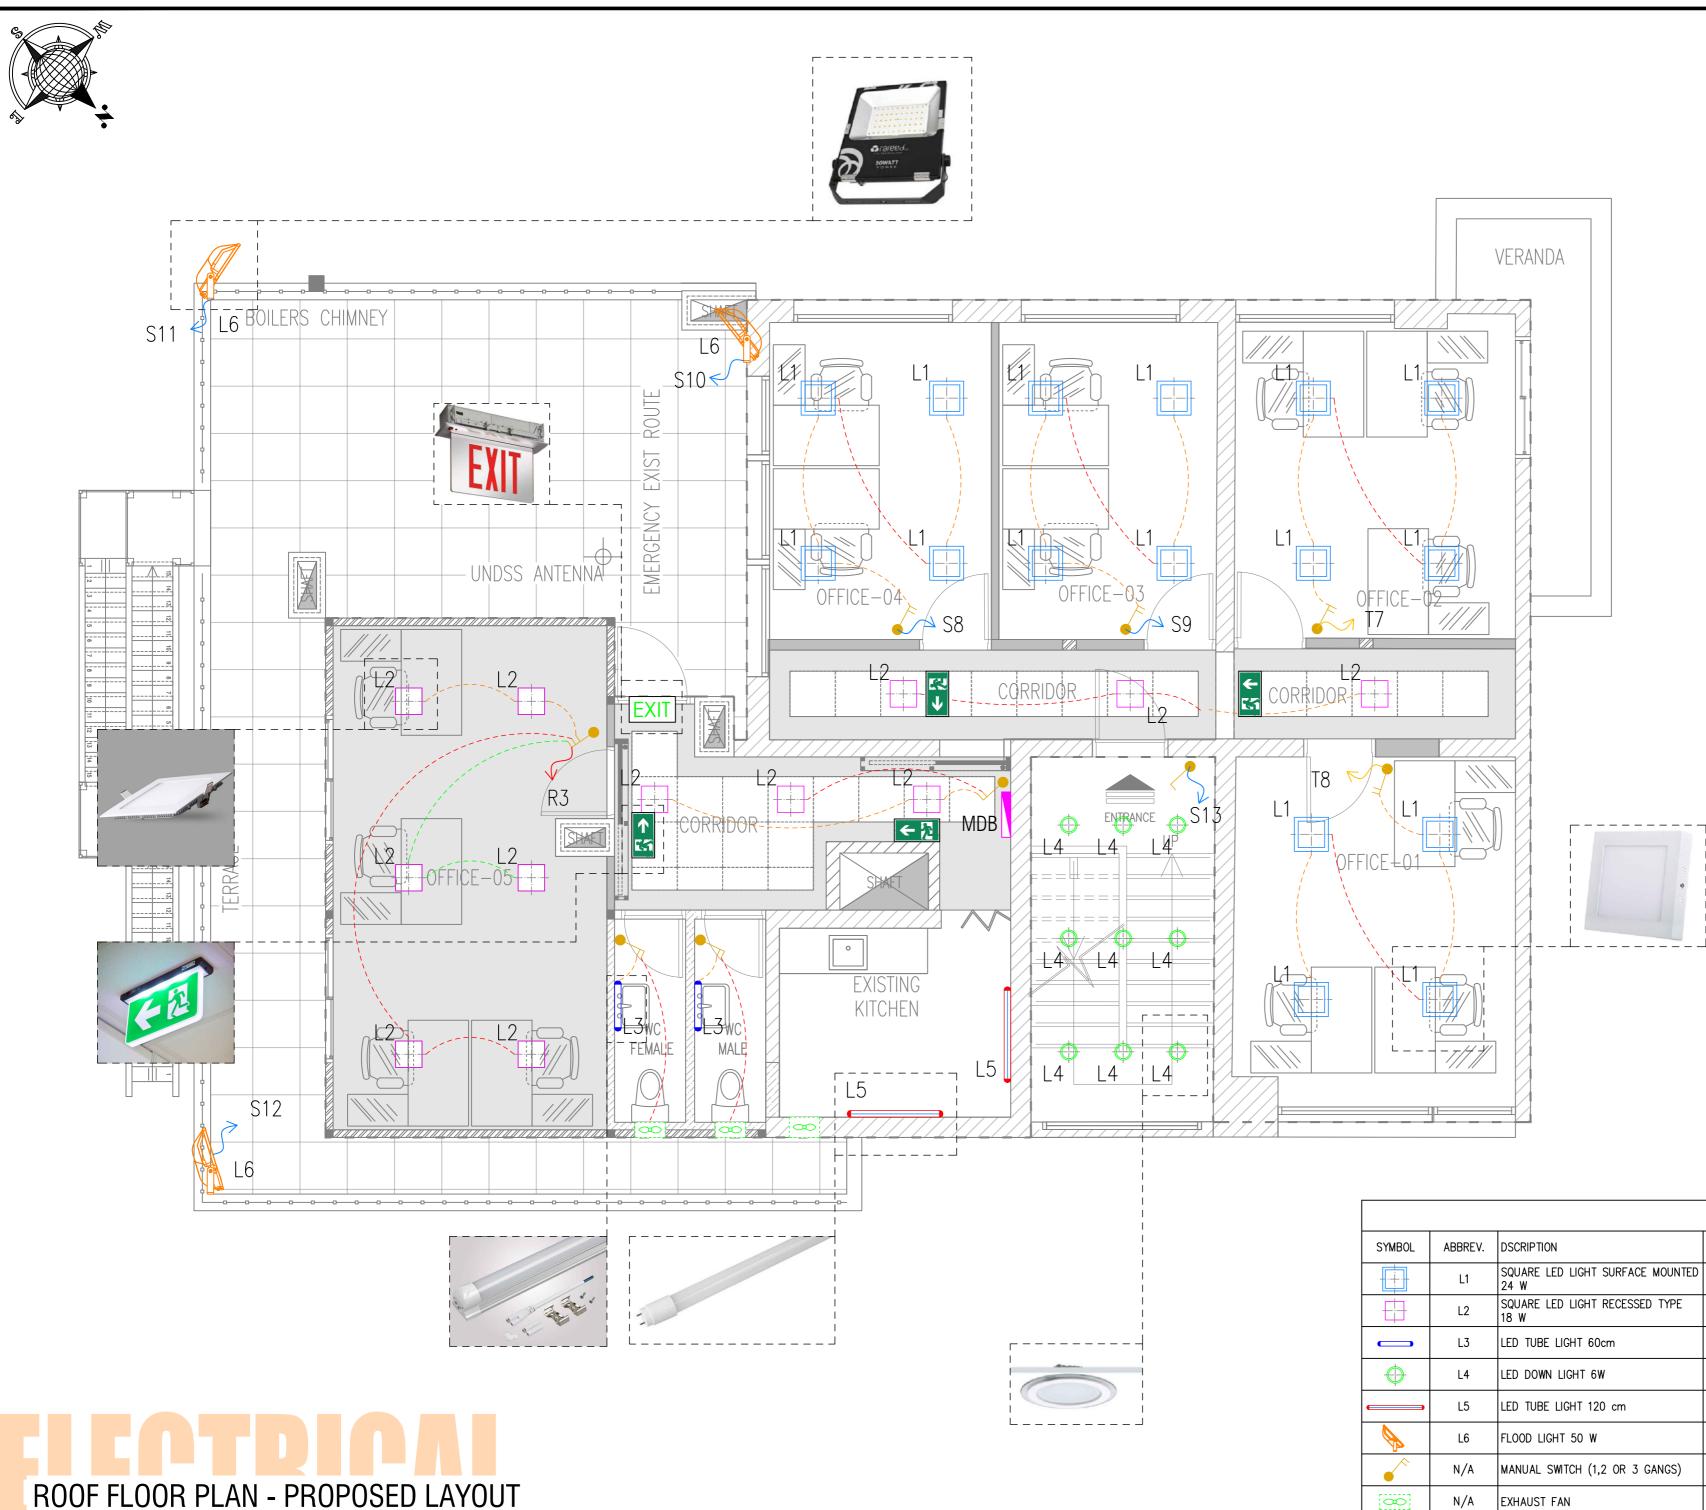


SYMBOL	ABBREV.	DSCRIPTION	QTY
	L1	SQUARE LED LIGHT SURFACE MOUNTED 24 W	16
	L2	SQUARE LED LIGHT RECESSED TYPE 18 W	12
	L3	LED TUBE LIGHT 60cm	2
$\Phi$	L4	LED DOWN LIGHT 6W	9
	L5	LED TUBE LIGHT 120 cm	4
	L6	FLOOD LIGHT 50 W	3
	N/A	MANUAL SWITCH (1,2 OR 3 GANGS)	N/A
8	N/A	EXHAUST FAN	3
		•	


DATE:

15/09/2018

REV NO. :

00

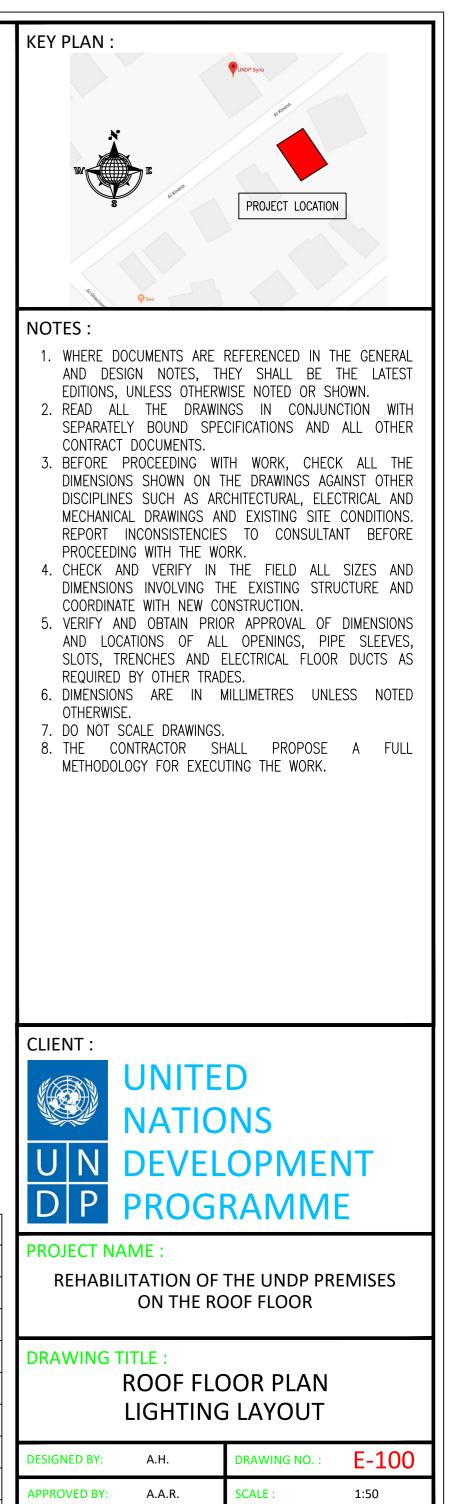

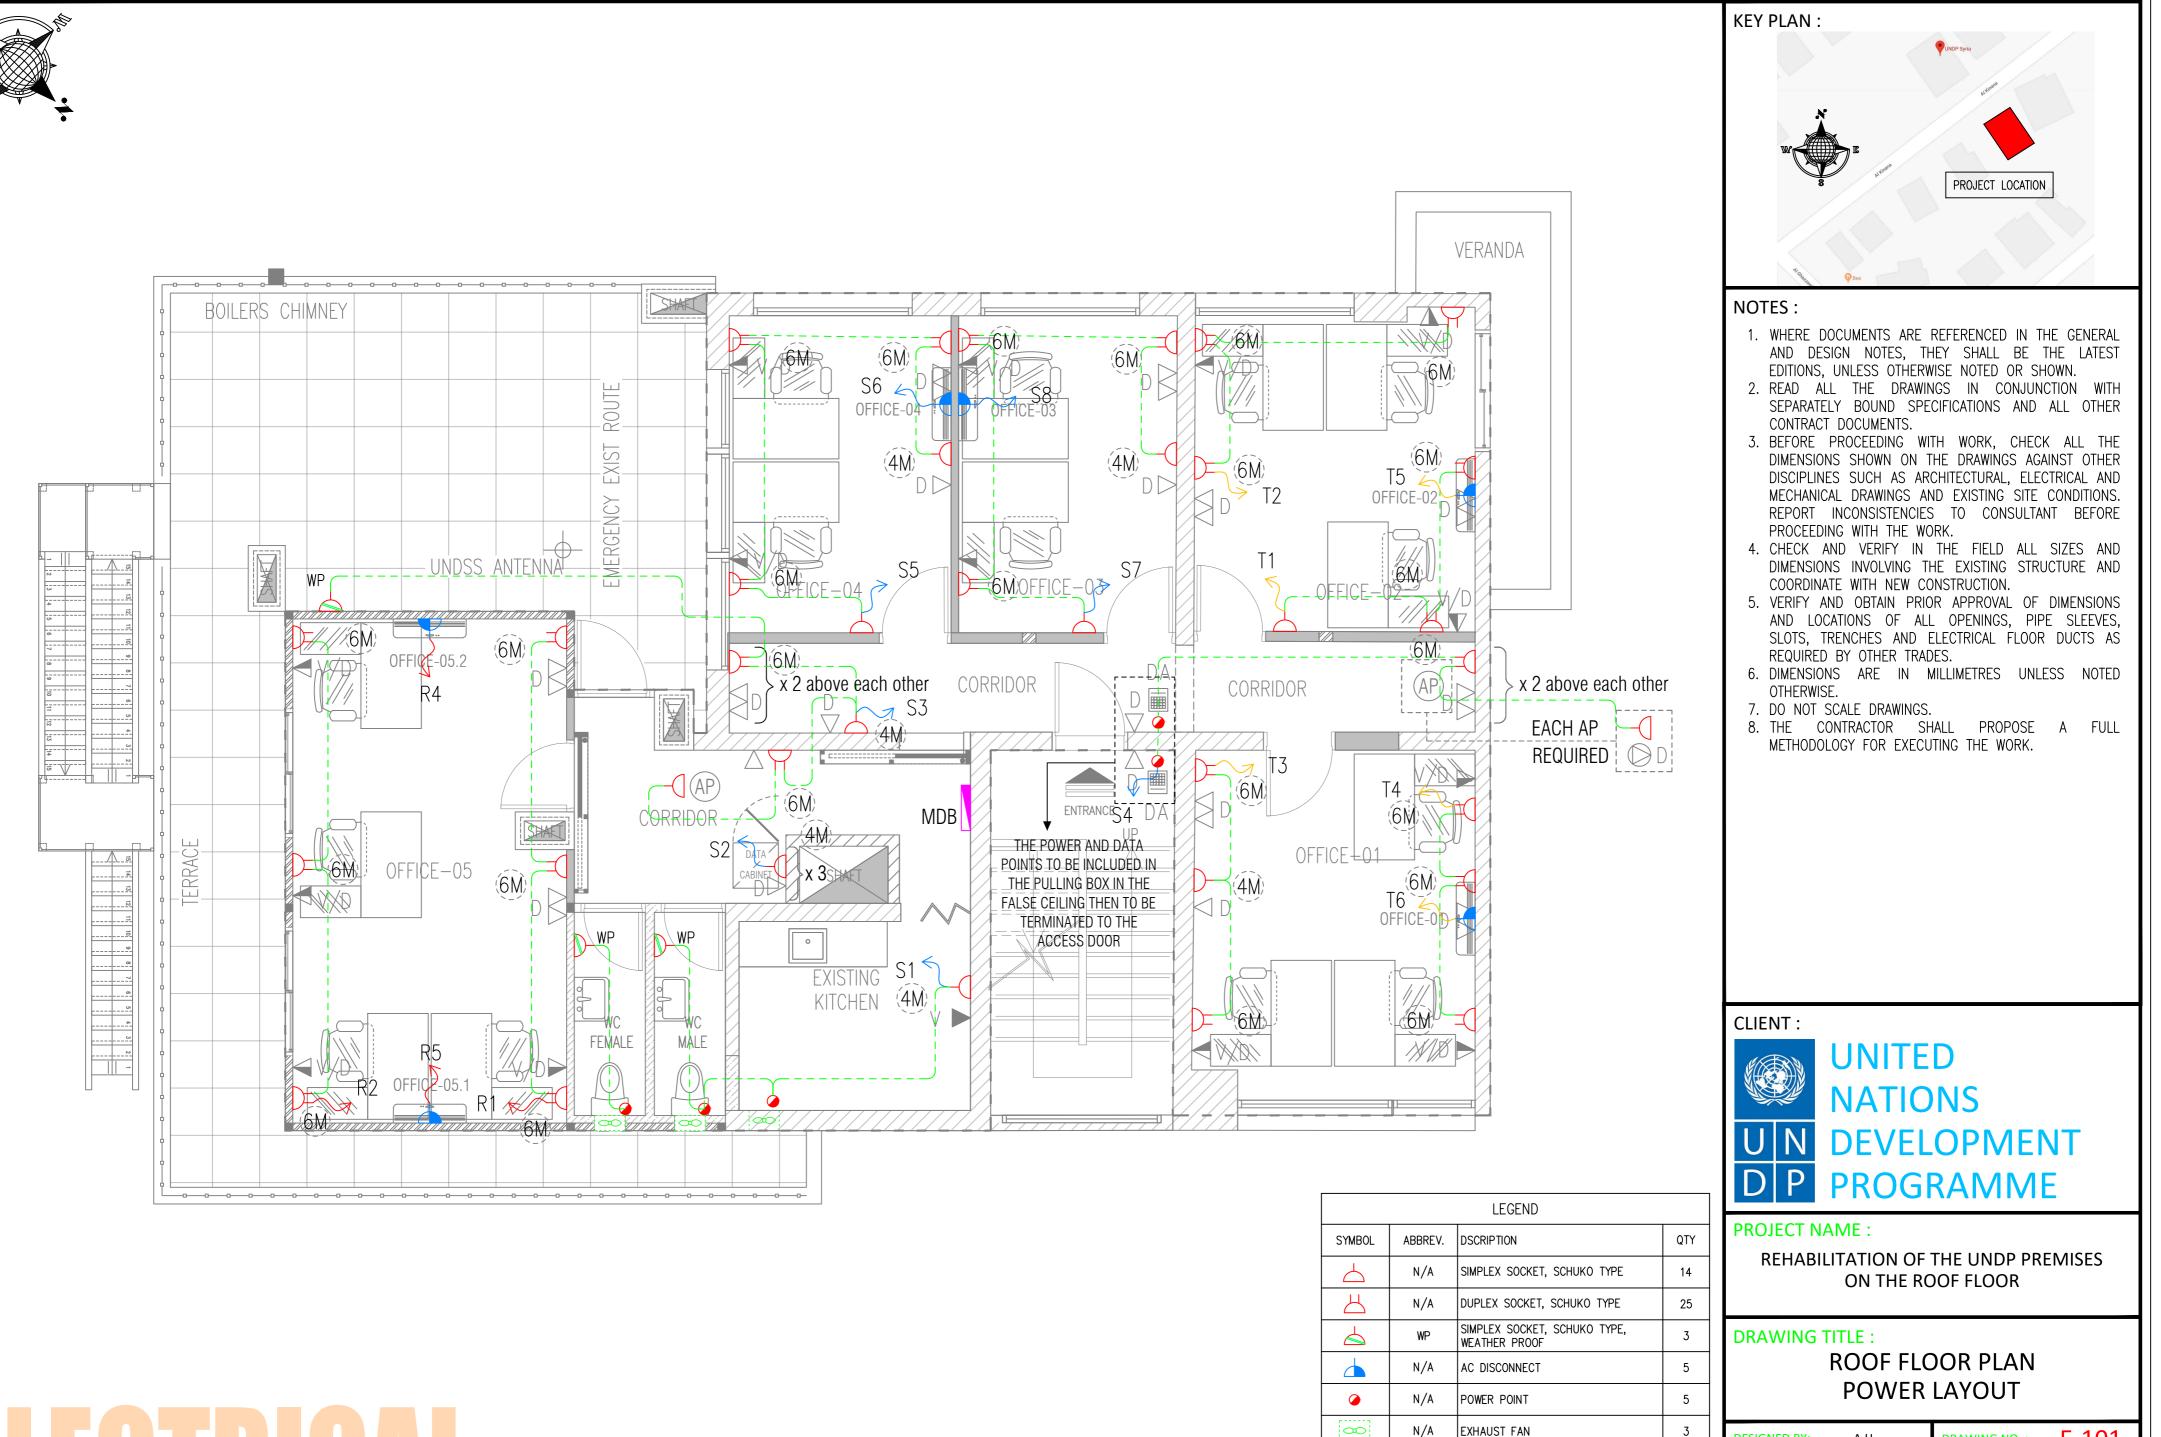

DESIGNED BY:	A.H.	DRAWING NO. :	E-101
APPROVED BY:	A.A.R.	SCALE :	1:50
DATE:	15/09/2018	REV NO. :	00

MAIN DISTRIBUTION BOARD

WEATHER PROOF


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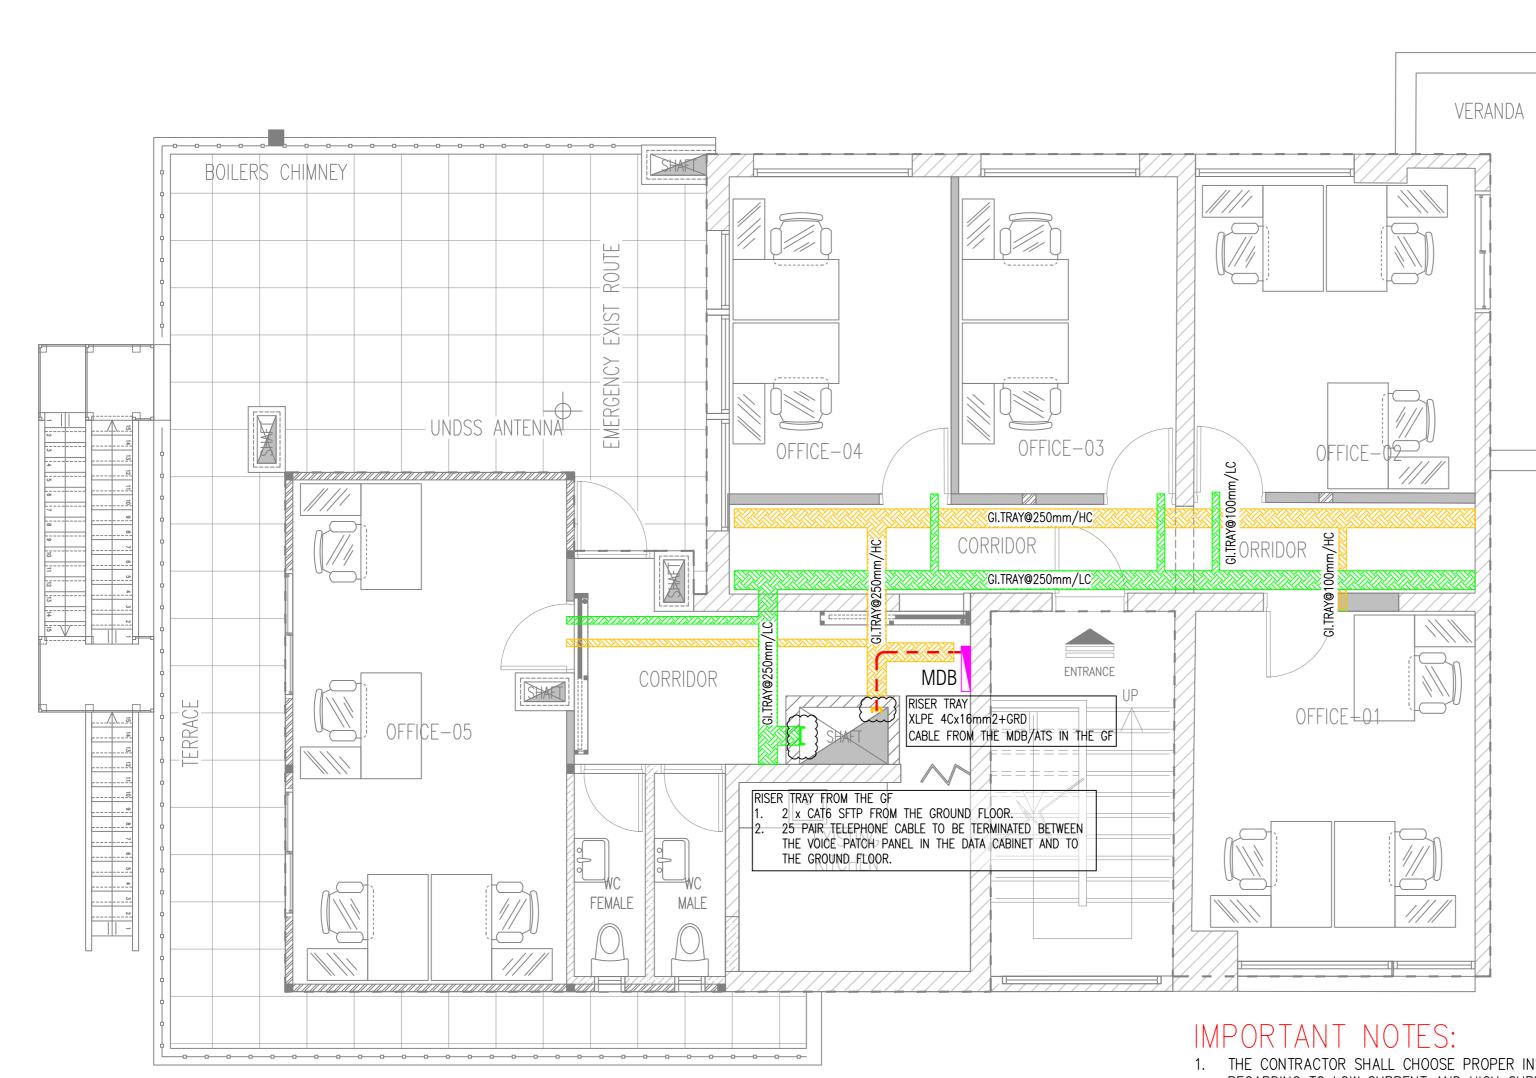
MDB

WP


N/A





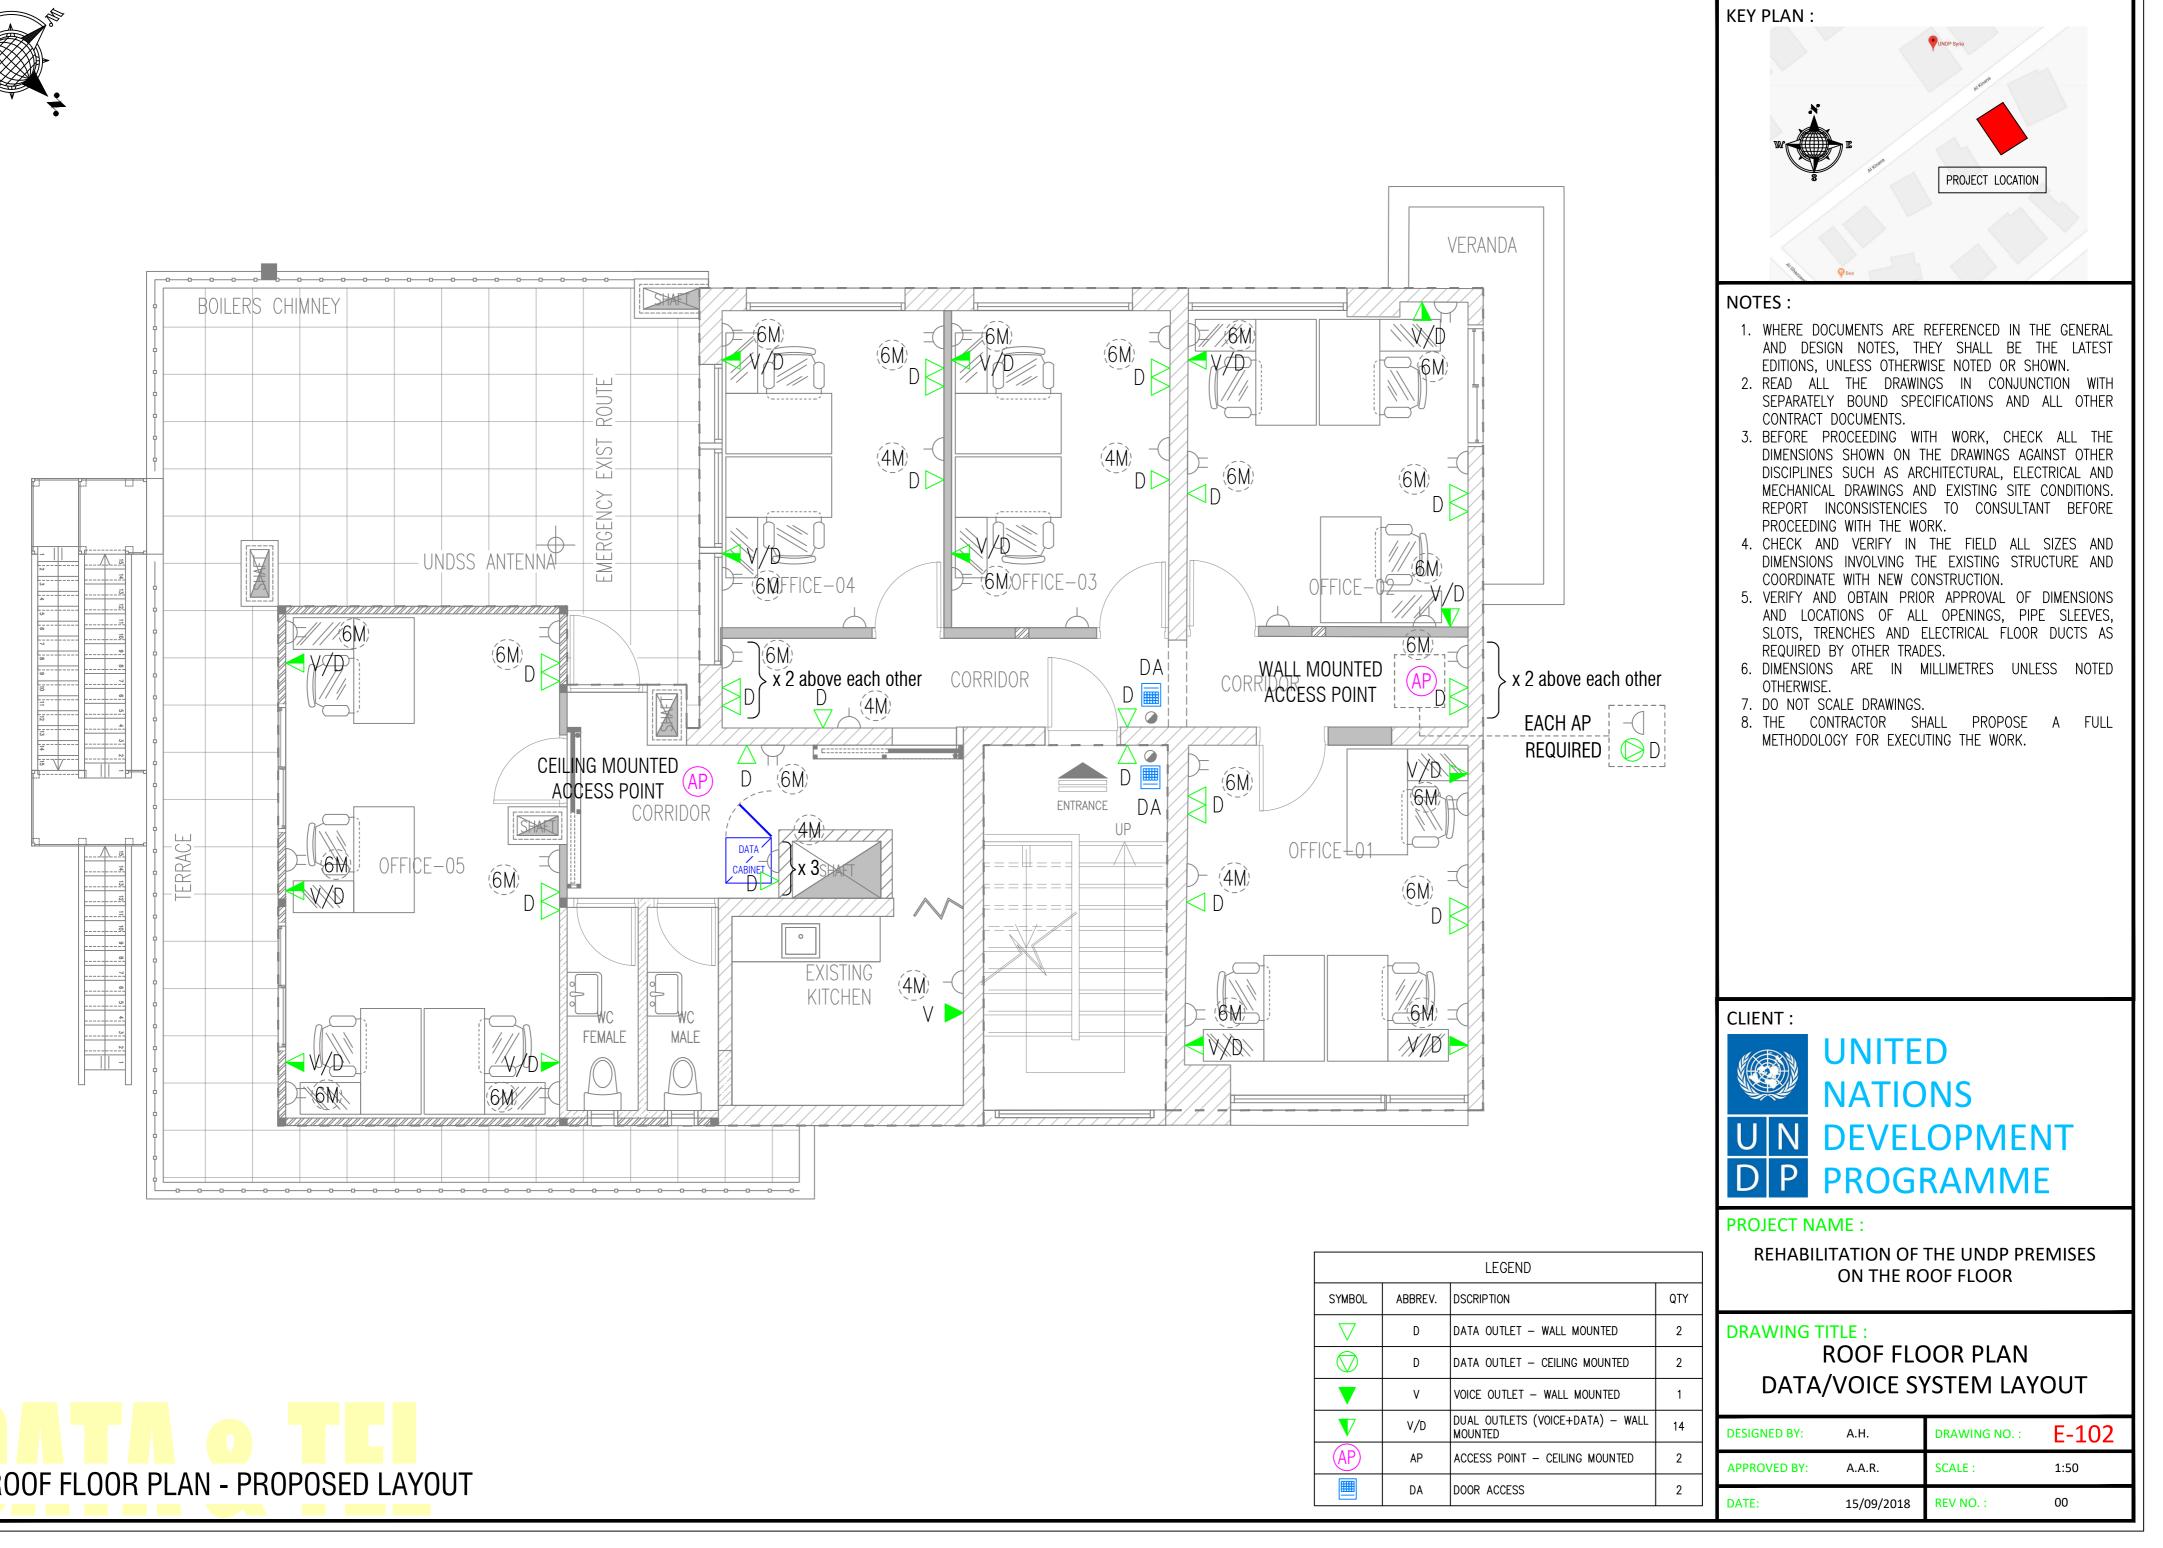

- THE CONTRACTOR SHALL CHOOSE PROPER INSTALLATION ROUTING REGARDING TO LOW CURRENT AND HIGH CURRENT CABLES.
- 2. THE DISTANCE BETWEEN THE LC AND HC CABLES NOT LESS THAN 25cm.
- THE CONTRACTOR SHALL INSTALL CABLES INVISIBLY IN THE GYPSUM 3. BOARD/CEMENT BOARD PARTITIONS.
- 4. WHERE THE VISIBLE INSTALLATION IS REQUIRED, THE CONTRACTOR SHALL USE PVC TRUNKING WITH A SIZE SUITABLE TO THE CABLES WITH DRAWING TITLE : ADDITION OF 50% FREE SPACE.
- 5. THE LC TRUNKING SHALL BE INSTALLED AT THE HIGH LEVEL OF THE ROOM ALONG THE WALL AND DOWN AT ANY ROOM CORNER @ 40cm F.F.L.
- 6. THE HC TRUNKING SHALL BE INSTALLED AT THE LOW LEVEL OF THE ROOM AT THE EDGE OF SKIRTING.

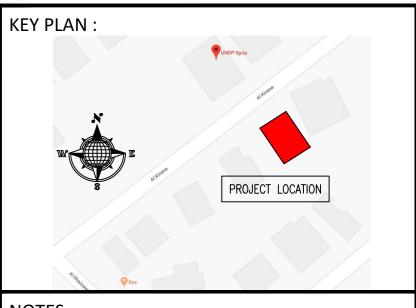

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### CLIENT :



### PROJECT NAME :

**REHABILITATION OF THE UNDP PREMISES** ON THE ROOF FLOOR


### **ROOF FLOOR PLAN** CABLE TRAYS LAYOUT


DESIGNED BY:	A.H.	DRAWING NO. :	E-103
APPROVED BY:	A.A.R.	SCALE :	1:50
DATE:	15/09/2018	REV NO. :	00


### SCHEMATIC LAYOUT

TO BE INSTALLED IN THE EXISTING 4" PVC CONDUIT IN THE STREET

### UN BUILDING INCLUDING UNDP OFFICE IN THE ROOF FLOOR

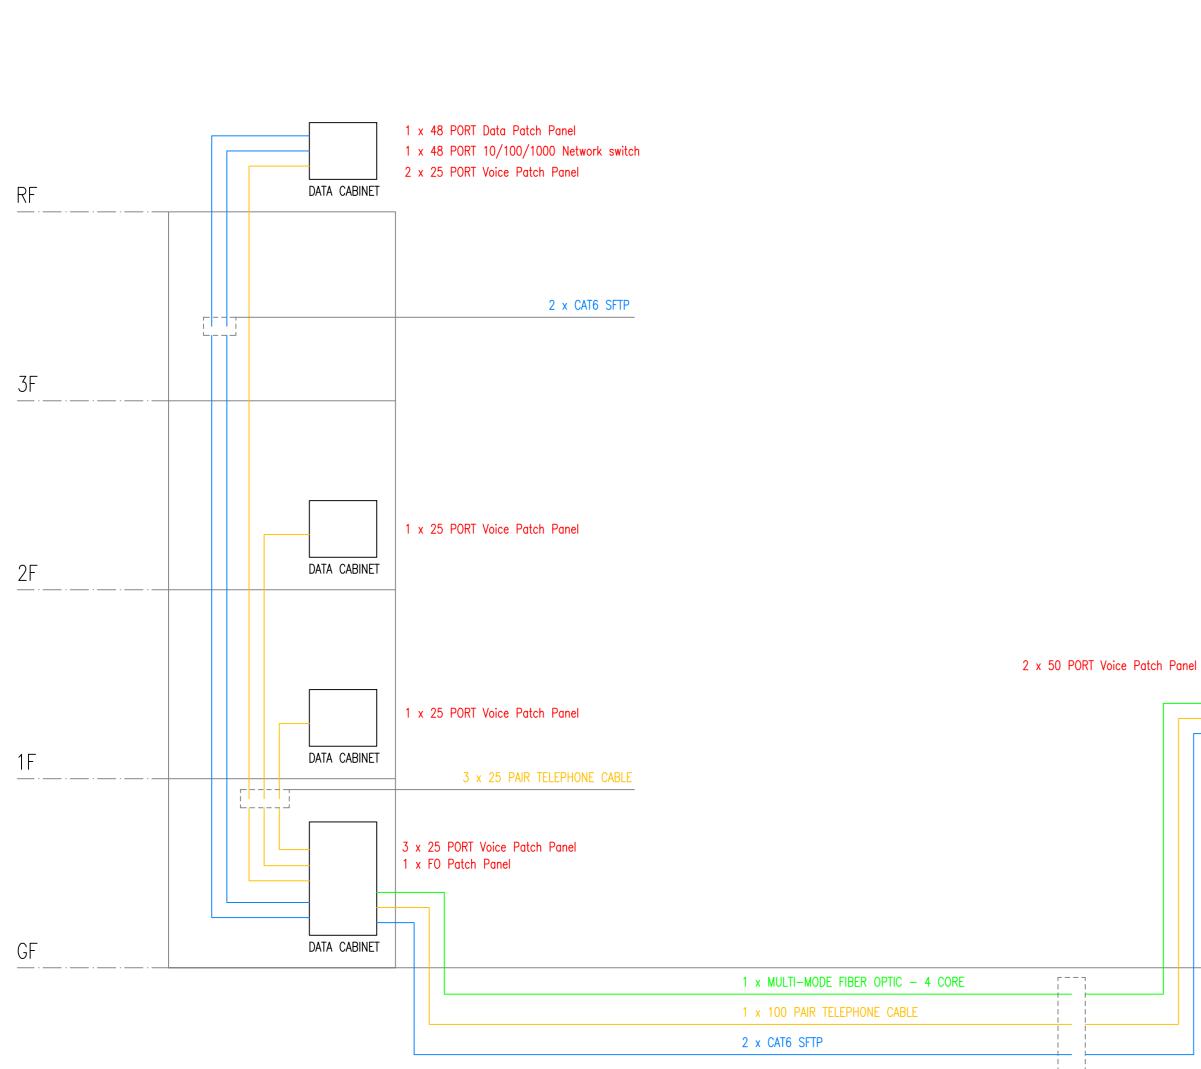

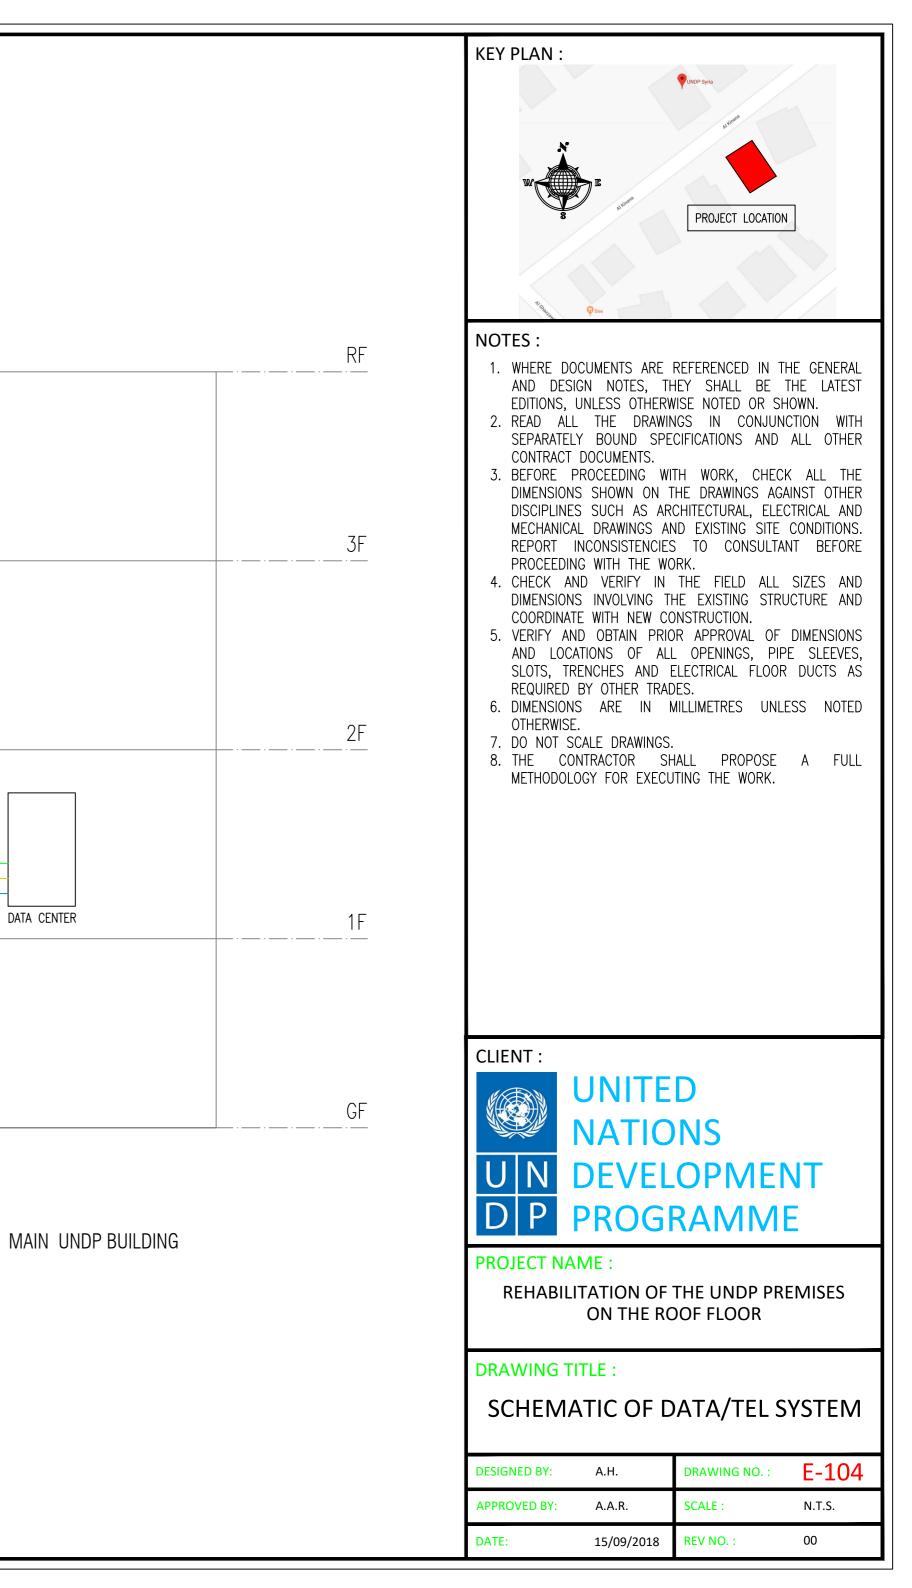

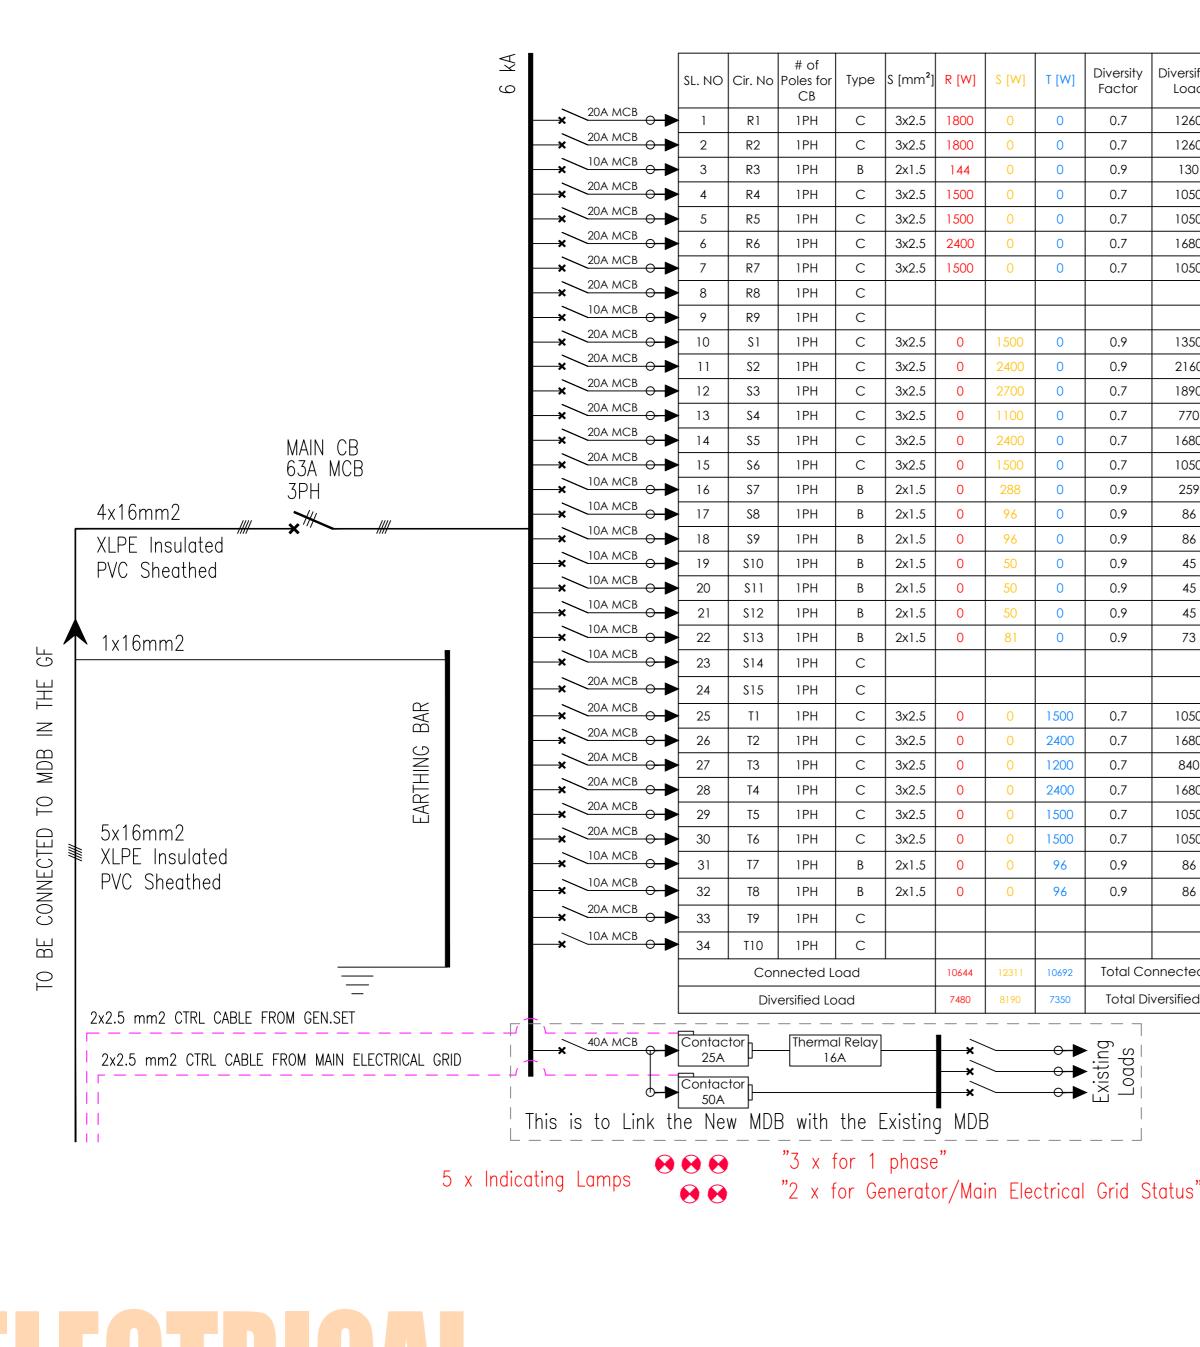


**ELECTRICAL LOAD SCHEDULE & SLD** 

ity Diversified Load Location		Location		
or	Load	Туре	Localion	
	1260	POWER	OFFICE-05	
	1260	POWER	OFFICE-05	
	130	LIGHT	OFFICE-05	
	1050	MECH	OFFICE-05 - AC - OFFICE-5.2	
	1050	MECH	OFFICE-05 - AC - OFFICE-5.1	
	1680	POWER	OFFICE-04	
	1050	MECH	OFFICE-04 - AC - OFFICE-4	
			SPARE	
			SPARE	
	1350	POWER	WET AREA	
	2160	POWER	SERVER CABINET	
	1890	POWER	CORRIDOR	
	770	POWER	CORRIDOR	
	1680	POWER	OFFICE-03	
	1050	MECH	OFFICE-03	
	259	LIGHT	KITCHEN + CORRIDOR	
	86	LIGHT	OFFICE-04	
	86	LIGHT	OFFICE-03	
	45	LIGHT	EXTERNAL LIGHTING	
	45	LIGHT	EXTERNAL LIGHTING	
	45	LIGHT	EXTERNAL LIGHTING	
	73	LIGHT	ENTRANCE LIGHTING	
			Spare	
			Space	
	1050	POWER	OFFICE-02	
	1680	POWER	OFFICE-02	
	840	POWER	OFFICE-01	
	1680	POWER	OFFICE-01	
	1050	MECH	OFFICE-02	
	1050	MECH	OFFICE-01	
	86	LIGHT	OFFICE-02	
	86	LIGHT	OFFICE-02	
			Spare	
			Space	
Connected Logid Turt		nd [kw]	33.6470	
Connected Load [kW]				
II DI	versified Loa	ia [km]	23.0195	
			ALL THE ENLIPMENT WITH 20 9 SADCE	

TO FIT ALL THE EQUIPMENT WITH 20 % SAPCE Surface-mounted Type Metal With Cover and Lock 96 Modules IP40

Main Distribution Board - MDB

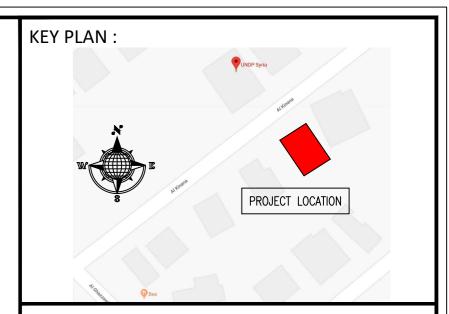

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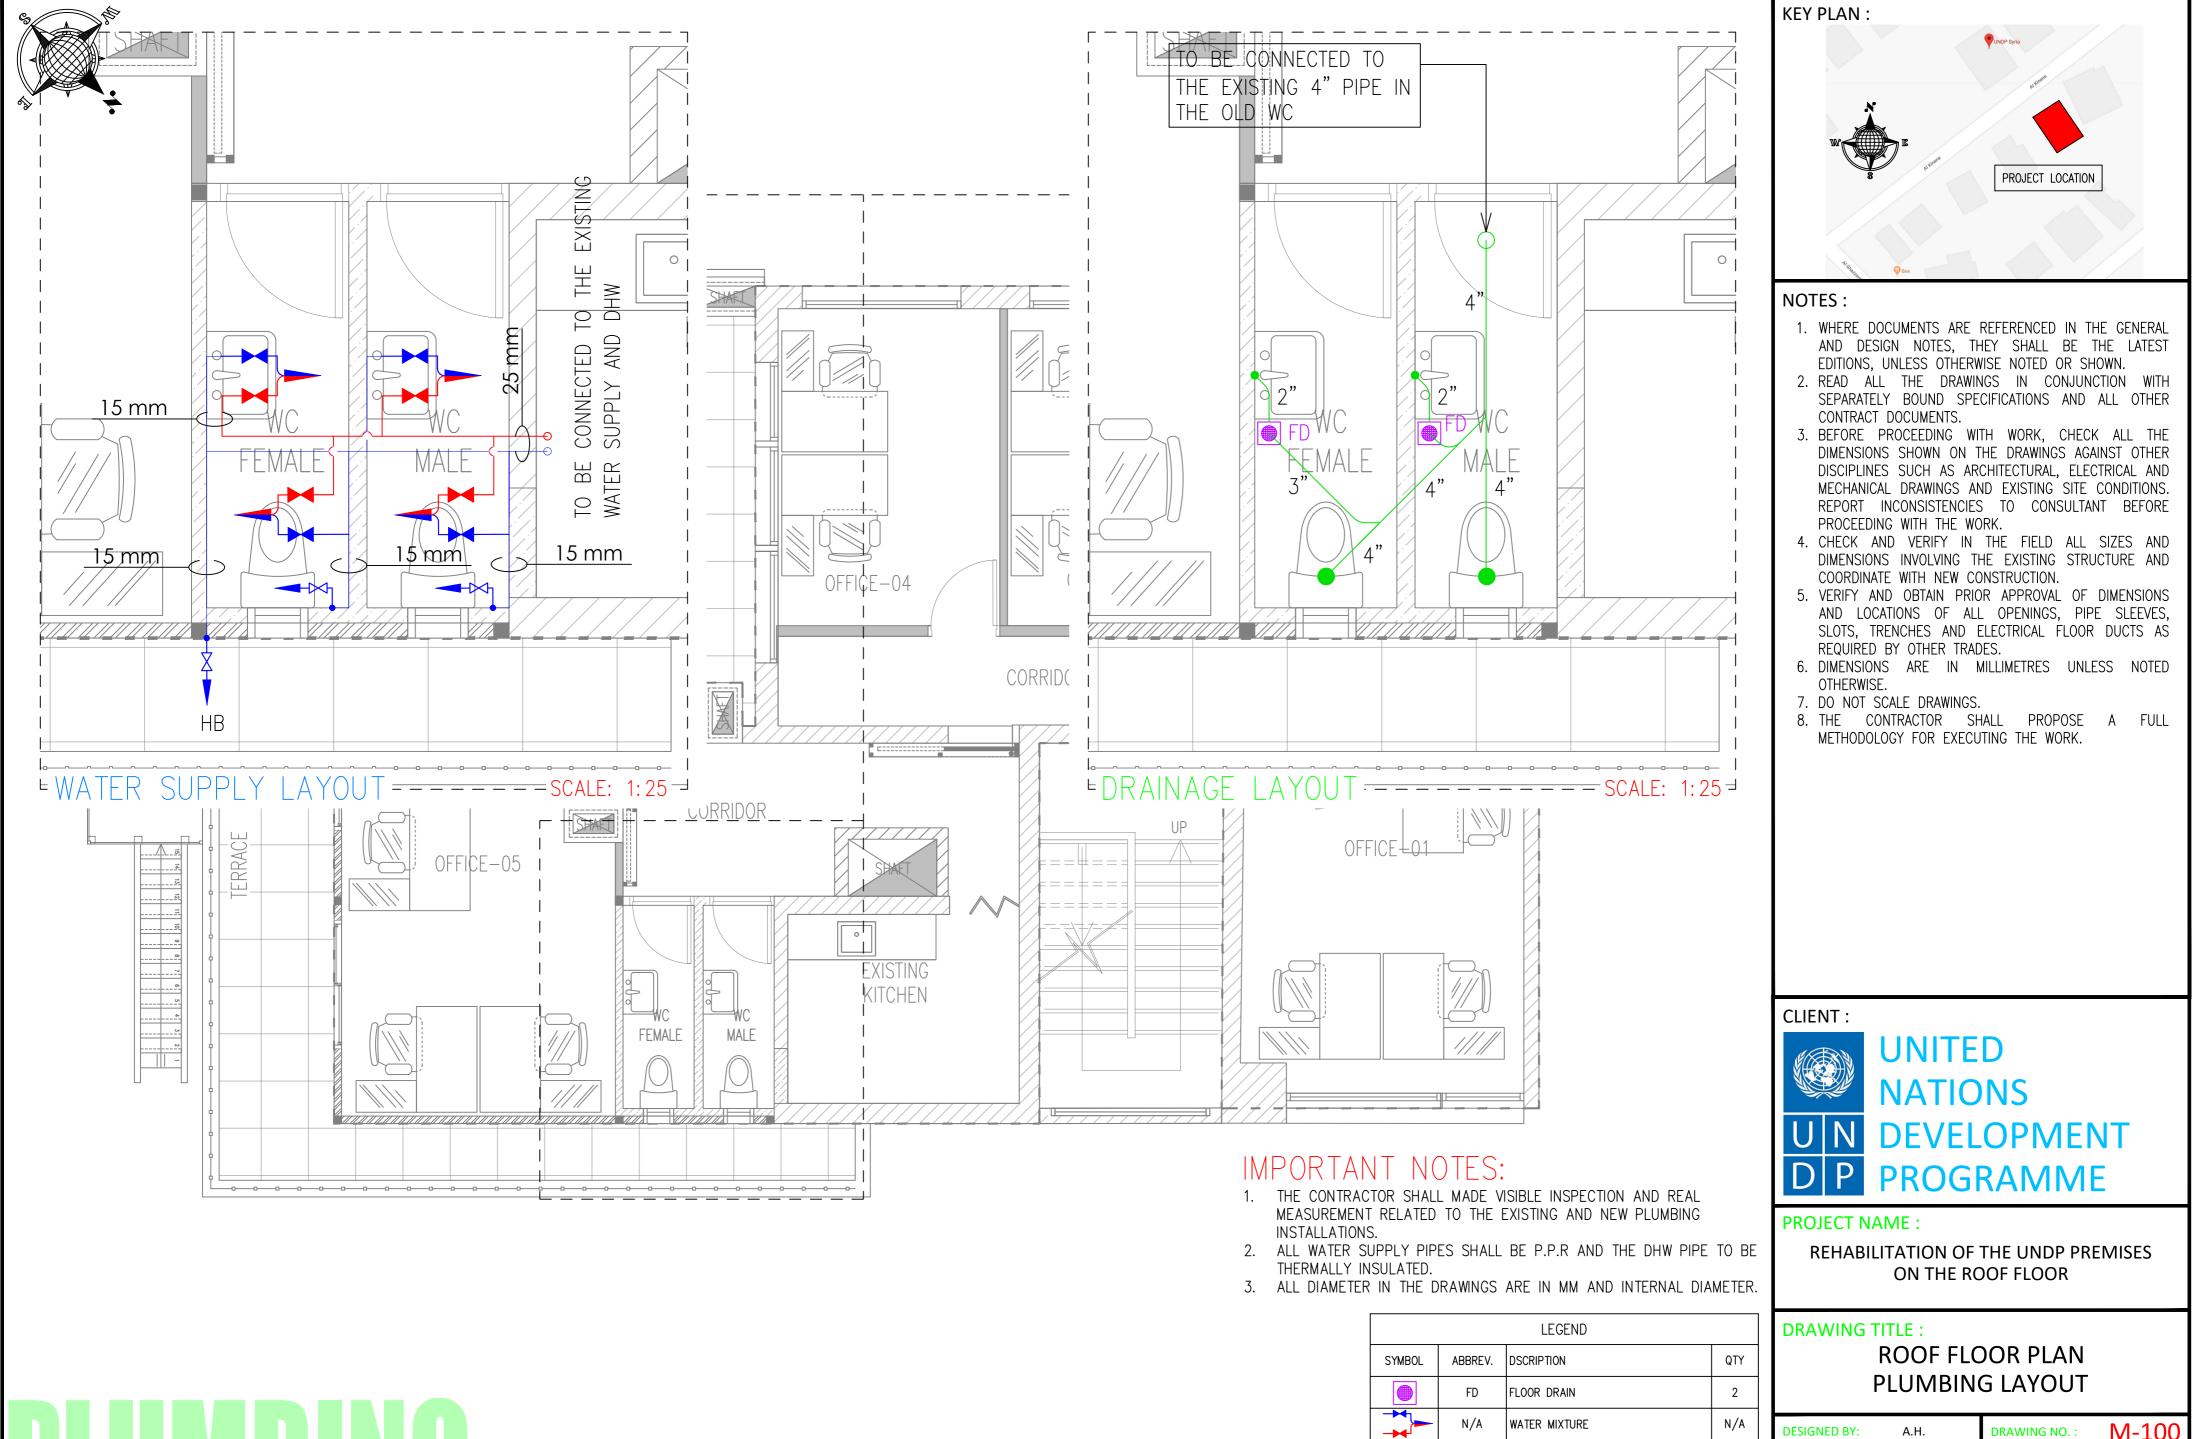
### **PROJECT NAME :**

**REHABILITATION OF THE UNDP PREMISES** ON THE ROOF FLOOR

### **DRAWING TITLE :**

### ELECTRICAL LOAD SCHEDULE

DESIGNED BY:	A.H.	DRAWING NO. :	E-105
APPROVED BY:	A.A.R.	SCALE :	N.T.S.
DATE:	15/09/2018	REV NO. :	00



DESIGNED BY:	A.H.	DRAWING NO. :	M-100
APPROVED BY:	A.A.R.	SCALE :	1:50
DATE:	15/09/2018	REV NO. :	00

HOSE BIB

HOT WATER

COLD WATER SUPPLY / DOMESTIC

1

N/A

HB

N/A

->-

