



EMPLOYER:




THE UNITED NATIONS DEVELOPMENT PROGRAMME PROGRAMME OF ASSISTANCE TO THE UN PALESTINIAN PEOPLE DP (UNDP/PAPP)

CLIENT




PALESTINIAN NATIONAL AUTHORITY MINISTRY OF PUBLIC WORKS & HOUSI MINISTRY OF PUBLIC WORKS & HOUSING (MPWH)

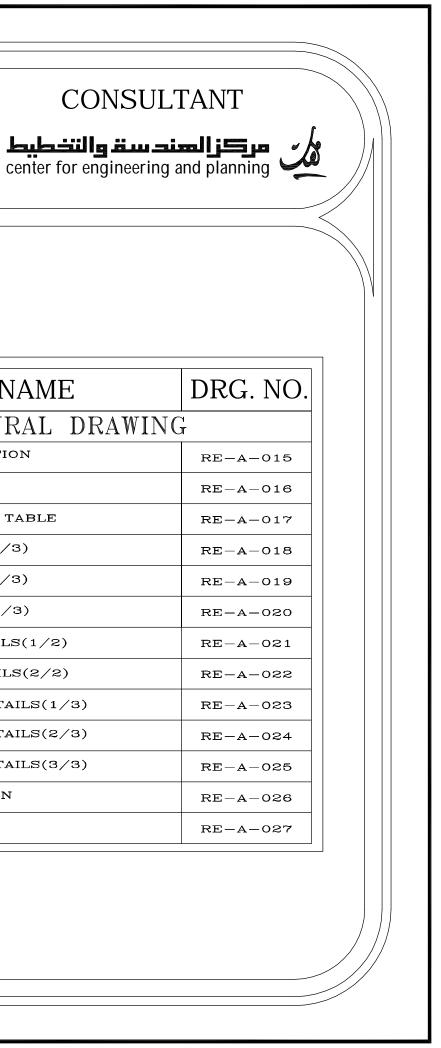


LIST OF DRAWINGS

S/NO.	DRAWING NAME	DRG. NO.	S/	NO.	DRAWING NAME
	ARCHITECTURAL DRAWING			ARCHITECTURAL DR.	
01/27	GENERAL LAYOUT, LOCATION AND DESIGN LEVEL OF THE BUILDING	RE-A-001	1	5/27	LONGITUDINAL SECTION
02/27	COORDINATES FOR THE BUILDING	RE-A-002	1	6/27	CROSS SECTIONS
03/27	EXISTING LEVEL FOR THE BUILDING SITE	RE-A-003	1	7/27	WINDOWS & DOORS TABLE
04/27	FURNITURE FOR UNDERGROUND FLOOR	RE-A-004	1	8/27	FINISHES TABLE $(1/3)$
05/27	FURNITURE FOR GROUND FLOOR	RE-A-005	1	9/27	FINISHES TABLE (2/3)
06/27	FURNITURE FOR TYPICAL FLOOR	RE-A-006	2	0/27	FINISHES TABLE (3/3)
07/27	UNDERGROUND FLOOR PLAN	RE-A-007	2	1/27	METAL DOOR DETAILS(1/2)
08/27	GROUND FLOOR PLAN	RE-A-008	2	2/27	METAL DOOR DETAILS(2/2)
09/27	TYPICAL FLOOR PLAN	RE-A-009	2	3/27	WOODEN DOOR DETAILS(1/3)
10/27	ROOF PLAN	RE-A-010	2	4/27	WOODEN DOOR DETAILS(2/3)
11/27	FINAL ROOF PLAN	RE-A-011	2	5/27	WOODEN DOOR DETAILS(3/3)
12/27	FRONT ELEVATION	RE-A-012	2	6/27	WINDOWS ELEVATION
13/27	BACK ELEVATION	RE-A-013	2	7/27	KITCHEN DETAILS
14/27	SIDE ELEVATIONS	RE-A-014			

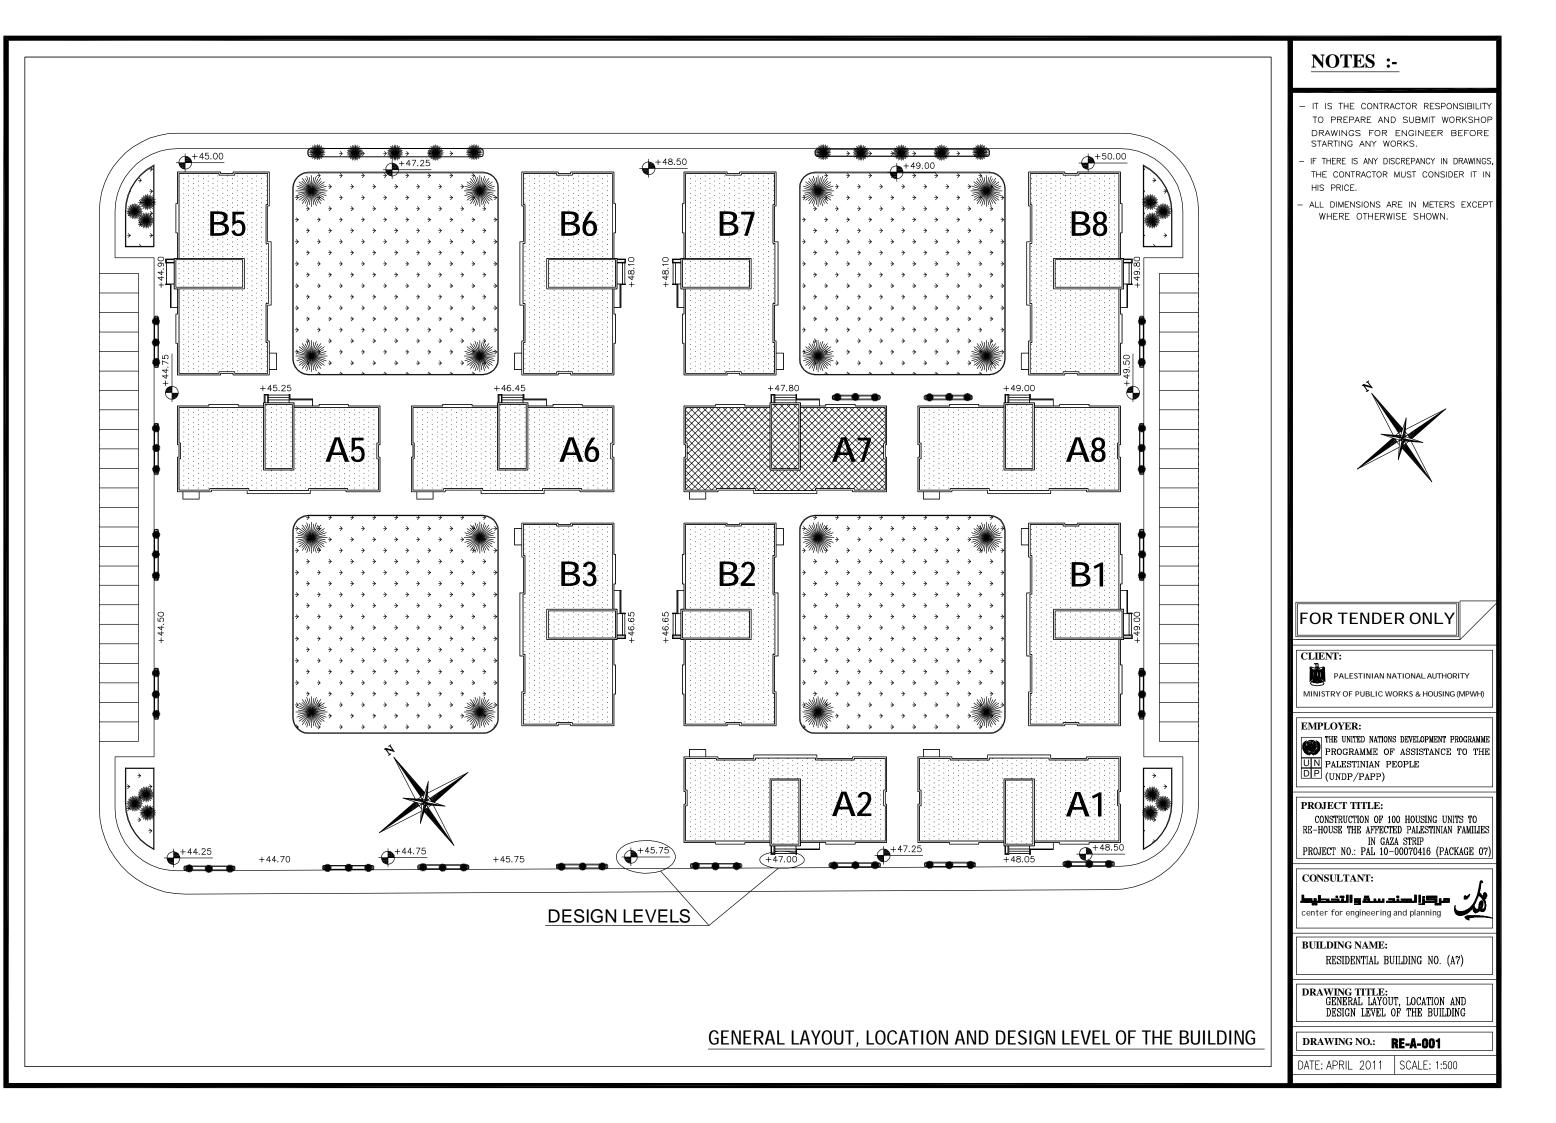


BUILDING NO. A7


Piont	Х	Y
1	100604.5970	107325.9991
2	100608.1731	107323.5225
3	100608.2870	107323.6869
4	100612.0687	107321.0680
5	100611.9548	107320.9035
6	100618.6138	107316.2919
7	100618.7277	107316.4563
8	100622.5094	107313.8374
9	100622.3955	107313.6729
10	100625.9717	107311.1963
11	100628.5052	107314.8547
12	100628.3408	107314.9686
13	100629.5364	107316.6950
14	100629.7008	107316.5811
15	100632.2344	107320.2395
16	100610.8597	107335.0422
17	100608.3261	107331.3839
18	100608.4906	107331.2700
19	100607.2949	107329.5436
20	100607.1305	107329.6575

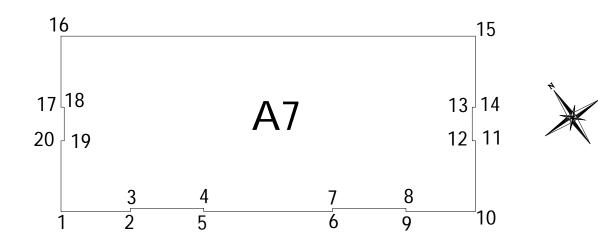



COORDINATES FOR THE BUILDING

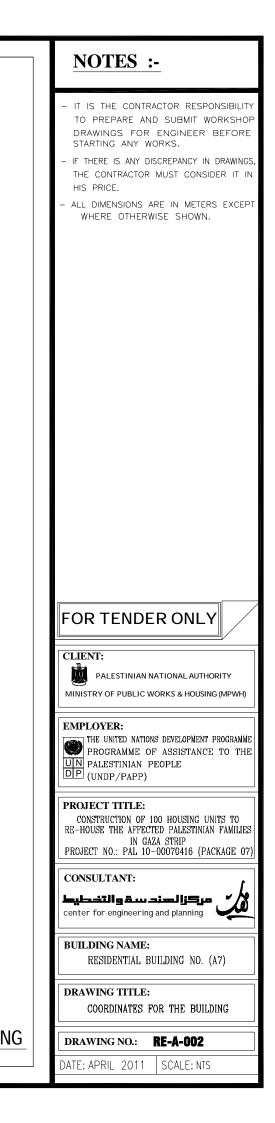




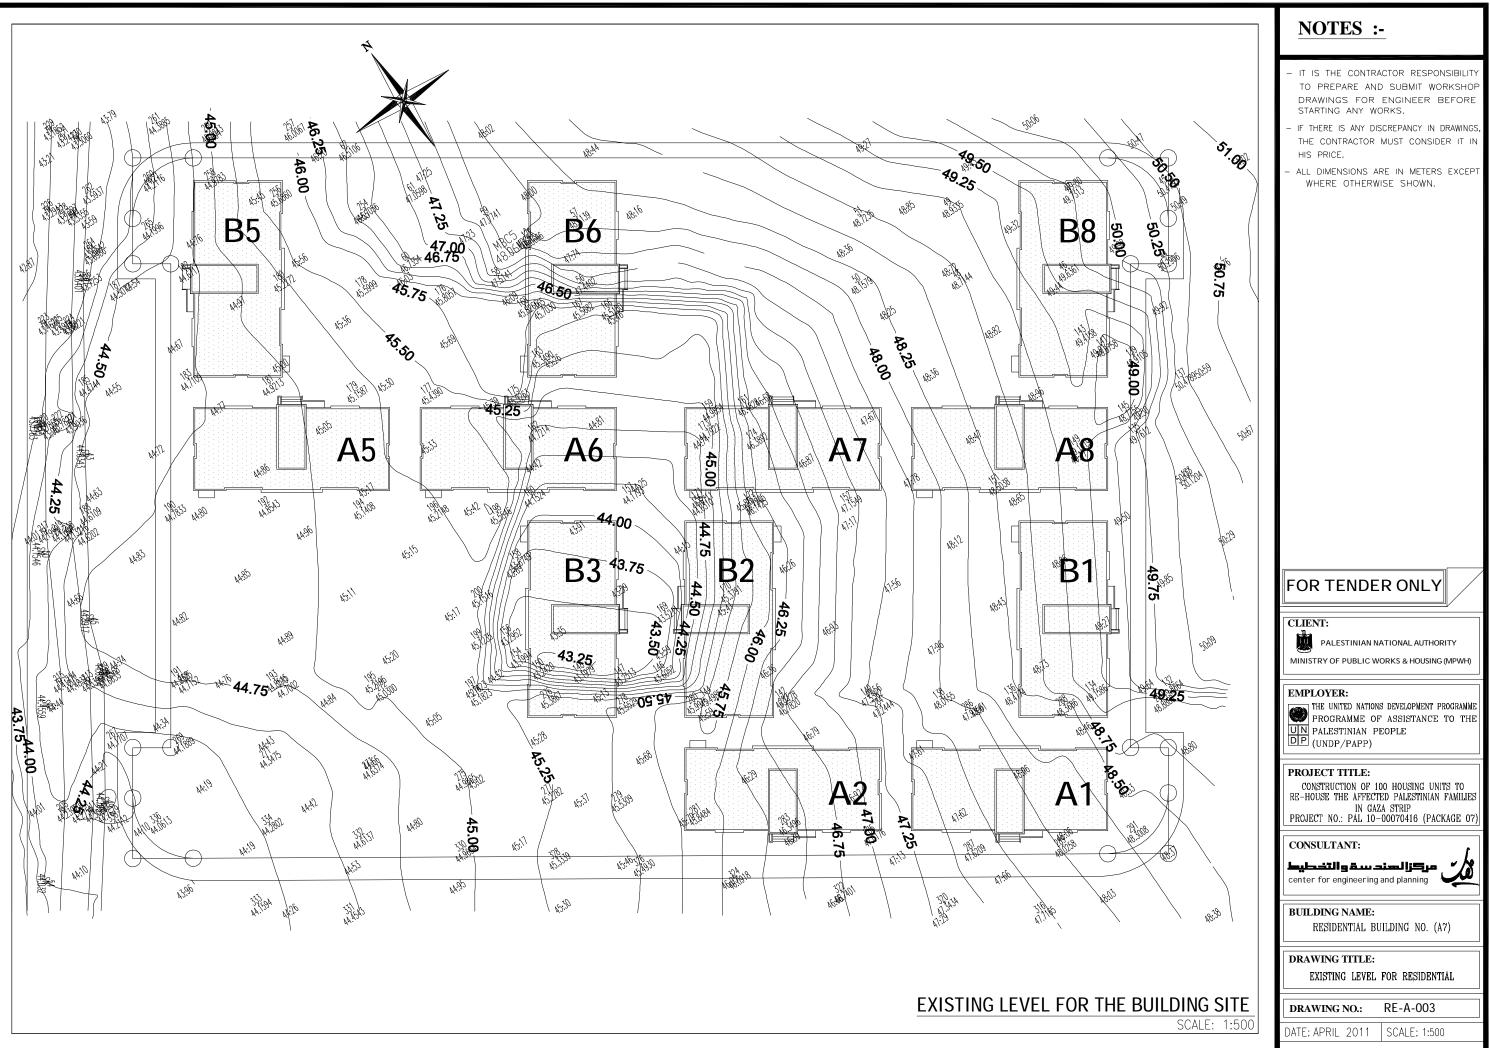

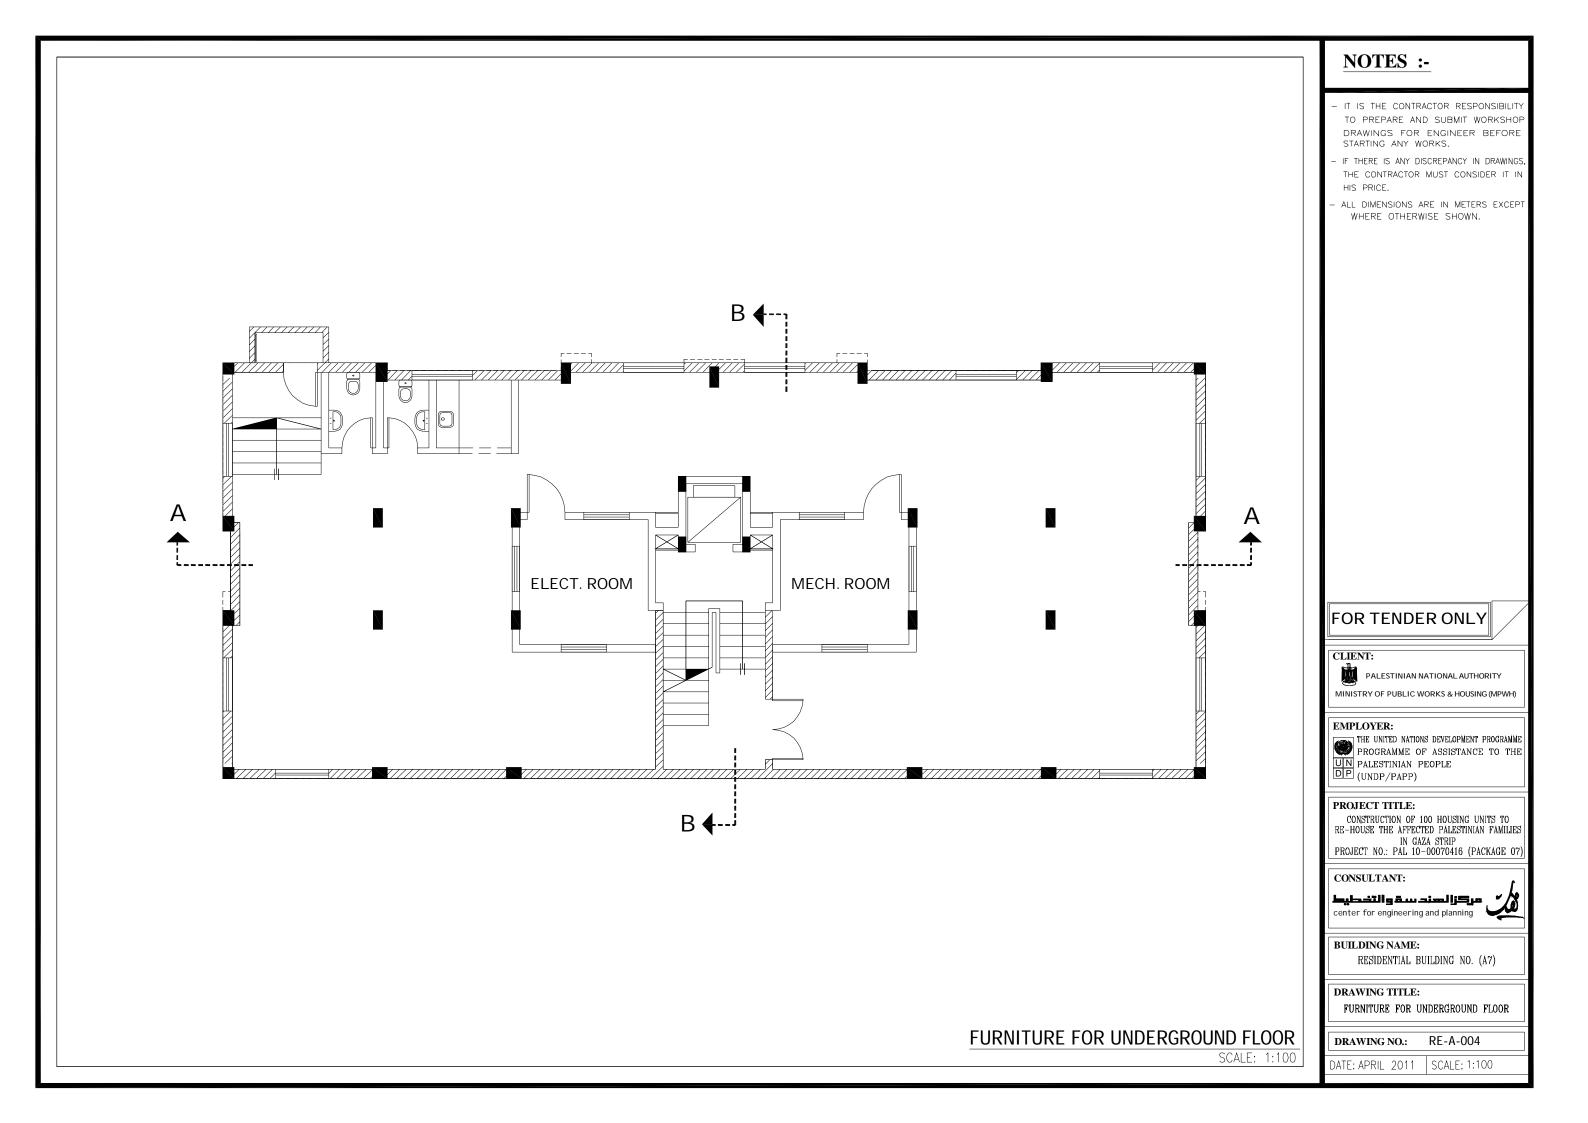


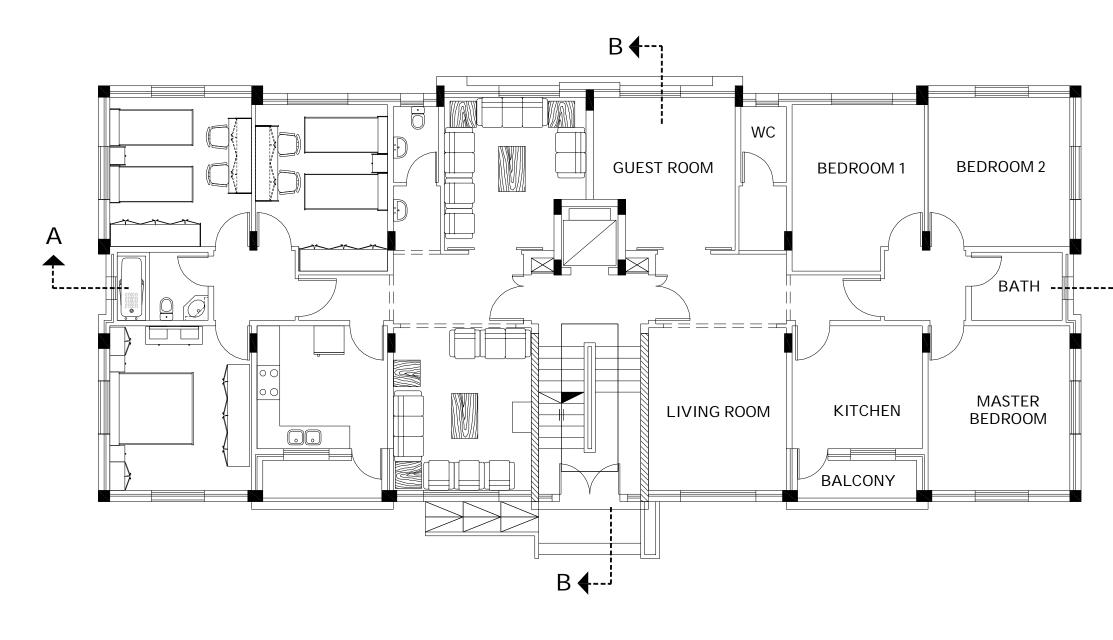

FURNITURE FOR GROUND FLOOR

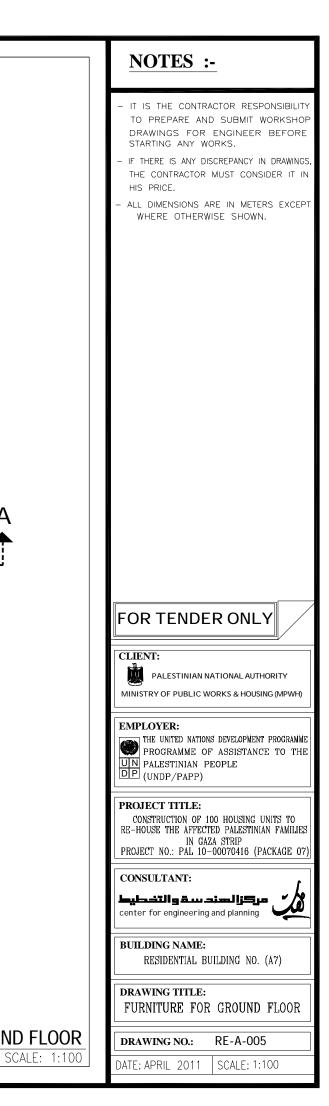


А

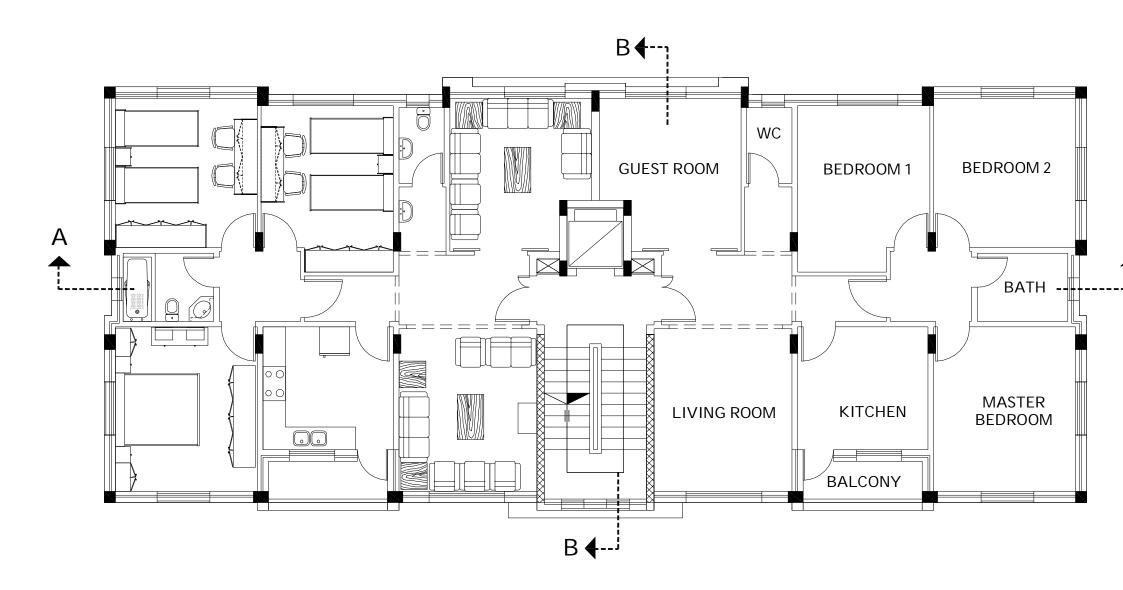



FURNITURE FOR TYPICAL FLOOR




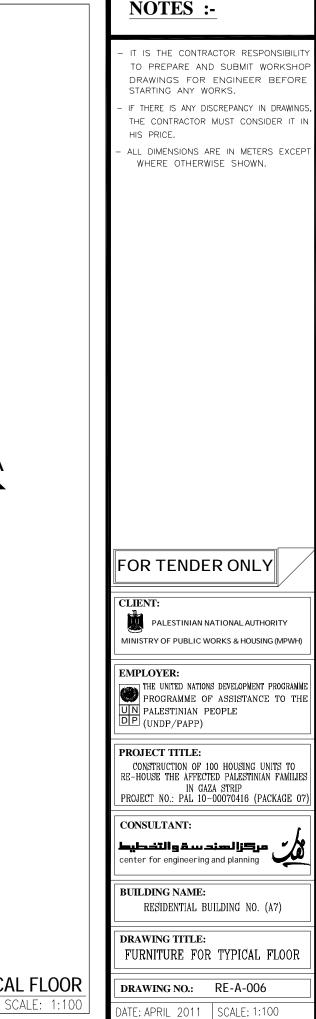



Α

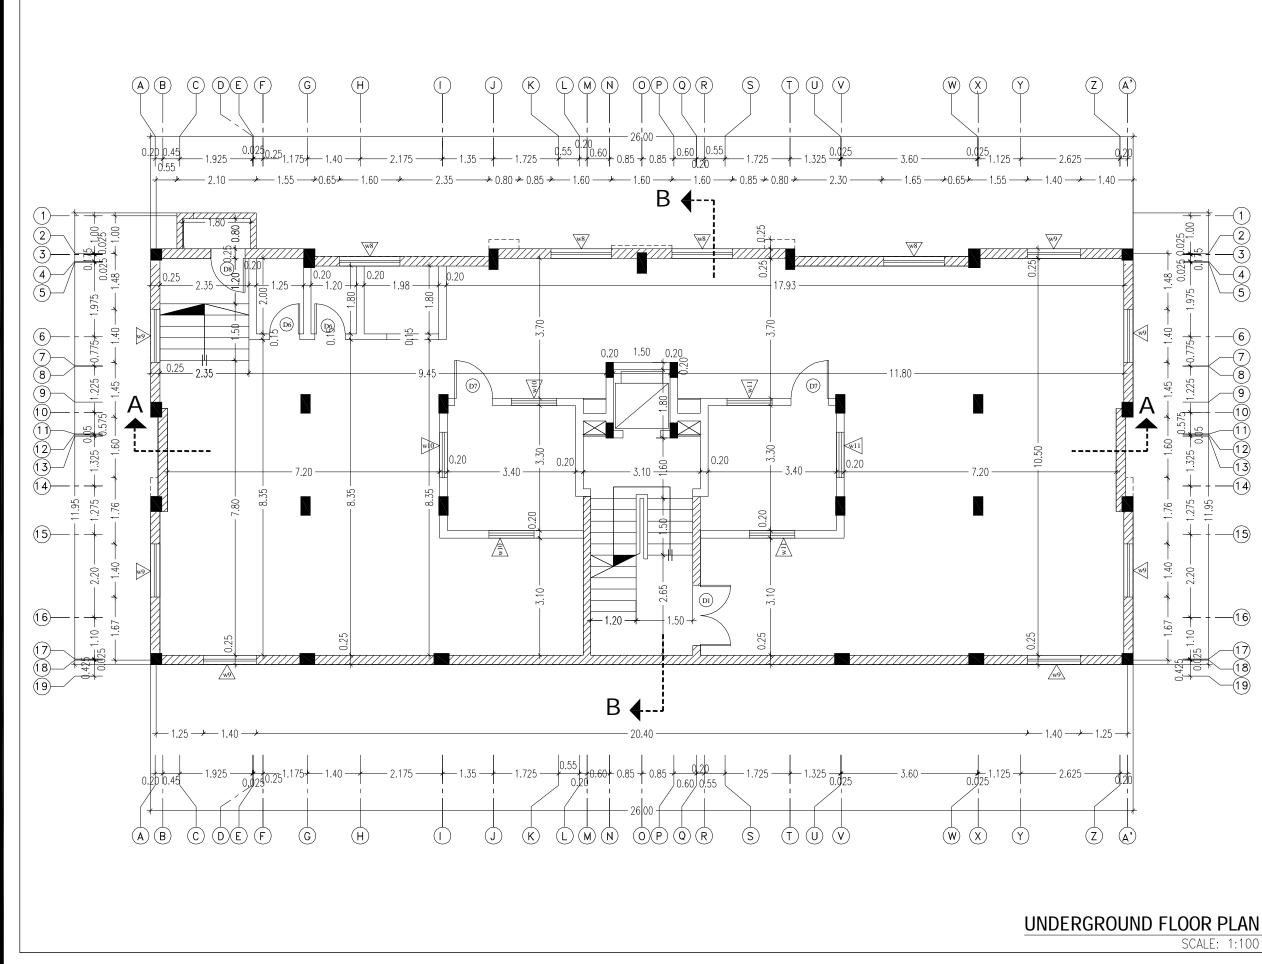


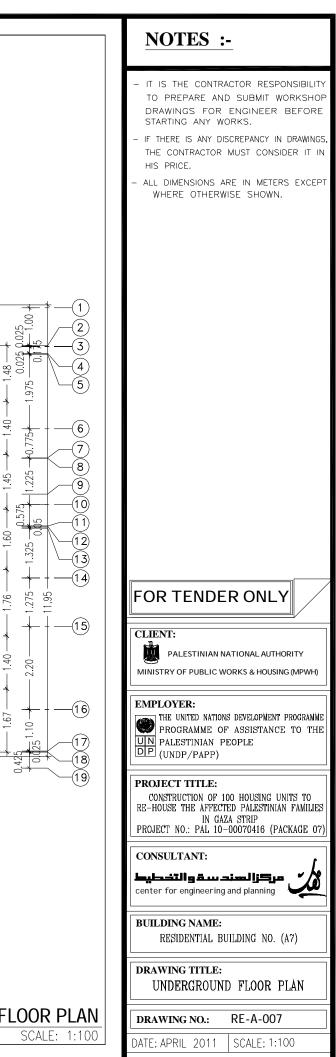


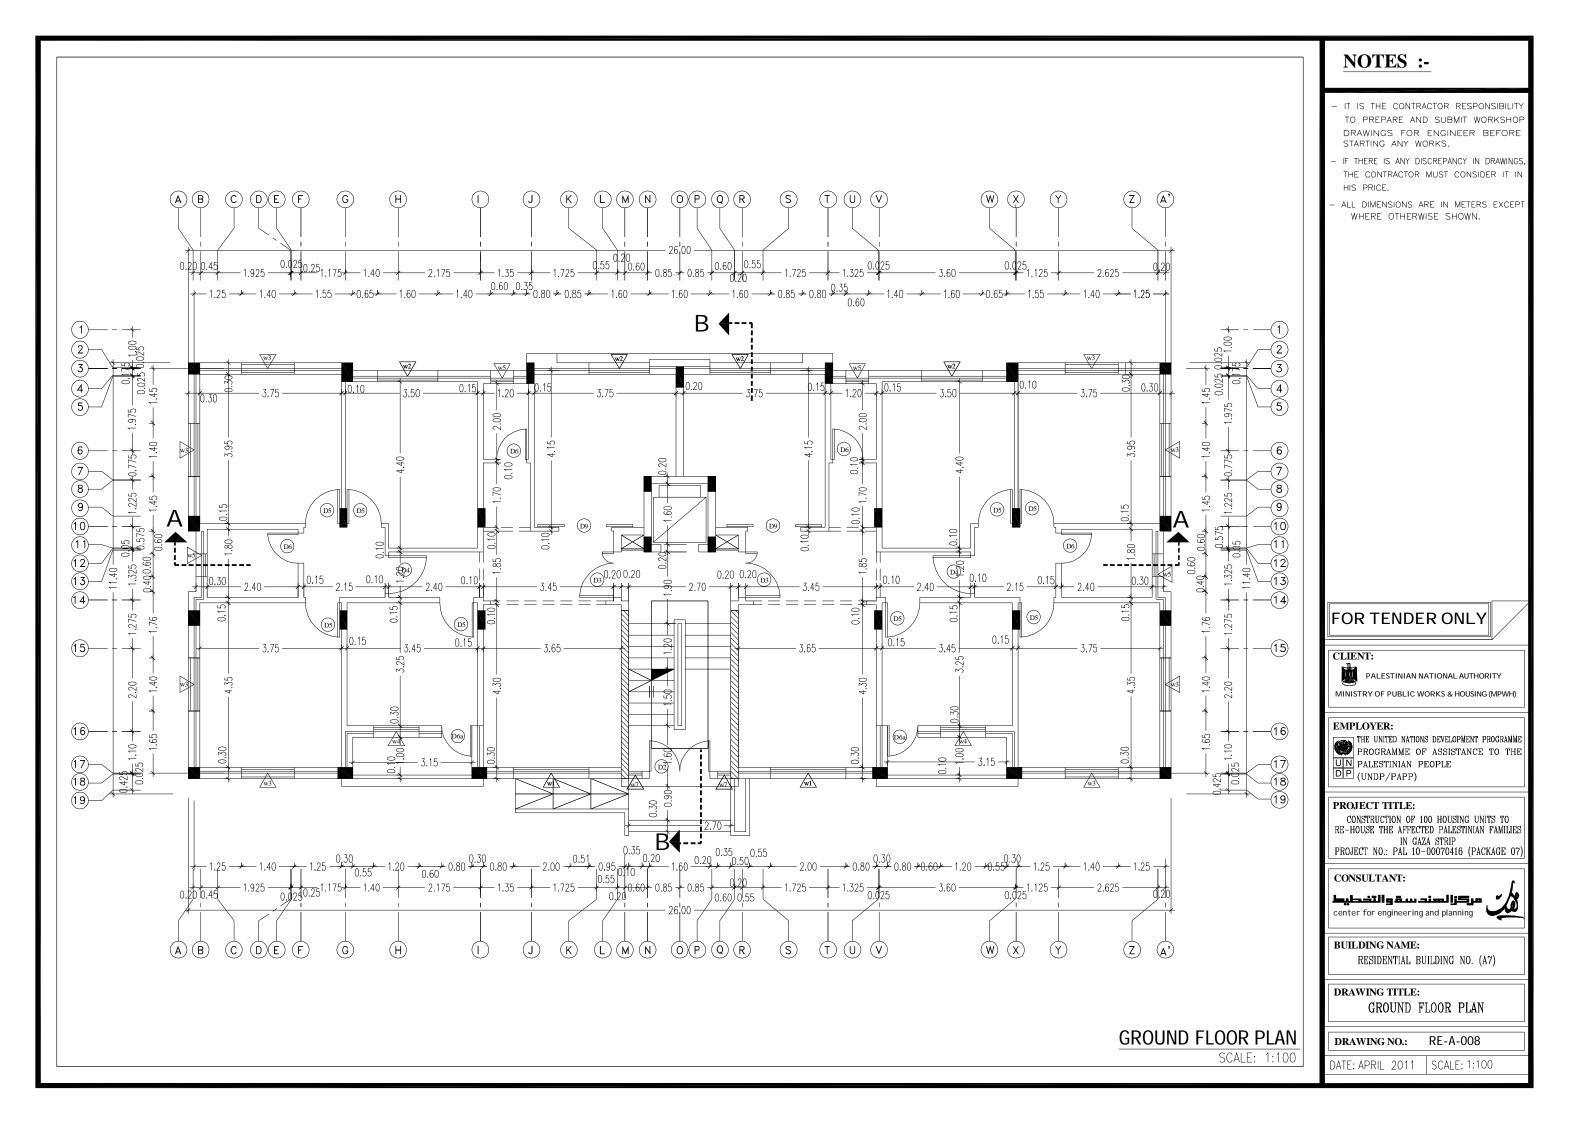

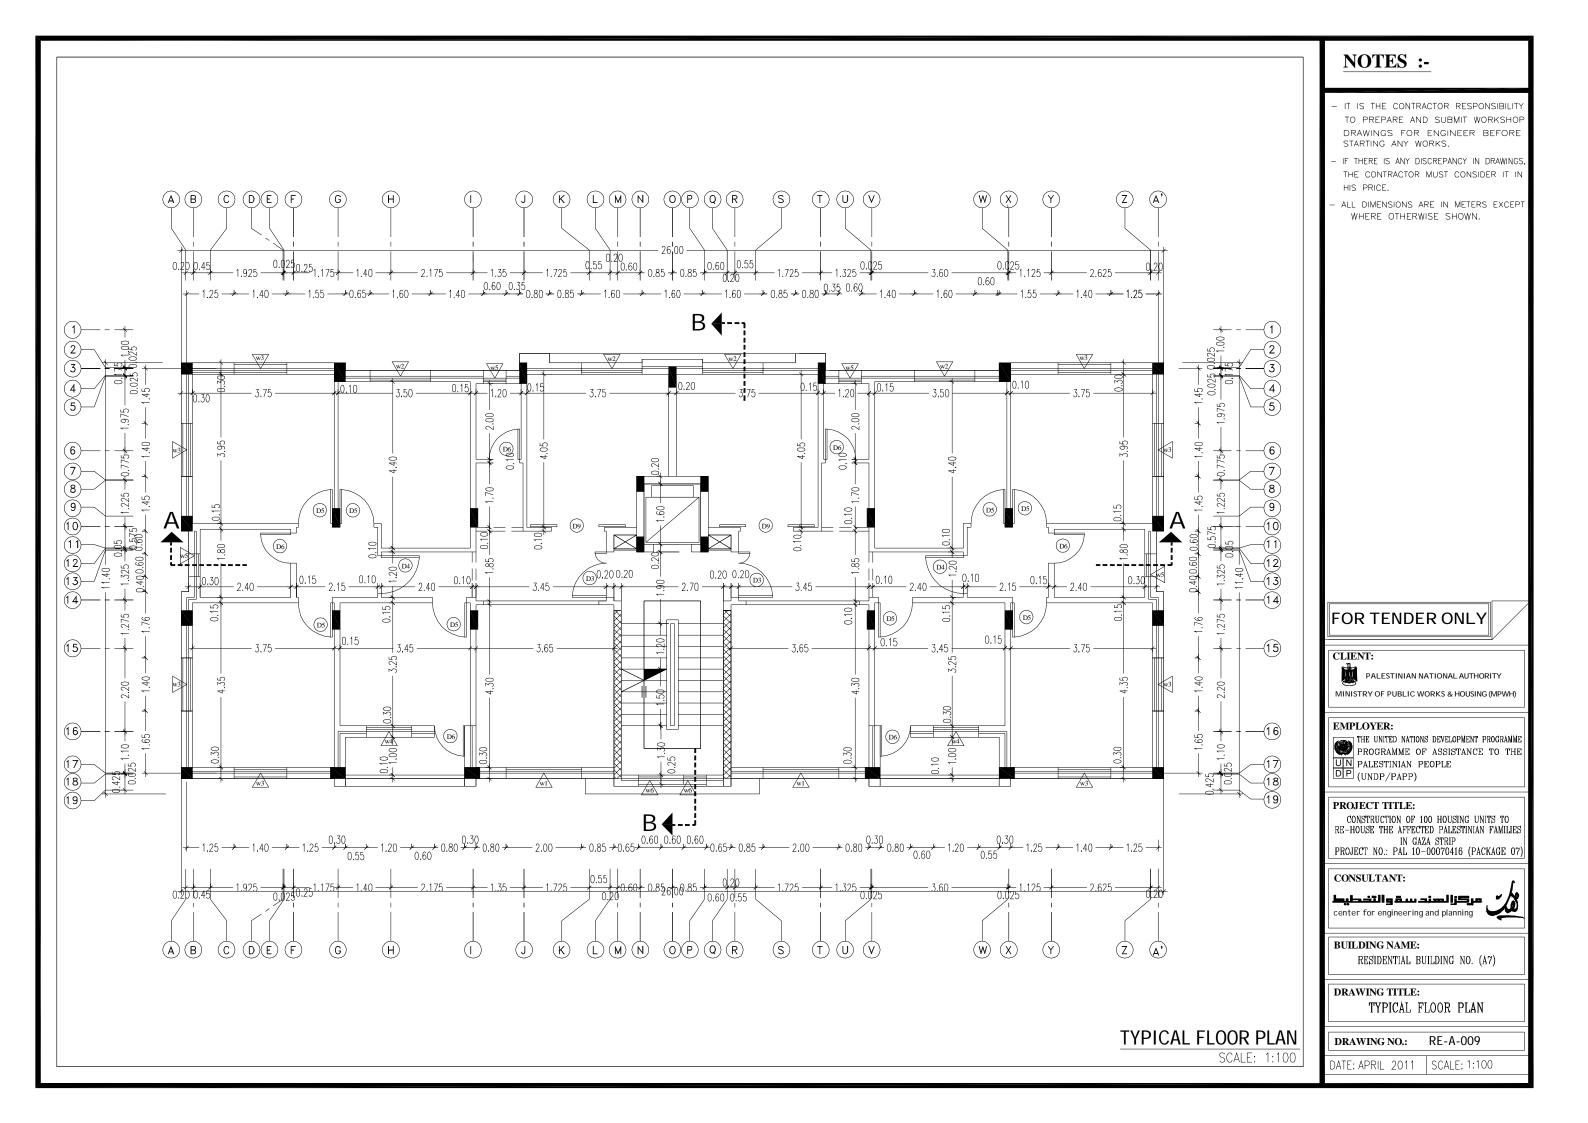


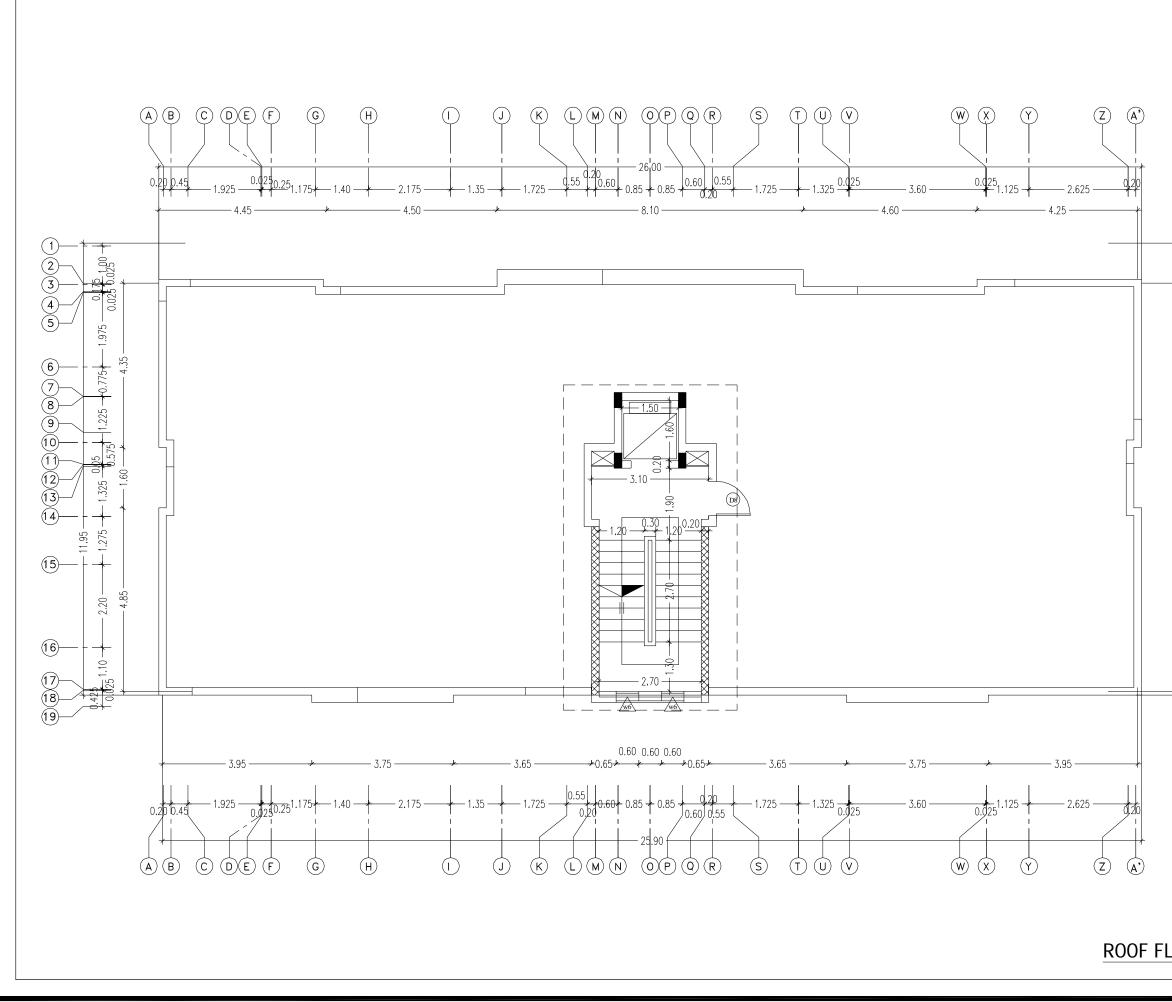


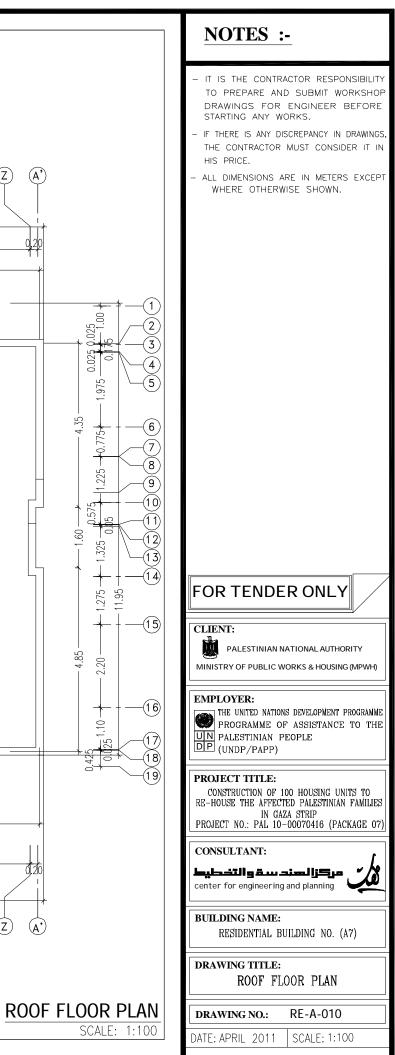


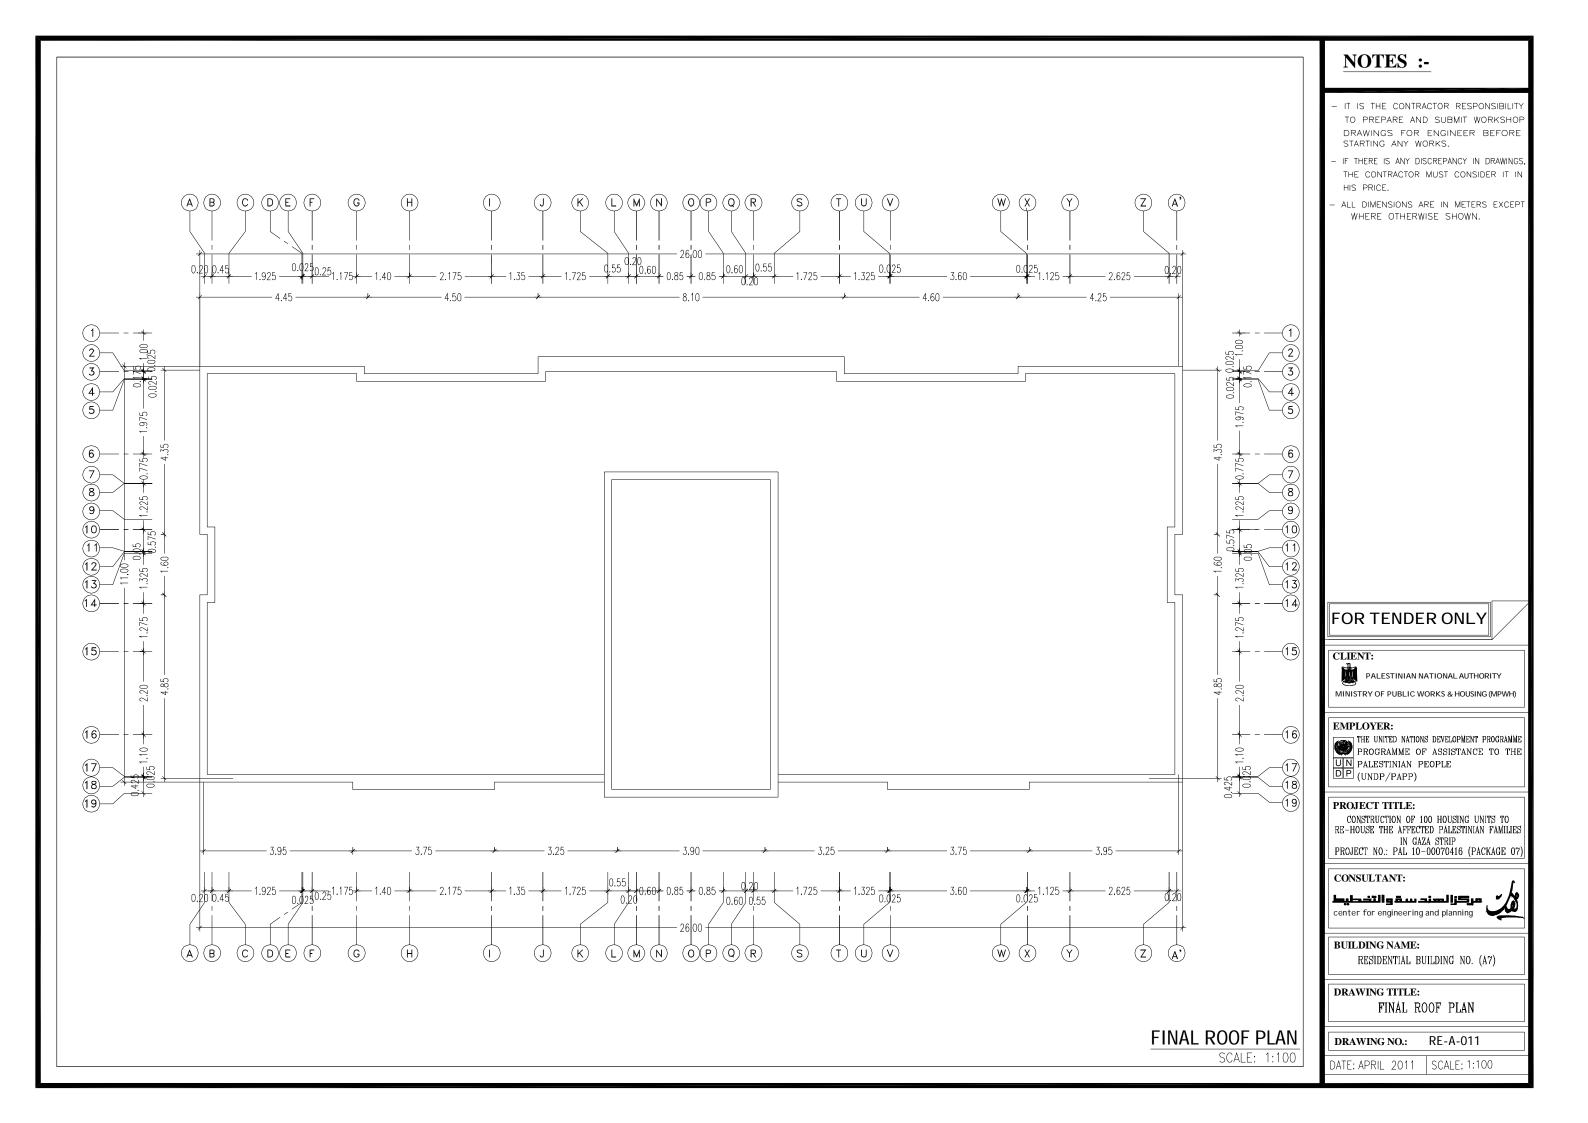



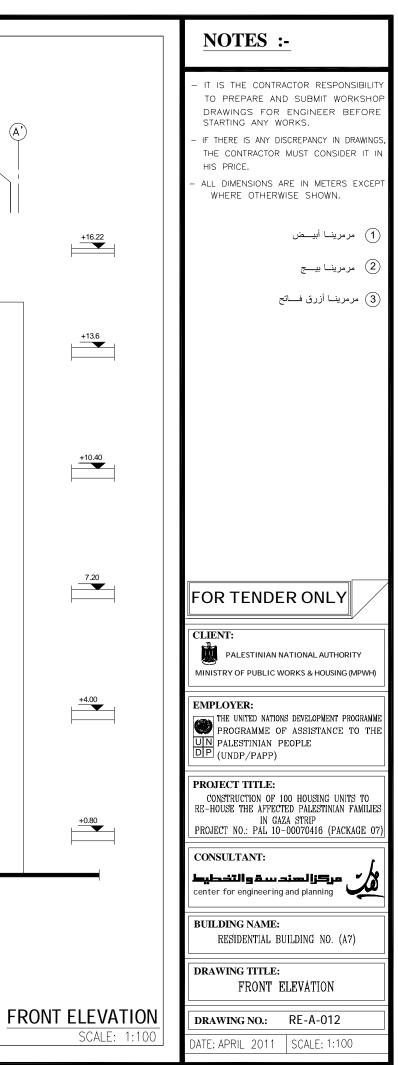


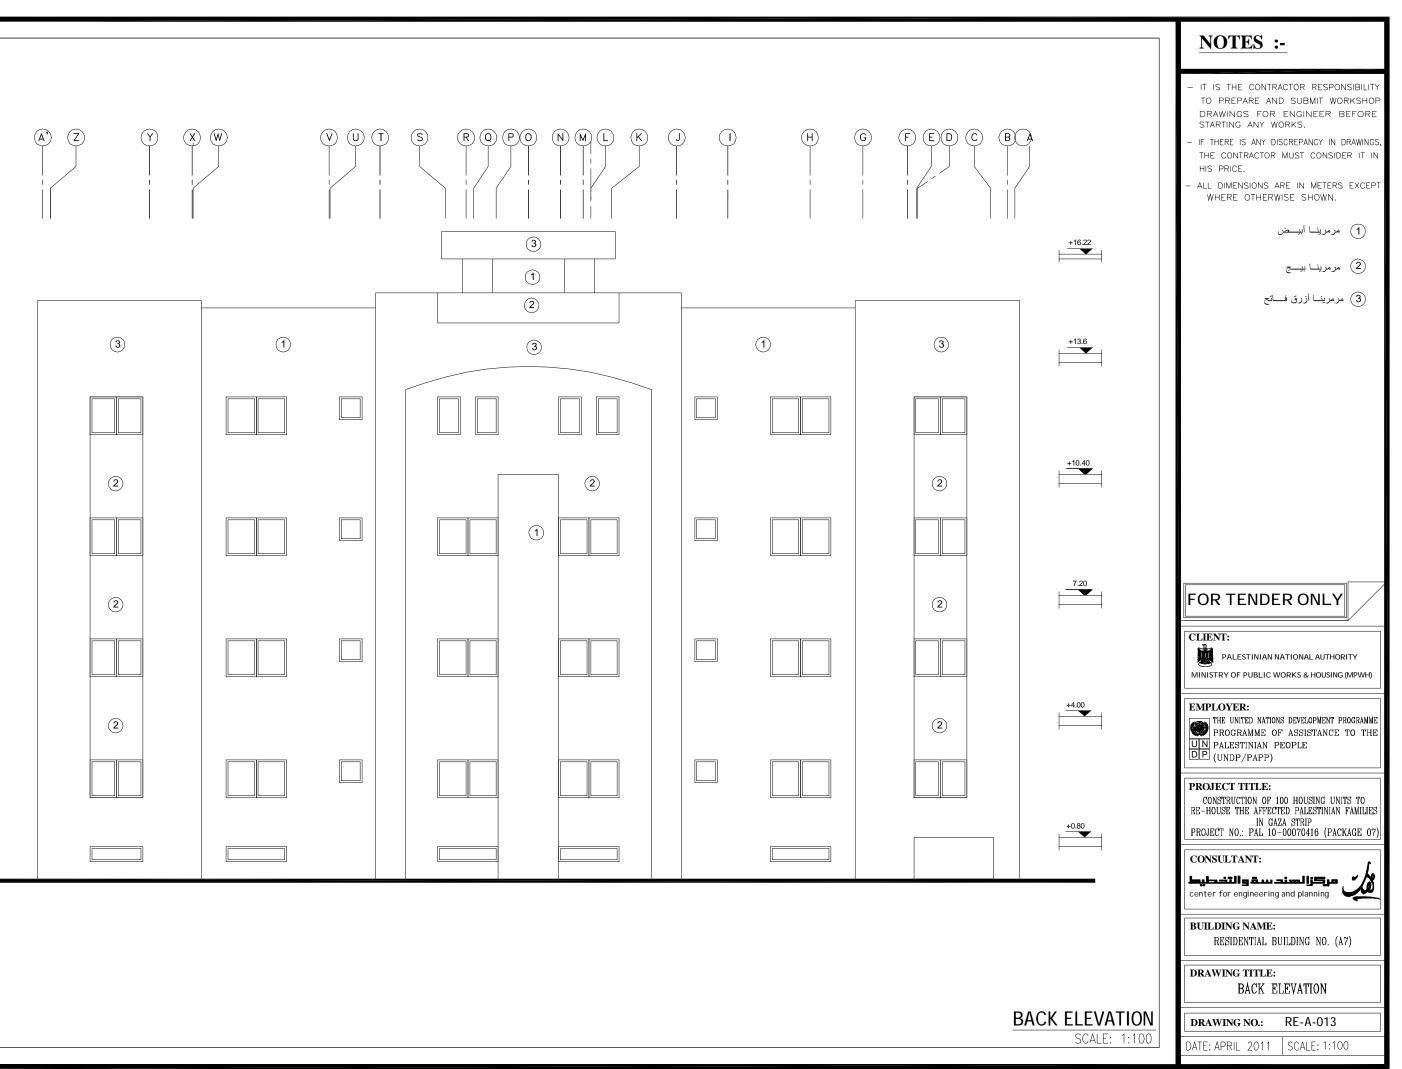


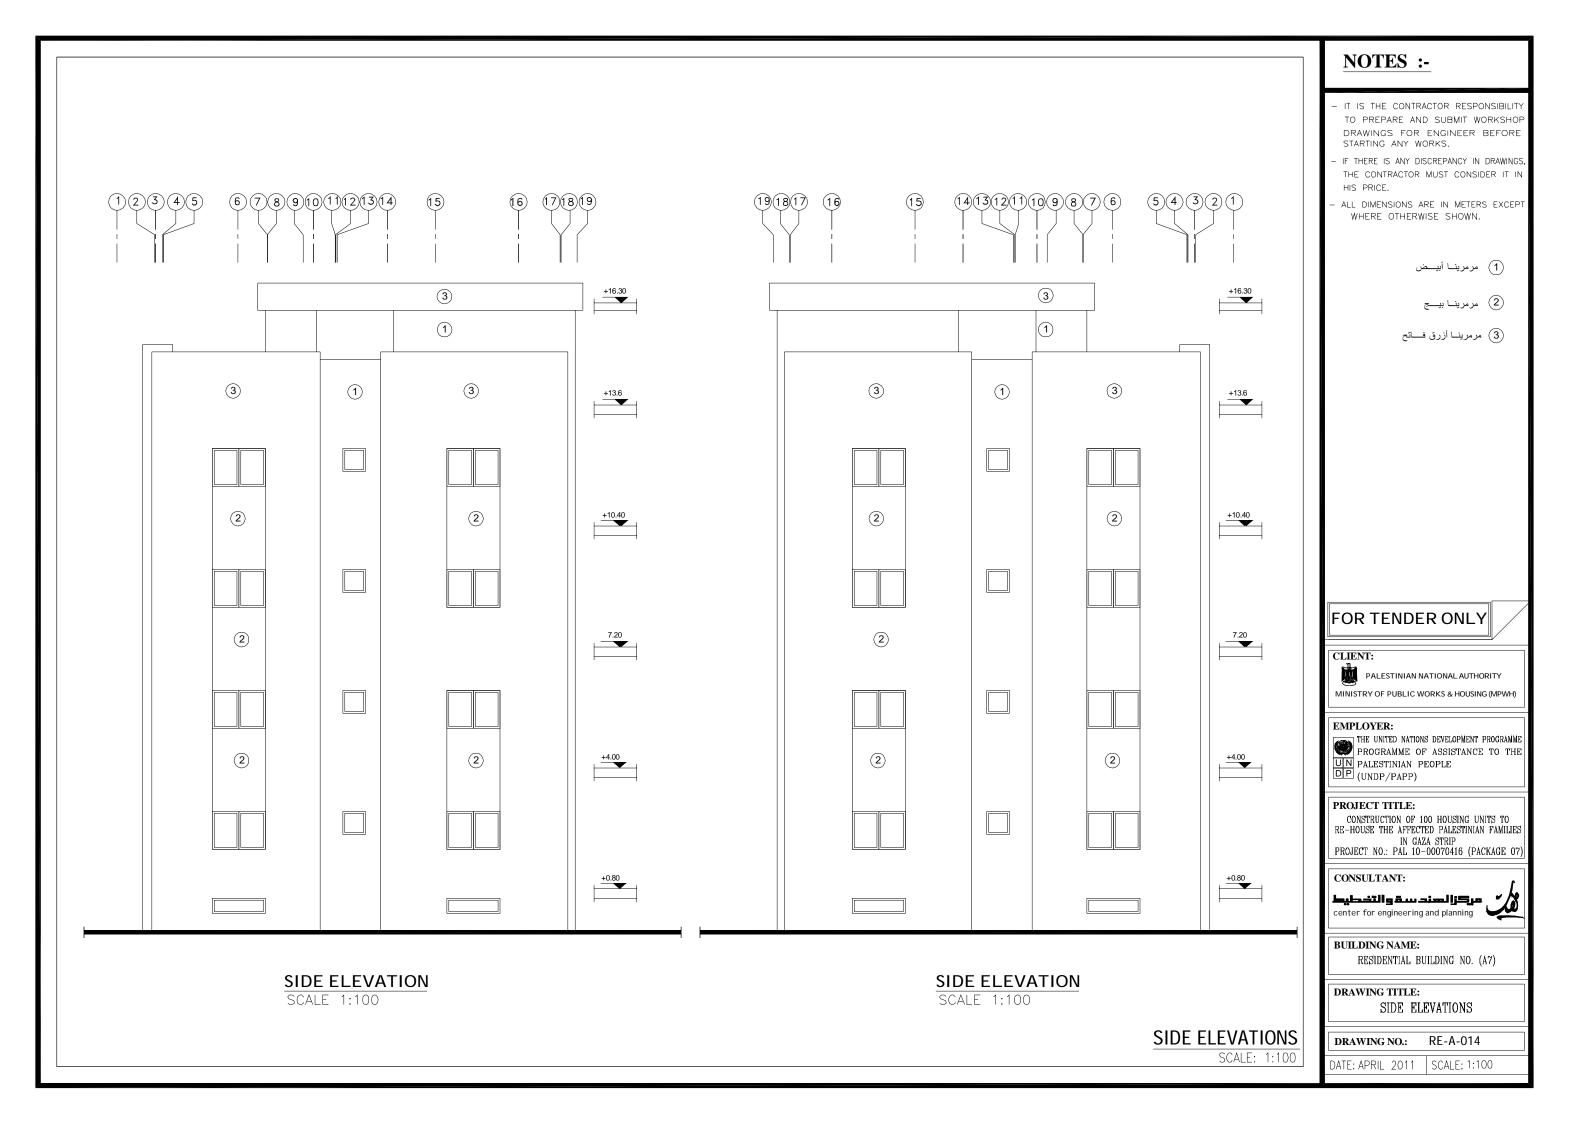




LONGITUDINAL SECTION A-A

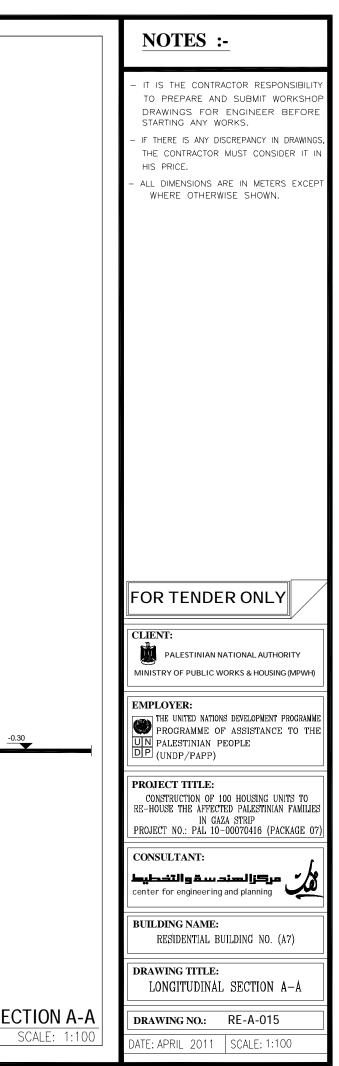

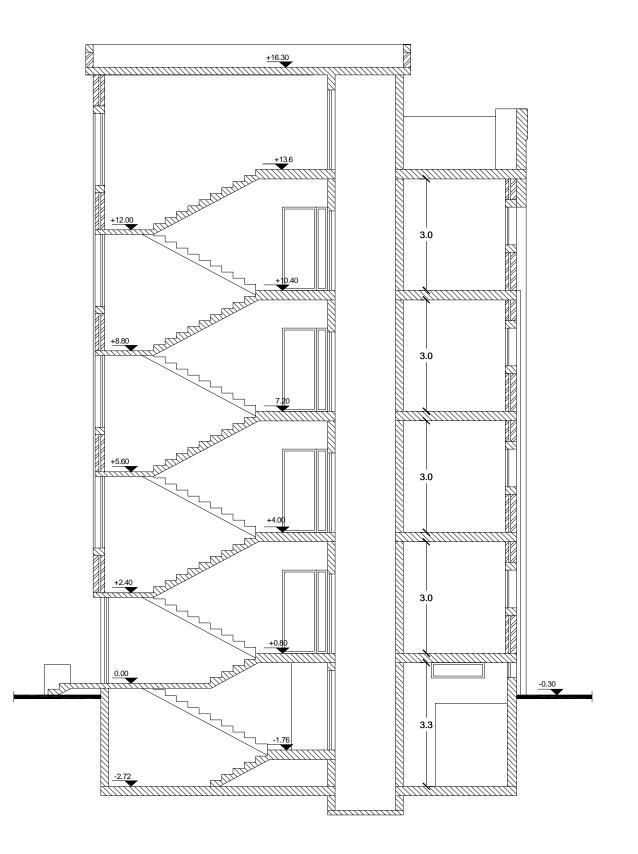

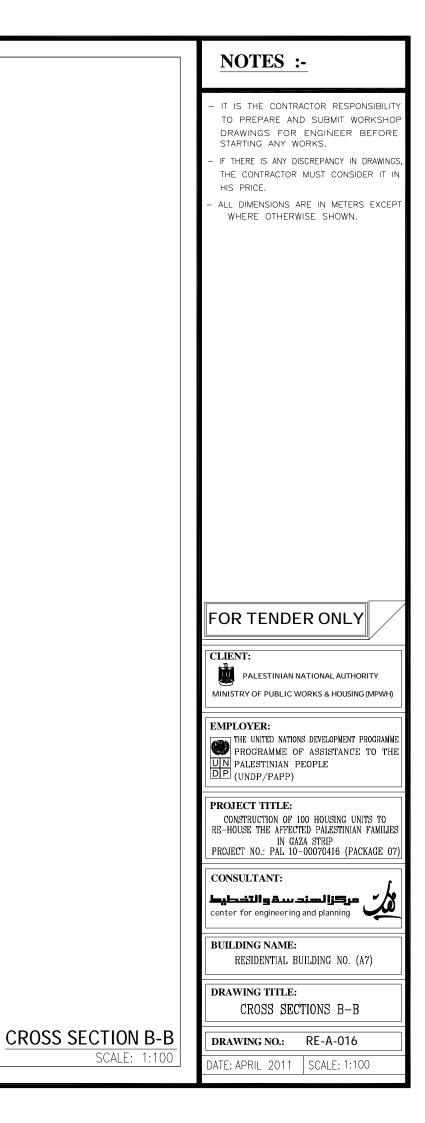

جدول الشبابيك الفتحة الانشاكية نظام الفتح رقم الشباك نظام الفتح المادة الفتحة الانشائية المادة رقم الشباك \$ \$ ġ W1 المئيرم سحاب W9 المنيوم سحا ب هباڪ اليدررم ≁____2.00-0-1-00-0 المنيرم W10 سحا ب W2 سحاب المنيرم **┼**___1.60──↓ ¢ ¢ W11 لوفر حديد W3 سحا ب المنيرم +1.20--1.40-¢ ¢ 1 W4 المنيوم سحا ب +1.20-+ € 0.60+ W5 قلاب المنيوم -1.90 W6 المنيرم قلاب شياڪ الدرجہ +0.60+ -1.42 W7 المنيرم قلاب شياڪ يجوار 0.40 مدغل العمارة -0.40 المنيوم سحا ب W8 -1.60 شياك اليدروم

جدول الابواب


نظام الفتح وعدد الضلف	المادة	الفتحة الانشائية		
لحفام المنع وعدة العيام		الارتفاع	العرض	
مفعلي ضلفتين	حديد	230	160	
مفصلي ضلفتين	حەيە	230	160	
مفصلي ضلفتين	خشب	230	120	
مفصلي ضلفة راحدة	خشب	230	100	
مفصلي ضلفة واحدة	خشب	230	90	
مفصلي ضلفة راحدة	خشب	230	80	
مفصلي ضلفة واحدة	ھەيھ	230	80	
مفصلي ضلفة راحدة	حديد	230	100	
مفصلي ضلفة واحدة	حەيە	230	90	
سحاب ضلفتين	خشب	230	140	

WINDOWS & DOO

		NOTES :-
		 IT IS THE CONTRACTOR RESPONSIBILITY TO PREPARE AND SUBMIT WORKSHOP DRAWINGS FOR ENGINEER BEFORE STARTING ANY WORKS. IF THERE IS ANY DISCREPANCY IN DRAWINGS, THE CONTRACTOR MUST CONSIDER IT IN HIS PRICE. ALL DIMENSIONS ARE IN METERS EXCEPT WHERE OTHERWISE SHOWN.
	رقم الباب	
-	D1	
	D2	
	D3	
	D4	
	D5	
	D6	
	D6a	FOR TENDER ONLY
_	D7	
	D8	CLIENT: PALESTINIAN NATIONAL AUTHORITY MUNISTRY OF FUELIC WORKS & HOUSING GOFWED
	D9	EMPLOYER:
		THE UNITED NATIONS DEVELOPMENT PROGRAMME PROGRAMME OF ASSISTANCE TO THE PALESTINIAN PEOPLE (UNDP/PAPP)
		PROJECT TITLE: CONSTRUCTION OF 100 HOUSING UNITS TO RE-HOUSE THE AFFECTED PALESTINIAN FAMILIES IN CAZA STRIP PROJECT NO.: PAL 10-00070416 (PACKAGE 07)
		CONSULTANT:
		BUILDING NAME: RESIDENTIAL BUILDING NO. (A7)
		DRAWING TITLE: WINDOWS & DOORS TABLE
	RS TABL	
	SCALE: 1:1	DATE: APRIL 2011 SCALE: 1:100

جدول التشطيبات الطبق التحت أرضي


الادراج	دورات الصياه	الغرف الميكانيكية	ا لمطبخ	المورعا ت	العيالة	ا لرقيم	نوع التشطيب	البند
					٠		بلاط کسر رخام	
	٩		۲			2	بلاط کرا میکا	₽)
						75)	رخام أو جرانيت	
٢		٩		•	٠		قصارة ودهان سوبركريل	A BAN
	٢		0			2	بلاط کرامیکا حتی السقف	
					٩	1	قصارة ودهان بوليسيد	" Alt of the second sec
		•		٠	•	1	کسر رځام	
•						2	رخام أو جرانيت	5.2 M

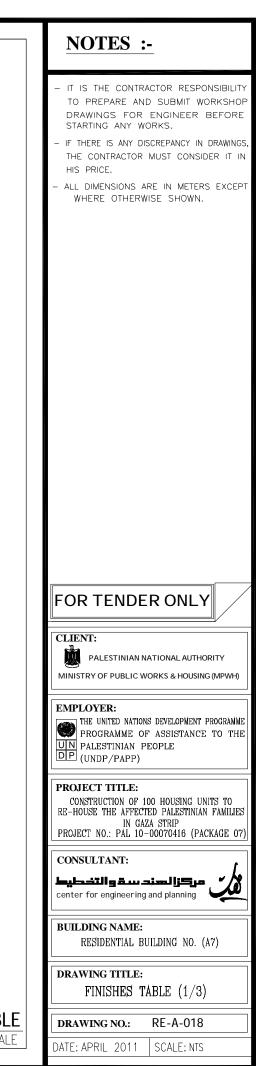

FINISHES TABLE SCALE: NOT TO SCALE

جدول التشطيبات الطابق الارضي


البلاكين	واج	دورات العياه	الحما ما ت	غرف النوم	الموزعات	المطابخ	صالات المعخل	غرف الصعيشة	غرف الفيوف	الرقم	نوع التشطيب	البنه
۲				٢	•		0	0	٩	1	بلاط کسر رخام	and the second s
			۲			۲				2	بلاط کرا میکا	*) ⁻
	•									3	رځام أو جرانيت	
	•			0	٩		٠	۲	۲	1	قصارة ودهان سوبرڪريل	A BAL
		۲	۲			٢				2	بلاط کرامیکا حتی السقف	
۲	۲	۲	۲	۲	•	۲	۲	٩	۲	1	قصارة ودهان بوليسيد	jane a
•	0			•	•		٢	•	٢	1	کسر رځام	
	۲									2	رځام أو جرانيت	y.
											هر مرینا	الحوائط الخارجية

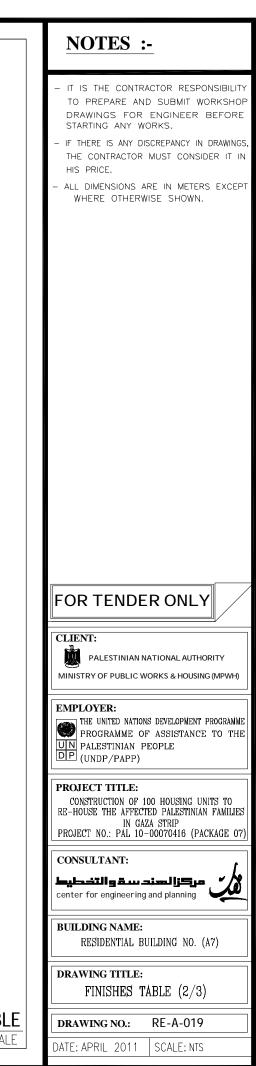


FINISHES TABLE SCALE: NOT TO SCALE


جدول التشطيبات
الطابق المتكرر


البلاكين	الادراج	دورات الصياه	الحمامات	غرف النوم	العوزعات	المطابخ	صالات المدخل	غرف الصعيشة	غرف الفيوف	الرقح	نوع التشطيب	البند
۲				•	٢		٩	۲	٢	1	بلاط کسر رخام	and a start of the
		0				۲				2	بلاط کرامیکا	e ar
	۲									3	رځام أو جرانيت	
۲	۲			۲	۲		0	۲	۲	1	قصارة ودهان سوبركريل	12 July
		0				۲				2	بلاط کرامیکا حتی السقف	
۲	٠	•		•	٠	۲	•	۲	٠	1	قصارة ودهان بوليسيد	. Beer B
۲	۲			۲	۲		•	۲	۲	1	کسر رځام	
										2	رځام أو جرانيت	y.
											مرمرینا	ا لحوا ئط ا لخا رجية

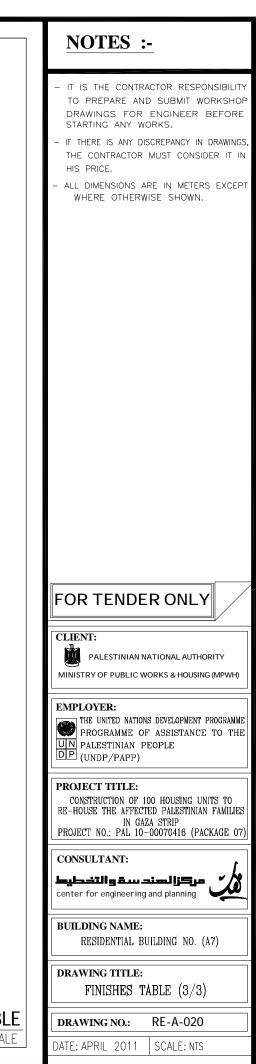

FINISHES TABLE SCALE: NOT TO SCALE

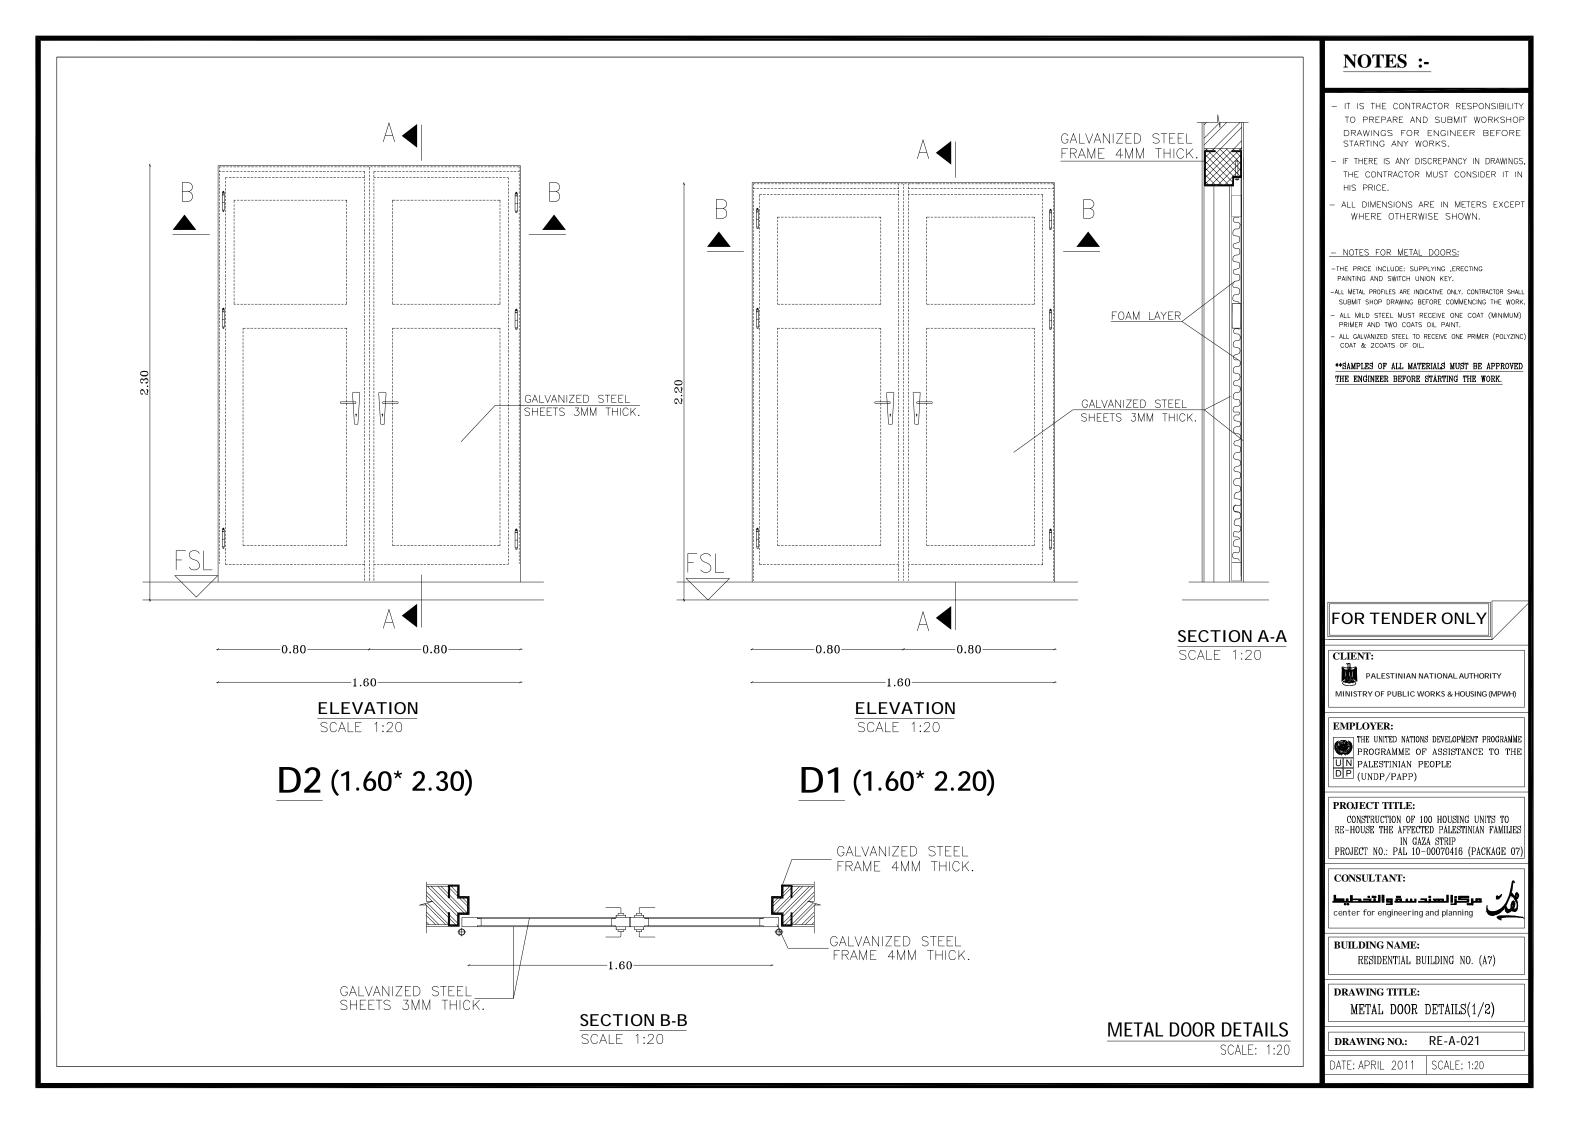


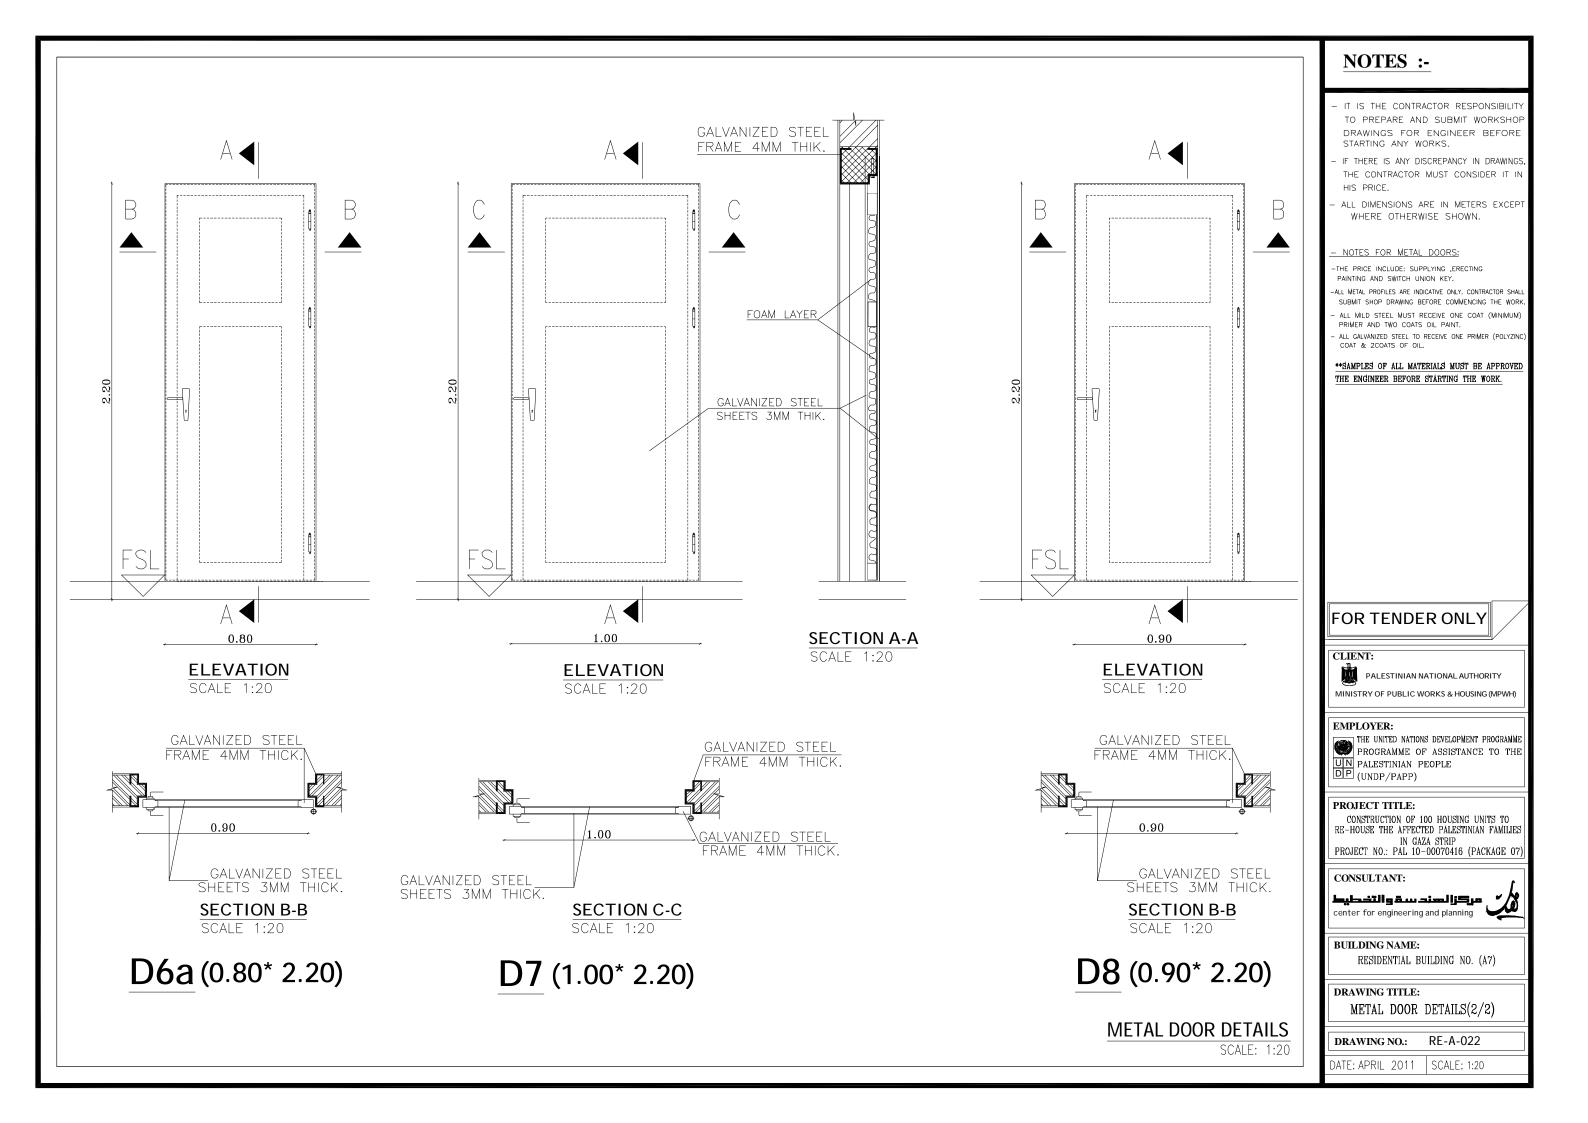

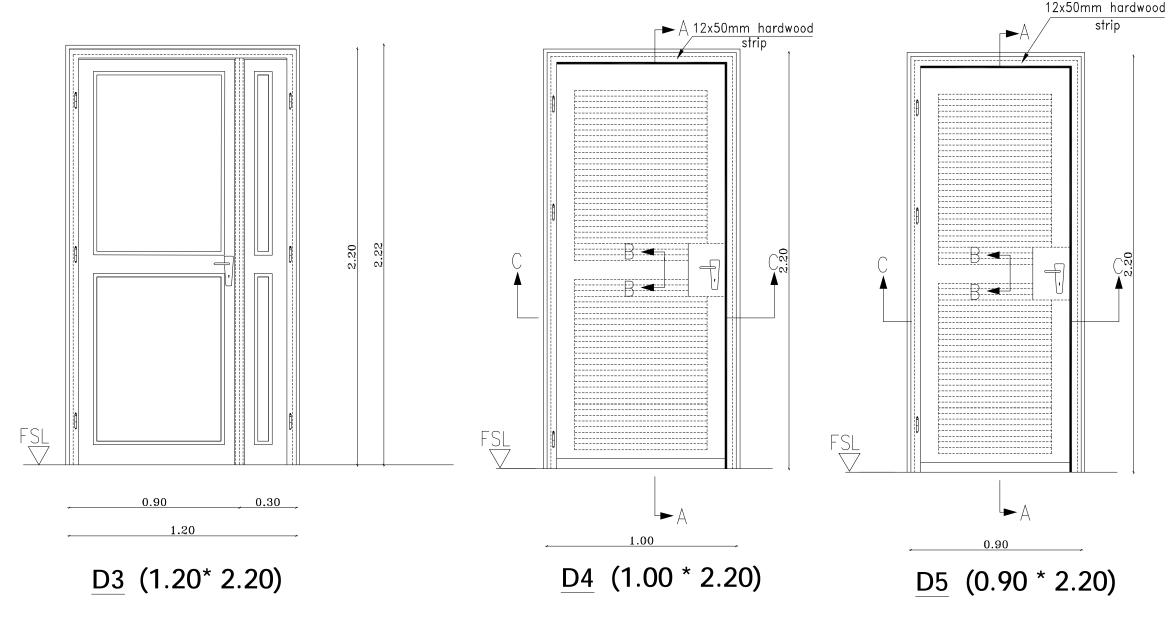


WOODEN DOOR DETAILS

NOTES :-- IT IS THE CONTRACTOR RESPONSIBILITY TO PREPARE AND SUBMIT WORKSHOP DRAWINGS FOR ENGINEER BEFORE STARTING ANY WORKS. IF THERE IS ANY DISCREPANCY IN DRAWINGS, THE CONTRACTOR MUST CONSIDER IT IN HIS PRICE. ALL DIMENSIONS ARE IN METERS EXCEPT WHERE OTHERWISE SHOWN. - NOTES FOR WOODEN DOORS: ALL TIMBER TO BE SWEDISH CLASS A UNLESS OTHERWISE SHOWN, ARCHITRAVES AND COVER MOULDS TO BE FIXED TO DOOR FRAMES WITH PANEL PINS. 3 HINGES WHERE NECESSARY BUTT HINGES PER DOOR LEAF. WOODEN FRAMES: FRAMES ABUTTING BLOCKWORK TO BE BUILT IN WITH MILD STEEL CRAMPS AS PER SPECIFICATION & DRAWINGS. FRAMES ABUTTING CONCRETE TO BE DRILLED COUNTERSUNK AND FIXED WITH EXPANSION BOLTS 3 PER JAMB. DOORSTOPS: PROJECTING WALL MOUNTED TYPE10CM LONG WOODEN DOORS (FIRST CLASS) WOOD AND 4MM THICK PLYWOOD. ALL TIMBER WILL BE PAINTED ACCORDING TO THE SPECIFICATIONS. THE DOOR LOCK IS "SWITCH UNION" (BEST QUALITY). ್ಗ ನಂ **SAMPLES OF ALL MATERIALS MUST BE APPROVED in THE ENGINEER BEFORE STARTING THE WORK. FOR TENDER ONLY CLIENT: PALESTINIAN NATIONAL AUTHORITY MINISTRY OF PUBLIC WORKS & HOUSING (MPWH) **EMPLOYER:** PROGRAMME OF ASSISTANCE TO THE UN PALESTINIAN PEOPLE DP (UNDP/PAPP) PROJECT TITLE: CONSTRUCTION OF 100 HOUSING UNITS TO RE-HOUSE THE AFFECTED PALESTINIAN FAMILIES IN GAZA STRIP PROJECT NO .: PAL 10-00070416 (PACKAGE 07) CONSULTANT: مركزالهند سقوالتخطيط center for engineering and planning **BUILDING NAME:** RESIDENTIAL BUILDING NO. (A7) DRAWING TITLE: WOODEN DOOR DETAILS (1/3)DRAWING NO .: RE-A-023 SCALE: 1:20 DATE: APRIL 2011 SCALE: 1:20

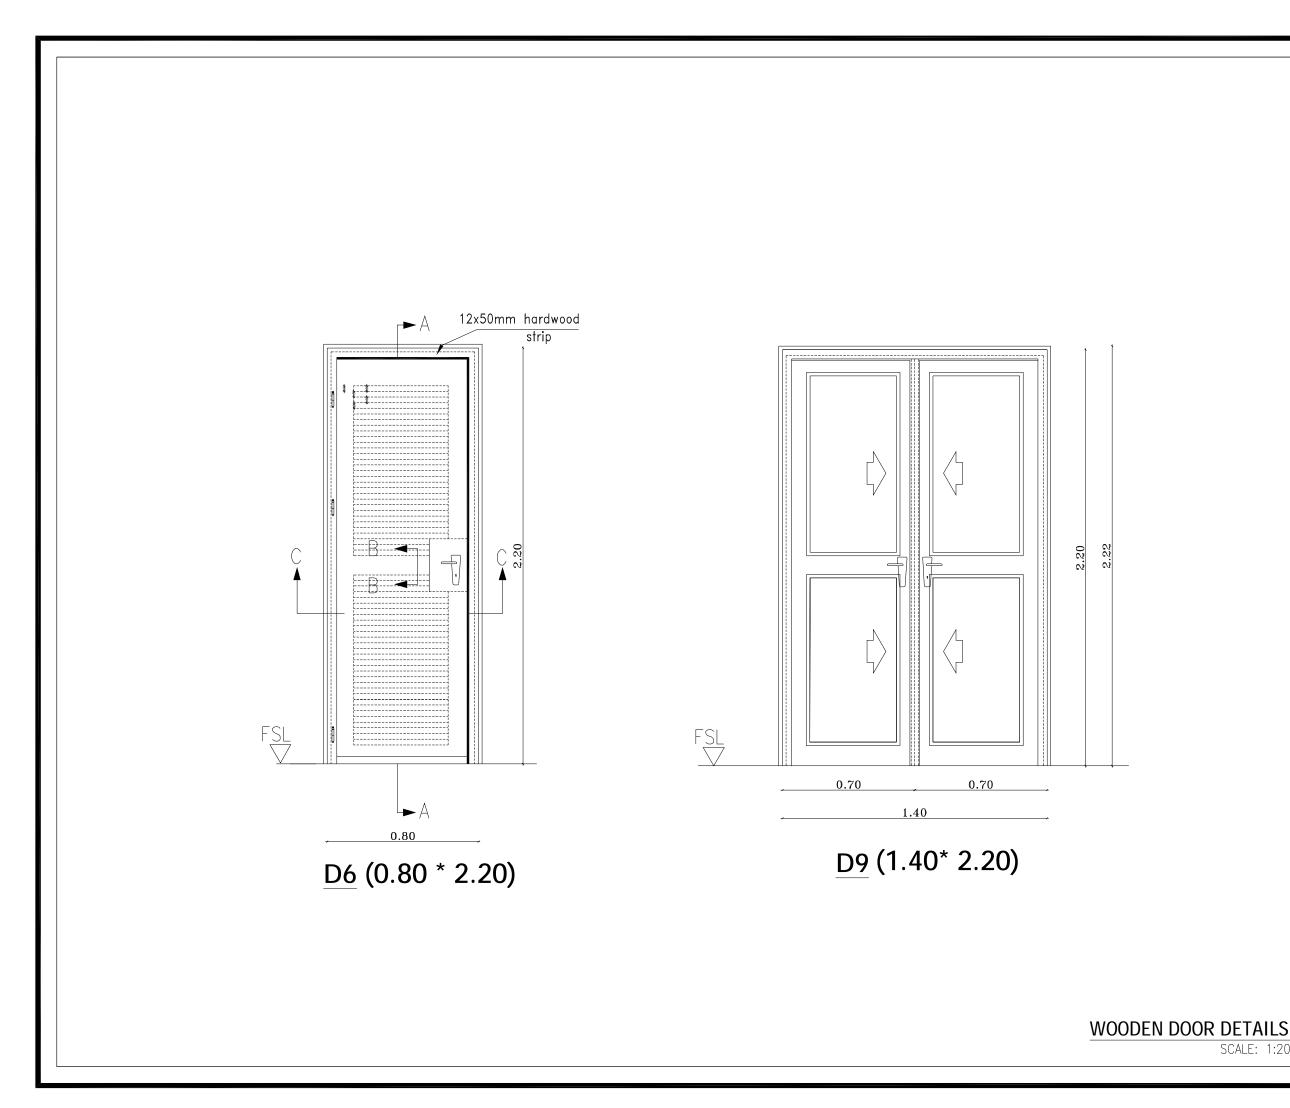



	NOTES :-
	 IT IS THE CONTRACTOR RESPONSIBILITY TO PREPARE AND SUBMIT WORKSHOP DRAWINGS FOR ENGINEER BEFORE STARTING ANY WORKS. IF THERE IS ANY DISCREPANCY IN DRAWINGS, THE CONTRACTOR MUST CONSIDER IT IN HIS PRICE. ALL DIMENSIONS ARE IN METERS EXCEPT WHERE OTHERWISE SHOWN.
	 NOTES FOR WOODEN DOORS: ALL TIMBER TO BE SWEDISH CLASS A UNLESS OTHERWISE SHOWN. ARCHITRAVES AND COVER MOULDS TO BE FIXED TO DOOR FRAMES WITH PANEL PINS. 3 HINGES WHERE NECESSARY BUTT HINGES PER DOOR LEAF. WOODEN FRAMES: FRAMES ABUTTING BLOCKWORK TO BE BUILT IN WITH MILD STEEL CRAMPS AS PER SPECIFICATION & DRAWINGS. FRAMES ABUTTING CONCRETE TO BE DRILLED, COUNTERSUNK AND FIXED WITH EXPANSION BOLTS, 3 PER JAMB. DOORSTOPS: PROJECTING WALL MOUNTED TYPE10CM LONG. WOODEN DOORS (FIRST CLASS) WOOD AND 4MM THICK PLYWOOD. ALL TIMBER WILL BE PAINTED ACCORDING TO THE SPECIFICATIONS. THE DOOR LOCK IS "SWITCH UNION" (BEST QUALITY). **SAMPLES OF ALL MATERIALS MUST BE APPROVED THE ENGINEER BEFORE STARTING THE WORK.
	FOR TENDER ONLY
	EMPLOYER: THE UNITED NATIONS DEVELOPMENT PROGRAMME PROGRAMME OF ASSISTANCE TO THE PALESTINIAN PEOPLE (UNDP/PAPP)
	PROJECT TITLE: CONSTRUCTION OF 100 HOUSING UNITS TO RE-HOUSE THE AFFECTED PALESTINIAN FAMILIES IN GAZA STRIP PROJECT NO.: PAL 10-00070416 (PACKAGE 07) CONSULTANT: Labeling center for engineering and planning
	BUILDING NAME: RESIDENTIAL BUILDING NO. (A7)
ς	DRAWING TITLE: WOODEN DOOR DETAILS (2/3)
20	DRAWING NO.: RE-A-024 DATE: APRIL 2011 SCALE: 1:20

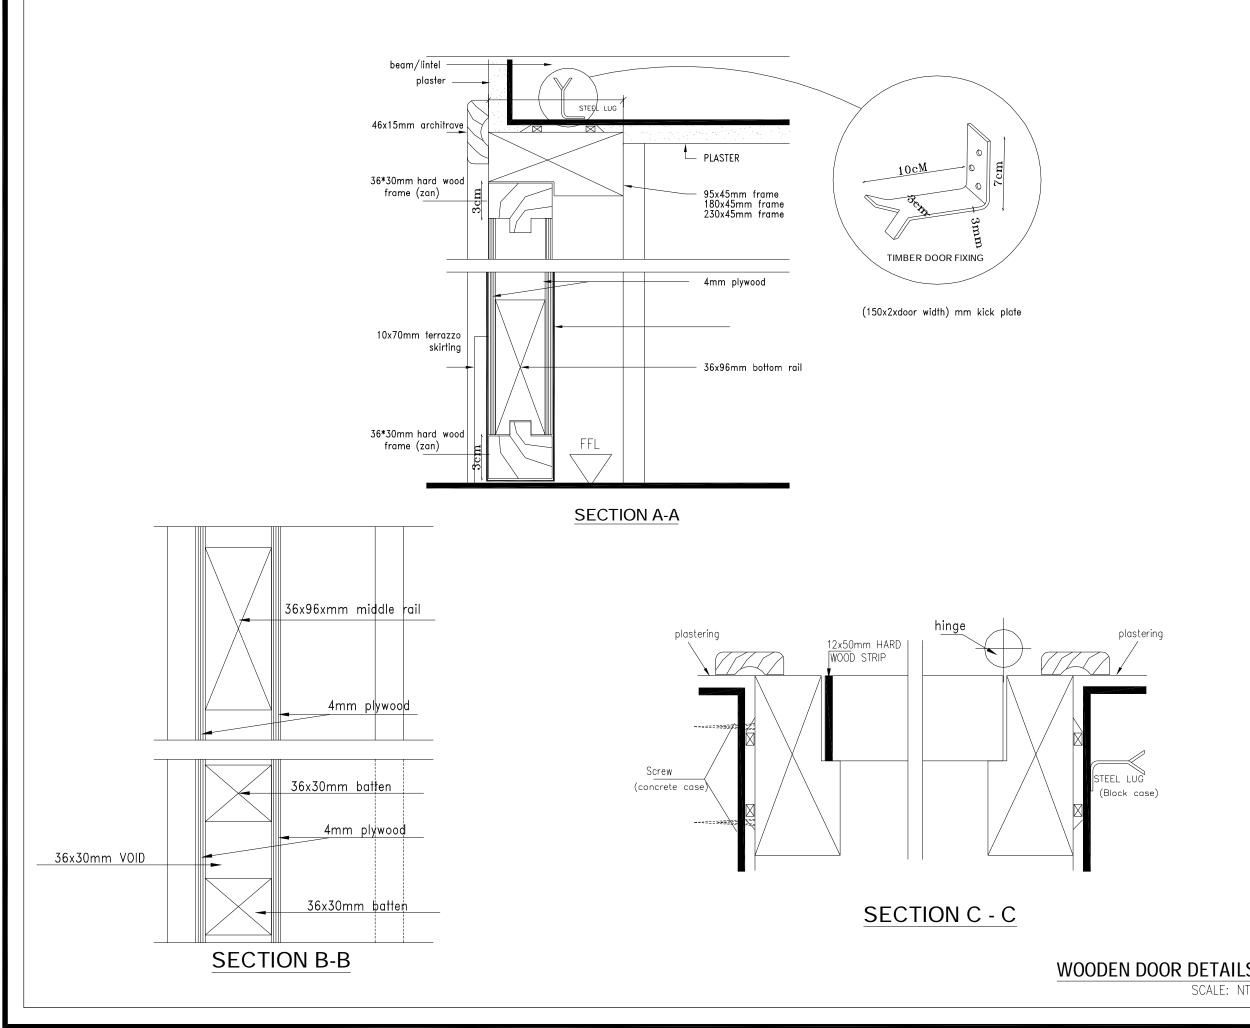



	<u>NOTES :-</u>
	 IT IS THE CONTRACTOR RESPONSIBILITY TO PREPARE AND SUBMIT WORKSHOP DRAWINGS FOR ENGINEER BEFORE STARTING ANY WORKS. IF THERE IS ANY DISCREPANCY IN DRAWINGS, THE CONTRACTOR MUST CONSIDER IT IN HIS PRICE. ALL DIMENSIONS ARE IN METERS EXCEPT WHERE OTHERWISE SHOWN.
	 NOTES FOR WOODEN DOORS; ALL TIMBER TO BE SWEDISH CLASS A UNLESS OTHERWISE SHOWN. ARCHITRAVES AND COVER MOULDS TO BE FIXED TO DOOR FRAMES WITH PANEL PINS. 3 HINGES WHERE NECESSARY BUTT HINGES PER DOOR LEAF. WOODEN FRAMES: FRAMES ABUTTING BLOCKWORK TO BE BUILT IN WITH MILD STEEL CRAMPS AS PER SPECIFICATION & DRAWINGS. FRAMES ABUTTING CONCRETE TO BE DRILLED, COUNTERSUNK AND FIXED WITH EXPANSION BOLTS, 3 PER JAMB. DOORSTOPS: PROJECTING WALL MOUNTED TYPE10CM LONG. WOODEN DOORS (FIRST CLASS) WOOD AND 4MM THICK PLYWOOD. ALL TIMBER WILL BE PAINTED ACCORDING TO THE SPECIFICATIONS. THE DOOR LOCK IS "SWITCH UNION" (BEST QUALITY). **SAMPLES OF ALL MATERIALS MUST BE APPROVED THE ENGINEER BEFORE STARTING THE WORK.
	FOR TENDER ONLY
	EMPLOYER: THE UNITED NATIONS DEVELOPMENT PROGRAMME PROGRAMME OF ASSISTANCE TO THE UN PALESTINIAN PEOPLE (UNDP/PAPP) PROJECT TITLE: CONSTRUCTION OF 100 HOUSING UNITS TO RE-HOUSE THE AFFECTED PALESTINIAN FAMILIES IN GAZA STRIP
	PROJECT NO.: PAL 10-00070416 (PACKAGE 07) CONSULTANT: Center for engineering and planning BUILDING NAME:
s	RESIDENTIAL BUILDING NO. (A7) DRAWING TITLE: WOODEN DOOR DETAILS (3/3)
TS	DRAWING NO.: RE-A-025 DATE: APRIL 2011 SCALE: NTS


SCALE: NT

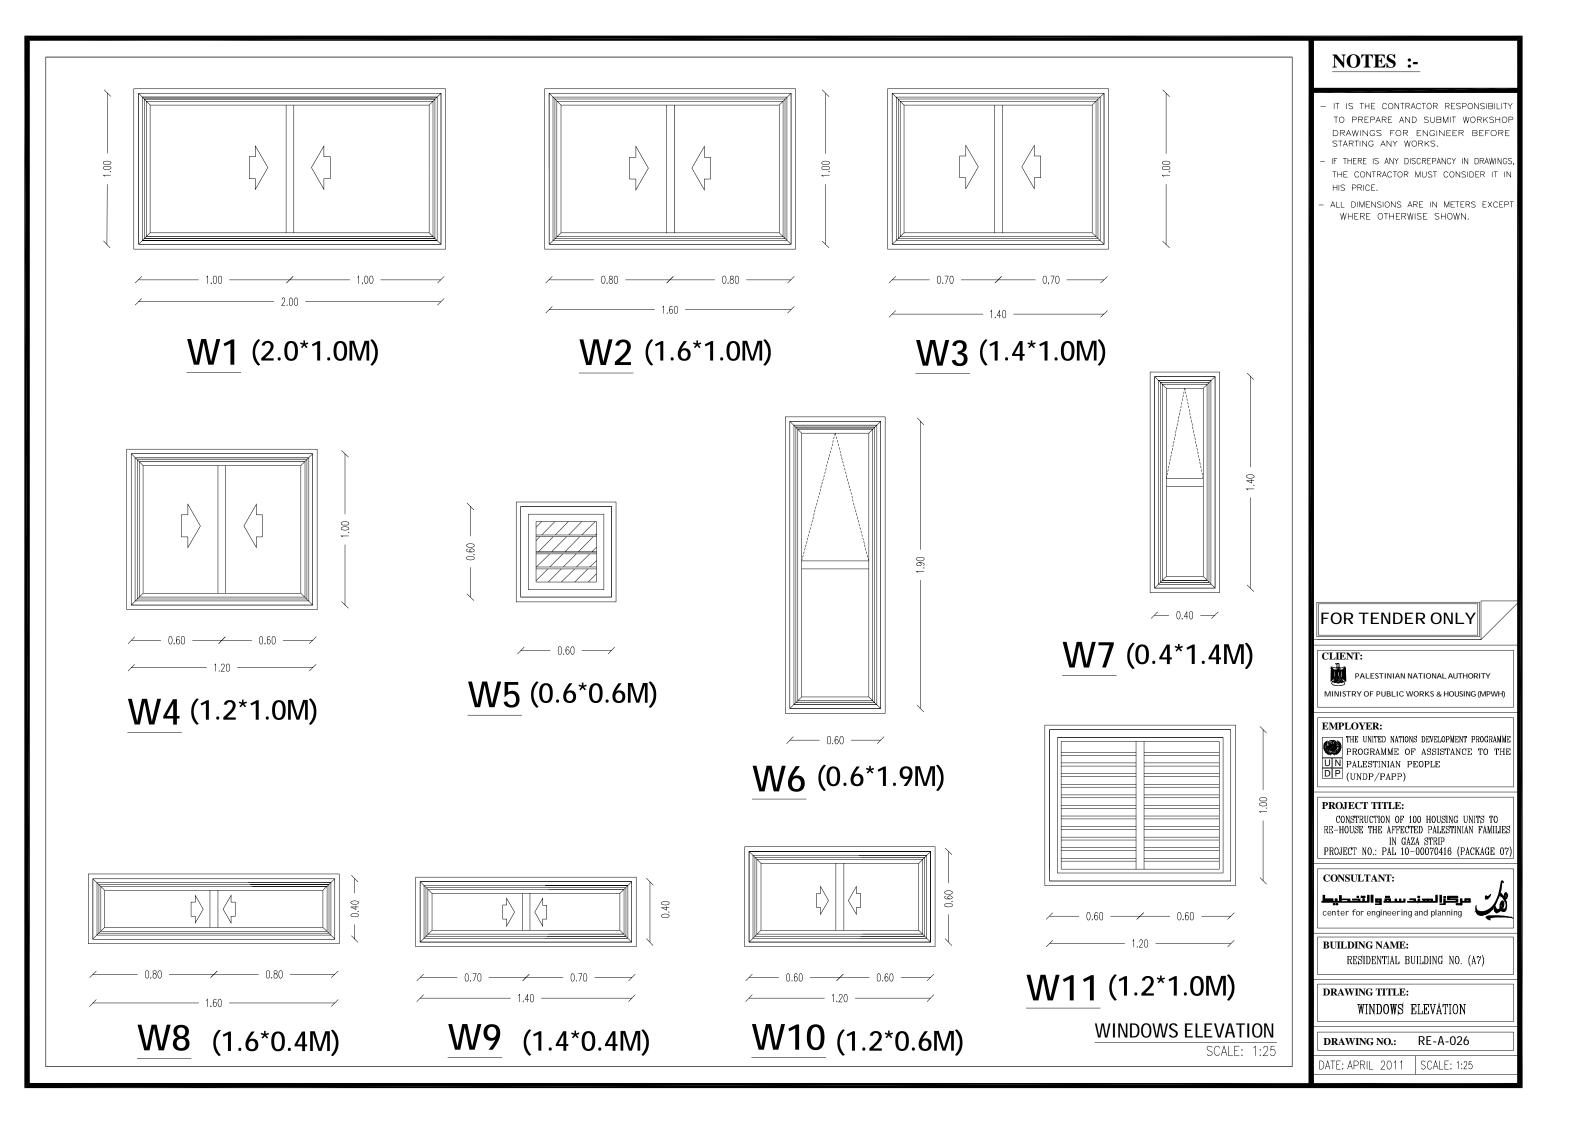

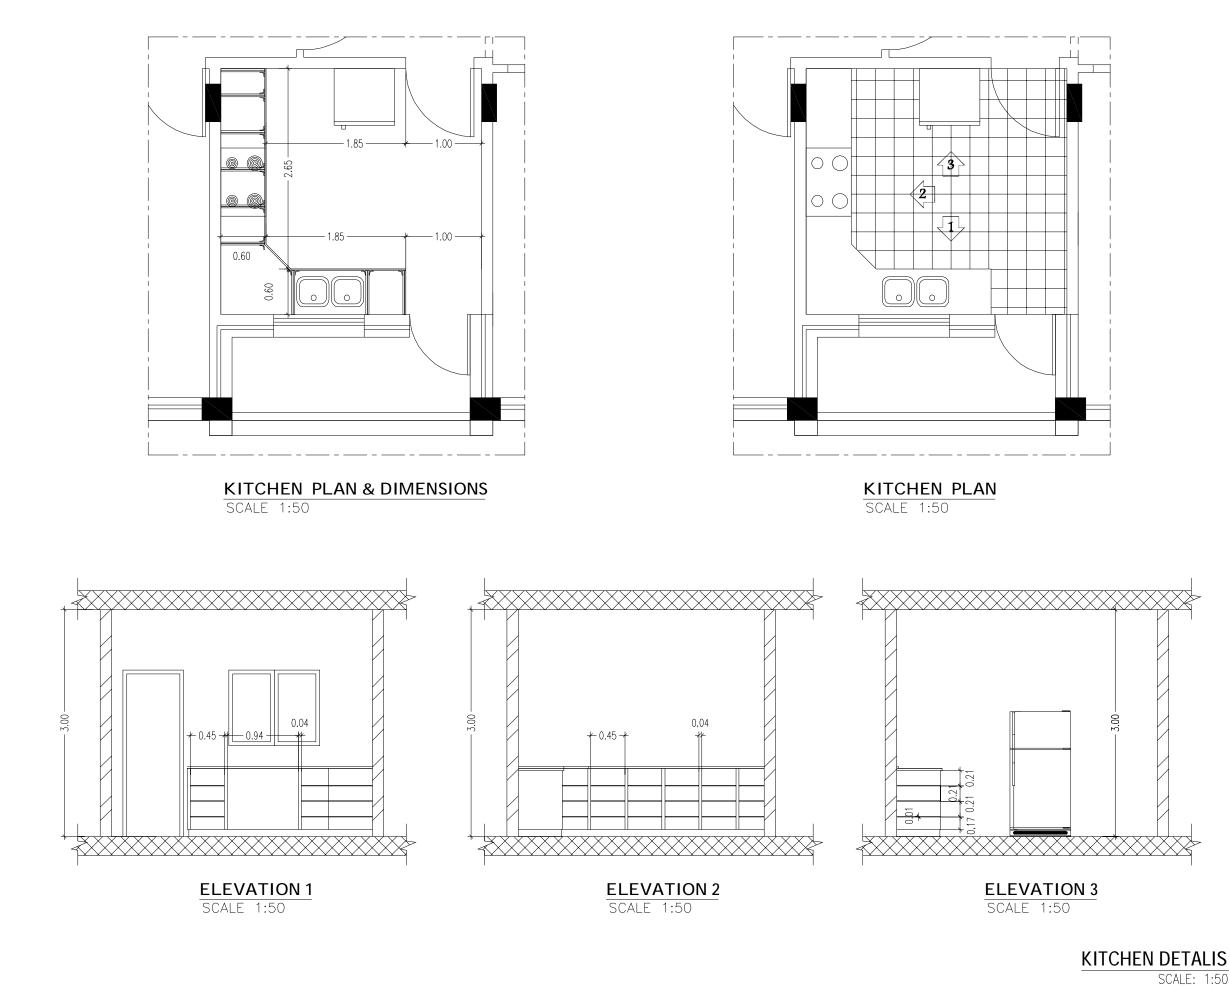

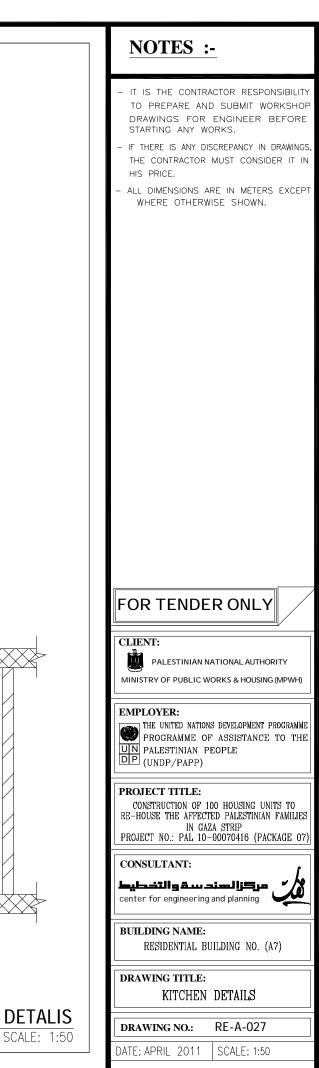

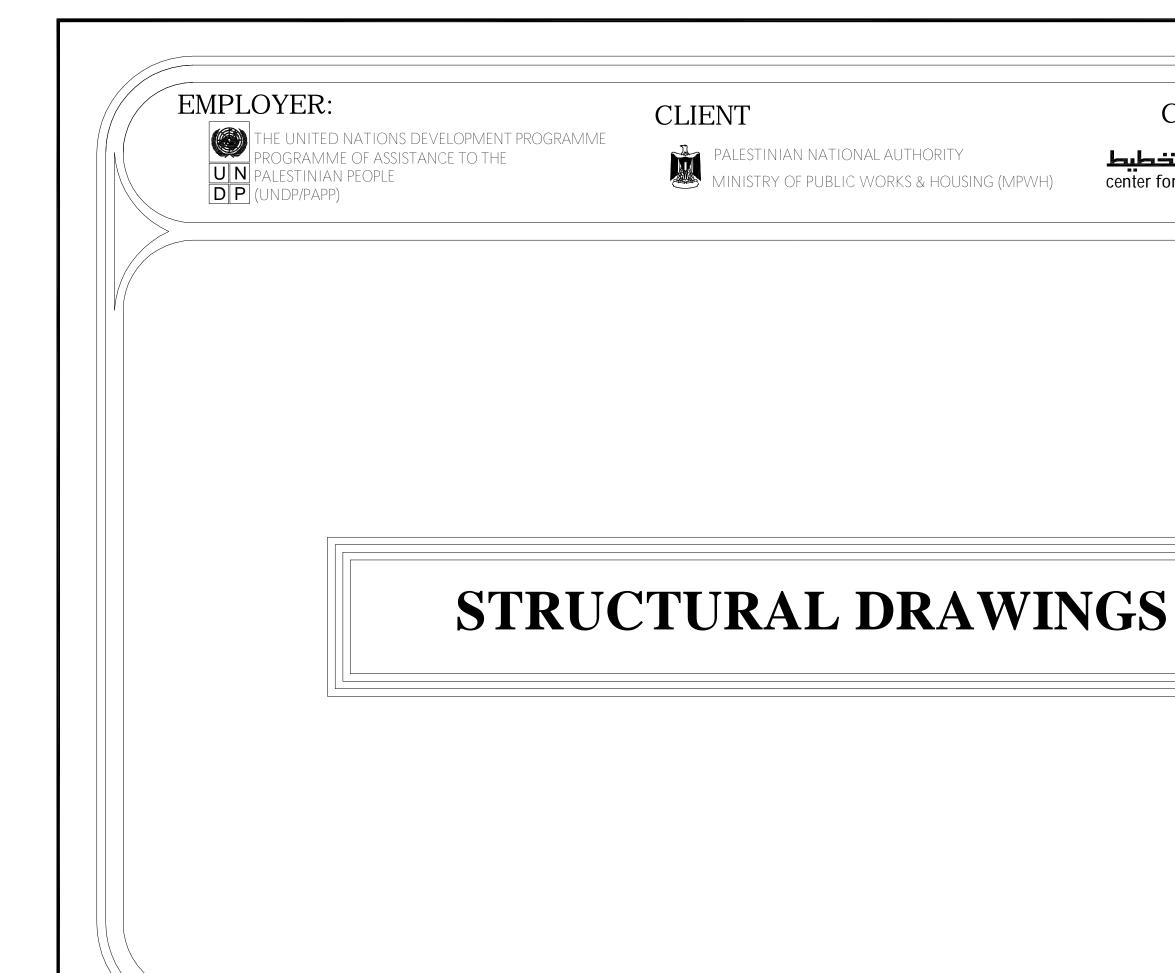

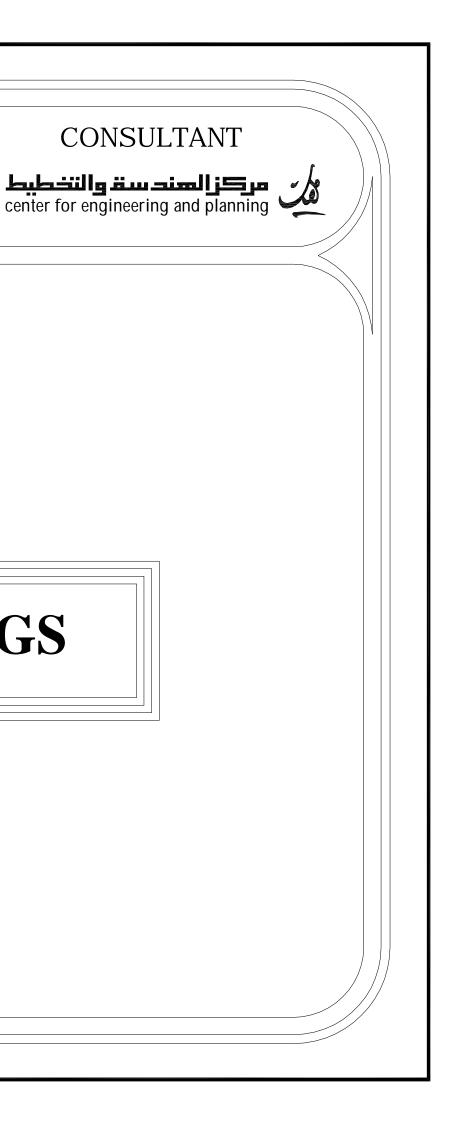

EMPLOYER:




THE UNITED NATIONS DEVELOPMENT PROGRAMME PROGRAMME OF ASSISTANCE TO THE PALESTINIAN PEOPLE **DP** (UNDP/PAPP)

CLIENT




PALESTINIAN NATIONAL AUTHORITY MINISTRY OF PUBLIC WORKS & HOUSI MINISTRY OF PUBLIC WORKS & HOUSING (MPWH)

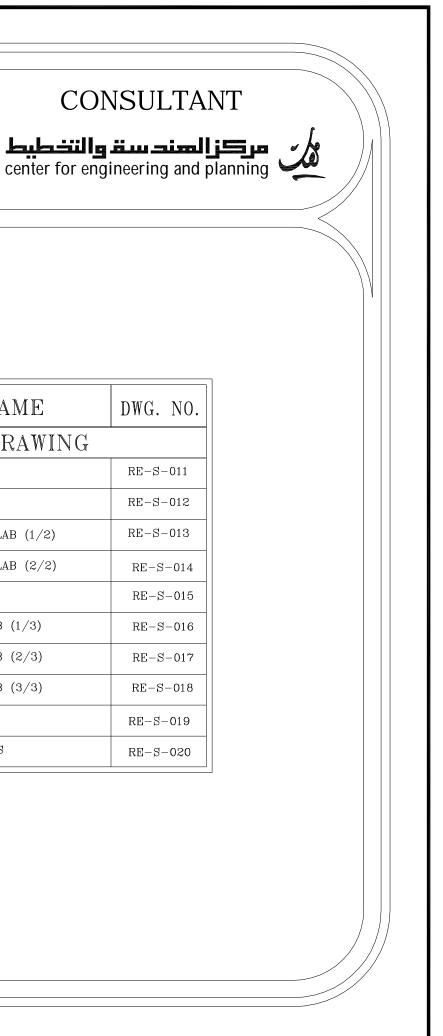


LIST OF DRAWINGS


S/NO.	DRAWING NAME	DWG. NO.						
	STRUCTURAL DRAWING							
01/21	GENERAL STRUCTURAL DETAILS	RE-S-000						
02/21	COLUMN AXES	RE-S-001						
03/21	GENERAL LAYOUT AND DIMENSIONS FOR FOOTINGS	RE-S-002						
04/21	FOOTING DETAILS (1/2)	RE-S-003						
05/21	FOUNDATIONS DETAILS (2/2)	RE-S-004						
06/21	BASEMENT WALL & SHEAR WALL DETAILS RE-							
07/21	ELEVATOR WALL DETAILS	RE-S-006						
08/21	COLUMNS DETAILS (1/4)	RE-S-007						
09/21	COLUMNS DETAILS (2/4)	RE-S-008						
10/21	COLUMNS DETAILS (3/4)	RE-S-009						
11/21	COLUMNS DETAILS (4/4) RE-S							

S/NO.	DRAWING NAME
	STRUCTURAL DRAWING
12/21	GROUND BEAMS DETAILS
13/21	BASEMENT SLAB DETAILS
14/21	BEAMS DETAILS OF BASEMENT SLAB (1/2)
15/21	BEAMS DETAILS OF BASEMENT SLAB (2/2)
16/21	TYPICAL SLAB DETAILS
17/21	BEAMS DETAILS OF TYPICAL SLAB (1/3)
18/21	BEAMS DETAILS OF TYPICAL SLAB (2/3)
19/21	BEAMS DETAILS OF TYPICAL SLAB (3/3)
20/21	STAIRS ROOF SLAB DETAILS
21/21	STRUCTURAL DETAILS FOR STAIRS
Ľ	

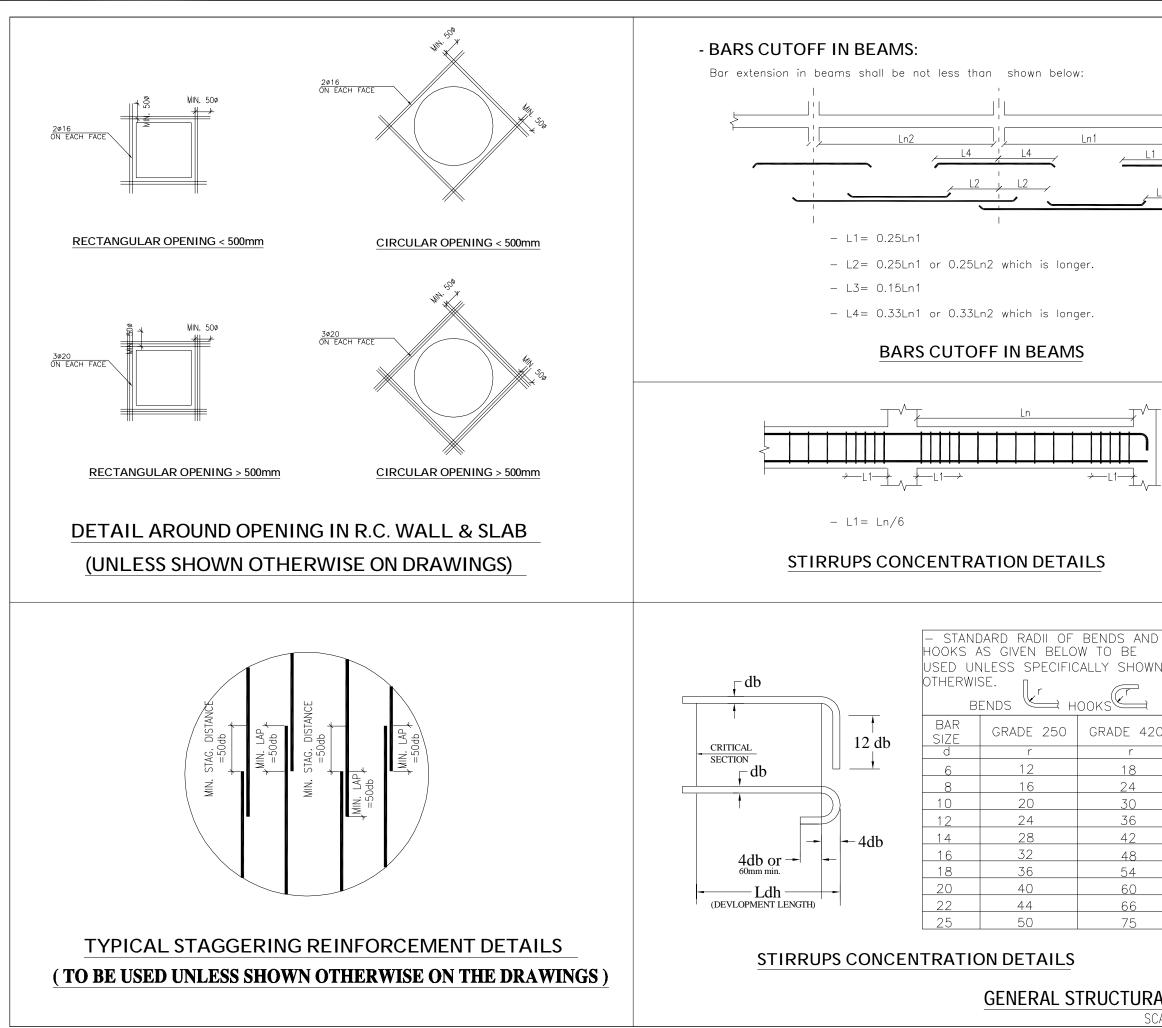

	NOTES :-
	 IT IS THE CONTRACTOR RESPONSIBILITY TO PREPARE AND SUBMIT WORKSHOP DRAWINGS FOR ENGINEER BEFORE START WORKS. ALL OF THE STRUCTURAL DRAWINGS ARE TO BE READ IN CONJUCTION WITH THE PERTINENT ARCHITECTURAL, CIVIL DEFENSE AND OTHER STRUCTURAL DRAWINGS IF THERE IS ANY DISCREPANCY IN DRAWINGS, THE CONTRACTOR MUST CONSIDER IT IN HIS PRICE. CONCRETE SURFACE IN CONTACT WITH SOIL SHALL BE PAINTED 1-COAT PRIMER AND 2-COATS OF HOT BITUMEN. DESIGN CODE IS ACI 318-08. STEEL BARS PROVIDED BY CONTRACTOR (G420) Fy=420 MPa. CONCRETE PROVIDED BY CONTRACTOR FOR COMPRESSIVE STRENGTH FCU AS: -FOR R.C. CULUMNS & WALLS =35 MPa -FOR R.C. SLAB
	-FOR R.C. FOOTINGS =30 MPa -FOR R.C. LINTELS =25 MPa -FOR PLAIN CONCRET =20 MPa - STEEL COVERS: -FOR FOOOTINGS (CAST AGAINST SOIL) =7.5 cm (FOR PROTECTED CONCRETE) =5.0 cm -FOR COLUMNS AND BEAMS =4.0 cm -FOR WALLS =5.0 cm -FOR SLABS =2.5 cm -FOR SLABS =2.5 cm -MIN. LAP FOR STEEL BAR = 60cm OR 50 x DIA, BAR WHICH IS GREATER.
	FOR UNDERGROUND, GROUND, & 3 STORIES. - SOIL BEARING CAPACITY IS: 200 KN/m ² .
) N	CLIENT: PALESTINIAN NATIONAL AUTHORITY MINISTRY OF PUBLIC WORKS & HOUSING (MPWH) EMPLOYER: THE UNITED NATIONS DEVELOPMENT PROGRAMME PROGRAMME OF ASSISTANCE TO THE PALESTINIAN PEOPLE
	PROJECT TITLE: CONSTRUCTION OF 100 HOUSING UNITS TO RE-HOUSE THE AFFECTED PALESTINIAN FAMILIES IN GAZA STRIP PROJECT NO.: PAL 10-00070416 (PACKAGE 07)
	CONSULTANT: التخطيط والتخطيط center for engineering and planning
	BUILDING NAME: RESIDENTIAL BUILDING NO. (A?) DRAWING TITLE:
AL DETAILS	GENERAL STRUCTURAL DETAILS DRAWING NO.: RE-S-000
CALE: AS SHOWN	DATE: APRIL 2011 SCALE: AS SHOWN

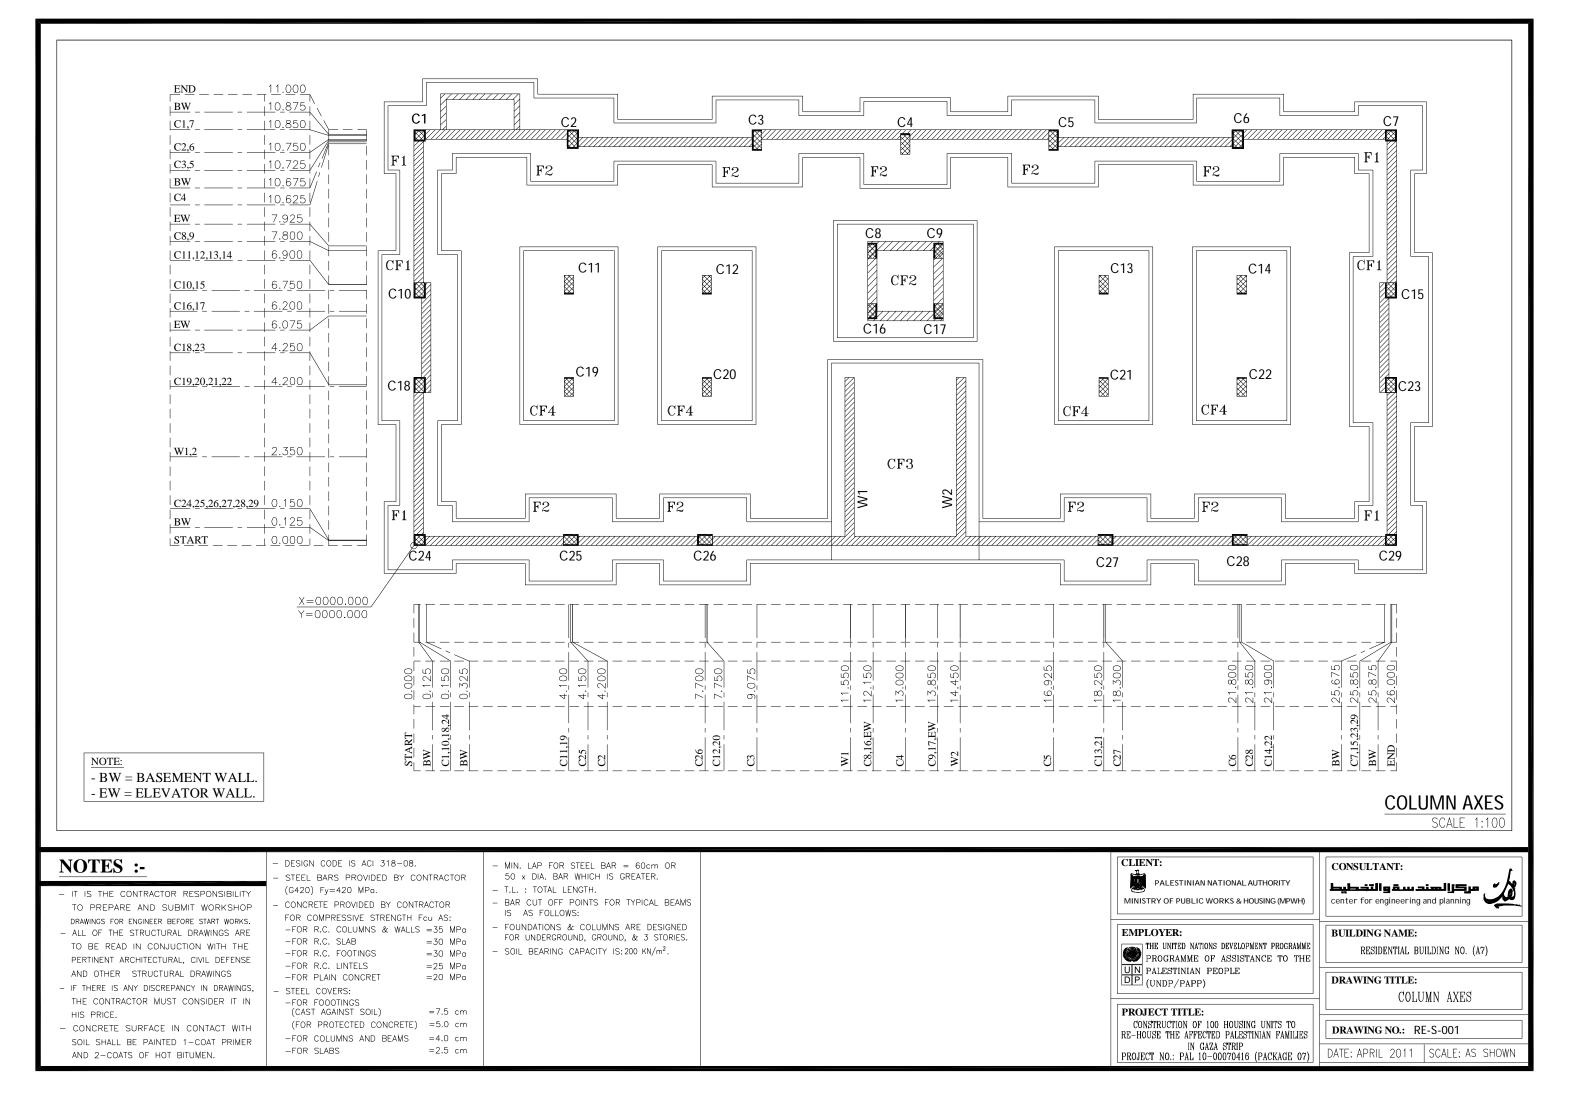

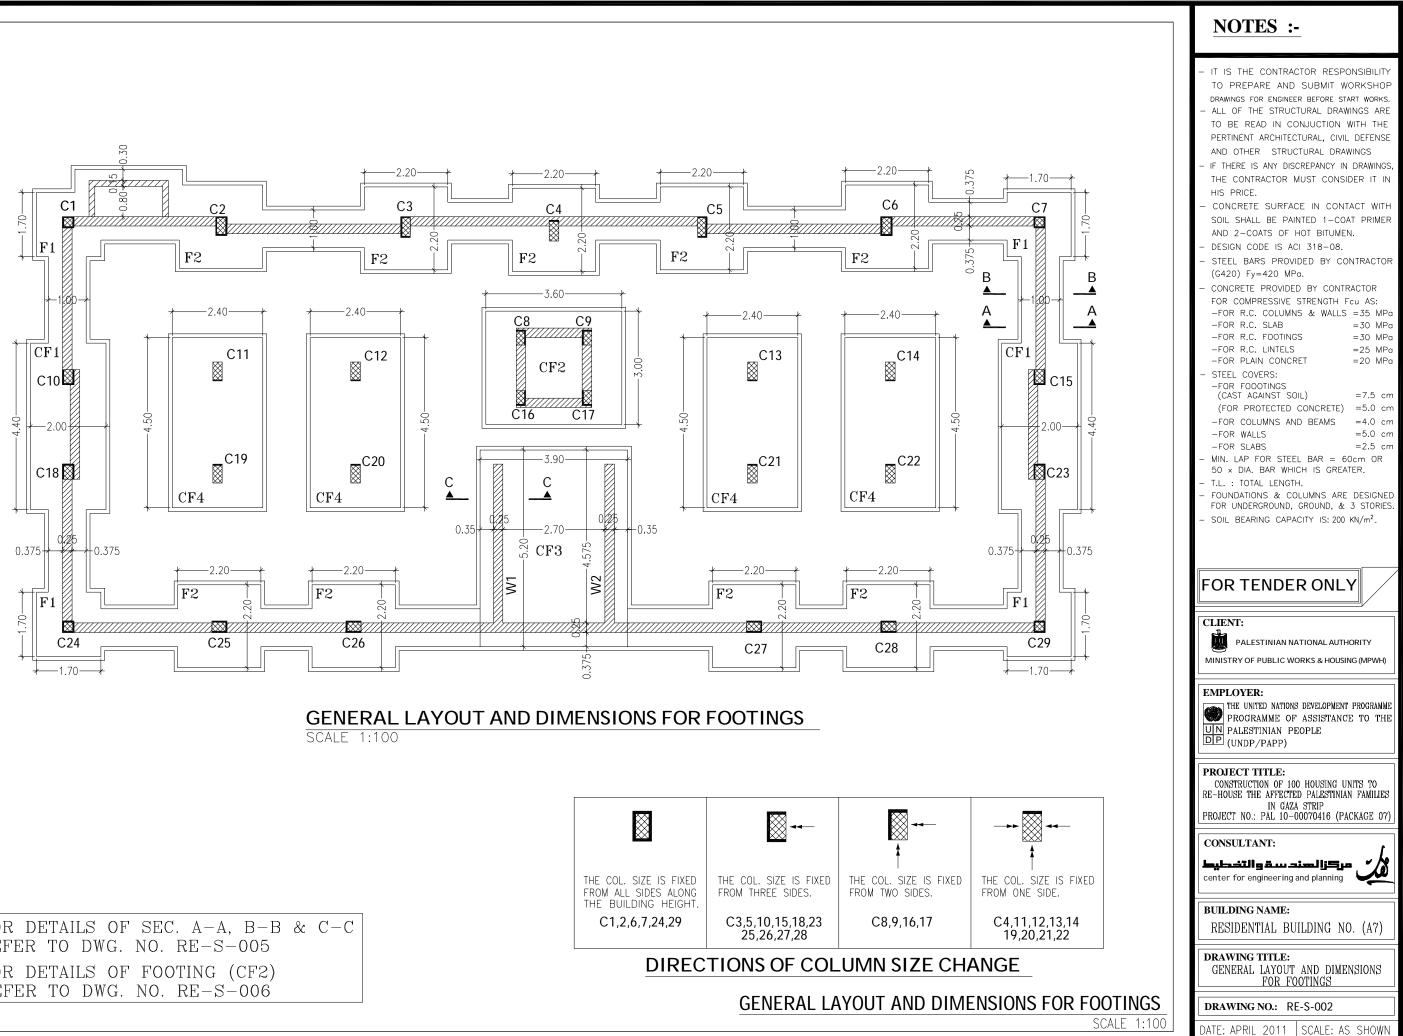

-FOR DETAILS OF SEC. A-A, B-B & C-C REFER TO DWG. NO. RE-S-005 -FOR DETAILS OF FOOTING (CF2) REFER TO DWG. NO. RE-S-006


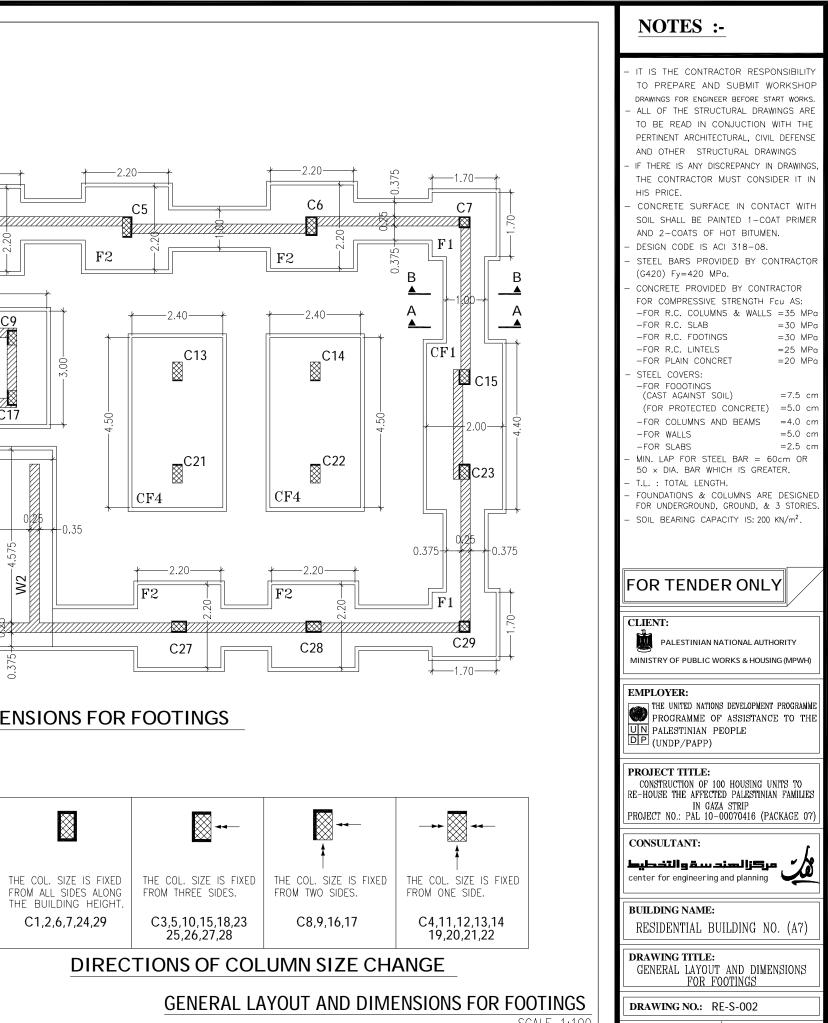


Table of Footings	(ISOLATED)
-------------------	------------

Г									
	Foot	ling	tal	Foot	ings	size	F	Reinforcen	nent
	FOOT. NO.	COL. NO.		L(cm)	W(cm)	h(cm)	LONG DIR.	SHORT DIR.	Shape
	F1	1,7,24,29	4	170	170	40	1ø12@15cm	1ø12@15cm	TOP/160cm 20 BOT/160cm T.L=200cm
	F2	2,3,4,5,6 25,26,27,28	9	220	220	40	1ø12@15cm	1ø12@15cm	TOP/210cm 20 BOT/210cm T.L=250cm

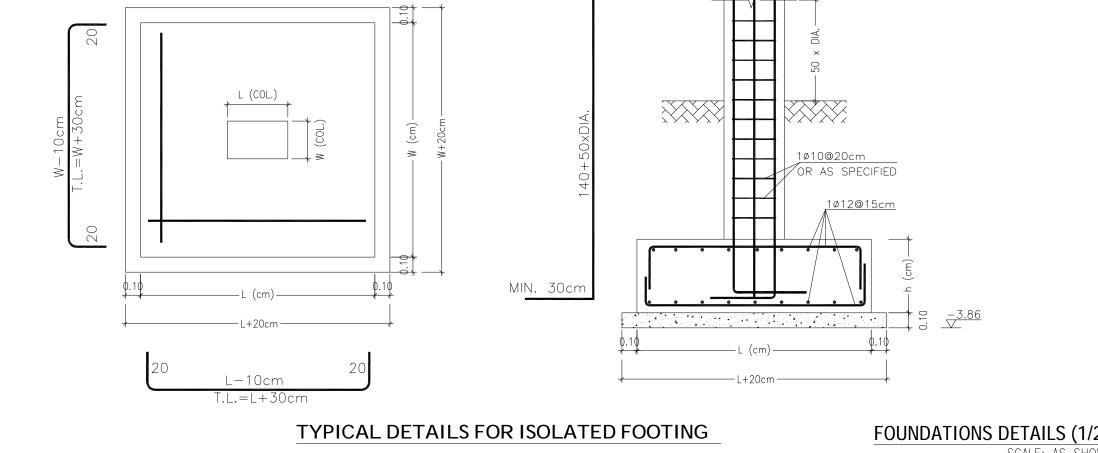


NOTES :-

J 20	 IT IS THE CONTRACTOR RESPONSIBILITY TO PREPARE AND SUBMIT WORKSHOP DRAWINGS FOR ENCINEER BEFORE START WORKS. ALL OF THE STRUCTURAL DRAWINGS ARE TO BE READ IN CONJUCTION WITH THE PERTINENT ARCHITECTURAL, CIVIL DEFENSE AND OTHER STRUCTURAL DRAWINGS IF THERE IS ANY DISCREPANCY IN DRAWINGS, THE CONTRACTOR MUST CONSIDER IT IN HIS PRICE. CONCRETE SURFACE IN CONTACT WITH SOIL SHALL BE PAINTED 1-COAT PRIMER AND 2-COATS OF HOT BITUMEN. DESIGN CODE IS ACI 318-08. STEEL BARS PROVIDED BY CONTRACTOR (G420) Fy=420 MPo. CONCRETE PROVIDED BY CONTRACTOR FOR COMPRESSIVE STRENGTH FCU AS: -FOR R.C. COLUMNS & WALLS = 35 MPo -FOR R.C. SLAB = 30 MPo -FOR R.C. LINTELS = 25 MPo -FOR R.C. LINTELS = 25 MPo -FOR FLAIN CONCRET = 20 MPo STEEL COVERS: -FOR FOOTINGS (CAST AGAINST SOIL) =7.5 cm (FOR PROTECTED CONCRETE) =5.0 cm -FOR COLUMNS AND BEAMS =4.0 cm -FOR SLABS = 2.5 cm MIN. LAP FOR STEEL BAR = 60cm OR 50 × DIA. BAR WHICH IS GREATER. T.L. : TOTAL LENGTH. FOUNDATIONS & COLUMNS ARE DESIGNED FOR UNDERGROUND, GROUND, & 3 STORES. SOIL BEARING CAPACITY IS: 200 KN/m².
	FOR TENDER ONLY
	CLIENT:
	CLIENT: PALESTINIAN NATIONAL AUTHORITY
	CLIENT: PALESTINIAN NATIONAL AUTHORITY MINISTRY OF PUBLIC WORKS & HOUSING (MPWH) EMPLOYER: THE UNITED NATIONS DEVELOPMENT PROGRAMME PROGRAMME OF ASSISTANCE TO THE UN PALESTINIAN PEOPLE
	CLIENT: PALESTINIAN NATIONAL AUTHORITY MINISTRY OF PUBLIC WORKS & HOUSING (MPWH) EMPLOYER: THE UNITED NATIONS DEVELOPMENT PROGRAMME PROGRAMME OF ASSISTANCE TO THE PROGRAMME OF ASSISTANCE TO THE UN PALESTINIAN PEOPLE UNDP/PAPP) PROJECT TITLE: CONSTRUCTION OF 100 HOUSING UNITS TO RE-HOUSE THE AFFECTED PALESTINIAN FAMILIES IN GAZA STRIP
	CLIENT: PALESTINIAN NATIONAL AUTHORITY MINISTRY OF PUBLIC WORKS & HOUSING (MPWH) EMPLOYER: THE UNITED NATIONS DEVELOPMENT PROGRAMME PROGRAMME OF ASSISTANCE TO THE PROGRAMME OF ASSISTANCE TO THE PROJECT TITLE: (UNDP/PAPP) PROJECT TITLE: CONSTRUCTION OF 100 HOUSING UNITS TO RE-HOUSE THE AFFECTED PALESTINIAN FAMILIES IN GAZA STRIP PROJECT NO.: PAL 10-00070416 (PACKAGE 07) CONSULTANT: Laberting a units of the state of t
	CLIENT: PALESTINIAN NATIONAL AUTHORITY MINISTRY OF PUBLIC WORKS & HOUSING (MPWH) EMPLOYER: THE UNITED NATIONS DEVELOPMENT PROGRAMME PROGRAMME OF ASSISTANCE TO THE PROGRAMME OF ASSISTANCE TO THE UN PALESTINIAN PEOPLE DP (UNDP/PAPP) PROJECT TITLE: CONSTRUCTION OF 100 HOUSING UNITS TO RE-HOUSE THE AFFECTED PALESTINIAN FAMILIES IN GAZA STRIP PROJECT NO.: PAL 10-00070416 (PACKAGE 07) CONSULTANT: Luberill g & Luberill g and planning BUILDING NAME:
DETAILS (1/2) SCALE: AS SHOWN	CLIENT: PALESTINIAN NATIONAL AUTHORITY MINISTRY OF PUBLIC WORKS & HOUSING (MPWH) EMPLOYER: PROGRAMME OF ASSISTANCE TO THE PROGRAMME OF ASSISTANCE TO THE PROGRAMME OF ASSISTANCE TO THE UN PALESTINIAN PEOPLE PROJECT TITLE: CONSTRUCTION OF 100 HOUSING UNITS TO RE-HOUSE THE AFFECTED PALESTINIAN FAMILIES IN GAZA STRIP PROJECT NO.: PAL 10-00070416 (PACKAGE 07) CONSULTANT: LLB-110 B LU - 10070416 (PACKAGE 07) CONSULTANT: LLB-110 B LU - 10070416 (PACKAGE 07) BUILDING NAME: RESIDENTIAL BUILDING NO. (A7) DRAWING TITLE:



Table of Footings (COMBINED)

Footing		cal	Foot	ings	size	F	Reinforce	ment
FOOT. NO.	COL. NO.	Total	L(cm)	W(cm)	h(cm)	LONG DIR. (TOP & BOT.)	SHORT DIR. (TOP & BOT.)	Shape
CF1	10,15,18,23	2	440	200	40	1ø12@15cm	1ø12@15cm	20 BOT. L OR W-10cm
CF2	8,9,16,17	1	360	300	30	1ø12@20cm	1ø12@20cm	TOP 15 BOT. L OR W-10cm
CF3	W1,W2	1	520	390	50	1ø12@10cm	1ø12@10cm	TOP 30 BOT. L OR W-10cm
CF4	11,19,12,20 13,21,14,22	4	450	240	50	1ø12@10cm	1ø12@10cm	30 BOT. L OR W-10cm

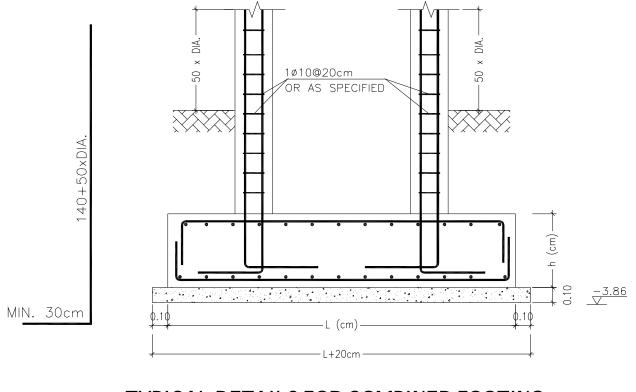


TYPICAL DETAILS FOR COMPINED FOOTING


NOTES :-

- IT IS THE CONTRACTOR RESPONSIBILITY
 TO PREPARE AND SUBMIT WORKSHOP DRAWINGS FOR ENGINEER BEFORE START WORKS. ALL OF THE STRUCTURAL DRAWINGS ARE TO BE READ IN CONJUCTION WITH THE PERTINENT ARCHITECTURAL, CIVIL DEFENSE AND OTHER STRUCTURAL DRAWINGS IF THERE IS ANY DISCREPANCY IN DRAWINGS, THE CONTRACTOR MUST CONSIDER IT IN HIS PRICE. CONCRETE SURFACE IN CONTACT WITH SOIL SHALL BE PAINTED 1-COAT PRIMER AND 2-COATS OF HOT BITUMEN. DESIGN CODE IS ACI 318-08. STEEL BARS PROVIDED BY CONTRACTOR (G420) Fy=420 MPa. CONCRETE PROVIDED BY CONTRACTOR FOR COMPRESSIVE STRENGTH FCU AS: -FOR R.C. COLUMNS & WALLS =35 MPa -FOR R.C. SLAB = 30 MPa -FOR R.C. SLAB = 30 MPa -FOR R.C. LINTELS = 25 MPa -FOR PLAIN CONCRET = 20 MPa STEEL COVERS: -FOR FOOTINGS (CAST AGAINST SOIL) =7.5 cm (FOR PROTECTED CONCRETE) =5.0 cm -FOR SLABS = 5.0 cm -FOR SLABS = 5.0 cm -FOR SLABS = 2.5 cm MIN. LAP FOR STEEL BAR = 60cm OR 50 × DIA. BAR WHICH IS GREATER. T.L. : TOTAL LENGTH. FOUNDATIONS & COLUMNS ARE DESIGNED FOR UNDERGROUND, GROUND, & 3 STORIES. SOIL BEARING CAPACITY IS: 200 KN/m².
FOR UNDERGROUND, GROUND, & 3 STORIES.
CLIENT: PALESTINIAN NATIONAL AUTHORITY MINISTRY OF PUBLIC WORKS & HOUSING (MPWH)
EMPLOYER:
PROGRAMME OF ASSISTANCE TO THE UN PALESTINIAN PEOPLE DP (UNDP/PAPP)
UN PALESTINIAN PEOPLE
PROJECT TITLE: CONSTRUCTION OF 100 HOUSING UNITS TO RE-HOUSE THE AFFECTED PALESTINIAN FAMILIES IN GAZA STRIP
UN PALESTINIAN PEOPLE UNDP/PAPP) (UNDP/PAPP) PROJECT TITLE: CONSTRUCTION OF 100 HOUSING UNITS TO CONSTRUCTION OF 100 HOUSING UNITS TO RE-HOUSE THE AFFECTED PALESTINIAN FAMILIES IN GAZA STRIP PROJECT NO.: PAL 10-00070416 (PACKAGE 07) CONSULTANT: Labertilling and planning center for engineering and planning Labertilling NAME: RESIDENTIAL BUILDING NO. (A7)
UN PALESTINIAN PEOPLE UNDP/PAPP) (UNDP/PAPP) PROJECT TITLE: CONSTRUCTION OF 100 HOUSING UNITS TO RE-HOUSE THE AFFECTED PALESTINIAN FAMILIES IN GAZA STRIP PROJECT NO.: PAL 10-00070416 (PACKAGE 07) CONSULTANT: Labelian Ellication of the engineering and planning Consultant: BUILDING NAME: Consultant:
UN PALESTINIAN PEOPLE UNDP/PAPP) PROJECT TITLE: CONSTRUCTION OF 100 HOUSING UNITS TO RE-HOUSE THE AFFECTED PALESTINIAN FAMILIES IN GAZA STRIP PROJECT NO.: PAL 10-00070416 (PACKAGE 07) CONSULTANT: Labertilling and planning center for engineering and planning BUILDING NAME: RESIDENTIAL BUILDING NO. (A7) DRAWING TITLE:

SCALE: AS SHOWN

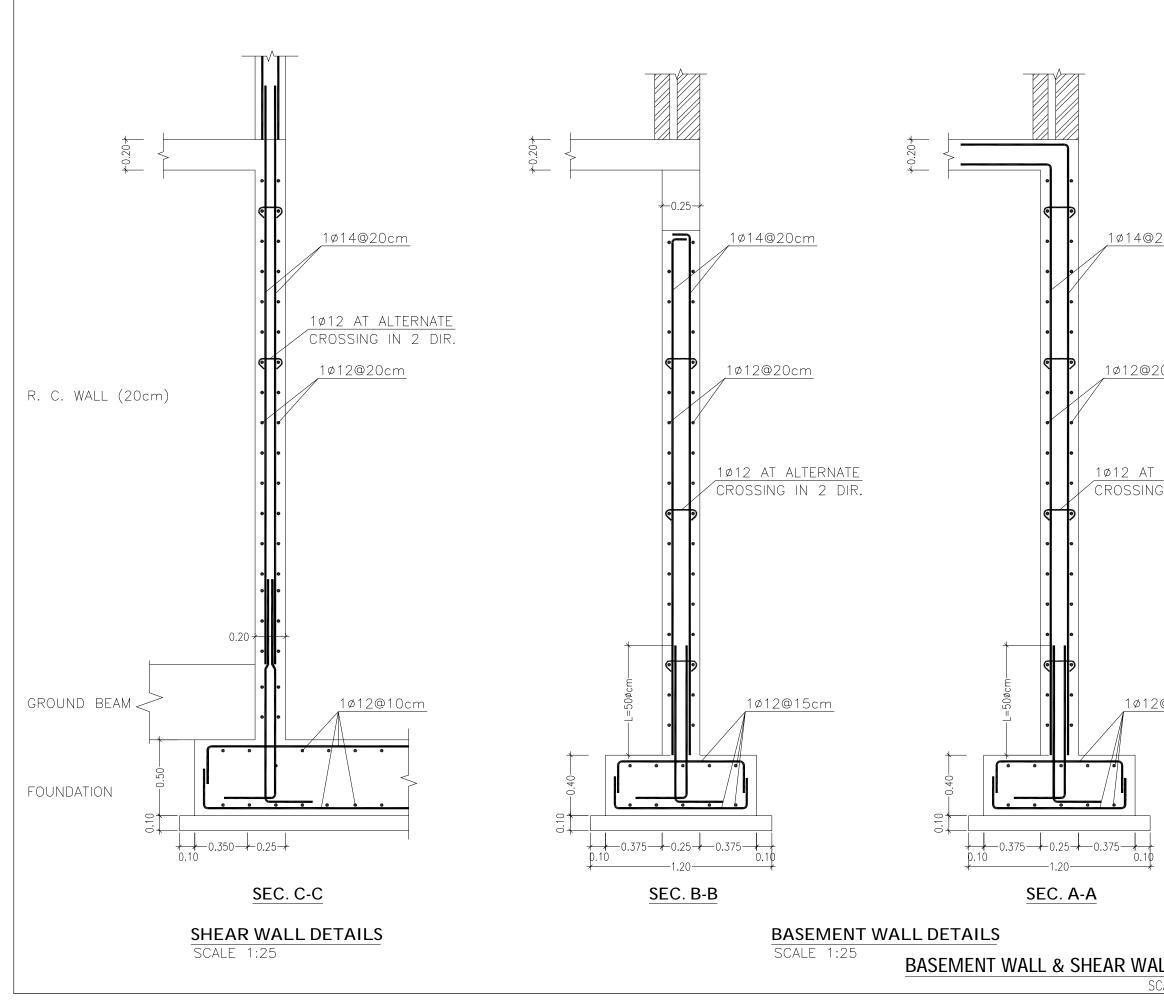


	NOTES :-
<u>20cm</u>	 IT IS THE CONTRACTOR RESPONSIBILITY TO PREPARE AND SUBMIT WORKSHOP DRAWINGS FOR ENGINEER BEFORE START WORKS. ALL OF THE STRUCTURAL DRAWINGS ARE TO BE READ IN CONJUCTION WITH THE PERTINENT ARCHITECTURAL, CIVIL DEFENSE AND OTHER STRUCTURAL DRAWINGS IF THERE IS ANY DISCREPANCY IN DRAWINGS, THE CONTRACTOR MUST CONSIDER IT IN HIS PRICE. CONCRETE SURFACE IN CONTACT WITH SOIL SHALL BE PAINTED 1-COAT PRIMER AND 2-COATS OF HOT BITUMEN. DESIGN CODE IS ACI 318-08. STEEL BARS PROVIDED BY CONTRACTOR (G420) Fy=420 MPa. CONCRETE PROVIDED BY CONTRACTOR FOR COMPRESSIVE STRENGTH FCU AS: -FOR R.C. COLUMNS & WALLS =35 MPa -FOR R.C. SLAB
<u>Ocm</u> Alternate G IN 2 DIR.	 FOR R.C. SLAB = 30 MPa FOR R.C. FOOTINGS = 30 MPa FOR R.C. LINTELS = 25 MPa FOR PLAIN CONCRET = 20 MPa STEEL COVERS: FOR FOOOTINGS (CAST AGAINST SOIL) = 7.5 cm (FOR PROTECTED CONCRETE) = 5.0 cm FOR COLUMNS AND BEAMS = 4.0 cm FOR WALLS = 5.0 cm FOR SLABS = 2.5 cm MIN. LAP FOR STEEL BAR = 60cm OR 50 x DIA. BAR WHICH IS GREATER. T.L. : TOTAL LENGTH. FOUNDATIONS & COLUMNS ARE DESIGNED FOR UNDERGROUND, GROUND, & 3 STORIES. SOIL BEARING CAPACITY IS: 200 KN/m².
	FOR TENDER ONLY
	CLIENT: PALESTINIAN NATIONAL AUTHORITY MINISTRY OF PUBLIC WORKS & HOUSING (MPWH)
<u>@15cm</u>	EMPLOYER: THE UNITED NATIONS DEVELOPMENT PROGRAMME PROGRAMME OF ASSISTANCE TO THE UN PALESTINIAN PEOPLE DP (UNDP/PAPP)
	PROJECT TITLE: CONSTRUCTION OF 100 HOUSING UNITS TO RE-HOUSE THE AFFECTED PALESTINIAN FAMILIES IN GAZA STRIP PROJECT NO.: PAL 10-00070416 (PACKAGE 07)
	CONSULTANT: مركزا لهندسة والتخطيط center for engineering and planning
	BUILDING NAME: RESIDENTIAL BUILDING NO. (A7)
	DRAWING TITLE: BASEMENT WALL & SHEAR WALL DETAILS
LL DETAILS	DRAWING NO.: RE-S-005
CALE: AS SHOWN	DATE: APRIL 2011 SCALE: AS SHOWN

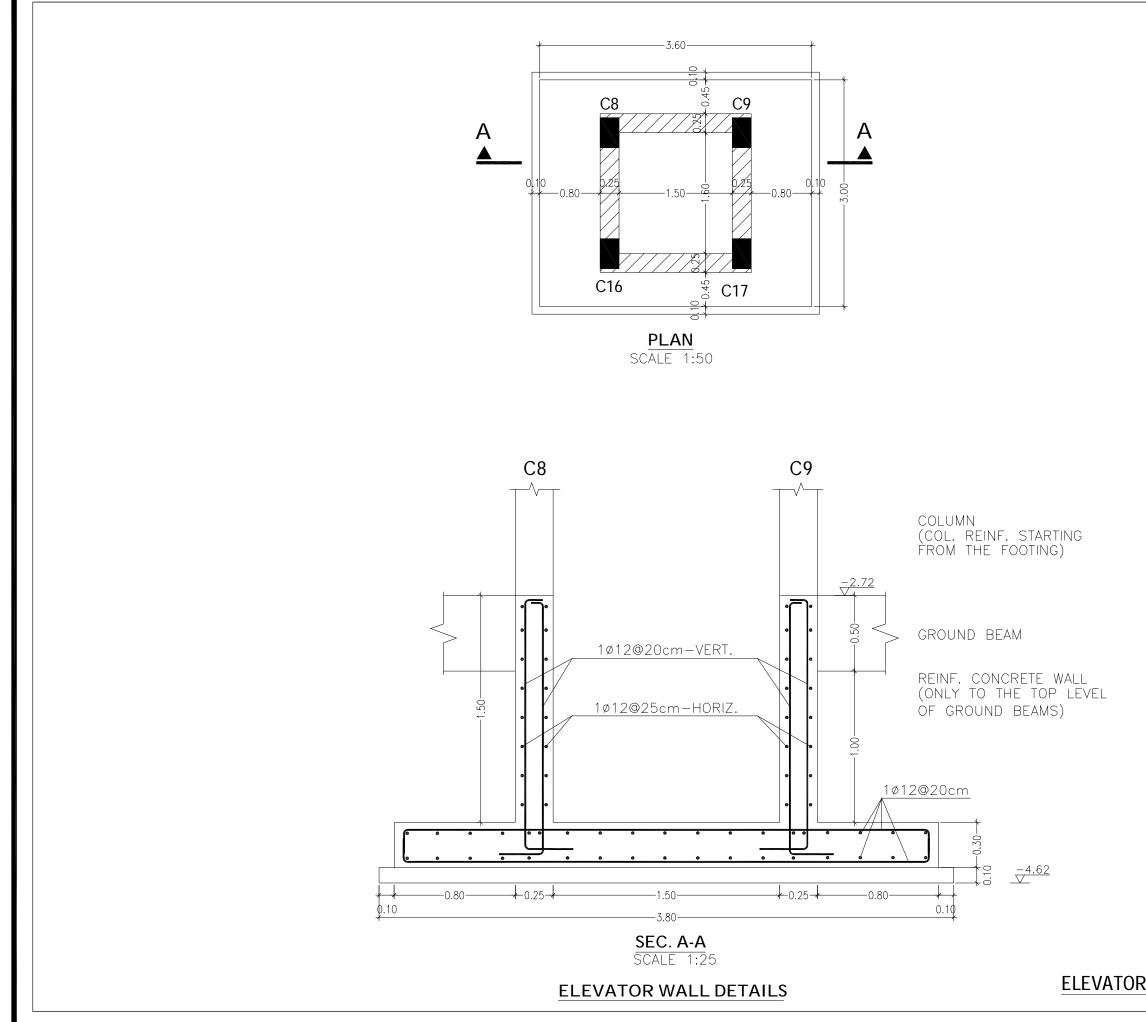

	 IT IS THE CONTRACTOR RESPONSIBILITY TO PREPARE AND SUBMIT WORKSHOP
	DRAWINGS FOR ENGINEER BEFORE START WORKSHUP DRAWINGS FOR ENGINEER BEFORE START WORKS. – ALL OF THE STRUCTURAL DRAWINGS ARE TO BE READ IN CONJUCTION WITH THE
	PERTINENT ARCHITECTURAL, CIVIL DEFENSE AND OTHER STRUCTURAL DRAWINGS
	- IF THERE IS ANY DISCREPANCY IN DRAWINGS, THE CONTRACTOR MUST CONSIDER IT IN
	HIS PRICE. — CONCRETE SURFACE IN CONTACT WITH SOIL SHALL BE PAINTED 1-COAT PRIMER
	AND 2-COATS OF HOT BITUMEN. – DESIGN CODE IS ACI 318-08.
	 STEEL BARS PROVIDED BY CONTRACTOR (G420) Fy=420 MPa.
	 CONCRETE PROVIDED BY CONTRACTOR FOR COMPRESSIVE STRENGTH Fcu AS: FOR R.C. COLUMNS & WALLS = 35 MPa
	-FOR R.C. SLAB = 30 MPa -FOR R.C. FOOTINGS = 30 MPa
	-FOR R.C. LINTELS =25 MPo -FOR PLAIN CONCRET =20 MPo - STEEL COVERS:
	-FOR FOODINGS (CAST AGAINST SOIL) =7.5 cm (FOR PROTECTED CONCRETE) =5.0 cm
	-FOR COLUMNS AND BEAMS =4.0 cm -FOR WALLS =5.0 cm
	-FOR SLABS =2.5 cm - MIN. LAP FOR STEEL BAR = 60cm OR 50 × DIA. BAR WHICH IS GREATER.
	 T.L. : TOTAL LENGTH. FOUNDATIONS & COLUMNS ARE DESIGNED
	FOR UNDERGROUND, GROUND, & 3 STORIES. - SOIL BEARING CAPACITY IS: 200 KN/m ² .
	FOR TENDER ONLY
	CLIENT:
	-
	PALESTINIAN NATIONAL AUTHORITY MINISTRY OF PUBLIC WORKS & HOUSING (MPWH) EMPLOYER: THE UNITED NATIONS DEVELOPMENT PROGRAMME PROGRAMME OF ASSISTANCE TO THE PALESTINIAN PEOPLE
	PALESTINIAN NATIONAL AUTHORITY MINISTRY OF PUBLIC WORKS & HOUSING (MPWH) EMPLOYER: THE UNITED NATIONS DEVELOPMENT PROGRAMME PROGRAMME OF ASSISTANCE TO THE UN PALESTINIAN PEOPLE DP (UNDP/PAPP)
	PALESTINIAN NATIONAL AUTHORITY MINISTRY OF PUBLIC WORKS & HOUSING (MPWH) EMPLOYER: THE UNITED NATIONS DEVELOPMENT PROGRAMME PROGRAMME OF ASSISTANCE TO THE PALESTINIAN PEOPLE UND PALESTINIAN PEOPLE (UNDP/PAPP) PROJECT TITLE: CONSTRUCTION OF 100 HOUSING UNITS TO RE-HOUSE THE AFFECTED PALESTINIAN FAMILIES IN GAZA STRIP
	PALESTINIAN NATIONAL AUTHORITY MINISTRY OF PUBLIC WORKS & HOUSING (MPWH) EMPLOYER: PROGRAMME OF ASSISTANCE TO THE PROGRAMME OF ASSISTANCE TO THE UN PALESTINIAN PEOPLE UNDP/PAPP) PROJECT TITLE: CONSTRUCTION OF 100 HOUSING UNITS TO RE-HOUSE THE AFFECTED PALESTINIAN FAMILIES IN GAZA STRIP PROJECT NO.: PAL 10-00070416 (PACKAGE 07)
	PALESTINIAN NATIONAL AUTHORITY MINISTRY OF PUBLIC WORKS & HOUSING (MPWH) EMPLOYER: THE UNITED NATIONS DEVELOPMENT PROGRAMME PROGRAMME OF ASSISTANCE TO THE PALESTINIAN PEOPLE UND PALESTINIAN PEOPLE (UNDP/PAPP) PROJECT TITLE: CONSTRUCTION OF 100 HOUSING UNITS TO RE-HOUSE THE AFFECTED PALESTINIAN FAMILIES IN GAZA STRIP
	PALESTINIAN NATIONAL AUTHORITY MINISTRY OF PUBLIC WORKS & HOUSING (MPWH) EMPLOYER: PROGRAMME OF ASSISTANCE TO THE PROGRAMME OF ASSISTANCE TO THE UN PALESTINIAN PEOPLE UN PALESTINIAN PEOPLE (UNDP/PAPP) PROJECT TITLE: CONSTRUCTION OF 100 HOUSING UNITS TO RE-HOUSE THE AFFECTED PALESTINIAN FAMILIES IN GAZA STRIP PROJECT NO.: PAL 10-00070416 (PACKAGE 07) CONSULTANT: Lubiting Builting Lingson
	PALESTINIAN NATIONAL AUTHORITY MINISTRY OF PUBLIC WORKS & HOUSING (MPWH) EMPLOYER: PROGRAMME OF ASSISTANCE TO THE PROGRAMME OF ASSISTANCE TO THE UN PALESTINIAN PEOPLE UN PALESTINIAN PEOPLE (UNDP/PAPP) PROJECT TITLE: CONSTRUCTION OF 100 HOUSING UNITS TO RE-HOUSE THE AFFECTED PALESTINIAN FAMILIES IN GAZA STRIP PROJECT NO.: PAL 10-00070416 (PACKAGE 07) CONSULTANT: Lubiling name:
	PALESTINIAN NATIONAL AUTHORITY MINISTRY OF PUBLIC WORKS & HOUSING (MPWH) EMPLOYER: THE UNITED NATIONS DEVELOPMENT PROGRAMME PROGRAMME OF ASSISTANCE TO THE PROJECT TITLE: CONSTRUCTION OF 100 HOUSING UNITS TO RE-HOUSE THE AFFECTED PALESTINIAN FAMILLES IN GAZA STRIP PROJECT NO.: PAL 10-00070416 (PACKAGE 07) CONSULTANT: Lucitor for engineering and planning Center for engineering and planning BUILDING NAME: RESIDENTIAL BUILDING NO. (A7) DRAWING TITLE:

ELEVATOR WALL DETAILS SCALE: AS SHOWN

DETAILS FOR COLUMNS NICK & COLUMNS							
FLOOR	COLUMNS NO.	TOTAL	DETAI	LS			
	C1,7,24,29	4	0.30 3ø12 2ø12 3ø12 3ø12	ST. 2010@20cm-MIDDLE ST. 2010@10cm-END			
	C10,15,18,23 25,26,27,28	8	3ø14 2ø14 3ø14	ST. 2ø10@20cm-MIDDLE ST. 2ø10@10cm-END			
COLUM NICK	C3,4,5	3	0.55 5ø14 5ø14 5ø14	ST. 2Ø10@20cm-MIDDLE ST. 2Ø10@10cm-END			
	C2,6	2	0.50 4ø14 2ø14 4ø14	ST. 2010@20cm-MIDDLE ST. 2010@10cm-END			
	C11,12,13,14 19,20,21,22	8	0.50 5ø14 5ø14 5ø14	ST. 2¢10@20cm-MIDDLE ST. 2¢10@10cm-END			
	C8,9,16,17	4	3ø14 3ø14	ST. 1ø10@20cm-MIDDLE ST. 1ø10@10cm-END			

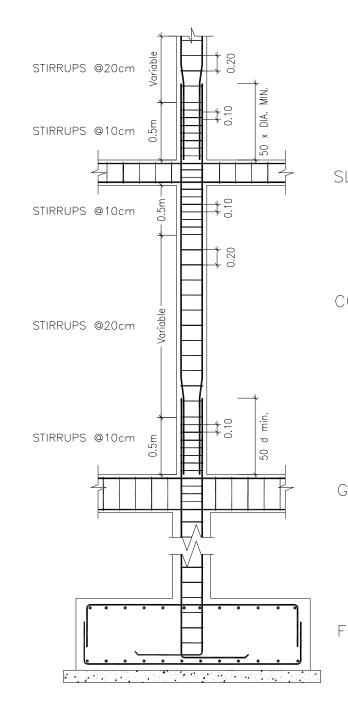




NOT TO SCALE

COLUMNS DE

SC

	NOTES :-		
LAB	 IT IS THE CONTRACTOR RESPONSIBILITY TO PREPARE AND SUBMIT WORKSHOP DRAWINGS FOR ENGINEER BEFORE START WORKS. ALL OF THE STRUCTURAL DRAWINGS ARE TO BE READ IN CONJUCTION WITH THE PERTINENT ARCHITECTURAL, CIVIL DEFENSE AND OTHER STRUCTURAL DRAWINGS IF THERE IS ANY DISCREPANCY IN DRAWINGS, THE CONTRACTOR MUST CONSIDER IT IN HIS PRICE. CONCRETE SURFACE IN CONTACT WITH SOIL SHALL BE PAINTED 1-COAT PRIMER AND 2-COATS OF HOT BITUMEN. DESIGN CODE IS ACI 318-08. STEEL BARS PROVIDED BY CONTRACTOR (G420) Fy=420 MPa. CONCRETE PROVIDED BY CONTRACTOR FOR COMPRESSIVE STRENGTH Fcu AS: -FOR R.C. COLUMNS & WALLS =35 MPa -FOR R.C. SLAB = 30 MPa 		
olumn	-FOR R.C. LINTELS =25 MPa -FOR PLAIN CONCRET =20 MPa STEEL COVERS: -FOR FOODTINGS (CAST AGAINST SOIL) =7.5 cm (FOR PROTECTED CONCRETE) =5.0 cm -FOR COLUMNS AND BEAMS =4.0 cm -FOR WALLS =5.0 cm -FOR SLABS =2.5 cm -MIN. LAP FOR STEEL BAR = 60cm OR 50 × DIA. BAR WHICH IS GREATER. = T.L. : TOTAL LENGTH. - FOUNDATIONS & COLUMNS ARE DESIGNED =50 CM		
S. BEAM	FOR UNDERGROUND, GROUND, & 3 STORIES. - SOIL BEARING CAPACITY IS: 200 KN/m ² . FOR TENDER ONLY CLIENT: PALESTINIAN NATIONAL AUTHORITY MINISTRY OF PUBLIC WORKS & HOUSING (MPWH)		
OUND.	EMPLOYER: THE UNITED NATIONS DEVELOPMENT PROGRAMME PROGRAMME OF ASSISTANCE TO THE PALESTINIAN PEOPLE (UNDP/PAPP) PROJECT TITLE:		
	CONSTRUCTION OF 100 HOUSING UNITS TO RE-HOUSE THE AFFECTED PALESTINIAN FAMILIES IN GAZA STRIP PROJECT NO.: PAL 10-00070416 (PACKAGE 07) CONSULTANT: التخطيط والتخطيط center for engineering and planning		
	BUILDING NAME: RESIDENTIAL BUILDING NO. (A7)		
	DRAWING TITLE: COLUMNS DETAILS (1/4)		
TAILS (1/3)	DRAWING NO.: RE-S-007		
CALE: AS SHOWN	DATE: APRIL 2011 SCALE: AS SHOWN		

DETAILS FOR COLUMNS NICK & COLUMNS							
FLOOR	COLUMNS NO. TOTAL DETAILS			LS			
	C1,7,24,29	4	0.30 3ø12 2ø12 3ø12 3ø12	ST. 2010@20cm-MIDDLE ST. 2010@10cm-END			
BASEMENT FLOOR	C10,15,18,23 25,26,27,28	8	0.40 3ø14 2ø14 3ø14	ST. 2010@20cm-MIDDLE ST. 2010@10cm-END			
	C3,4,5	3	0.55 5ø14 5ø14 5ø14	ST. 2010@20cm-MIDDLE ST. 2010@10cm-END			
	C2,6	2	0.50 4ø14 2ø14 4ø14	ST. 2010@20cm-MIDDLE ST. 2010@10cm-END			
	C11,12,13,14 19,20,21,22	8	0.50 5ø14 5ø14 5ø14	ST. 2ø10@20cm-MIDDLE ST. 2ø10@10cm-END			
	C8,9,16,17	4	3ø14 3ø14	ST. 1ø10@20cm-MIDDLE ST. 1ø10@10cm-END			

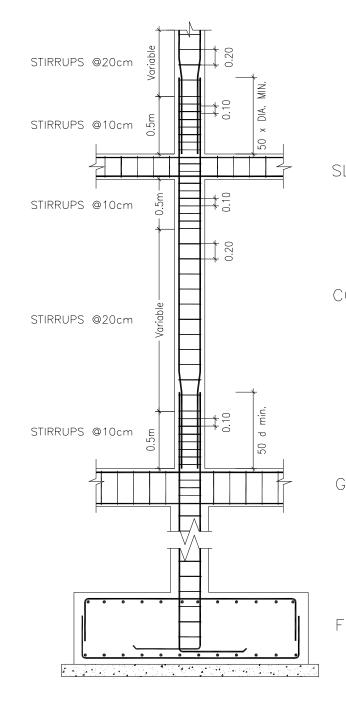





NOT TO SCALE

COLUMNS DE

	NOTES :-		
	 IT IS THE CONTRACTOR RESPONSIBILITY TO PREPARE AND SUBMIT WORKSHOP DRAWINGS FOR ENGINEER BEFORE START WORKS. ALL OF THE STRUCTURAL DRAWINGS ARE TO BE READ IN CONJUCTION WITH THE PERTINENT ARCHITECTURAL, CIVIL DEFENSE AND CTUED. CTRUCTURAL DEFENSE 		
	 AND OTHER STRUCTURAL DRAWINGS IF THERE IS ANY DISCREPANCY IN DRAWINGS, THE CONTRACTOR MUST CONSIDER IT IN HIS PRICE. CONCRETE SURFACE IN CONTACT WITH SOIL SHALL BE PAINTED 1-COAT PRIMER AND 2-COATS OF HOT BITUMEN. DESIGN CODE IS ACI 318-08. 		
LAB	 STEEL BARS PROVIDED BY CONTRACTOR (G420) Fy=420 MPa. CONCRETE PROVIDED BY CONTRACTOR FOR COMPRESSIVE STRENGTH Fcu AS: -FOR R.C. COLUMNS & WALLS =35 MPa -FOR R.C. SLAB = 30 MPa -FOR R.C. FOOTINGS = 30 MPa -FOR R.C. LINTELS =25 MPa -FOR PLAIN CONCRET =20 MPa 		
OLUMN	 STEEL COVERS: -FOR FOODTINGS (CAST AGAINST SOIL) =7.5 cm (FOR PROTECTED CONCRETE) =5.0 cm -FOR COLUMNS AND BEAMS =4.0 cm -FOR WALLS =5.0 cm -FOR SLABS =2.5 cm MIN. LAP FOR STEEL BAR = 60cm OR 50 x DIA. BAR WHICH IS GREATER. T.L. : TOTAL LENGTH. FOUNDATIONS & COLUMNS ARE DESIGNED FOR UNDERGROUND, GROUND, & 3 STORIES. SOIL BEARING CAPACITY IS: 200 KN/m². 		
G. BEAM	FOR TENDER ONLY		
	CLIENT: PALESTINIAN NATIONAL AUTHORITY MINISTRY OF PUBLIC WORKS & HOUSING (MPWH)		
OUND.	EMPLOYER: THE UNITED NATIONS DEVELOPMENT PROGRAMME PROGRAMME OF ASSISTANCE TO THE PALESTINIAN PEOPLE (UNDP/PAPP)		
	PROJECT TITLE: CONSTRUCTION OF 100 HOUSING UNITS TO RE-HOUSE THE AFFECTED PALESTINIAN FAMILIES IN GAZA STRIP PROJECT NO.: PAL 10-00070416 (PACKAGE 07)		
	CONSULTANT: مرکزا لهند ست والتخطیط center for engineering and planning		
	BUILDING NAME: RESIDENTIAL BUILDING NO. (A7)		
	DRAWING TITLE: COLUMNS DETAILS (2/4)		
TAILS (1/3) Cale: as shown	DRAWING NO.:RE-S-008DATE:APRIL2011SCALE:ASSHOWN		

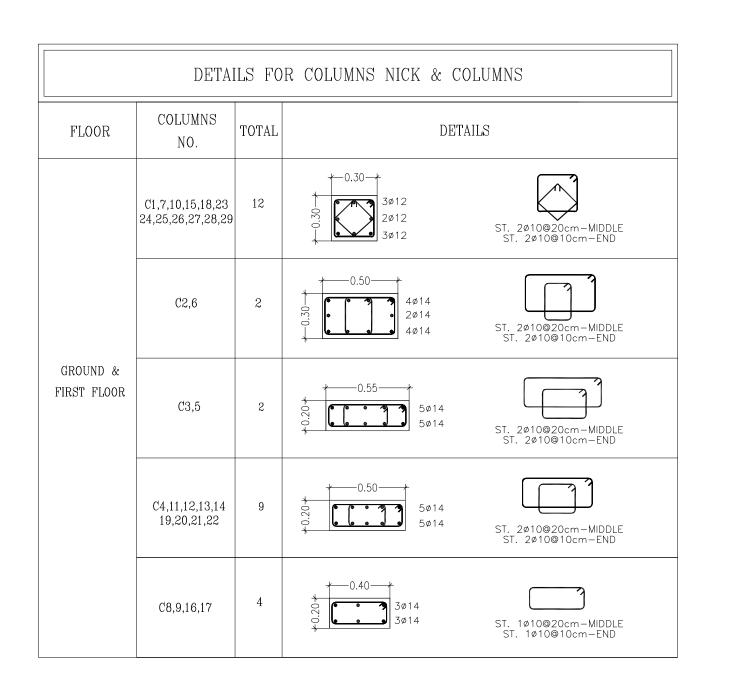


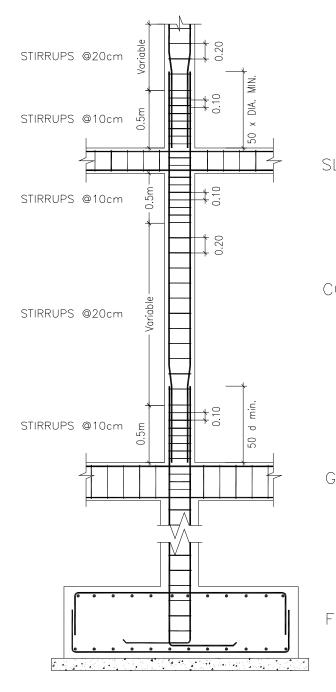


COLUMN STIRRUP SPACING

COLUMNS DE

	NOTES :-		
LAB	 IT IS THE CONTRACTOR RESPONSIBILITY TO PREPARE AND SUBMIT WORKSHOP DRAWINGS FOR ENGINEER BEFORE START WORKS. ALL OF THE STRUCTURAL DRAWINGS ARE TO BE READ IN CONJUCTION WITH THE PERTINENT ARCHITECTURAL, CIVIL DEFENSE AND OTHER STRUCTURAL DRAWINGS IF THERE IS ANY DISCREPANCY IN DRAWINGS, THE CONTRACTOR MUST CONSIDER IT IN HIS PRICE. CONCRETE SURFACE IN CONTACT WITH SOIL SHALL BE PAINTED 1–COAT PRIMER AND 2–COATS OF HOT BITUMEN. DESIGN CODE IS ACI 318–08. STEEL BARS PROVIDED BY CONTRACTOR (G420) Fy=420 MPa. CONCRETE PROVIDED BY CONTRACTOR FOR COMPRESSIVE STRENGTH Fcu AS: -FOR R.C. COLUMNS & WALLS =35 MPa -FOR R.C. FOOTINGS =30 MPa -FOR R.C. FOOTINGS =30 MPa 		
OLUMN	-FOR PLAIN CONCRET = 20 MPa - STEEL COVERS: -FOR FOODTINGS (CAST AGAINST SOIL) = 7.5 cm (FOR PROTECTED CONCRETE) = 5.0 cm -FOR COLUMNS AND BEAMS = 4.0 cm -FOR WALLS = 5.0 cm		
	-FOR SLABS =2.5 cm - MIN. LAP FOR STEEL BAR = 60cm OR 50 × DIA. BAR WHICH IS GREATER. - T.L. : TOTAL LENGTH. - FOUNDATIONS & COLUMNS ARE DESIGNED FOR UNDERGROUND, GROUND, & 3 STORIES. - SOIL BEARING CAPACITY IS: 200 KN/m ² .		
G. BEAM	CLIENT: PALESTINIAN NATIONAL AUTHORITY MINISTRY OF PUBLIC WORKS & HOUSING (MPWH)		
OUND.	EMPLOYER: THE UNITED NATIONS DEVELOPMENT PROGRAMME PROGRAMME OF ASSISTANCE TO THE UN PALESTINIAN PEOPLE UNDP/PAPP)		
	PROJECT TITLE: CONSTRUCTION OF 100 HOUSING UNITS TO RE-HOUSE THE AFFECTED PALESTINIAN FAMILIES IN GAZA STRIP PROJECT NO.: PAL 10-00070416 (PACKAGE 07)		
	CONSULTANT: مركزا لهندسة والتخطيط center for engineering and planning		
	BUILDING NAME: RESIDENTIAL BUILDING NO. (A7)		
	DRAWING TITLE: COLUMNS DETAILS (3/4)		
TAILS (2/3)	DRAWING NO.: RE-S-009		
CALE: AS SHOWN	DATE: APRIL 2011 SCALE: AS SHOWN		

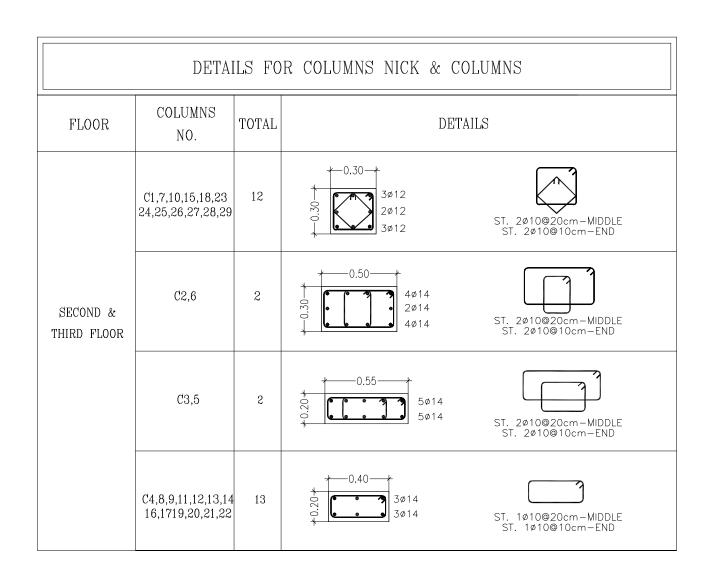

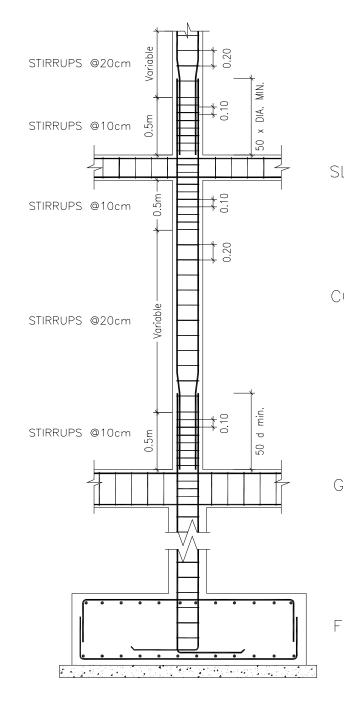


COLUMN STIRRUP SPACING


COLUMNS DE


SC


	NOTES :-		
LAB	 IT IS THE CONTRACTOR RESPONSIBILITY TO PREPARE AND SUBMIT WORKSHOP DRAWINGS FOR ENGINEER BEFORE START WORKS. ALL OF THE STRUCTURAL DRAWINGS ARE TO BE READ IN CONJUCTION WITH THE PERTINENT ARCHITECTURAL, CIVIL DEFENSE AND OTHER STRUCTURAL DRAWINGS IF THERE IS ANY DISCREPANCY IN DRAWINGS, THE CONTRACTOR MUST CONSIDER IT IN HIS PRICE. CONCRETE SURFACE IN CONTACT WITH SOIL SHALL BE PAINTED 1–COAT PRIMER AND 2–COATS OF HOT BITUMEN. DESIGN CODE IS ACI 318–08. STEEL BARS PROVIDED BY CONTRACTOR (G420) Fy=420 MPa. CONCRETE PROVIDED BY CONTRACTOR FOR COMPRESSIVE STRENGTH FCU AS: -FOR R.C. CLUMNS & WALLS =35 MPa -FOR R.C. SLAB = 30 MPa -FOR R.C. LINTELS = 25 MPa 		
	-FOR PLAIN CONCRET = 20 MPa - STEEL COVERS: -FOR FODOTINGS (CAST AGAINST SOIL) =7.5 cm		
OLUMN	 (FOR PROTECTED CONCRETE) =5.0 cm -FOR COLUMNS AND BEAMS =4.0 cm -FOR WALLS =5.0 cm -FOR SLABS =2.5 cm MIN. LAP FOR STEEL BAR = 60cm OR 50 × DIA. BAR WHICH IS GREATER. T.L. : TOTAL LENGTH. - FOUNDATIONS & COLUMNS ARE DESIGNED FOR UNDERGROUND, GROUND, & 3 STORIES. - SOIL BEARING CAPACITY IS: 200 KN/m². 		
. BEAM	FOR TENDER ONLY		
DLAW	CLIENT: PALESTINIAN NATIONAL AUTHORITY MINISTRY OF PUBLIC WORKS & HOUSING (MPWH)		
OUND.	EMPLOYER: THE UNITED NATIONS DEVELOPMENT PROGRAMME PROGRAMME OF ASSISTANCE TO THE UN PALESTINIAN PEOPLE UNDP/PAPP)		
	PROJECT TITLE: CONSTRUCTION OF 100 HOUSING UNITS TO RE-HOUSE THE AFFECTED PALESTINIAN FAMILIES IN GAZA STRIP PROJECT NO.: PAL 10-00070416 (PACKAGE 07)		
	CONSULTANT: مركزالهندسة والتخطيط center for engineering and planning		
	BUILDING NAME: RESIDENTIAL BUILDING NO. (A7)		
	DRAWING TITLE: COLUMNS DETAILS (4/4)		
TAILS (3/3)	DRAWING NO.: RE-S-010		
CALE: AS SHOWN	DATE: APRIL 2011 SCALE: AS SHOWN		

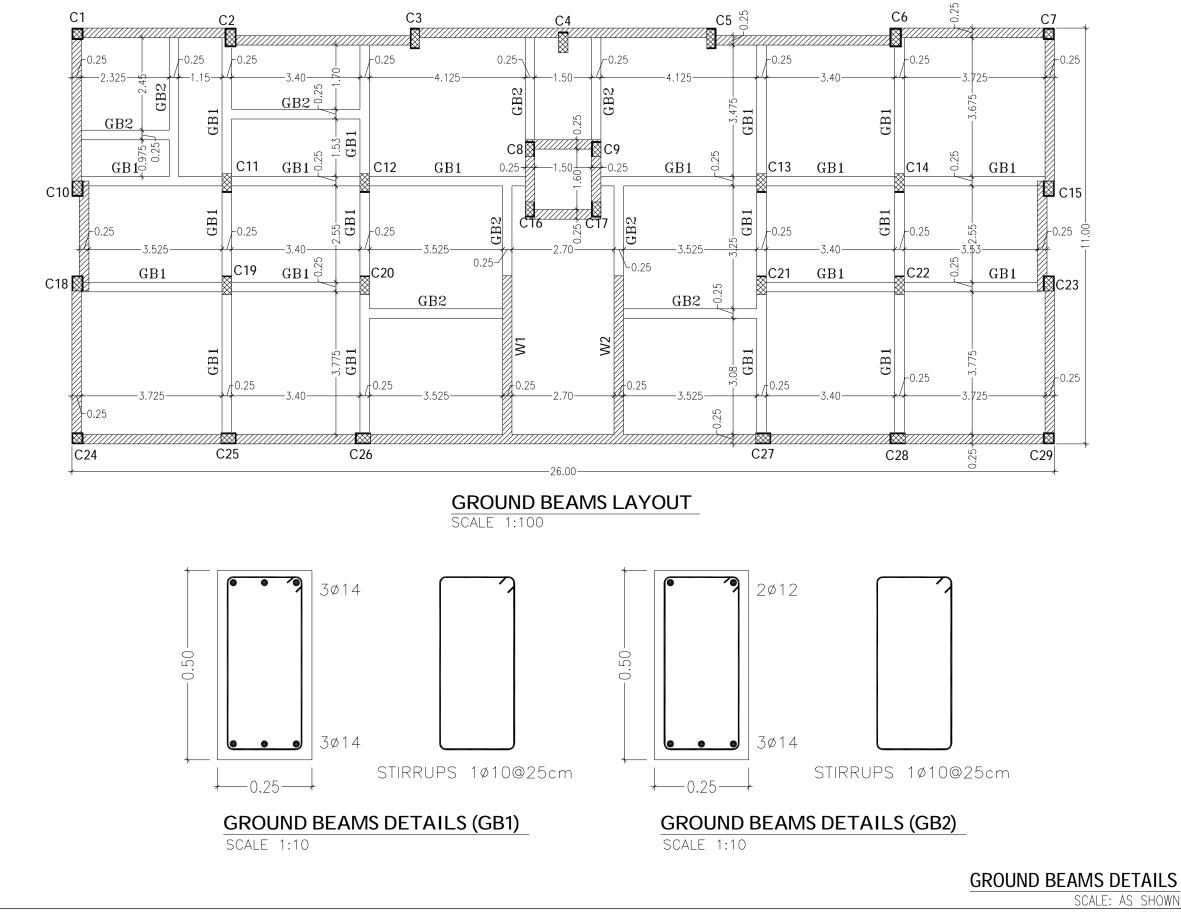

-	
-	 IT IS THE CONTRACTOR RESPONSIBILITY TO PREPARE AND SUBMIT WORKSHOP DRAWINGS FOR ENGINEER BEFORE START WORKS. ALL OF THE STRUCTURAL DRAWINGS ARE TO BE READ IN CONJUCTION WITH THE PERTINENT ARCHITECTURAL, CIVIL DEFENSE AND OTHER STRUCTURAL DRAWINGS IF THERE IS ANY DISCREPANCY IN DRAWINGS, THE CONTRACTOR MUST CONSIDER IT IN HIS PRICE. CONCRETE SURFACE IN CONTACT WITH SOIL SHALL BE PAINTED 1-COAT PRIMER AND 2-COATS OF HOT BITUMEN. DESIGN CODE IS ACI 318-08. STEEL BARS PROVIDED BY CONTRACTOR (G420) Fy=420 MPo. CONCRETE PROVIDED BY CONTRACTOR FOR COMPRESSIVE STRENGTH Fou AS:
	-FOR R.C. COLUMNS & WALLS = 35 MPa -FOR R.C. COLUMNS & WALLS = 30 MPa -FOR R.C. SLAB = 30 MPa -FOR R.C. FOOTINGS = 30 MPa -FOR R.C. LINTELS = 25 MPa -FOR PLAIN CONCRET = 20 MPa -FOR FOOOTINGS (CAST AGAINST SOIL) = 7.5 cm (FOR PROTECTED CONCRETE) = 5.0 cm -FOR COLUMNS AND BEAMS = 4.0 cm
-	-FOR COLUMNS AND BEAMS =4.0 cm -FOR WALLS =5.0 cm -FOR SLABS =2.5 cm MIN. LAP FOR STEEL BAR = 60cm OR 50 x DIA. BAR WHICH IS GREATER. T.L. : TOTAL LENGTH. FOUNDATIONS & COLUMNS ARE DESIGNED FOR UNDERGROUND, GROUND, & 3 STORIES. SOIL BEARING CAPACITY IS: 200 KN/m ² .
	FOR TENDER ONLY
	CLIENT: PALESTINIAN NATIONAL AUTHORITY MINISTRY OF PUBLIC WORKS & HOUSING (MPWH)
	EMPLOYER: THE UNITED NATIONS DEVELOPMENT PROGRAMME PROGRAMME OF ASSISTANCE TO THE UN PALESTINIAN PEOPLE UNDP/PAPP)
	PROJECT TITLE: CONSTRUCTION OF 100 HOUSING UNITS TO RE-HOUSE THE AFFECTED PALESTINIAN FAMILIES IN GAZA STRIP PROJECT NO.: PAL 10-00070416 (PACKAGE 07)
	CONSULTANT: درکزالهزد سقوالتخطیط center for engineering and planning
	CONSULTANT: مرکزالهند سقوالتخطیط
	CONSULTANT: مرکزالسند سق والتخطیط center for engineering and planning BUILDING NAME:
	CONSULTANT: التخطيط center for engineering and planning BUILDING NAME: RESIDENTIAL BUILDING NO. (A7) DRAWING TITLE:

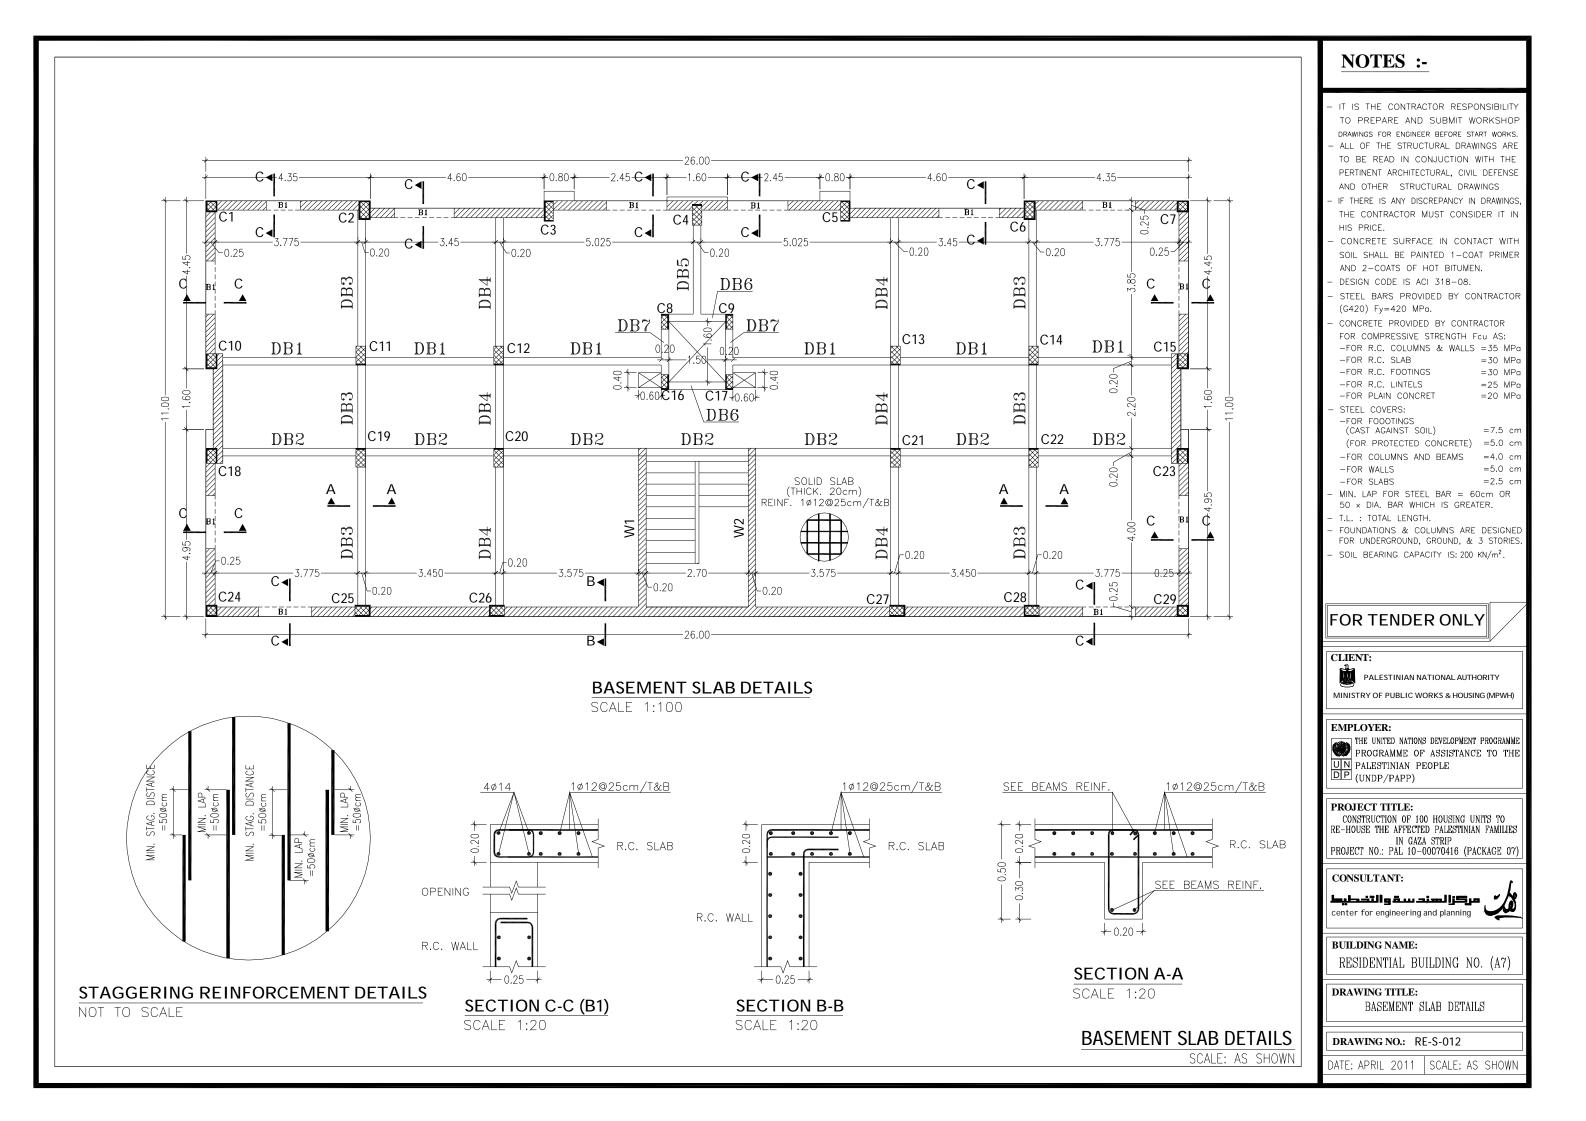

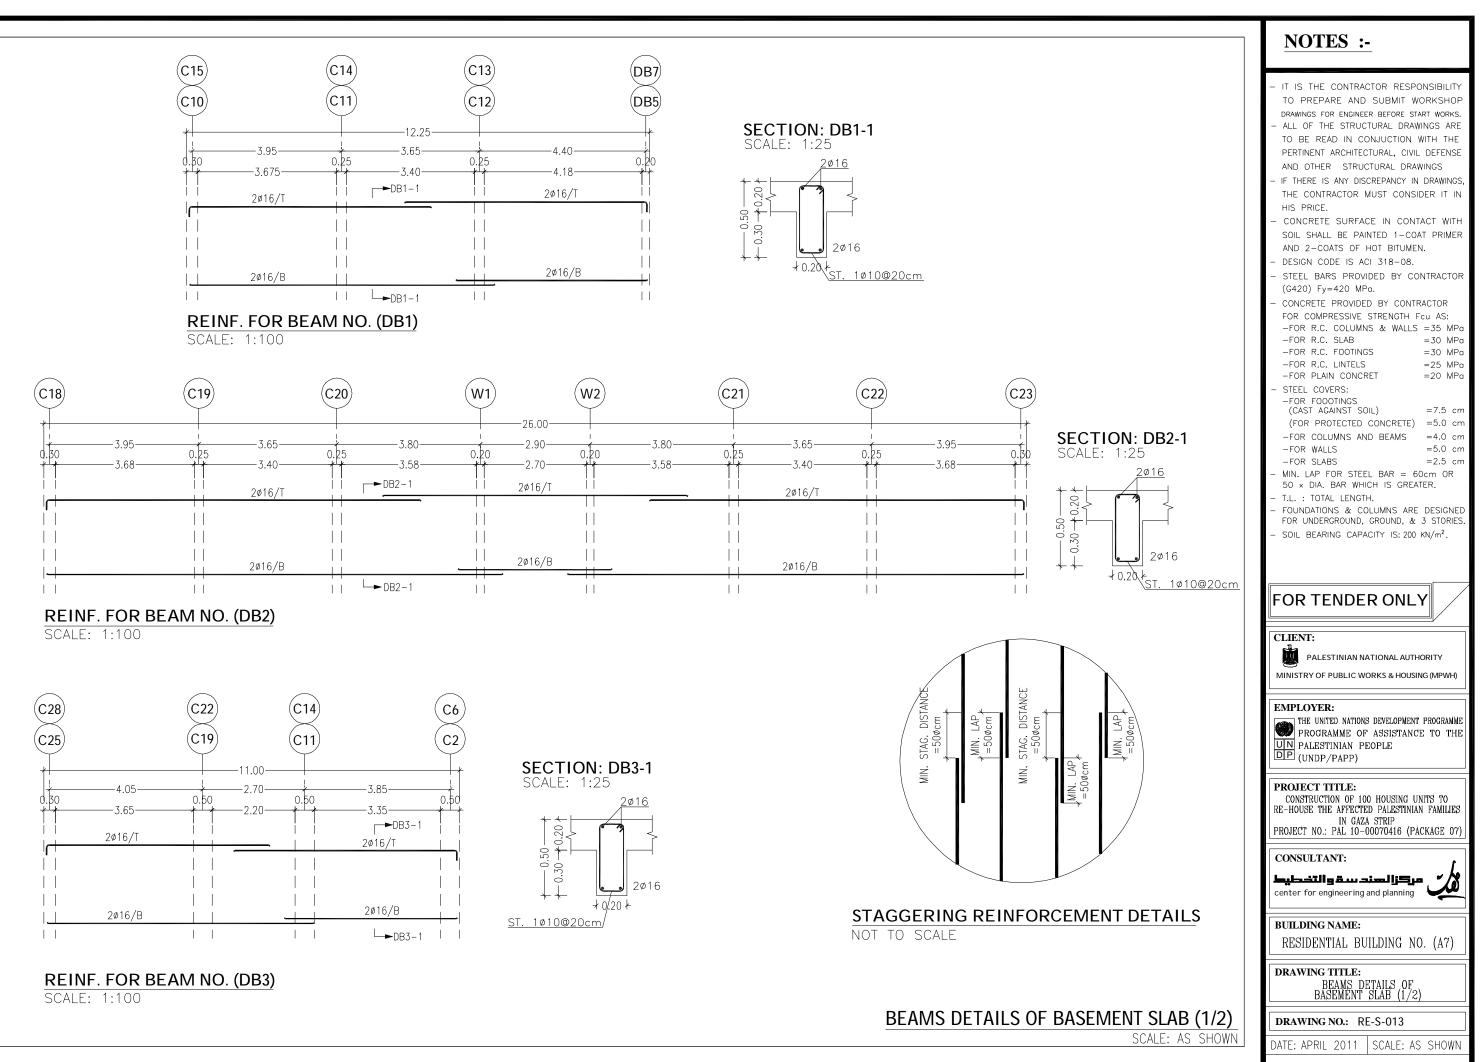

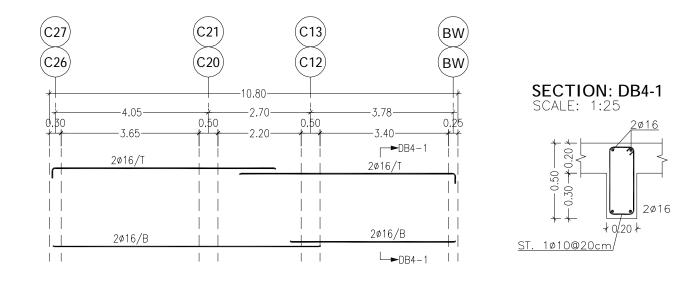

REINF. FOR BEAM NO. (DB4) SCALE: 1:100


BEAMS REINFORCEMENT TABLE FOR GROUND SLAB

NO.	DIM		воттом	TOP	STIRRUPS
	<i>W</i> .	Н.	REINF.	REINF.	
DB5	20	50	2ø16	2ø16	1ø10/20cm
DB6	20	50	2ø16	2ø16	1ø10/20cm
DB7	20	50	2ø16	2ø16	1ø10/20cm

BEAMS DETAILS OF BASEMENT SLAB (2/2)


	 IT IS THE CONTRACTOR RESPONSIBILITY TO PREPARE AND SUBMIT WORKSHOP DRAWINGS FOR ENGINEER BEFORE START WORKS.
	 ALL OF THE STRUCTURAL DRAWINGS ARE TO BE READ IN CONJUCTION WITH THE PERTINENT ARCHITECTURAL, CIVIL DEFENSE
	AND OTHER STRUCTURAL DRAWINGS – IF THERE IS ANY DISCREPANCY IN DRAWINGS, THE CONTRACTOR MUST CONSIDER IT IN
	HIS PRICE. — CONCRETE SURFACE IN CONTACT WITH SOIL SHALL BE PAINTED 1—COAT PRIMER AND 2—COATS OF HOT BITUMEN.
	 DESIGN CODE IS ACI 318-08. STEEL BARS PROVIDED BY CONTRACTOR (G420) Fy=420 MPa.
	 CONCRETE PROVIDED BY CONTRACTOR FOR COMPRESSIVE STRENGTH Fcu AS: FOR R.C. COLUMNS & WALLS = 35 MPa FOR R.C. SLAB = 30 MPa
	-FOR R.C. FOOTINGS = 30 MPo -FOR R.C. LINTELS = 25 MPo -FOR PLAIN CONCRET = 20 MPo - STEEL COVERS:
	-FOR FOODTINGS (CAST AGAINST SOIL) =7.5 cm (FOR PROTECTED CONCRETE) =5.0 cm -FOR COLUMNS AND BEAMS =4.0 cm
	 FOR WALLS =5.0 cm FOR SLABS =2.5 cm MIN. LAP FOR STEEL BAR = 60cm OR 50 x DIA. BAR WHICH IS GREATER.
	 T.L. : TOTAL LENGTH. FOUNDATIONS & COLUMNS ARE DESIGNED FOR UNDERGROUND, GROUND, & 3 STORIES. SOIL BEARING CAPACITY IS: 200 KN/m².
	FOR TENDER ONLY
	FOR TENDER ONLY
	CLIENT: PALESTINIAN NATIONAL AUTHORITY
	CLIENT: PALESTINIAN NATIONAL AUTHORITY MINISTRY OF PUBLIC WORKS & HOUSING (MPWH) EMPLOYER: THE UNITED NATIONS DEVELOPMENT PROGRAMME PROGRAMME OF ASSISTANCE TO THE PALESTINIAN PEOPLE
	CLIENT: PALESTINIAN NATIONAL AUTHORITY MINISTRY OF PUBLIC WORKS & HOUSING (MPWH) EMPLOYER: THE UNITED NATIONS DEVELOPMENT PROGRAMME PROGRAMME OF ASSISTANCE TO THE PROGRAMME OF ASSISTANCE TO THE UN PALESTINIAN PEOPLE (UNDP/PAPP) PROJECT TITLE: CONSTRUCTION OF 100 HOUSING UNITS TO RE-HOUSE THE AFFECTED PALESTINIAN FAMILIES IN GAZA STRIP
	CLIENT: PALESTINIAN NATIONAL AUTHORITY MINISTRY OF PUBLIC WORKS & HOUSING (MPWH) EMPLOYER: THE UNITED NATIONS DEVELOPMENT PROGRAMME PROGRAMME OF ASSISTANCE TO THE PROGRAMME OF ASSISTANCE TO THE UIN PALESTINIAN PEOPLE (UNDP/PAPP) PROJECT TITLE: CONSTRUCTION OF 100 HOUSING UNITS TO RE-HOUSE THE AFFECTED PALESTINIAN FAMILIES IN GAZA STRIP PROJECT NO.: PAL 10-00070416 (PACKAGE 07) CONSULTANT: Lucuting Bun simplify (Marchaeler)
	CLIENT: PALESTINIAN NATIONAL AUTHORITY MINISTRY OF PUBLIC WORKS & HOUSING (MPWH) EMPLOYER: THE UNITED NATIONS DEVELOPMENT PROGRAMME PROGRAMME OF ASSISTANCE TO THE PROJECT TITLE: (UNDP/PAPP) PROJECT TITLE: CONSTRUCTION OF 100 HOUSING UNITS TO RE-HOUSE THE AFFECTED PALESTINIAN FAMILIES IN GAZA STRIP PROJECT NO.: PAL 10-00070416 (PACKAGE 07) CONSULTANT: Lubertillg Bau signalijspr center for engineering and planning BUILDING NAME:
) N	CLIENT: PALESTINIAN NATIONAL AUTHORITY MINISTRY OF PUBLIC WORKS & HOUSING (MPWH) EMPLOYER: THE UNITED NATIONS DEVELOPMENT PROGRAMME PROGRAMME OF ASSISTANCE TO THE PROJECT TITLE: (UNDP/PAPP) PROJECT TITLE: CONSTRUCTION OF 100 HOUSING UNITS TO RE-HOUSE THE AFFECTED PALESTINIAN FAMILIES IN GAZA STRIP PROJECT NO.: PAL 10-00070416 (PACKAGE 07) CONSULTANT: Lab-STIL BALL SUILDING NO. (A7) BUILDING NAME: RESIDENTIAL BUILDING NO. (A7)



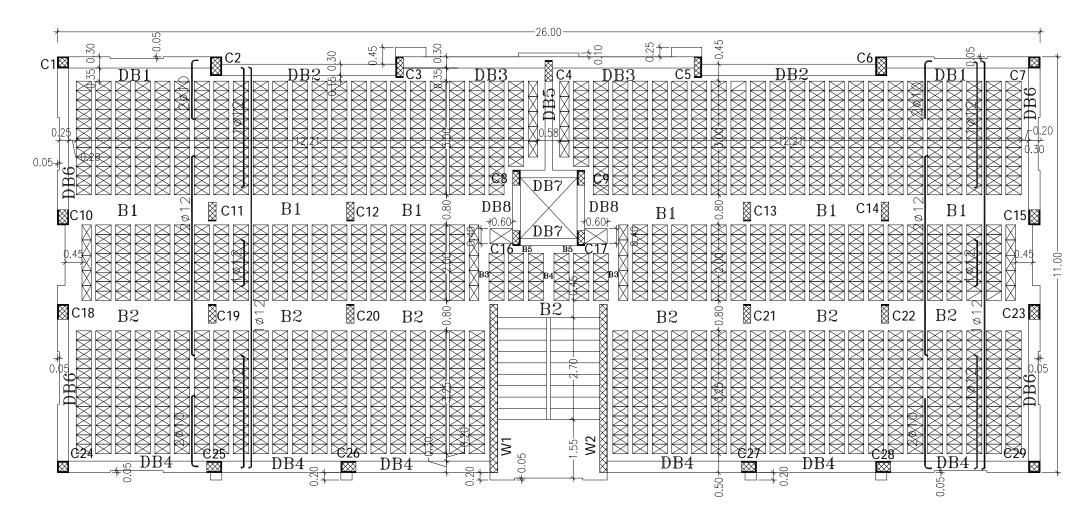

REINF. DETAILS FOR TYPICAL SLAB

SCALE 1:100

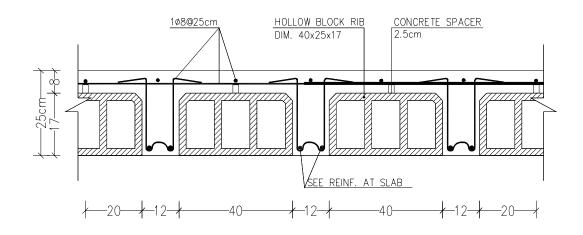

SECTION DETAIL FOR RIBS

NOT TO SCALE


DISTANCE DIS STAG. [=50øc MIN. STAG. =50ø MIN.


STAGGERING REINFORCEMENT DETAILS NOT TO SCALE


> **TYPICAL SLAB** SCALE

NOTES .

	NOTES :-			
	 IT IS THE CONTRACTOR RESPONSIBILITY TO PREPARE AND SUBMIT WORKSHOP DRAWINGS FOR ENGINEER BEFORE START WORKS. ALL OF THE STRUCTURAL DRAWINGS ARE TO BE READ IN CONJUCTION WITH THE PERTINENT ARCHITECTURAL, CIVIL DEFENSE AND OTHER STRUCTURAL DRAWINGS IF THERE IS ANY DISCREPANCY IN DRAWINGS, THE CONTRACTOR MUST CONSIDER IT IN HIS PRICE. CONCRETE SURFACE IN CONTACT WITH SOIL SHALL BE PAINTED 1-COAT PRIMER AND 2-COATS OF HOT BITUMEN. DESIGN CODE IS ACI 318-08. STEEL BARS PROVIDED BY CONTRACTOR (G420) Fy=420 MPa. CONCRETE PROVIDED BY CONTRACTOR FOR COMPRESSIVE STRENGTH Fcu AS: -FOR R.C. COLUMNS & WALLS =35 MPa -FOR R.C. COLUMNS & WALLS =35 MPa -FOR R.C. COTINGS = 30 MPa -FOR R.C. LINTELS = 25 MPa -FOR R.C. LINTELS = 25 MPa -FOR R.C. CONCRET = 20 MPa STEEL COVERS: -FOR FOOOTINGS (CAST AGAINST SOIL) =7.5 cm (FOR POTECTED CONCRETE) =5.0 cm -FOR COLUMNS AND BEAMS =4.0 cm -FOR WALLS =5.0 cm FOR WALLS = 5.0 cm FOR WALLS = 5.0 cm FOR WALLS = 5.0 cm FOR SLABS =2.5 cm MIN. LAP FOR STEEL BAR = 60cm OR 50 × DIA. BAR WHICH IS GREATER. T.L. : TOTAL LENGTH. FOUNDATIONS & COLUMNS ARE DESIGNED FOR UNDERGROUND, GROUND, & 3 STORIES. SOIL BEARING CAPACITY IS: 200 KN/m². 			
	FOR TENDER ONLY			
	MINISTRY OF PUBLIC WORKS & HOUSING (MPWH) EMPLOYER: THE UNITED NATIONS DEVELOPMENT PROGRAMME PROGRAMME OF ASSISTANCE TO THE PALESTINIAN PEOPLE DP (UNDP/PAPP)			
	PROJECT TITLE: CONSTRUCTION OF 100 HOUSING UNITS TO RE-HOUSE THE AFFECTED PALESTINIAN FAMILIES IN GAZA STRIP PROJECT NO.: PAL 10-00070416 (PACKAGE 07)			
	CONSULTANT: مركزا لهند سقو التخطيط center for engineering and planning			
	BUILDING NAME: RESIDENTIAL BUILDING NO. (A7)			
	DRAWING TITLE: TYPICAL SLAB DETAILS			
	DRAWING NO.: RE-S-015			
: AS SHOWN	DATE: APRIL 2011 SCALE: AS SHOWN			

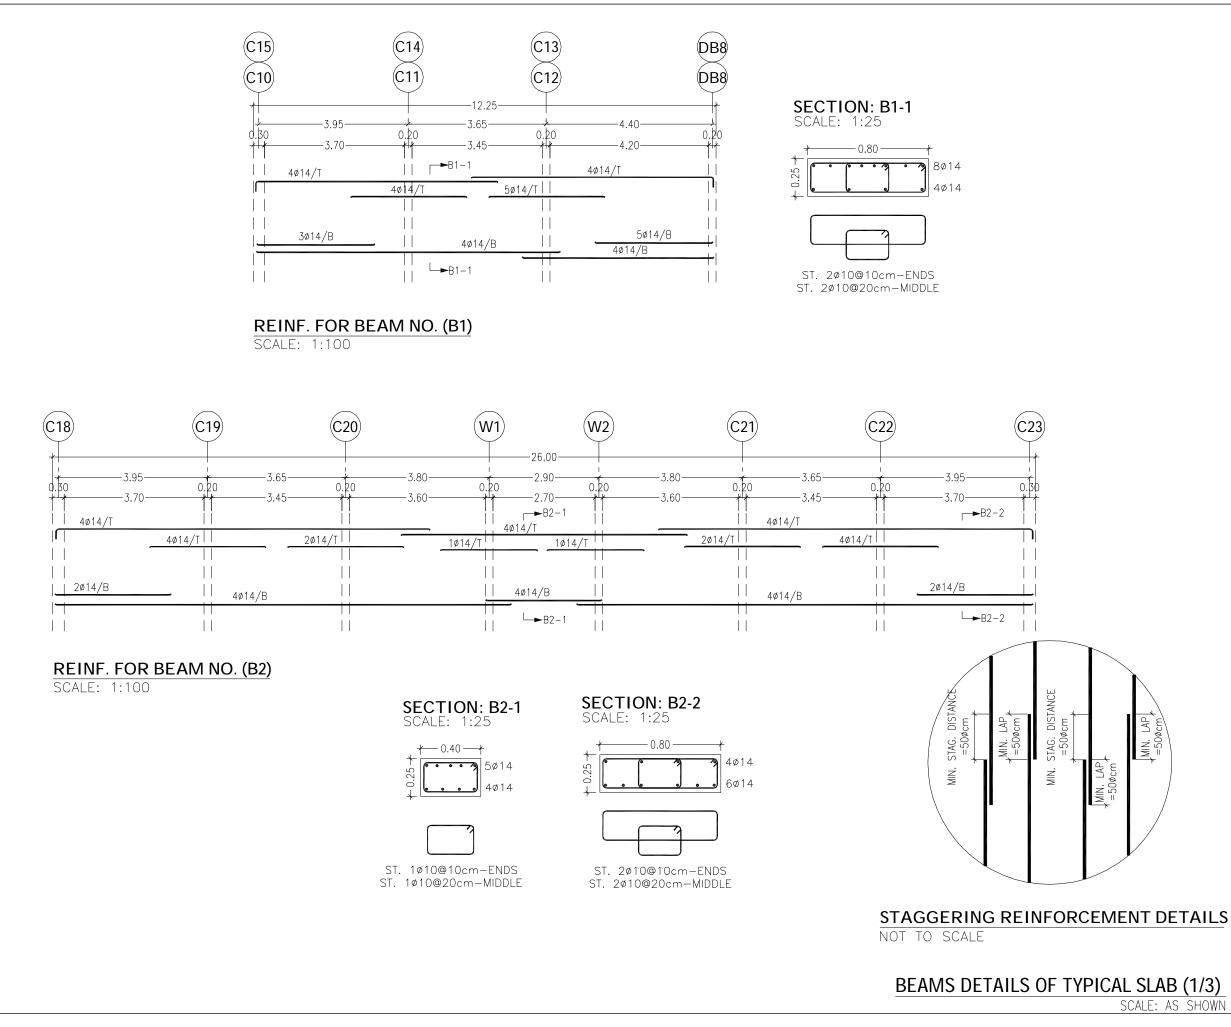


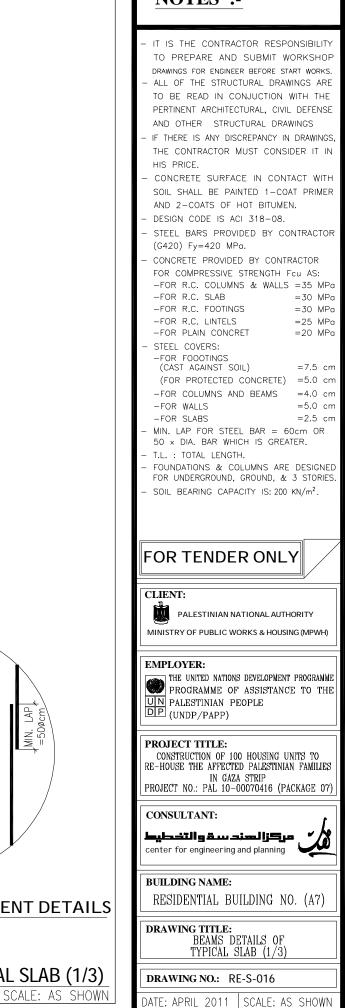


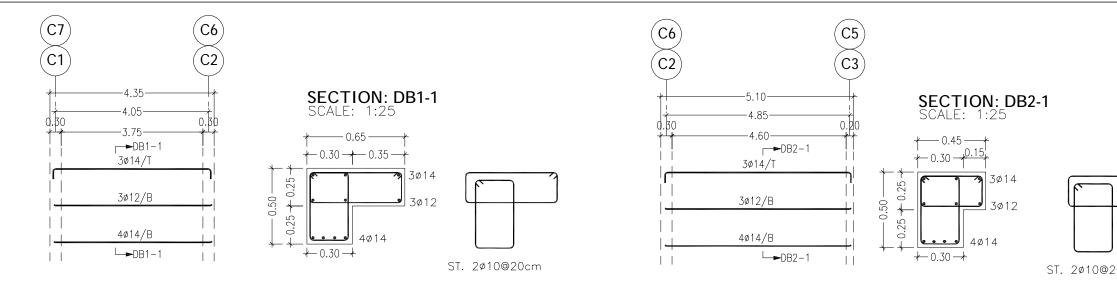

REINF. FOR BEAM NO. (DB1)

SCALE: 1:100

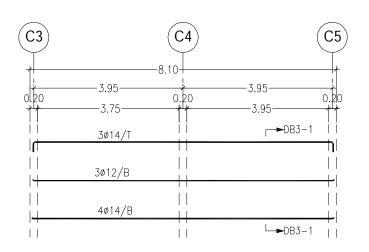

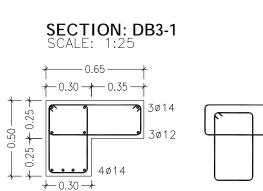

ST. 2ø10@20cm

SECTION: DB4-1 SCALE: 1:25

4ø14

7 3ø14

y 3ø12

ST. 2ø10@20cm

★ 0.50 **★**

+ 0.30 + 0.20 +

+−0.30 +


- 0.25

- 0.50 -- 0.25 + 0

+ +

REINF. FOR BEAM NO. (DB3)

SCALE: 1:100

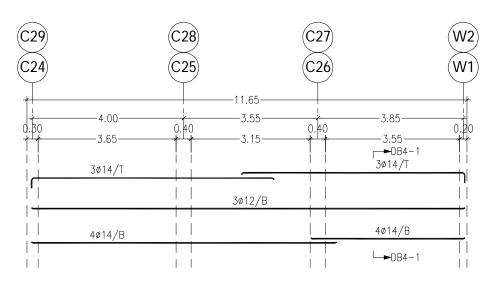




SCALE: 1:100

BEAMS DETAILS OF TYPICAL SL

SCAL

) 20cm	 IT IS THE CONTRACTOR RESPONSIBILITY TO PREPARE AND SUBMIT WORKSHOP DRAWINGS FOR ENGINEER BEFORE START WORKS. ALL OF THE STRUCTURAL DRAWINGS ARE TO BE READ IN CONJUCTION WITH THE PERTINENT ARCHITECTURAL, CIVIL DEFENSE AND OTHER STRUCTURAL DRAWINGS IF THERE IS ANY DISCREPANCY IN DRAWINGS, THE CONTRACTOR MUST CONSIDER IT IN HIS PRICE. CONCRETE SURFACE IN CONTACT WITH SOIL SHALL BE PAINTED 1-COAT PRIMER AND 2-COATS OF HOT BITUMEN. DESIGN CODE IS ACI 318-08. STEEL BARS PROVIDED BY CONTRACTOR (G420) Fy=420 MPa. CONCRETE PROVIDED BY CONTRACTOR FOR R.C. COLUMNS & WALLS =35 MPa -FOR R.C. LINTELS =25 MPa -FOR R.C. LINTELS =25 MPa -FOR R.C. LINTELS =25 MPa -FOR R.C. LINTELS =25 MPa -FOR RC. COLUMNS AND BEAMS =4.0 cm -FOR RODTINGS (CAST AGAINST SOIL) =7.5 cm (FOR PROTECTED CONCRETE) =5.0 cm -FOR SLABS =2.5 cm MIN. LAP FOR STEEL BAR = 60cm OR 50 × DIA. BAR WHICH IS GREATER. T.L. : TOTAL LENGTH. FOUNDATIONS & COLUMNS ARE DESIGNED FOR UNDERGROUND, GROUND, & 3 STORIES. SOIL BEARING CAPACITY IS: 200 KN/m².
	FOR TENDER ONLY
	EMPLOYER: THE UNITED NATIONS DEVELOPMENT PROGRAMME PROGRAMME OF ASSISTANCE TO THE UN PALESTINIAN PEOPLE DP (UNDP/PAPP)
	PROJECT TITLE: CONSTRUCTION OF 100 HOUSING UNITS TO RE-HOUSE THE AFFECTED PALESTINIAN FAMILIES IN GAZA STRIP PROJECT NO.: PAL 10-00070416 (PACKAGE 07)
	CONSULTANT: طركزا لهند سق والتخطيط center for engineering and planning
	BUILDING NAME: RESIDENTIAL BUILDING NO. (A7)
	DRAWING TITLE: BEAMS DETAILS OF TYPICAL SLAB (2/3)
_AB (2/3)	DRAWING NO.: RE-S-017
E: AS SHOWN	DATE: APRIL 2011 SCALE: AS SHOWN

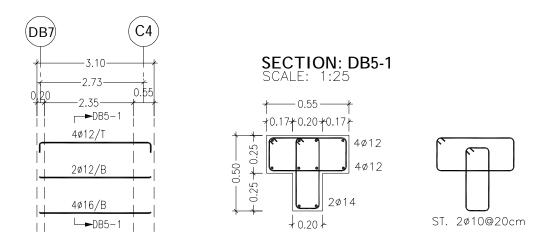

REINF. FOR BEAM NO. (DB5)

SCALE: 1:100


BEAMS REINFORCEMENT TABLE FOR TYPICAL SLAB

NO.	DIM BOTTOM		ТОР	STIRRUPS	
	<i>W</i> .	Н.	REINF.	REINF.	,
DB6	30	50	4ø16	2ø12	1ø10/20cm
DB7	20	40	2ø14	2ø12	1ø10/20cm
DB8	20	40	2ø14	2ø12	1ø10/20cm
<i>B3</i>	25	25	2ø12	2ø12	1ø10/20cm
<i>B4</i>	25	25	2ø12	2ø12	1ø10/20cm
B5	20	25	2ø14	2ø12	1ø10/20cm


NOTES :-


	- IT IS THE CONTRACTOR RESPONSIBILITY				
	TO PREPARE AND SUBMIT WORKSHOP				
	DRAWINGS FOR ENGINEER BEFORE START WORKS. - ALL OF THE STRUCTURAL DRAWINGS ARE				
	TO BE READ IN CONJUCTION WITH THE PERTINENT ARCHITECTURAL, CIVIL DEFENSE				
	AND OTHER STRUCTURAL DRAWINGS				
	 IF THERE IS ANY DISCREPANCY IN DRAWINGS, THE CONTRACTOR MUST CONSIDER IT IN 				
	HIS PRICE.				
	 CONCRETE SURFACE IN CONTACT WITH SOIL SHALL BE PAINTED 1-COAT PRIMER 				
	AND 2-COATS OF HOT BITUMEN.				
	 DESIGN CODE IS ACI 318-08. STEEL BARS PROVIDED BY CONTRACTOR 				
	(G420) Fy=420 MPa.				
	 CONCRETE PROVIDED BY CONTRACTOR FOR COMPRESSIVE STRENGTH Fcu AS: 				
	-FOR R.C. COLUMNS & WALLS =35 MPa				
	-FOR R.C. SLAB = 30 MPa -FOR R.C. FOOTINGS = 30 MPa				
	–FOR R.C. LINTELS =25 MPa –FOR PLAIN CONCRET =20 MPa				
	- STEEL COVERS:				
	-FOR FOOOTINGS (CAST AGAINST SOIL) =7.5 cm				
	(FOR PROTECTED CONCRETE) =5.0 cm -FOR COLUMNS AND BEAMS =4.0 cm				
	-FOR WALLS =5.0 cm				
	-FOR SLABS =2.5 cm - MIN. LAP FOR STEEL BAR = 60cm OR				
	50 × DIA. BAR WHICH IS GREATER. – T.L. : TOTAL LENGTH.				
	- FOUNDATIONS & COLUMNS ARE DESIGNED				
	FOR UNDERGROUND, GROUND, & 3 STORIES. - SOIL BEARING CAPACITY IS: 200 KN/m ² .				
	FOR TENDER ONLY				
	CLIENT:				
	PALESTINIAN NATIONAL AUTHORITY				
	MINISTRY OF PUBLIC WORKS & HOUSING (MPWH)				
	EMPLOYER:				
	THE UNITED NATIONS DEVELOPMENT PROGRAMME PROGRAMME OF ASSISTANCE TO THE				
	UN PALESTINIAN PEOPLE				
	UNDP/PAPP)				
	PROJECT TITLE:				
	CONSTRUCTION OF 100 HOUSING UNITS TO RE-HOUSE THE AFFECTED PALESTINIAN FAMILIES				
	IN GAZA STRIP PROJECT NO.: PAL 10-00070416 (PACKAGE 07)				
	CONSULTANT:				
	مركزالهندسة والتخطيط				
	center for engineering and planning				
	BUILDING NAME: RESIDENTIAL BUILDING NO. (A7)				
	DRAWING TITLE: BEAMS DETAILS OF				
	TYPICAL SLAB (3/3)				
3)	DRAWING NO.: RE-S-018				


SCALE: AS SHC

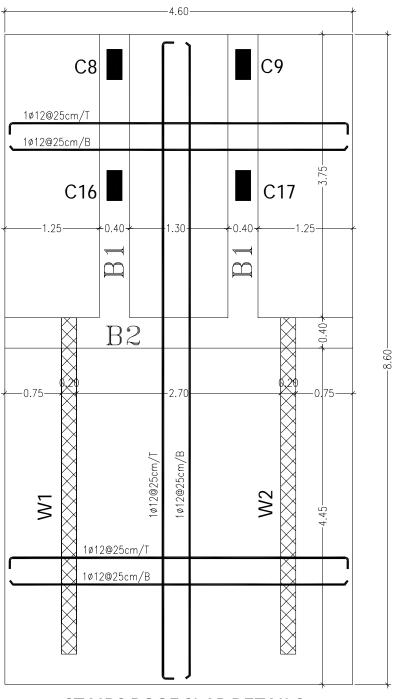

STAIRS ROOF SLAB DETAILS SCALE 1:50

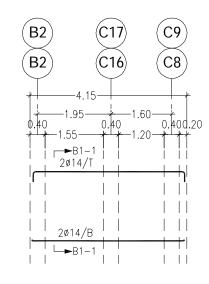

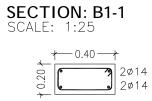


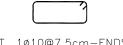


ST. 1ø10@7.5cm-ENDS ST. 1ø10@15cm-MIDDLE

REINF. FOR BEAM NO. (B1)

SCALE: 1:100

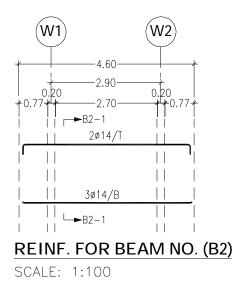



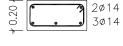




ST. 1ø10@7.5cm-ENDS ST. 1ø10@15cm-MIDDLE

NOTES :-


 IT IS THE CONTRACTOR RESPONSIBILITY TO PREPARE AND SUBMIT WORKSHOP DRAWINGS FOR ENGINEER BEFORE START WORKS. ALL OF THE STRUCTURAL DRAWINGS ARE TO BE READ IN CONJUCTION WITH THE PERTINENT ARCHITECTURAL, CIVIL DEFENSE AND OTHER STRUCTURAL DRAWINGS. IF THERE IS ANY DISCREPANCY IN DRAWINGS, THE CONTRACTOR MUST CONSIDER IT IN HIS PRICE. CONCRETE SURFACE IN CONTACT WITH SOIL SHALL BE PAINTED 1-COAT PRIMER AND 2-COATS OF HOT BITUMEN. DESIGN CODE IS ACI 318-08. STEEL BARS PROVIDED BY CONTRACTOR 				
	 (G420) Fy=420 MPa. CONCRETE PROVIDED BY CONTRACTOR FOR COMPRESSIVE STRENGTH Fcu AS: -FOR R.C. CLUMNS & WALLS = 35 MPa -FOR R.C. SLAB = 30 MPa -FOR R.C. FOOTINGS = 30 MPa -FOR R.C. LINTELS = 25 MPa -FOR PLAIN CONCRET = 20 MPa - STEEL COVERS: -FOR FOODTINGS (CAST AGAINST SOIL) = 7.5 cm (FOR PROTECTED CONCRETE) = 5.0 cm -FOR COLUMNS AND BEAMS = 4.0 cm -FOR SLABS = 2.5 cm -FOR SLABS = 2.5 cm MIN. LAP FOR STEEL BAR = 60cm OR 50 x DIA. BAR WHICH IS GREATER. T.L.: TOTAL LENGTH. FOUNDATIONS & COLUMNS ARE DESIGNED FOR UNDERGROUND, GROUND, & 3 STORIES. SOIL BEARING CAPACITY IS: 200 KN/m². 			
	FOR TENDER ONLY			
	FOR TENDER ONLY			
	CLIENT: PALESTINIAN NATIONAL AUTHORITY			
	CLIENT: PALESTINIAN NATIONAL AUTHORITY MINISTRY OF PUBLIC WORKS & HOUSING (MPWH) EMPLOYER: THE UNITED NATIONS DEVELOPMENT PROGRAMME PROGRAMME OF ASSISTANCE TO THE UN PALESTINIAN PEOPLE			
	CLIENT: PALESTINIAN NATIONAL AUTHORITY MINISTRY OF PUBLIC WORKS & HOUSING (MPWH) EMPLOYER: PROGRAMME OF ASSISTANCE TO THE PROGRAMME OF ASSISTANCE TO THE UN PALESTINIAN PEOPLE DP (UNDP/PAPP) PROJECT TITLE: CONSTRUCTION OF 100 HOUSING UNITS TO RE-HOUSE THE AFFECTED PALESTINIAN FAMILIES IN GAZA STRIP			
	CLIENT: PALESTINIAN NATIONAL AUTHORITY MINISTRY OF PUBLIC WORKS & HOUSING (MPWH) EMPLOYER: THE UNITED NATIONS DEVELOPMENT PROGRAMME PROGRAMME OF ASSISTANCE TO THE PROGRAMME OF ASSISTANCE TO THE UNN PALESTINIAN PEOPLE UNN PALESTINIAN PEOPLE (UNDP/PAPP) PROJECT TITLE: CONSTRUCTION OF 100 HOUSING UNITS TO RE-HOUSE THE AFFECTED PALESTINIAN FAMILIES IN GAZA STRIP PROJECT NO.: PAL 10-00070416 (PACKAGE 07) CONSULTANT: Lubiting Builing builing by			
	CLIENT: PALESTINIAN NATIONAL AUTHORITY MINISTRY OF PUBLIC WORKS & HOUSING (MPWH) EMPLOYER: THE UNITED NATIONS DEVELOPMENT PROGRAMME PROGRAMME OF ASSISTANCE TO THE UN PALESTINIAN PEOPLE DIP (UNDP/PAPP) PROJECT TITLE: CONSTRUCTION OF 100 HOUSING UNITS TO RE-HOUSE THE AFFECTED PALESTINIAN FAMILIES IN GAZA STRIP PROJECT NO.: PAL 10-00070416 (PACKAGE 07) CONSULTANT: Labertillg and planning Center for engineering and planning			
	CLIENT: PALESTINIAN NATIONAL AUTHORITY MINISTRY OF PUBLIC WORKS & HOUSING (MPWH) EMPLOYER: THE UNITED NATIONS DEVELOPMENT PROGRAMME PROGRAMME OF ASSISTANCE TO THE UN PALESTINIAN PEOPLE DP (UNDP/PAPP) PROJECT TITLE: CONSTRUCTION OF 100 HOUSING UNITS TO RE-HOUSE THE AFFECTED PALESTINIAN FAMILIES IN GAZA STRIP PROJECT NO.: PAL 10-00070416 (PACKAGE 07) CONSULTANT: LLD-STIL BUILDING NO. (A7) BUILDING NAME: RESIDENTIAL BUILDING NO. (A7)			

SCALE: AS SHOWN

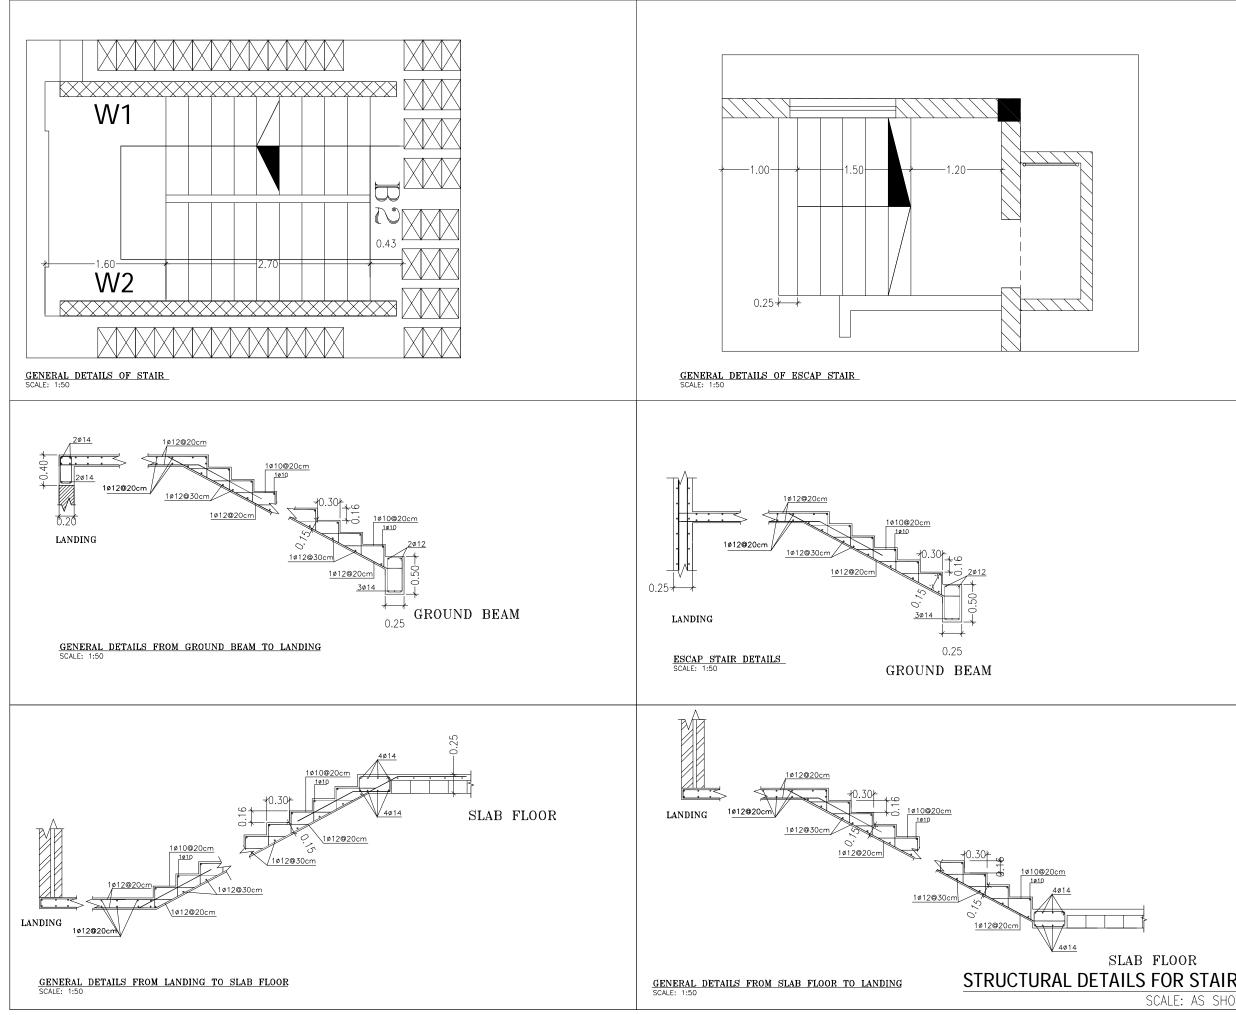

	 IT IS THE CONTRACTOR RESPONSIBILITY TO PREPARE AND SUBMIT WORKSHOP
	DRAWINGS FOR ENGINEER BEFORE START WORKS. – ALL OF THE STRUCTURAL DRAWINGS ARE TO BE READ IN CONJUCTION WITH THE PERTINENT ARCHITECTURAL, CIVIL DEFENSE
	AND OTHER STRUCTURAL DRAWINGS - IF THERE IS ANY DISCREPANCY IN DRAWINGS, THE CONTRACTOR MUST CONSIDER IT IN
	HIS PRICE. - CONCRETE SURFACE IN CONTACT WITH SOIL SHALL BE PAINTED 1-COAT PRIMER
	AND 2-COATS OF HOT BITUMEN. - DESIGN CODE IS ACI 318-08. - STEEL BARS PROVIDED BY CONTRACTOR
	 (G420) Fy=420 MPa. CONCRETE PROVIDED BY CONTRACTOR FOR COMPRESSIVE STRENGTH Fcu AS: FOR R.C. COLUMNS & WALLS =35 MPa
	-FOR R.C. SLAB = 30 MPa -FOR R.C. FOOTINGS = 30 MPa -FOR R.C. LINTELS = 25 MPa -FOR PLAIN CONCRET = 20 MPa
	 STEEL COVERS: FOR FOODTINGS (CAST AGAINST SOIL) =7.5 cm (FOR PROTECTED CONCRETE) =5.0 cm
	-FOR COLUMNS AND BEAMS=4.0 cm-FOR WALLS=5.0 cm-FOR SLABS=2.5 cm
	 MIN. LAP FOR STELL BAR = 60cm OR 50 × DIA. BAR WHICH IS GREATER. T.L. : TOTAL LENGTH. FOUNDATIONS & COLUMNS ARE DESIGNED FOR UNDERGROUND, GROUND, & 3 STORIES.
	- SOIL BEARING CAPACITY IS: 200 KN/m ² .
	FOR TENDER ONLY
	CLIENT: PALESTINIAN NATIONAL AUTHORITY
	CLIENT:
	CLIENT: PALESTINIAN NATIONAL AUTHORITY
	CLIENT: PALESTINIAN NATIONAL AUTHORITY MINISTRY OF PUBLIC WORKS & HOUSING (MPWH) EMPLOYER: THE UNITED NATIONS DEVELOPMENT PROGRAMME PROGRAMME OF ASSISTANCE TO THE UN PALESTINIAN PEOPLE
	CLIENT: PALESTINIAN NATIONAL AUTHORITY MINISTRY OF PUBLIC WORKS & HOUSING (MPWH) EMPLOYER: PROGRAMME OF ASSISTANCE TO THE PROGRAMME OF ASSISTANCE TO THE UN PALESTINIAN PEOPLE DIP (UNDP/PAPP) PROJECT TITLE: CONSTRUCTION OF 100 HOUSING UNITS TO RE-HOUSE THE AFFECTED PALESTINIAN FAMILIES IN GAZA STRIP
	CLIENT: PALESTINIAN NATIONAL AUTHORITY MINISTRY OF PUBLIC WORKS & HOUSING (MPWH) EMPLOYER: PROGRAMME OF ASSISTANCE TO THE PROGRAMME OF ASSISTANCE TO THE UN PALESTINIAN PEOPLE DIP (UNDP/PAPP) PROJECT TITLE: CONSTRUCTION OF 100 HOUSING UNITS TO RE-HOUSE THE AFFECTED PALESTINIAN FAMILIES IN GAZA STRIP PROJECT NO.: PAL 10-00070416 (PACKAGE 07)
	CLIENT: PALESTINIAN NATIONAL AUTHORITY MINISTRY OF PUBLIC WORKS & HOUSING (MPWH) EMPLOYER: PROGRAMME OF ASSISTANCE TO THE PROGRAMME OF ASSISTANCE TO THE UN PALESTINIAN PEOPLE DP (UNDP/PAPP) PROJECT TITLE: CONSTRUCTION OF 100 HOUSING UNITS TO RE-HOUSE THE AFFECTED PALESTINIAN FAMILIES IN GAZA STRIP PROJECT NO.: PAL 10-00070416 (PACKAGE 07) CONSULTANT: Lubuiling a.u. august 1000000000000000000000000000000000000
	CLIENT: PALESTINIAN NATIONAL AUTHORITY MINISTRY OF PUBLIC WORKS & HOUSING (MPWH) EMPLOYER: THE UNITED NATIONS DEVELOPMENT PROGRAMME PROGRAMME OF ASSISTANCE TO THE UN PALESTINIAN PEOPLE DIP (UNDP/PAPP) PROJECT TITLE: CONSTRUCTION OF 100 HOUSING UNITS TO RE-HOUSE THE AFFECTED PALESTINIAN FAMILIES IN GAZA STRIP PROJECT NO.: PAL 10-00070416 (PACKAGE 07) CONSULTANT: Lub-1119 a.u Jun 115 for center for engineering and planning BUILDING NAME:
RS SMALL	CLIENT: PALESTINIAN NATIONAL AUTHORITY MINISTRY OF PUBLIC WORKS & HOUSING (MPWH) EMPLOYER: PROGRAMME OF ASSISTANCE TO THE PROGRAMME OF ASSISTANCE TO THE UN PALESTINIAN PEOPLE DIP (UNDP/PAPP) PROJECT TITLE: CONSTRUCTION OF 100 HOUSING UNITS TO RE-HOUSE THE AFFECTED PALESTINIAN FAMILIES IN GAZA STRIP PROJECT NO.: PAL 10-00070416 (PACKAGE 07) CONSULTANT: LLD-STIL BUILDING NO. (A7) BUILDING NAME: RESIDENTIAL BUILDING NO. (A7)

SCALE: AS SHO

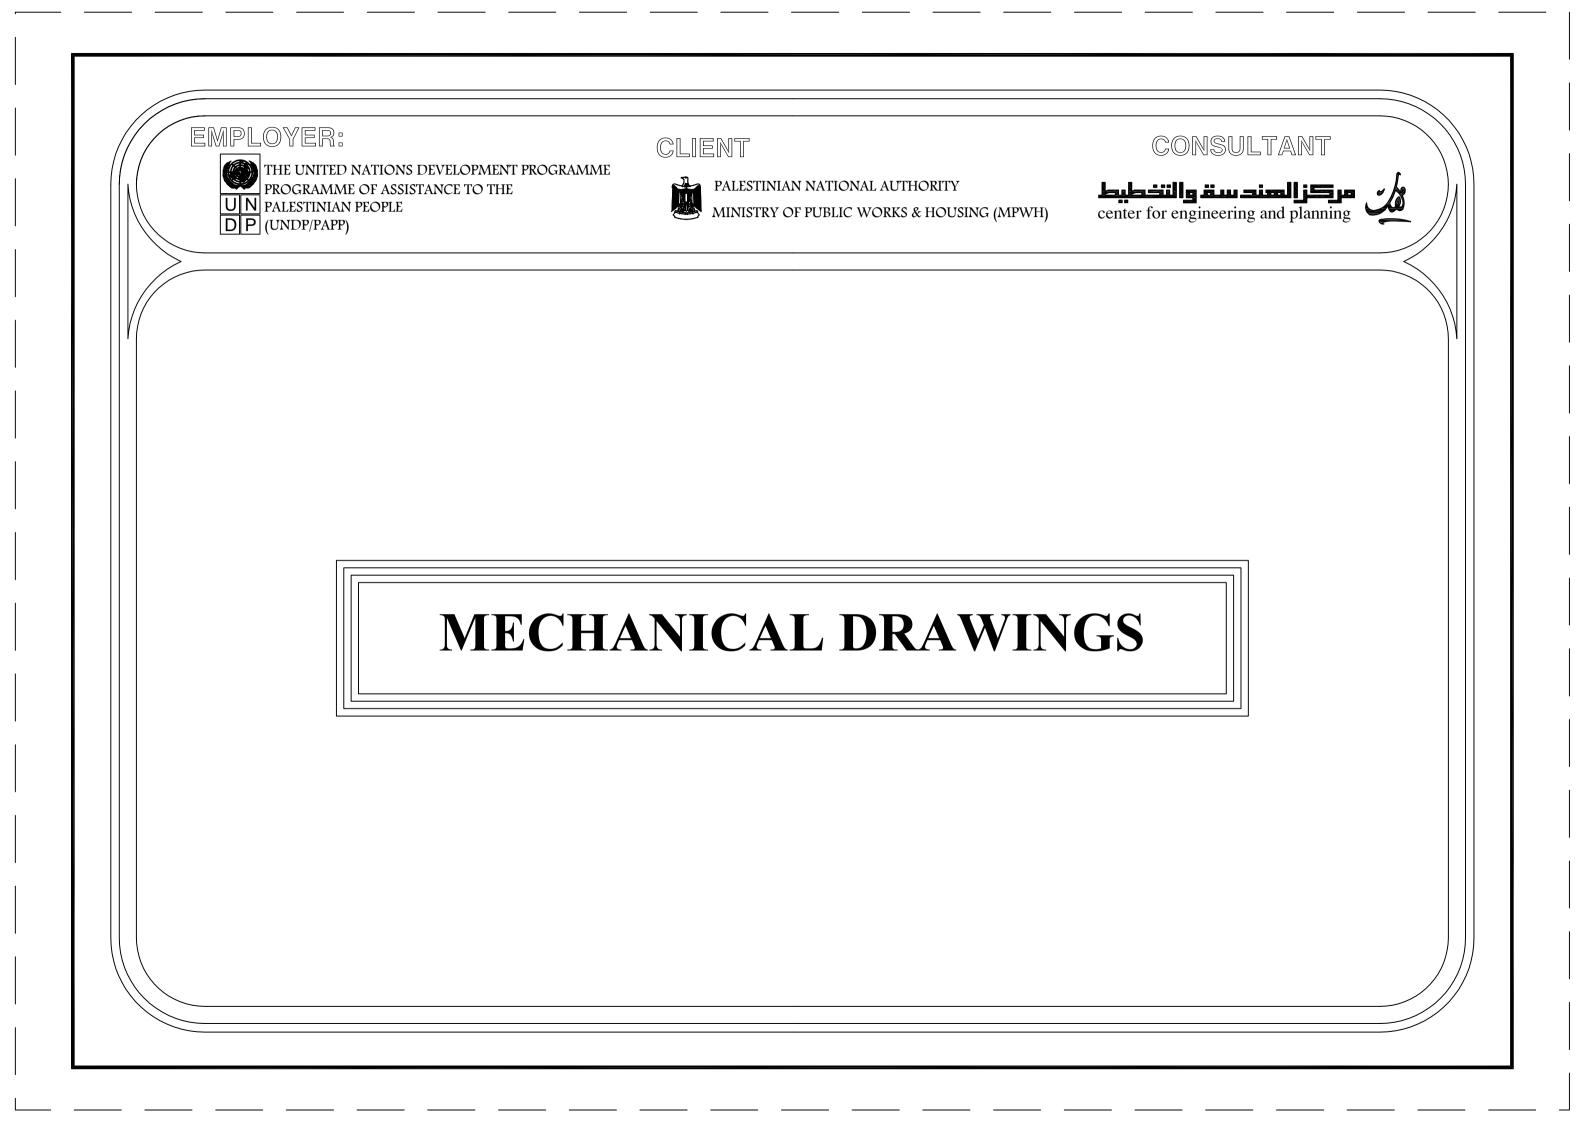

EMPLOYER:



THE UNITED NATIONS DEVELOPMENT PROGRAMME PROGRAMME OF ASSISTANCE TO THE **UN** PALESTINIAN PEOPLE

CLIENT




PALESTINIAN NATIONAL AUTHORITY MINISTRY OF PUBLIC WORKS & HOUS


MINISTRY OF PUBLIC WORKS & HOUSING (MPWH)

LIST OF DRAWINGS FOR PLUMBING

NO.	DRAWING NAME	DWG NO.
00	SANITARY NETWORK FOR HOUSING UNITS	RE-M-000
01	SEWER PIPE FOR THE BUILDING	RE-M-001
02	WATER NETWORK FOR UNDERGROUND FLOOR	RE-M-002
03	WATER NETWORK FOR GROUND FLOOR	RE-M-003
04	WATER NETWORK FOR TYPICAL FLOOR	RE-M-004
05	SANITARY NETWORK FOR UNDERGROUND FLOOR	RE-M-005
06	SANITARY NETWORK FOR GROUND FLOOR	RE-M-006


NO.	DRAWING NAME
07	SANITARY NETWORK FOR TYPICAL FLOOR
08	RAIN WATER FOR ROOF PLAN
09	WATER NETWORK FOR UNDERGROUND FLOOR
10	WATER NETWORK FORROOF FLOOR
11	WATER NETWORK FOR ROOF FLOOR
12	GENERAL DETAILS FOR MECHANICAL (1/2)
13	GENERAL DETAILS FOR MECHANICAL (2/2)

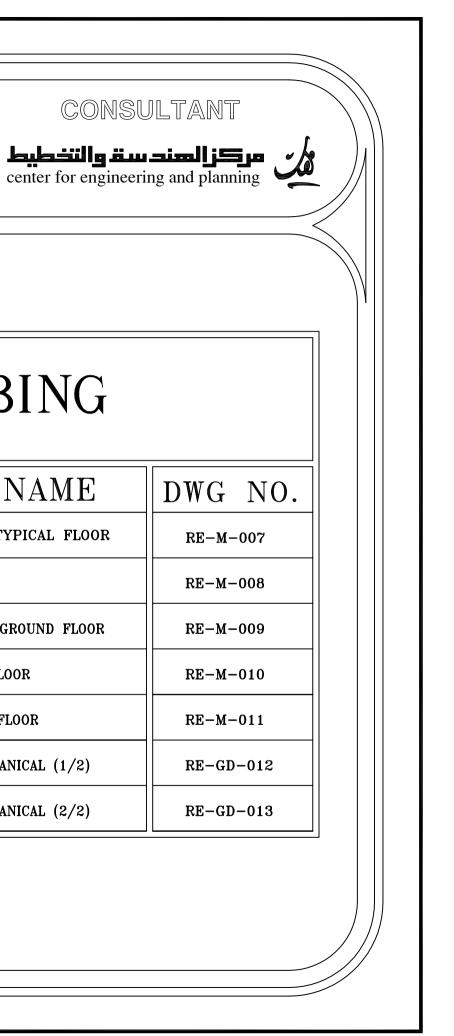


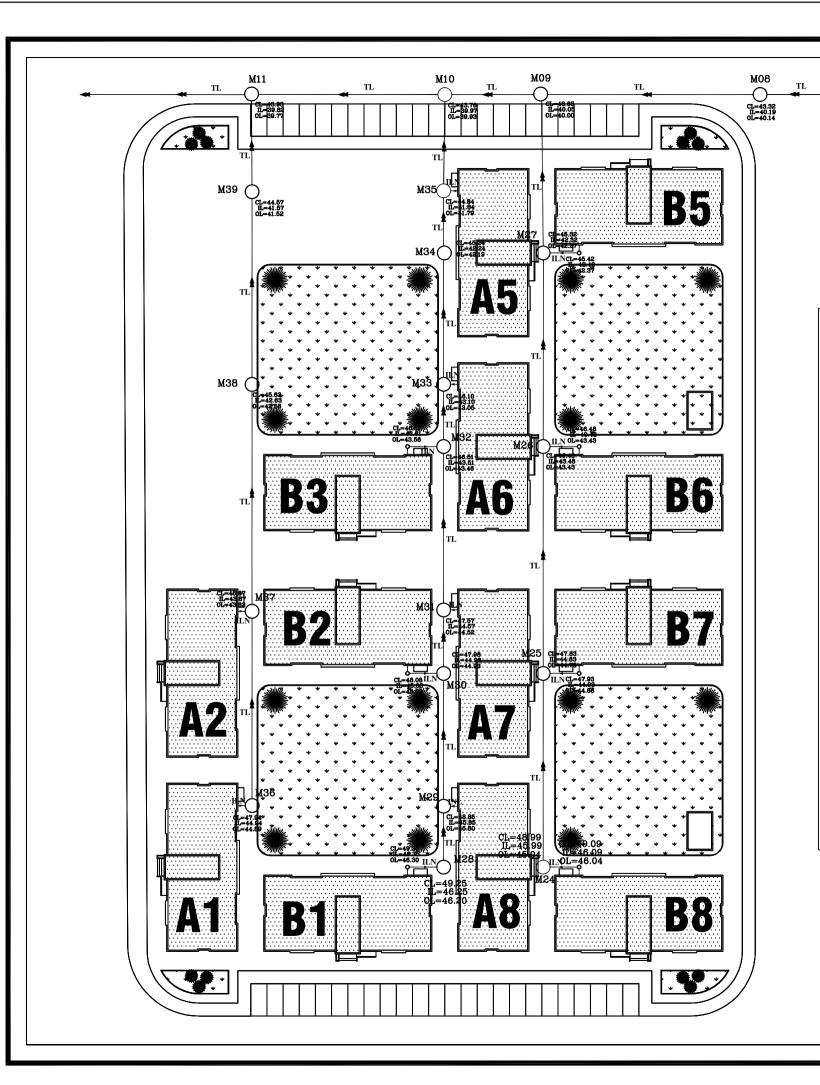



MANHOLES SCHEDULE


M.No.	COVER LEVEL	INVERT LEVEL	OUTLET LEVEL	DEPTH (m)
M08	43.32	40.19	40.14	3.13
M09	43.63	40.05	40.00	3.58
M10	43.76	39.97	39.93	3.79
M11	43.93	39.82	39.77	4.11
M24	48.99	45.99	45.94	3.00
M25	47.83	44.83	44.78	3.00
M26	46.48	43.48	43.43	3.00
M27	45.32	42.32	42.17	3.00
M28	49.25	46.25	46.20	3.00
M29	48.85	45.85	45.80	3.00
М30	47.98	44.98	44.93	3.00
M31	47.57	44.57	44.52	3.00
M32	46.51	43.51	43.46	3.00
М33	46.10	43.10	43.05	3.00
M34	45.24	42.24	42.19	3.00
M35	44.84	41.84	41.79	3.00
M36	47.94	44.94	44.89	3.00
M37	46.87	43.87	43.82	3.00
M38	45.63	42.63	42.58	3.00
M39	44.57	41.57	41.52	3.00

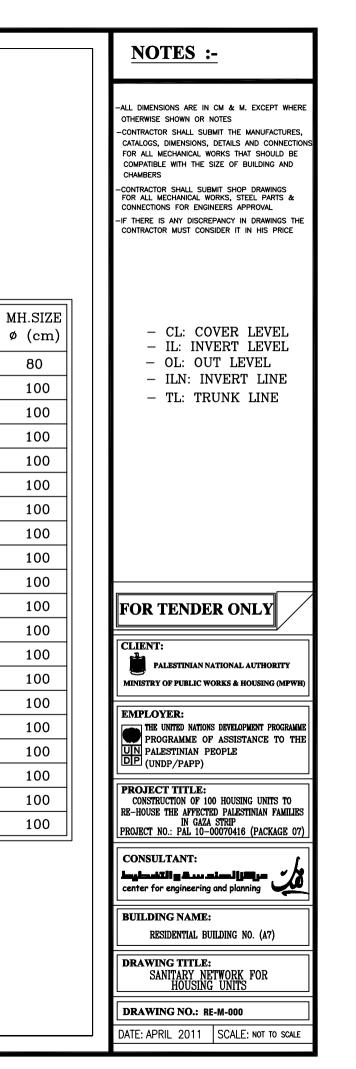

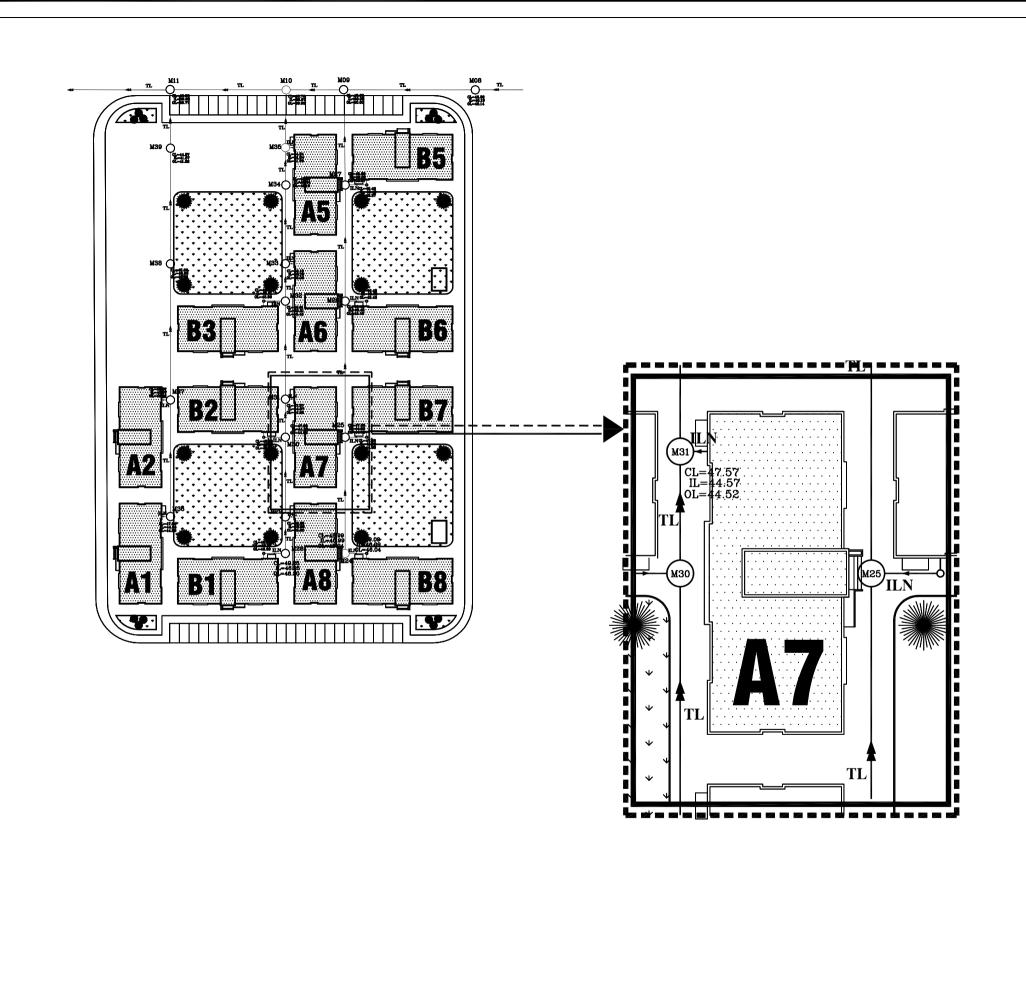

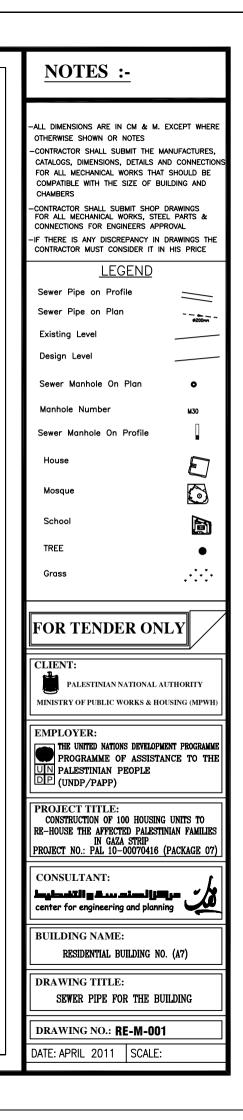

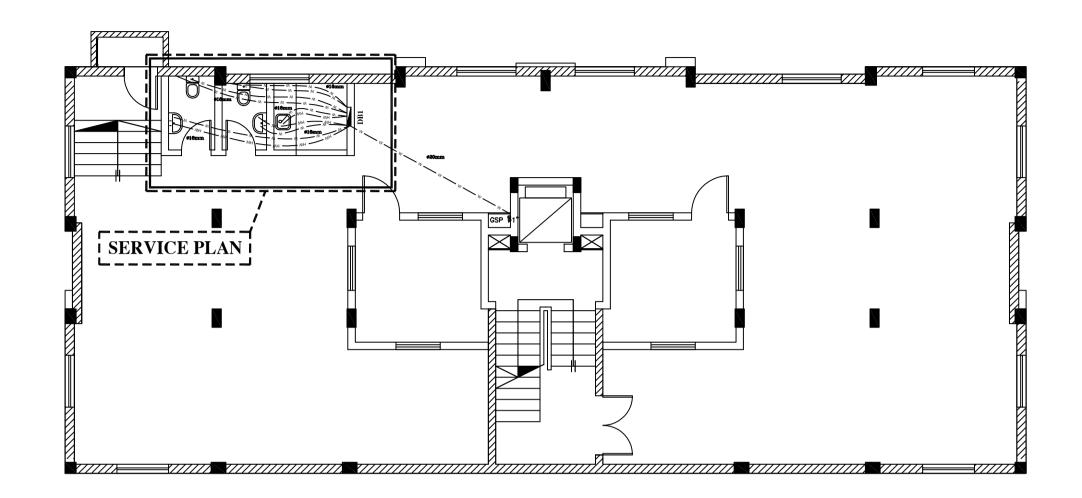


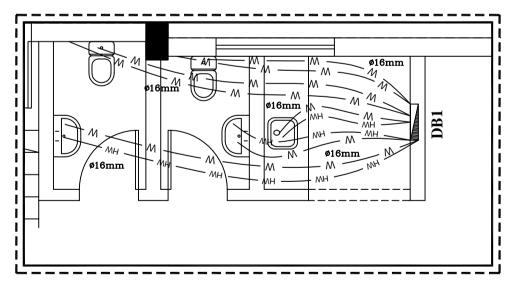



WATER NETWORK FOR SERVICE PLAN


SCALE 1:50


WATER NETWORK FOR UNDERGROUND FLOOR

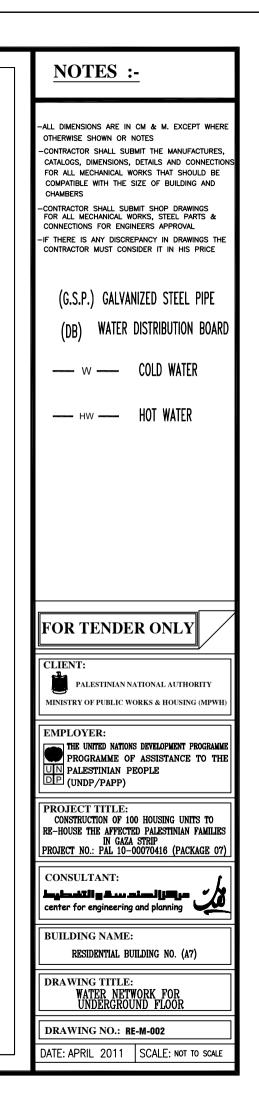


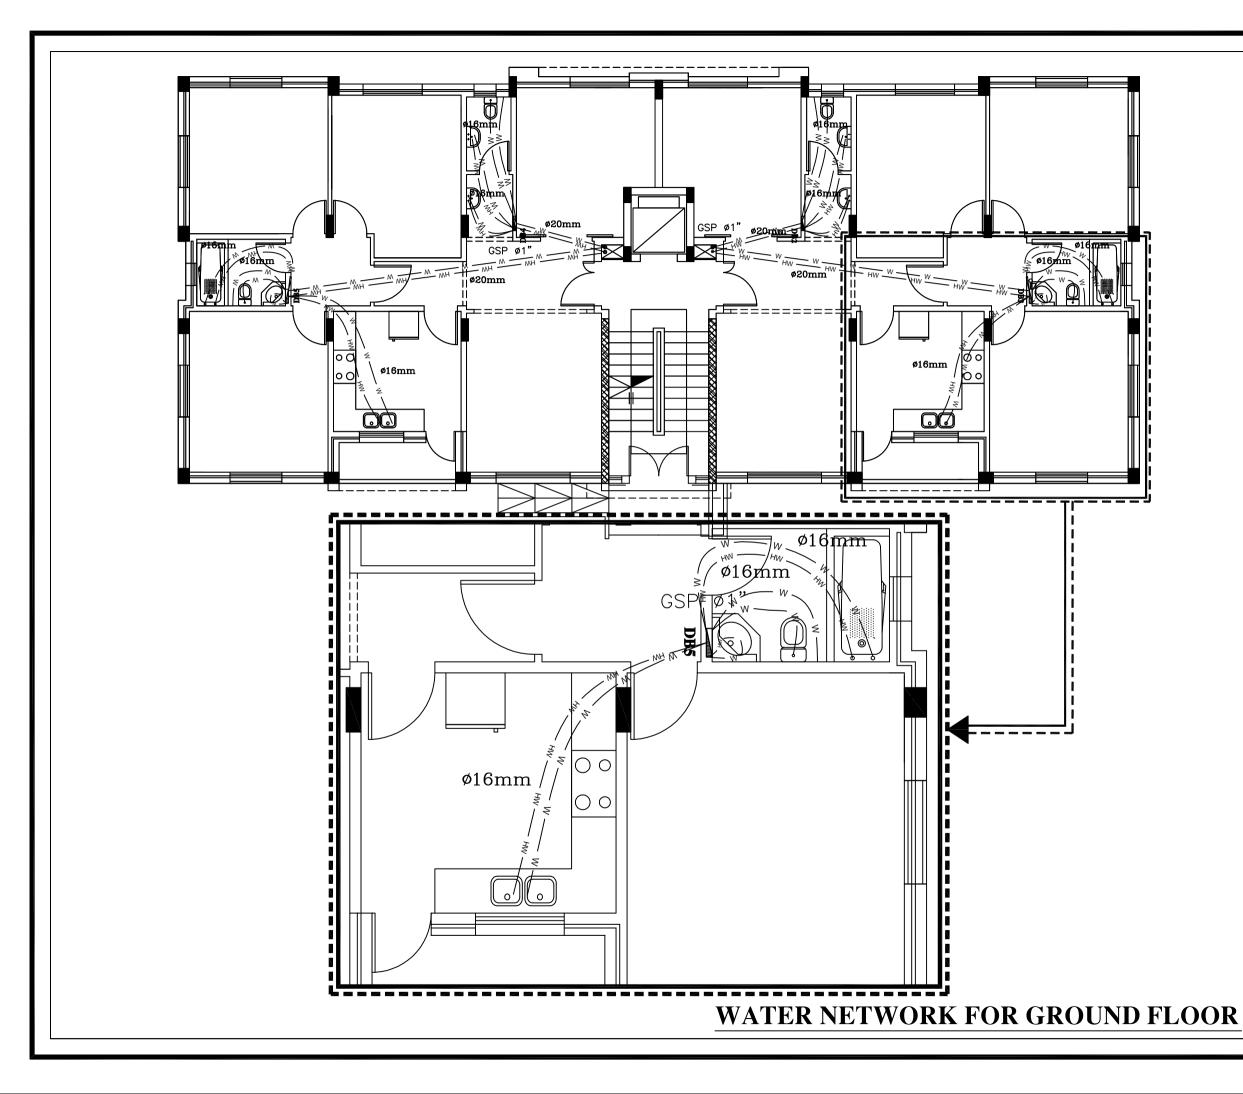


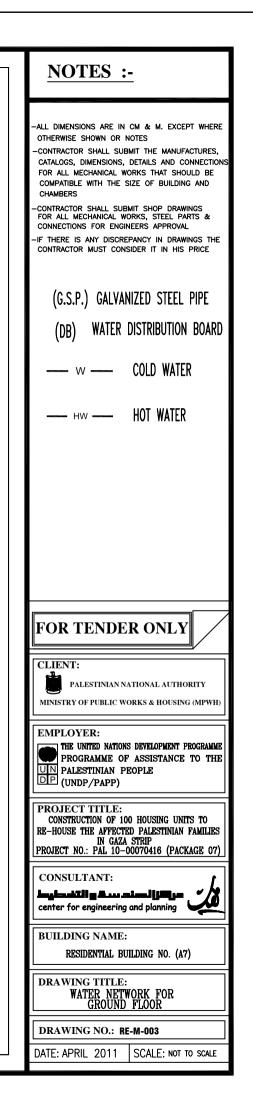

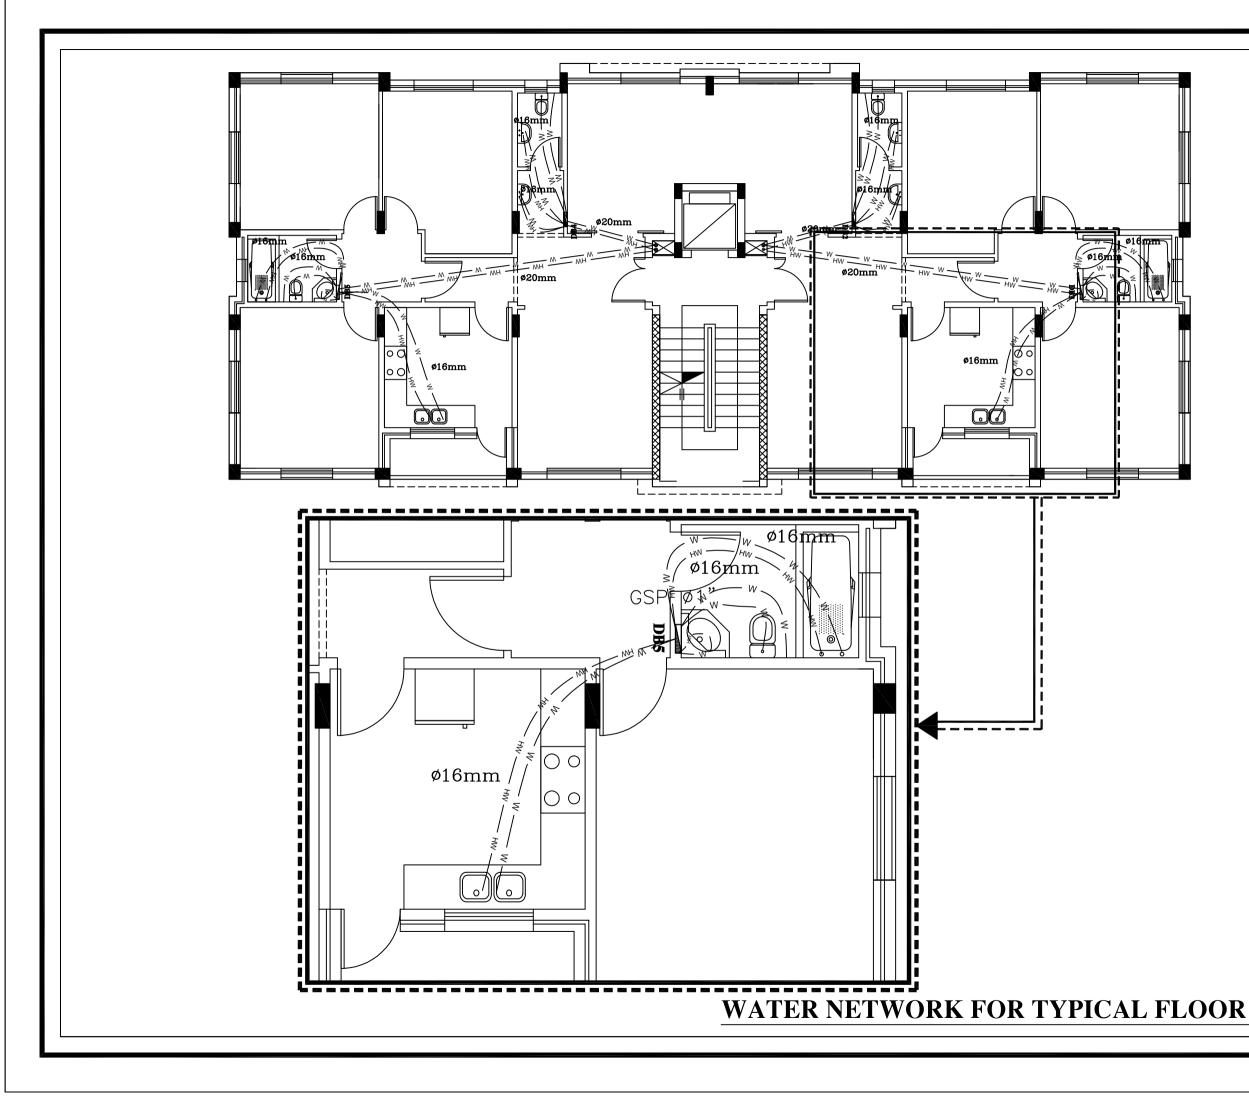


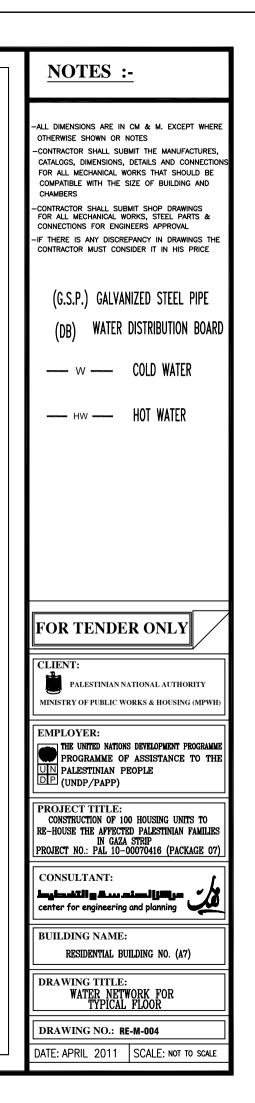


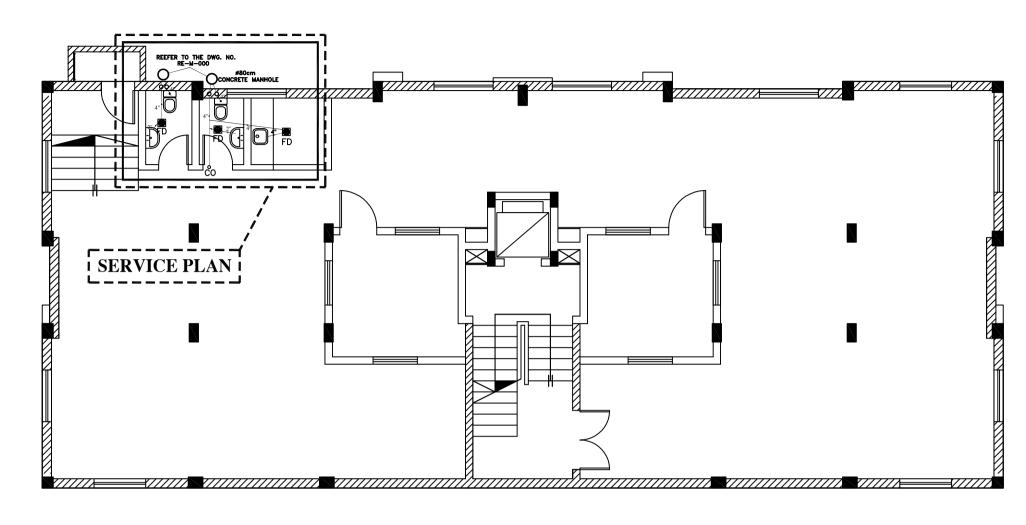


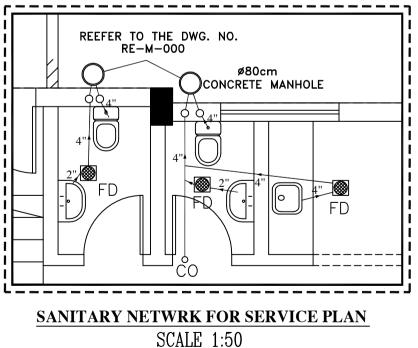



SANITARY NETWORK FOR UNDERGROUND FLOOR

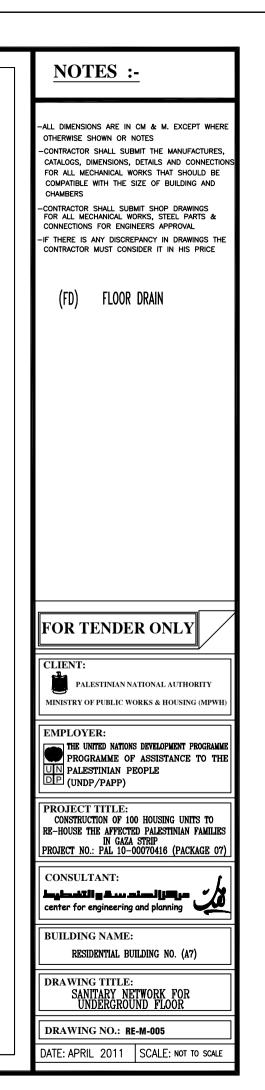


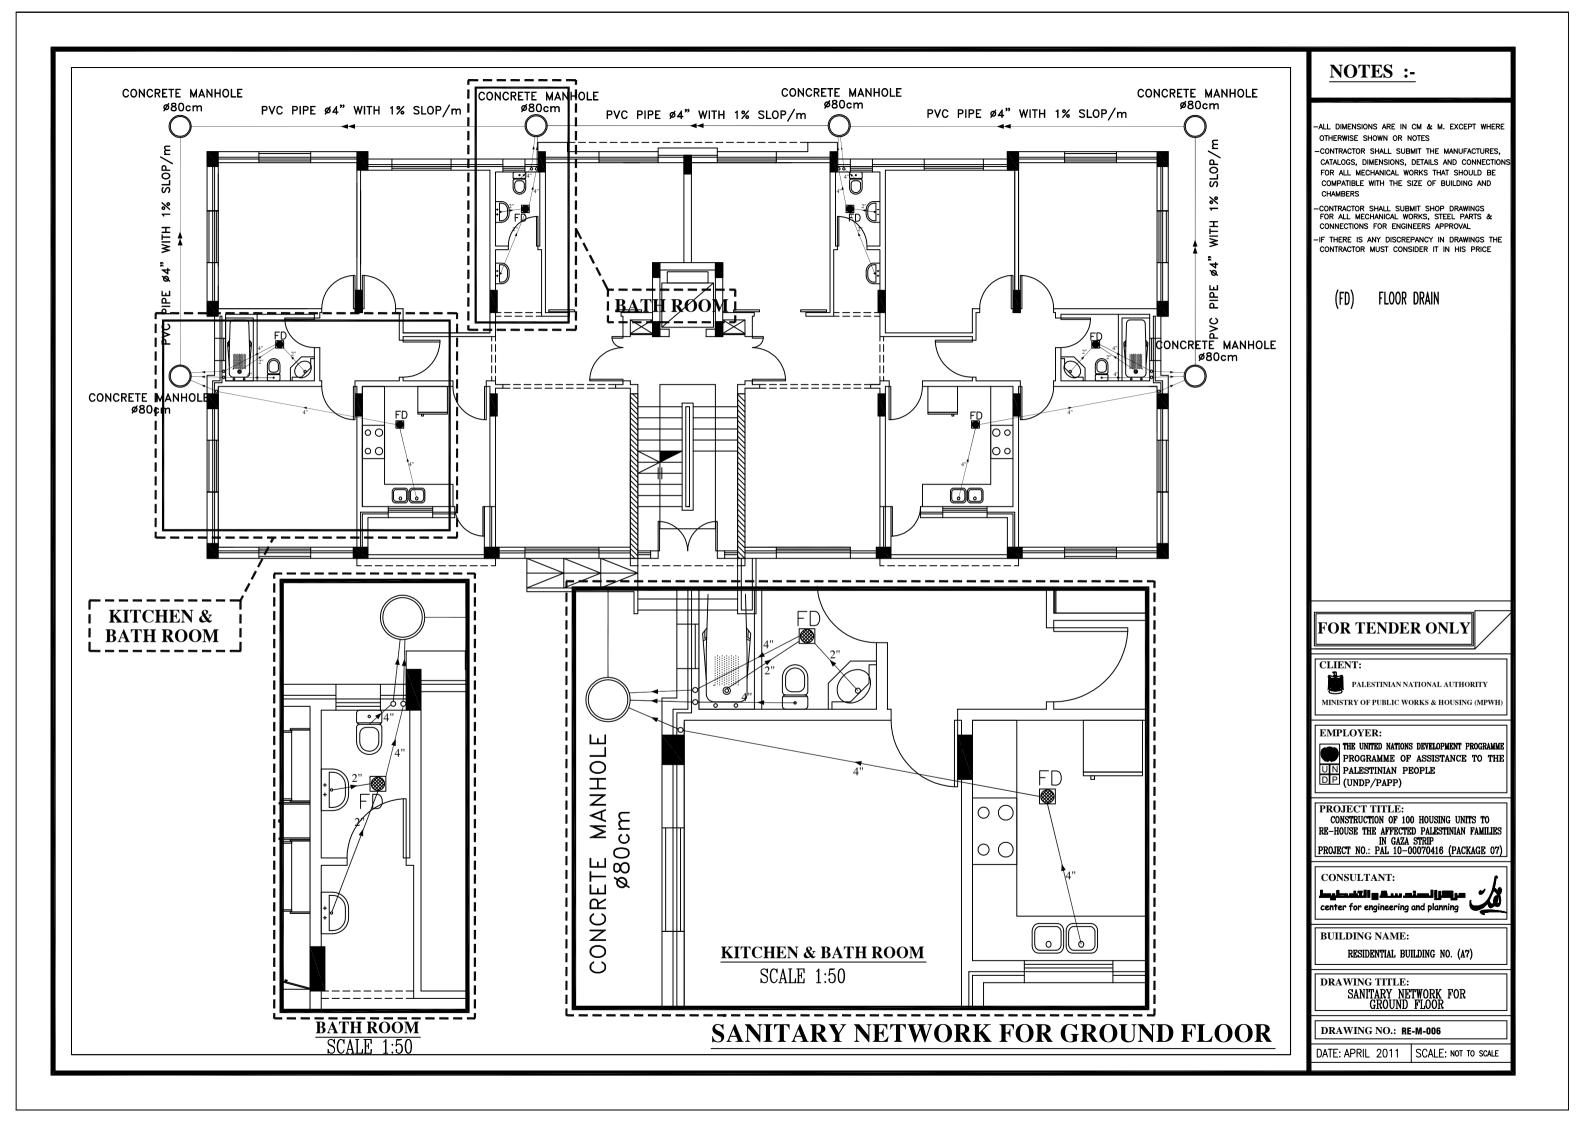


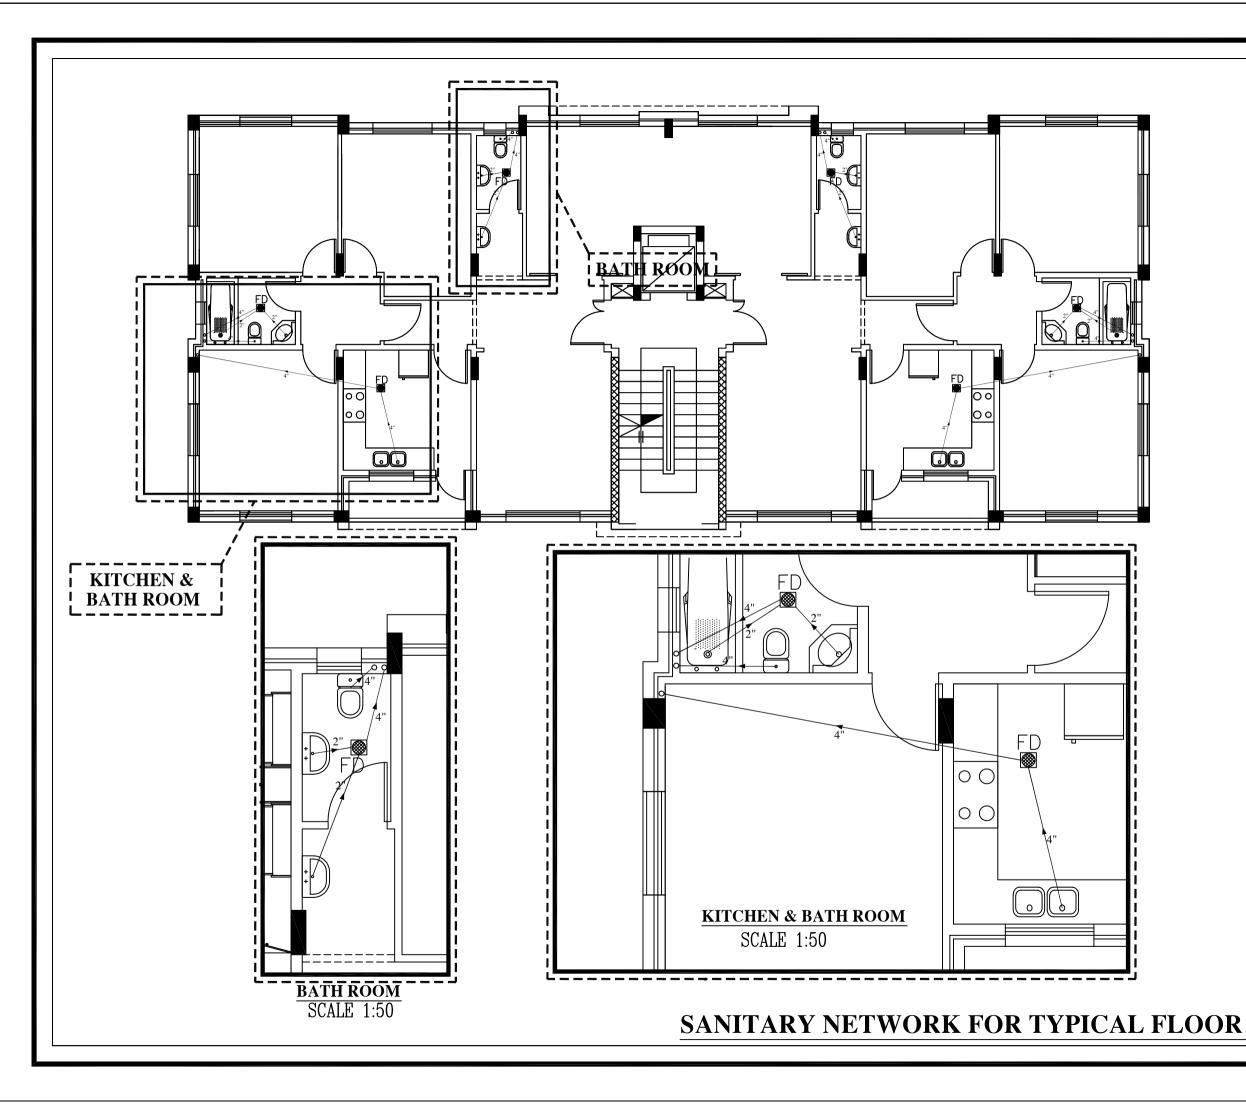


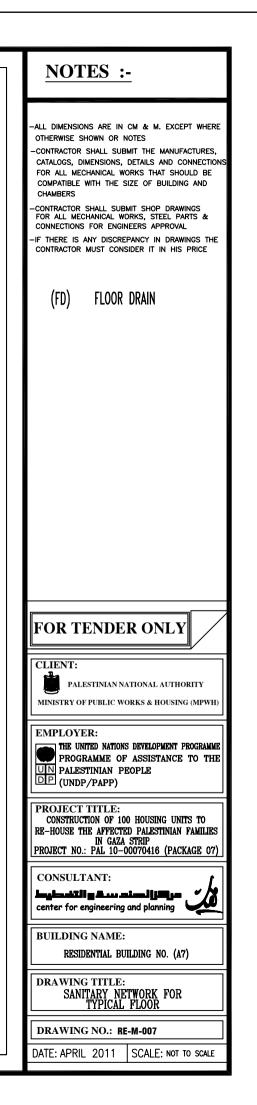

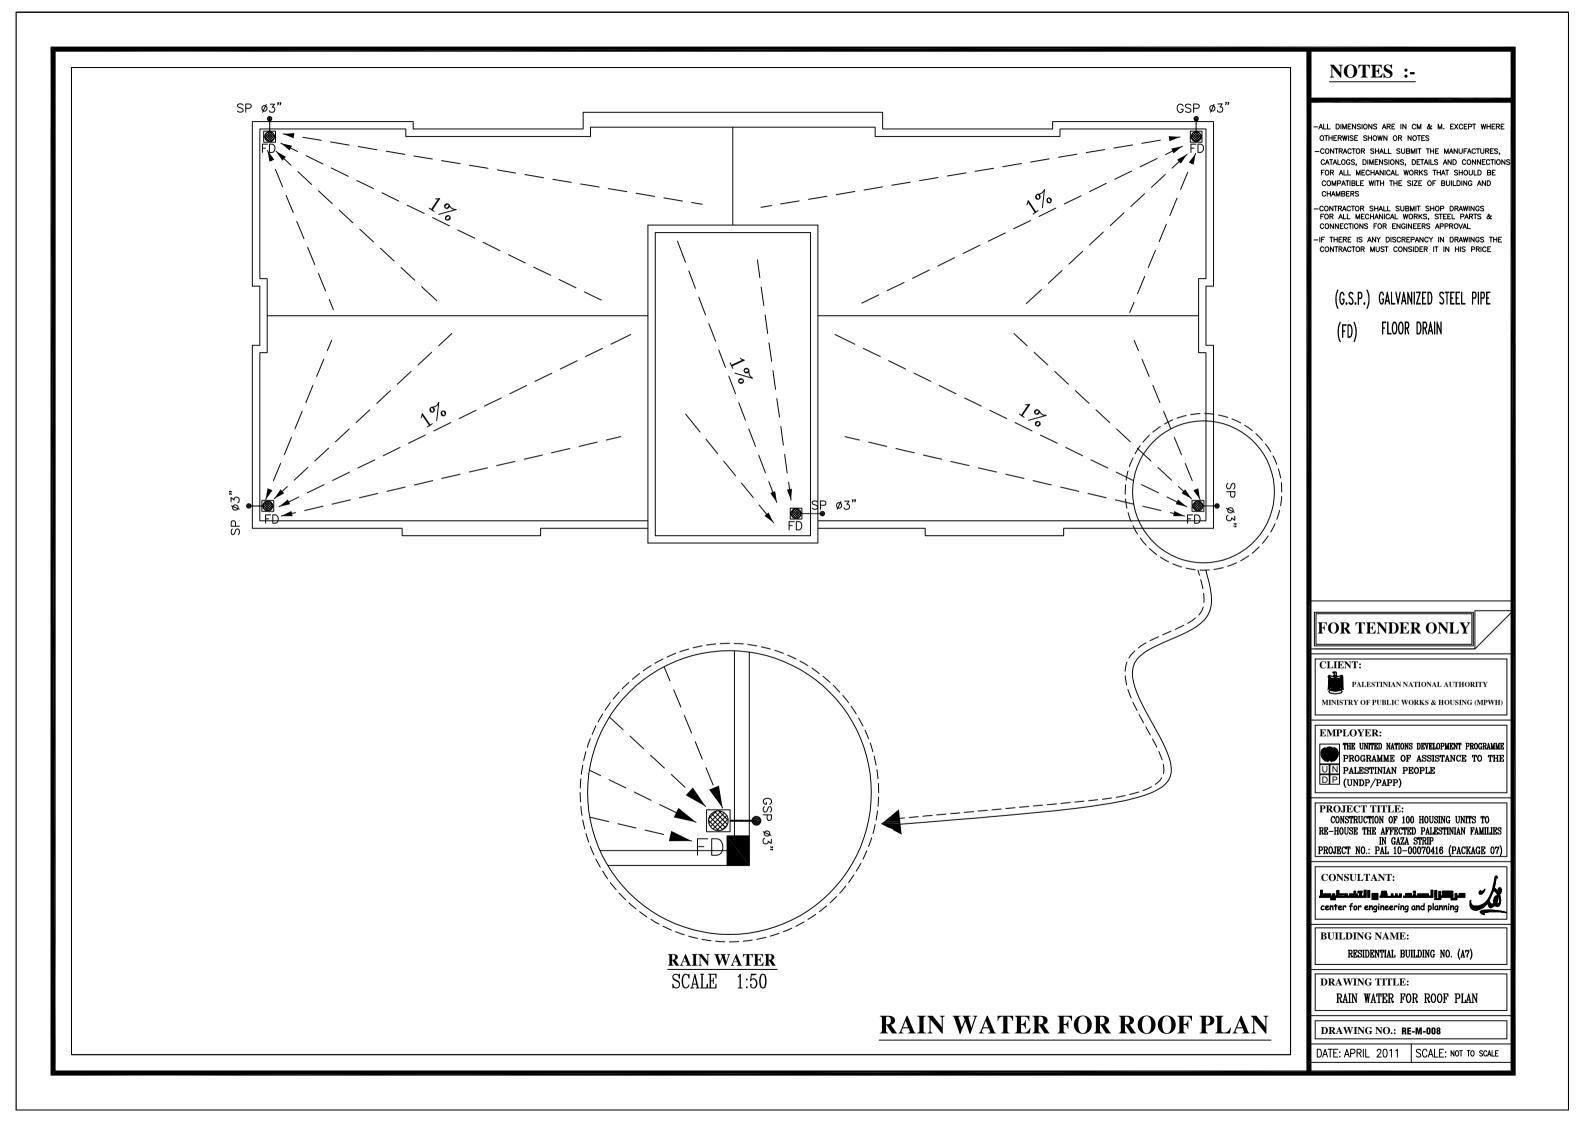

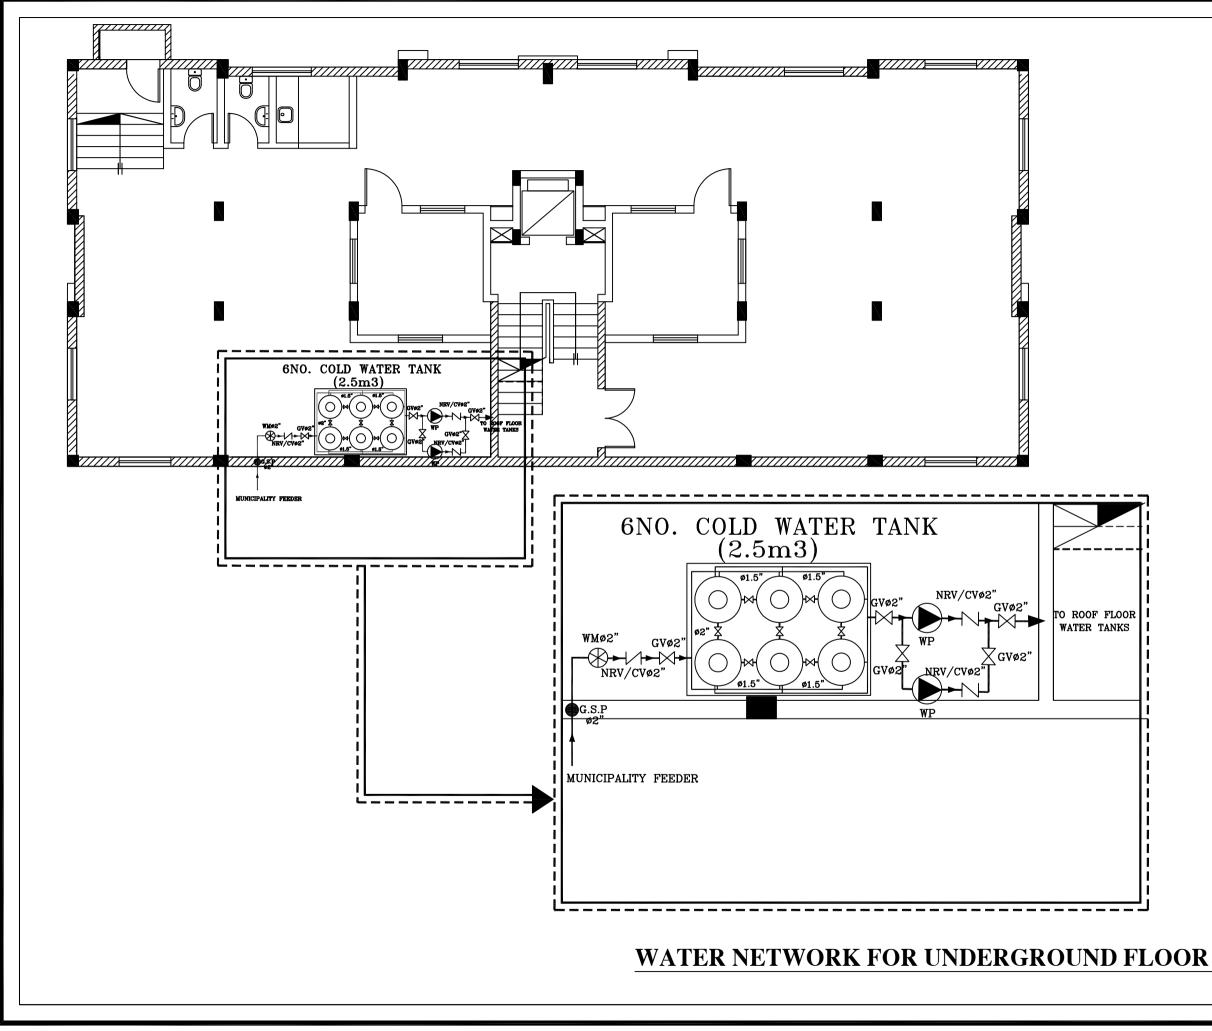


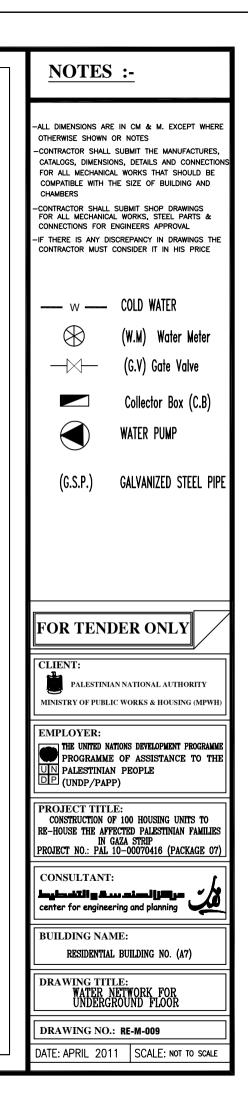

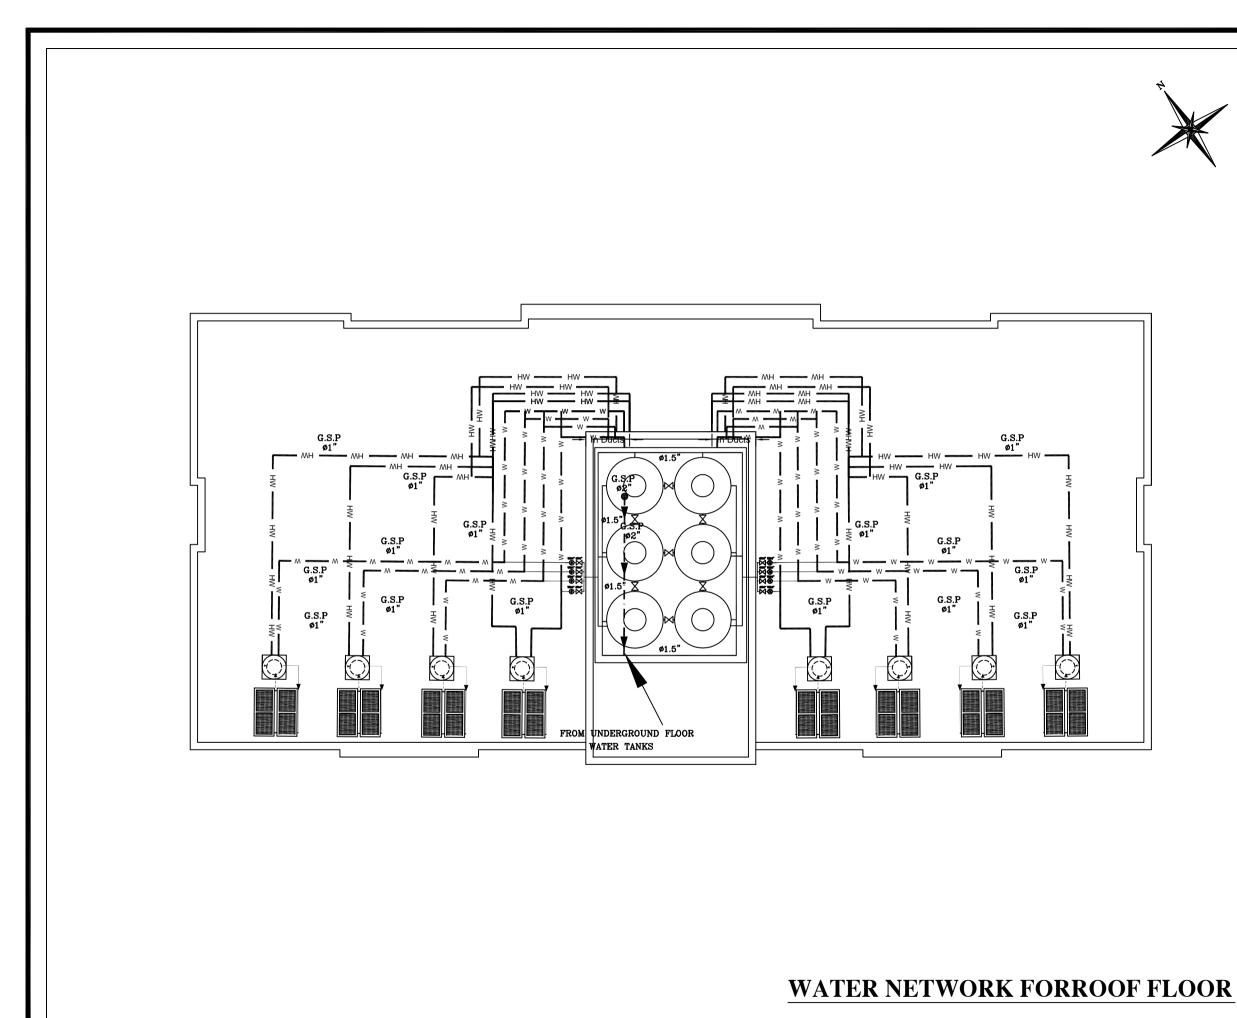






<u>NOTES :-</u>
 ALL DIMENSIONS ARE IN CM & M. EXCEPT WHERE OTHERWISE SHOWN OR NOTES CONTRACTOR SHALL SUBMIT THE MANUFACTURES, CATALOGS, DIMENSIONS, DETAILS AND CONNECTIONS FOR ALL MECHANICAL WORKS THAT SHOULD BE COMPATIBLE WITH THE SIZE OF BUILDING AND CHAMBERS CONTRACTOR SHALL SUBMIT SHOP DRAWINGS FOR ALL MECHANICAL WORKS, STEEL PARTS & CONNECTIONS FOR ENGINEERS APPROVAL IF THERE IS ANY DISCREPANCY IN DRAWINGS THE CONTRACTOR MUST CONSIDER IT IN HIS PRICE
(G.S.P.) GALVANIZED STEEL PIPE (DB) WATER DISTRIBUTION BOARD
FOR TENDER ONLY
CLIENT: PALESTINIAN NATIONAL AUTHORITY MINISTRY OF PUBLIC WORKS & HOUSING (MPWH)
EMPLOYER: THE UNITED NATIONS DEVELOPMENT PROGRAMME PROGRAMME OF ASSISTANCE TO THE UN PALESTINIAN PEOPLE DP (UNDP/PAPP)
PROJECT TITLE: CONSTRUCTION OF 100 HOUSING UNITS TO RE-HOUSE THE AFFECTED PALESTINIAN FAMILIES IN GAZA STRIP PROJECT NO.: PAL 10-00070416 (PACKAGE 07)
CONSULTANT:
BUILDING NAME: RESIDENTIAL BUILDING NO. (A7)
DRAWING TITLE: WATER NETWORK FOR ROOF FLOOR
DRAWING NO.: RE-M-010 DATE: APRIL 2011 SCALE: NOT TO SCALE

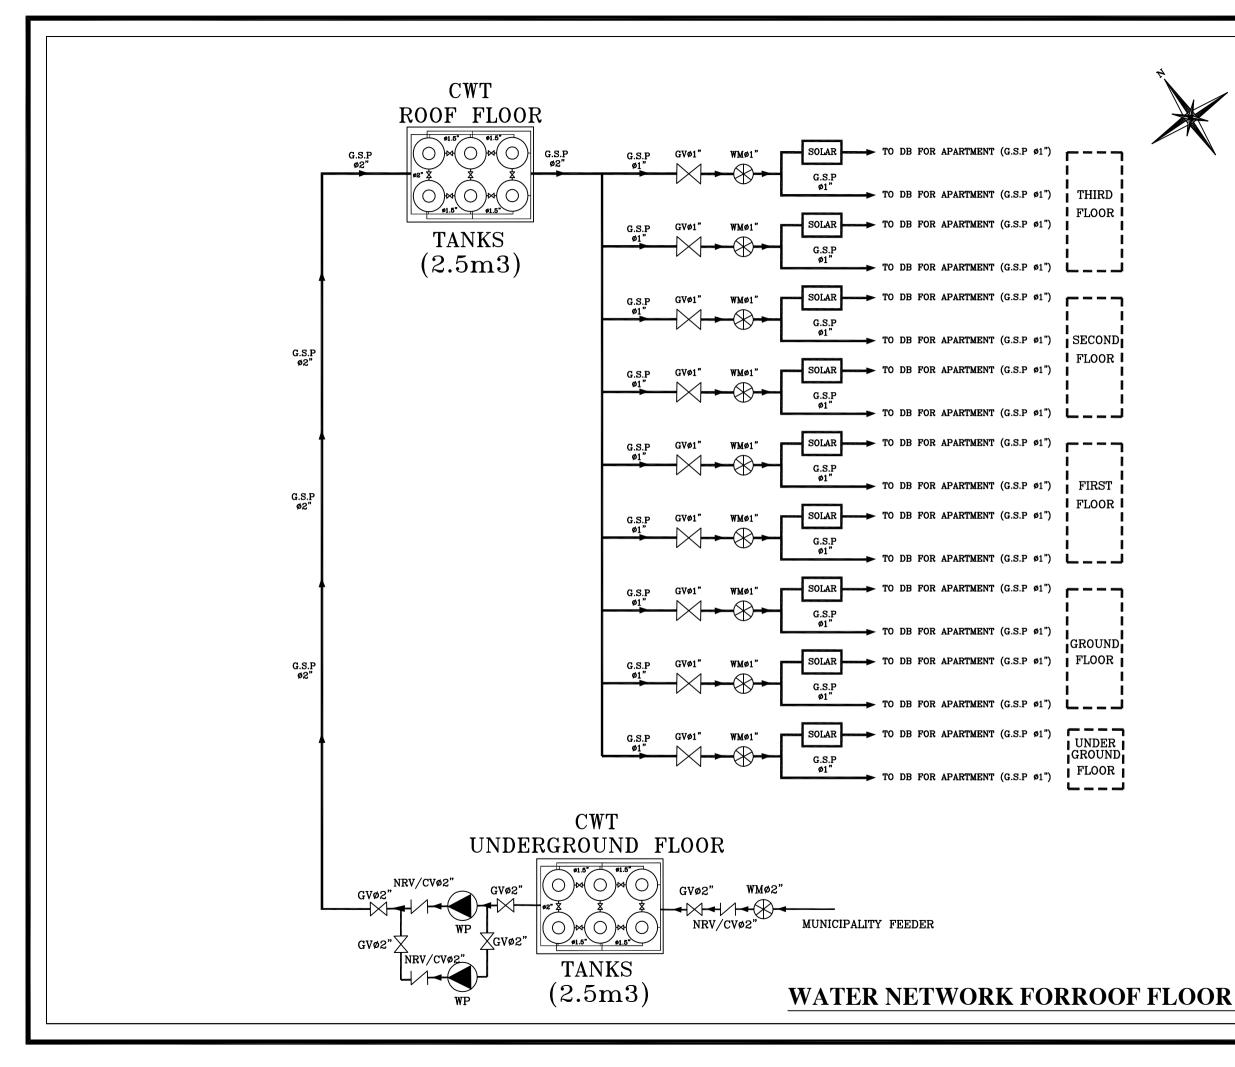





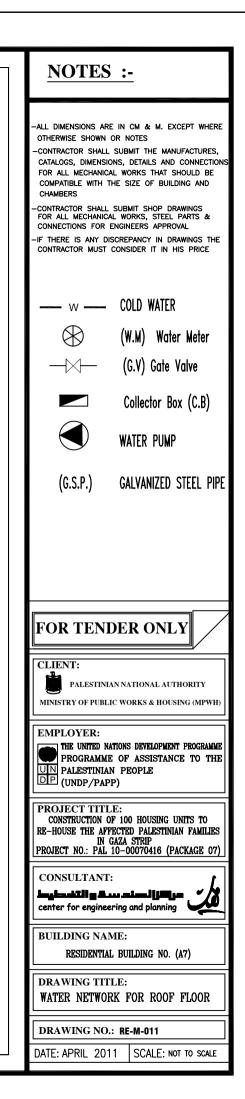


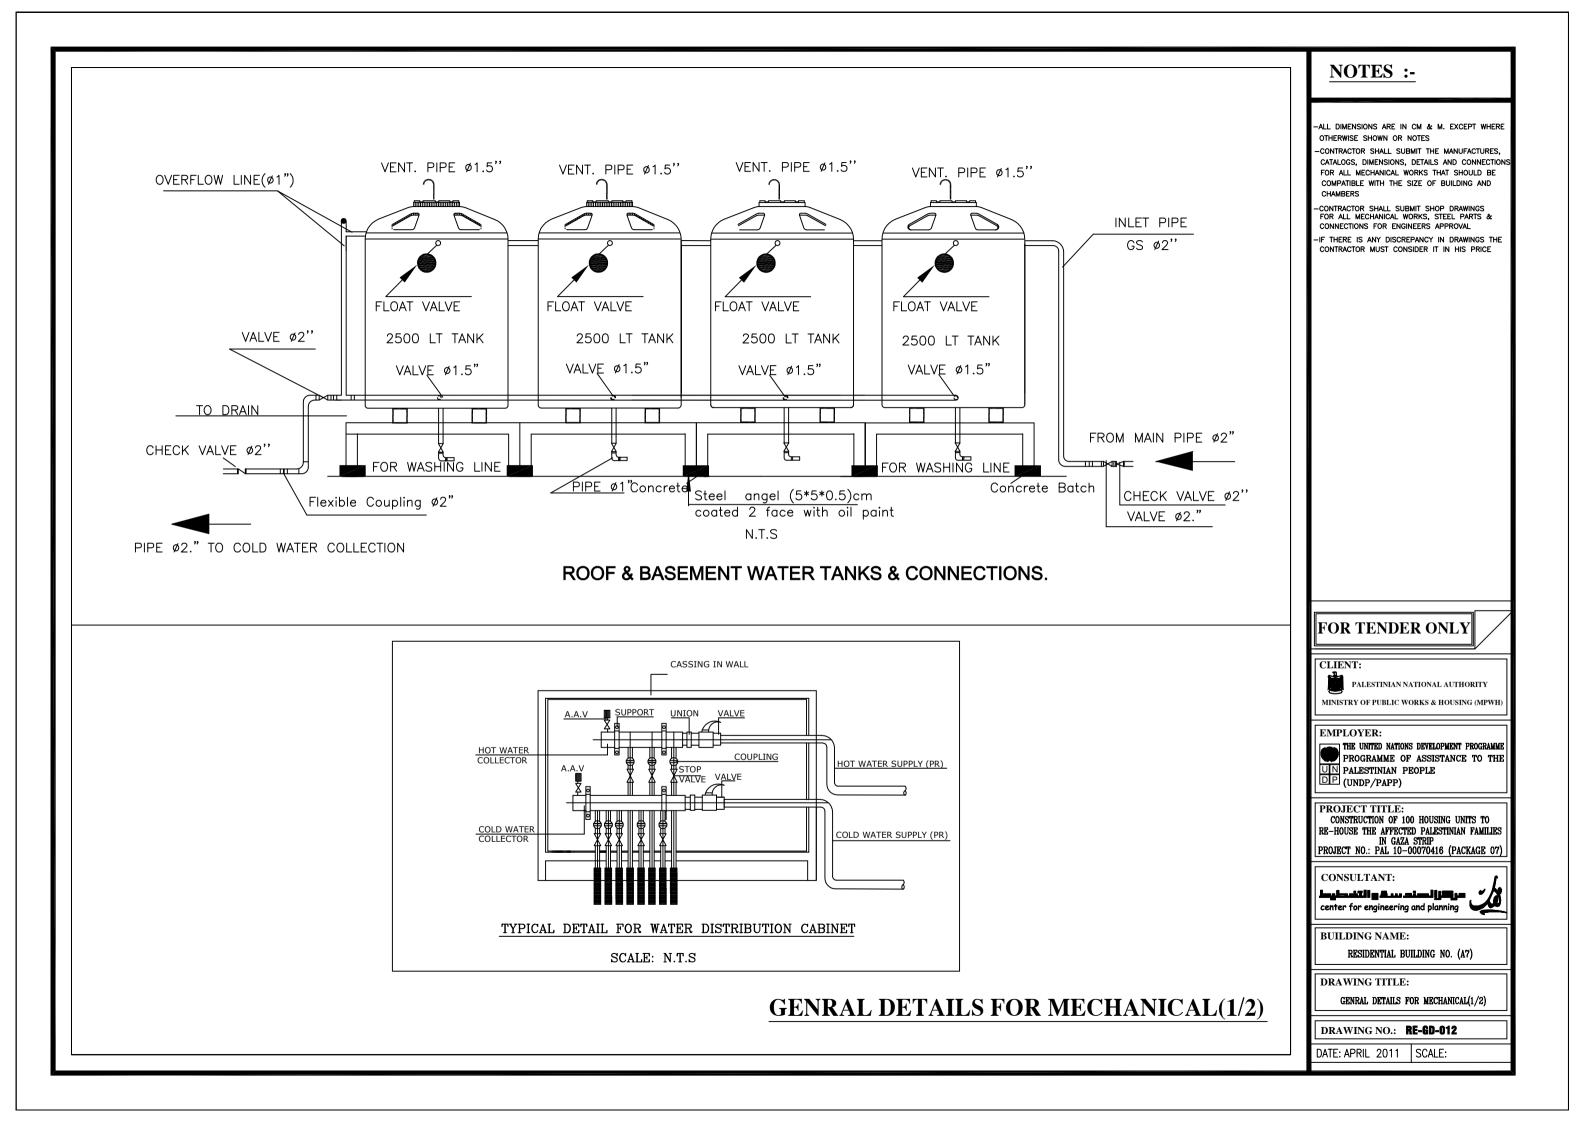

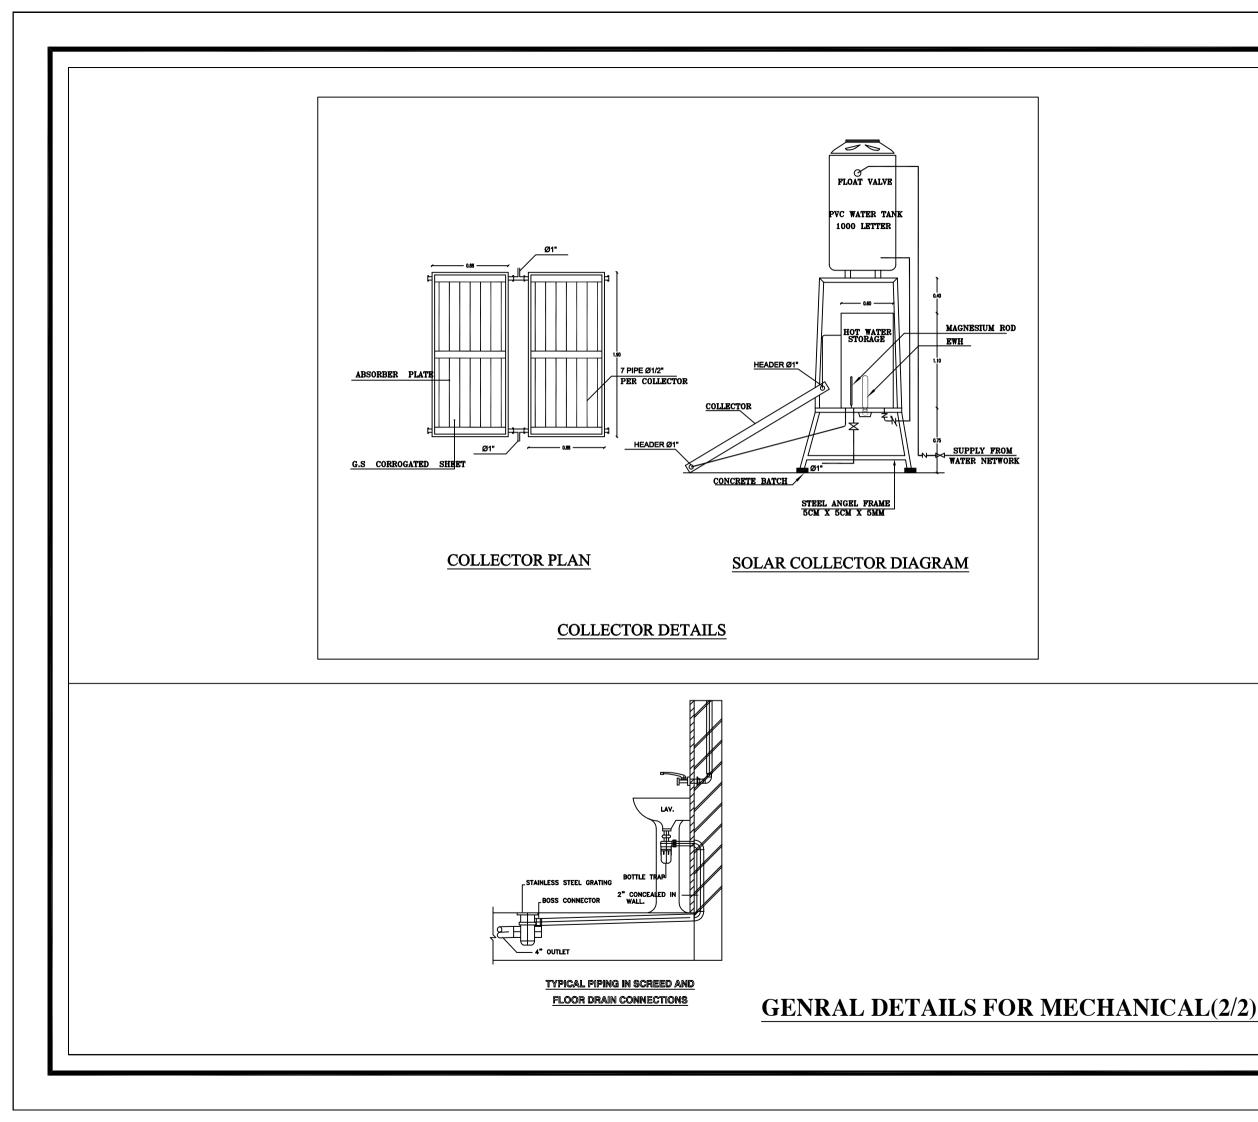

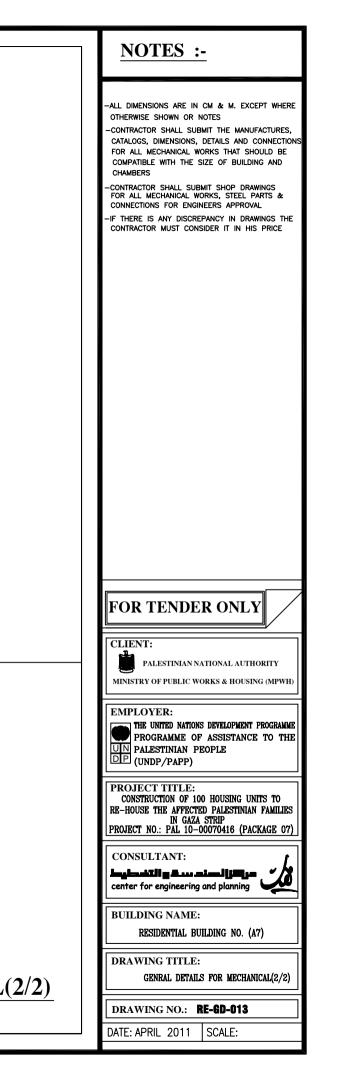

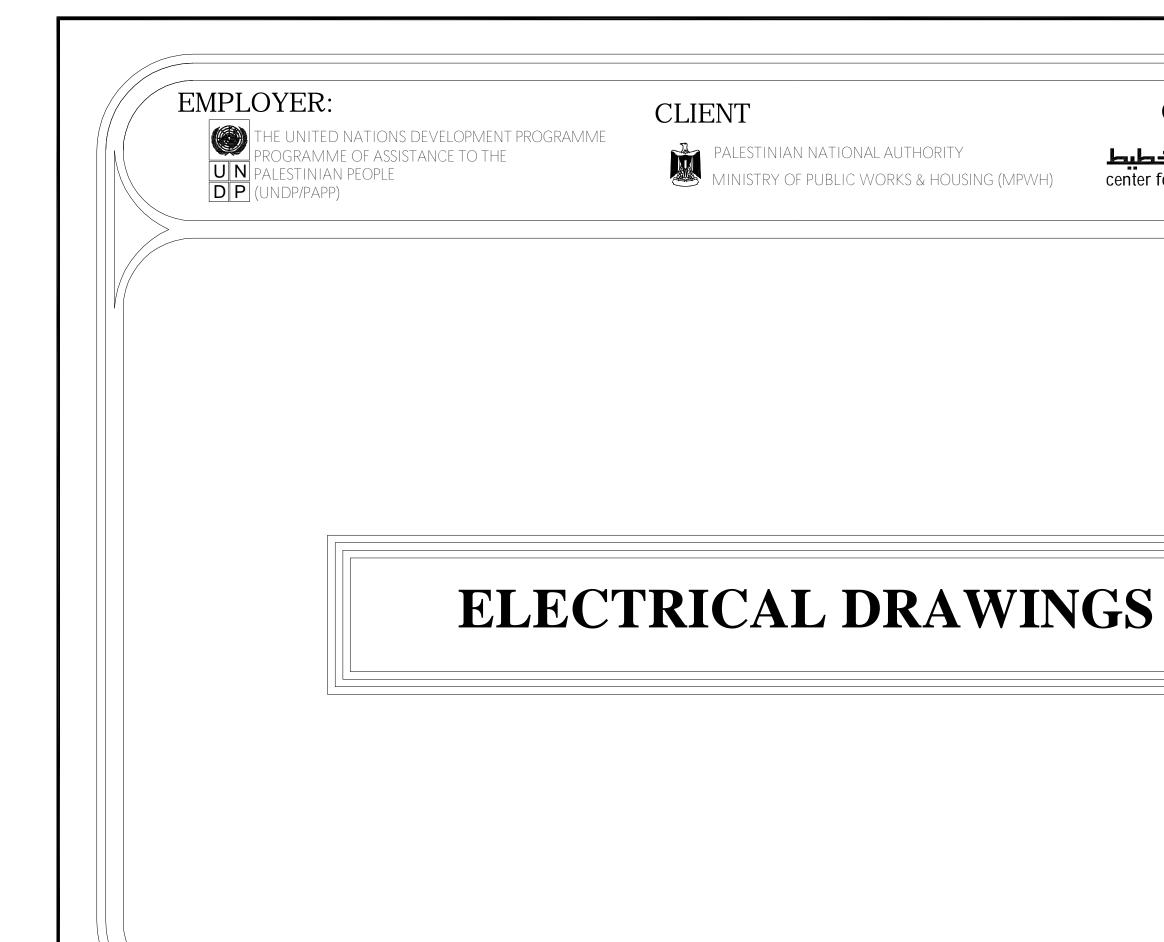

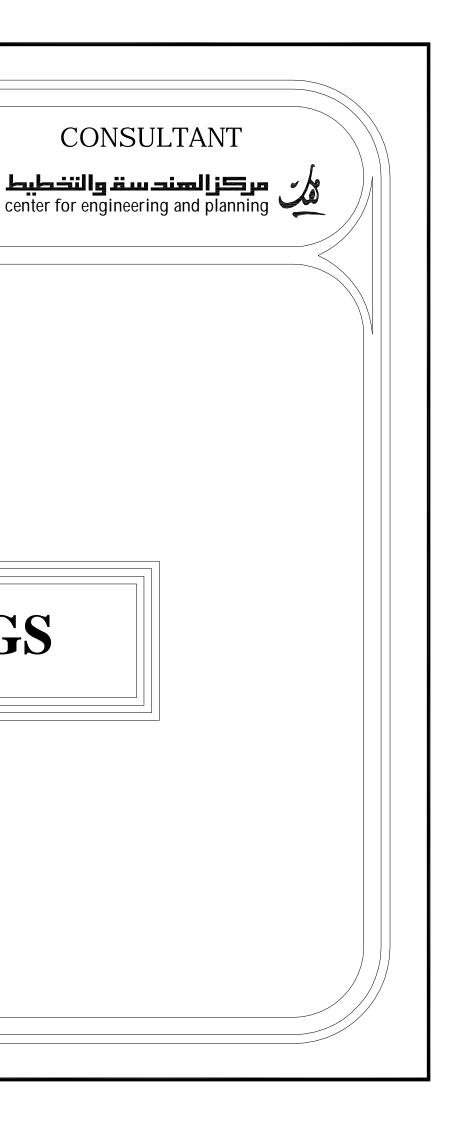






THE UNITED NATIONS DEVELOPMENT PROGRAMME PROGRAMME OF ASSISTANCE TO THE UN PALESTINIAN PEOPLE DP (UNDP/PAPP)

CLIENT



PALESTINIAN NATIONAL AUTHORITY MINISTRY OF PUBLIC WORKS & HOUSI MINISTRY OF PUBLIC WORKS & HOUSING (MPWH)

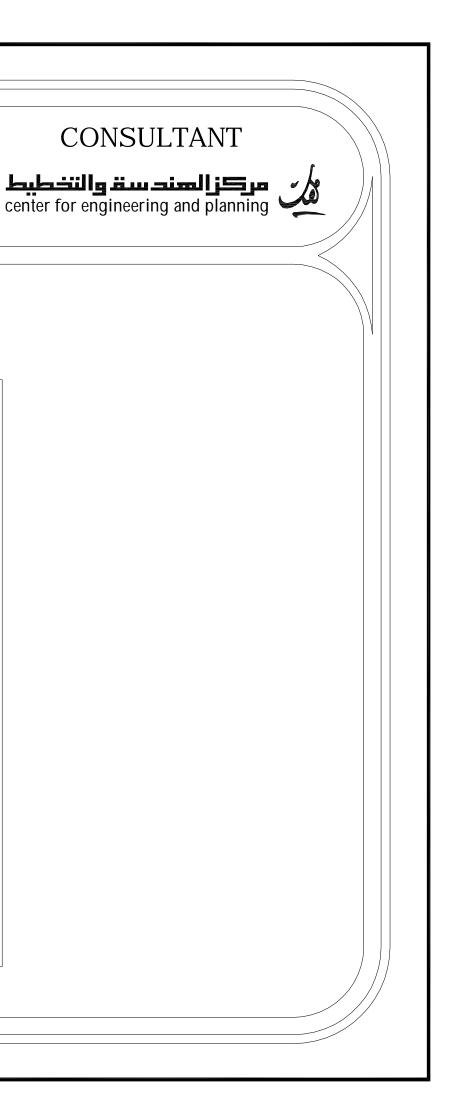



LIST OF DRAWINGS


S/NO.	DRAWING NAME	DRG. NO.
	ELECTRICAL DRAWING	
01/17	Legend	RE-E-001
02/17	Grounding System	RE-E-002
03/17	UNDERGROUND FLOOR-Electrical Arrangements	RE-E-003
04/17	UNDERGROUND FLOOR-Lighting Fittings Layout	RE-E-004
05/17	UNDERGROUND FLOOR-Power Fittings Layout	RE-E-005
06/17	GROUND FLOOR-Lighting Fittings Layout	RE-E-006
07/17	GROUND FLOOR-Power Fittings Layout	RE-E-007
08/17	GROUND FLOOR-Telephone & TV Fittings Layout	RE-E-008
09/17	TYPICAL FLOOR-Lighting Fittings Layout	RE-E-009
10/17	TYPICAL FLOOR-Power Fittings Layout	RE-E-010
11/17	TYPICAL FLOOR-Telephone & TV Fittings Layout	RE-E-011
12/17	TYPICAL FLAT PANEL-DB-G1 Single Line Power Diagram	RE-E-012
13/17	UNDERGROUND FLOOR-DB-B Single Line Power Diagram	RE-E-013
14/17	UNDERGROUND FLOOR-MDB Main Distribution Board	RE-E-014
15/17	Power Cables Riser Diagram	RE-E-015
16/17	Telephone Cables Riser Diagram	RE-E-016


SYMBOL	DESCRIPTION
-(16A SINGLE PHASE, 3-PIN SOCKET OUTLET H=45CM F.F.F.L
	16A SINGLE PHASE, 3-PIN SOCKET OUTLET, WATER PROOF.IP65
	H=140CM F.F.F.L
À	1x20A – 220V AIR CONDITIONING SOCKETOUTLET
	+CONTROL SWITCH WITH INDICATOR LAMP. H=160CM F.F.F.L
## - K	THREE PHASE, SOCKET OUTLET H=140CM F.F.F.L
W.H.	ELECTRICAL WATER HEATER H=180CM F.F.F.L
	OUTDOOR A/C UNITS
	A/C SPLIT UNIT
	SUB-DISTRIBUTION BOARD H=160CM F.F.F.L
	MAIN DISTRIBUTION BOARD (MDB)
	WALL OR WINDOW MOUNTED EXHAUST FAN
$\bigcirc \bigtriangledown$	Electrical Bell
\square	RJ11 TELEPHONE SOCKET OUTLET.
TEL	TELEPHONE JUNCTION BOX H=45CM F.F.F.L
	Intercom Indoor Handle H=160CM F.F.F.L
	Intercom Outdoor Panel H=160CM F.F.F.L
	TV SOCKET OUTLET H=45CM F.F.L
TV	TELEPHONE JUNCTION BOX H=45CM F.F.L
MTF	MAIN TELEPHONE FRAME H=45CM F.F.L


SYMBOL	DESCRIPTION
	2x36W SURFACE MOUNTED FLUORESCENT LIGHTING FIXT WITH OUT REFLECTOR IP20
EM	DITTO BUT WITH BACK UP POWER BUILT IN, FOR 1.5HR
	2x36W SURFACE MOUNTED FLUORESCENT LIGHTING FIXT WATER PROOF IP65
EM	2x36W SURFACE MOUNTED FLUORESCENT LIGHTING FIXT WATER PROOF IP65
	26W COMPACT FLUORESCENT SURFACE MOUNTED LIGHT
-	DITTO BUT WALL MOUNTED
-18	10W INCANDESCENT WALL MOUNTED DECORATIVE NIGHT
	CHNDELIER
6	1-GANG LIGHTING SWITCH, ONE WAY 16A H=140CM
6	DITTO BUT WATER PROOF IP 65 . H=140CM F.F.F.
Ś	2-GANG LIGHTING SWITCH, ONE WAY 16A H=140CM
S	DITTO BUT WATER PROOF IP 65 . H=140CM
e la construcción de la construc	3-GANG LIGHTING SWITCH, ONE WAY 16A H=140CM
J.	DITTO BUT WATER PROOF IP 65 . H=140CM
Ś	2-WAY LIGHTING SWITCH, 16A H=140CM
Ś	DITTO BUT WATER PROOF IP 65 . H=140CM
•	PUSHBUTTON LIGHTING SWITCH, ONE WAY 10A H=14

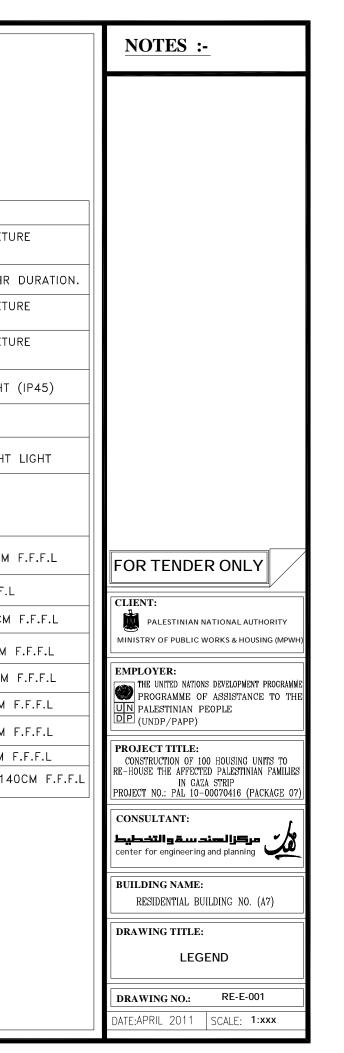


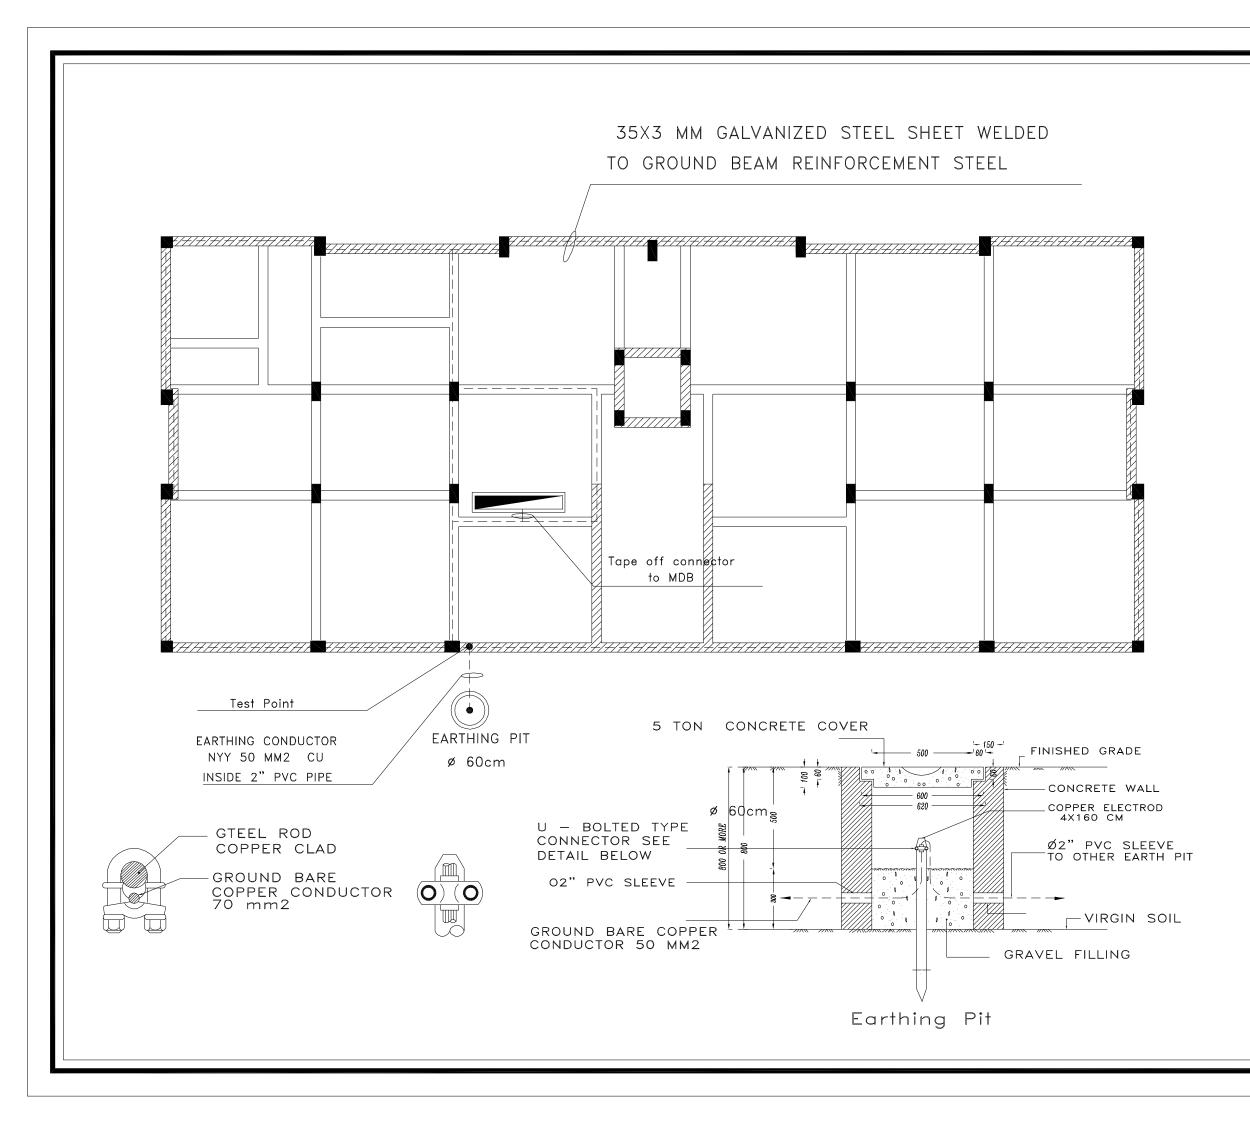


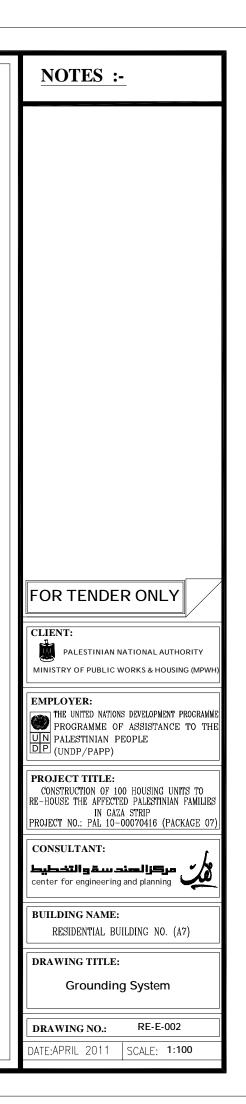


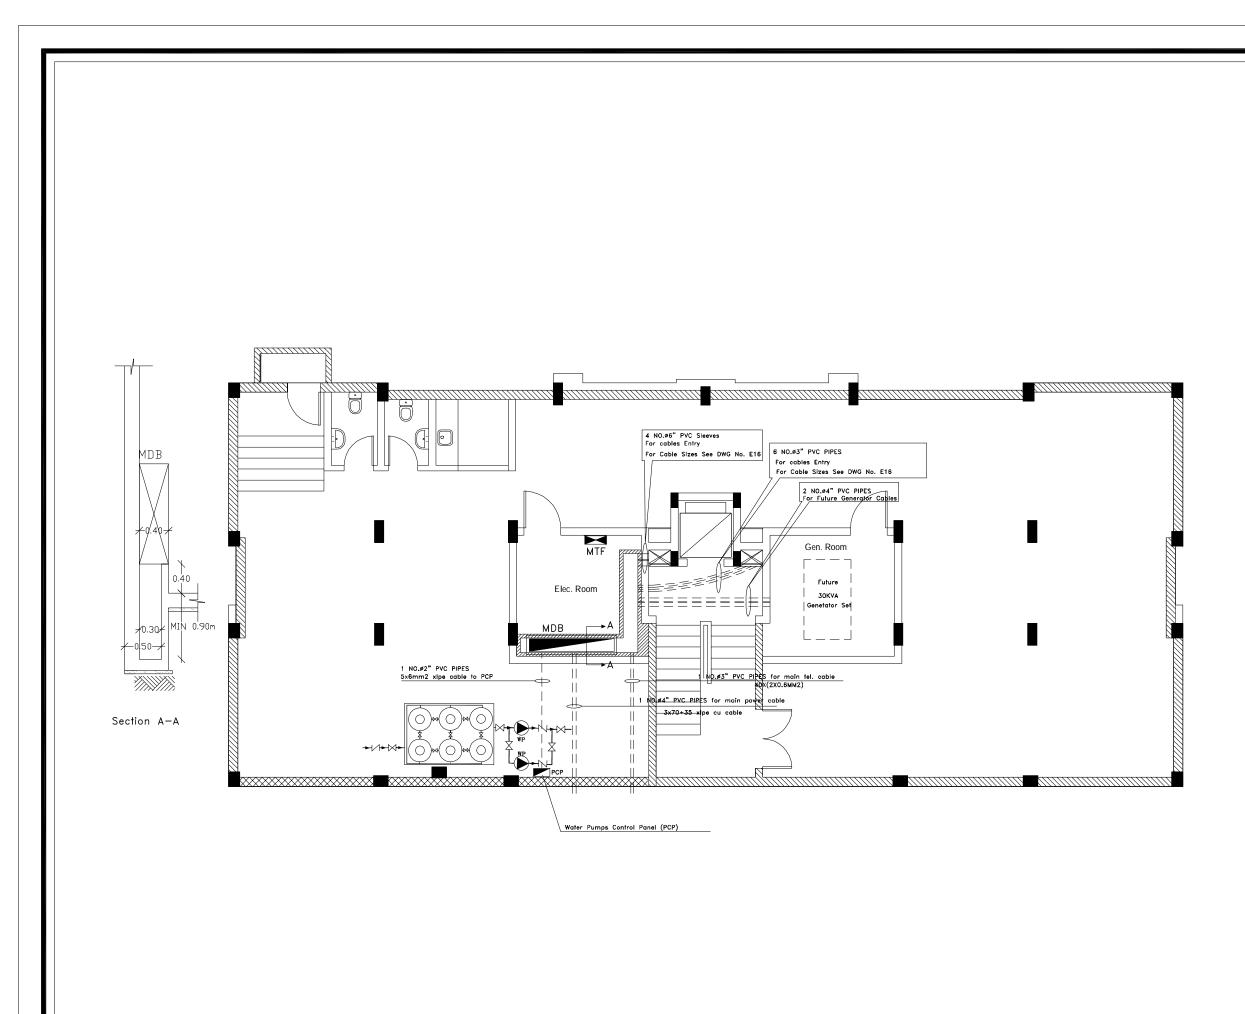


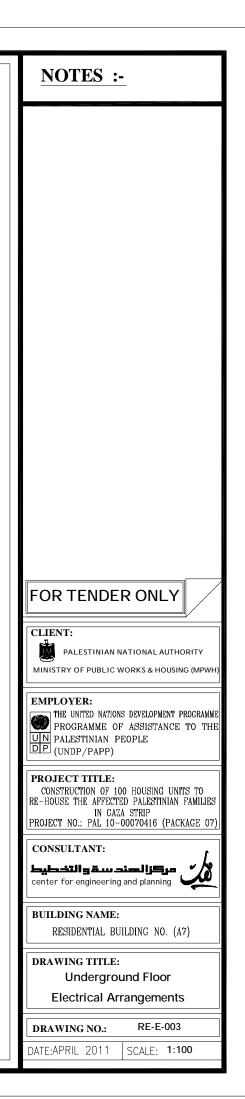


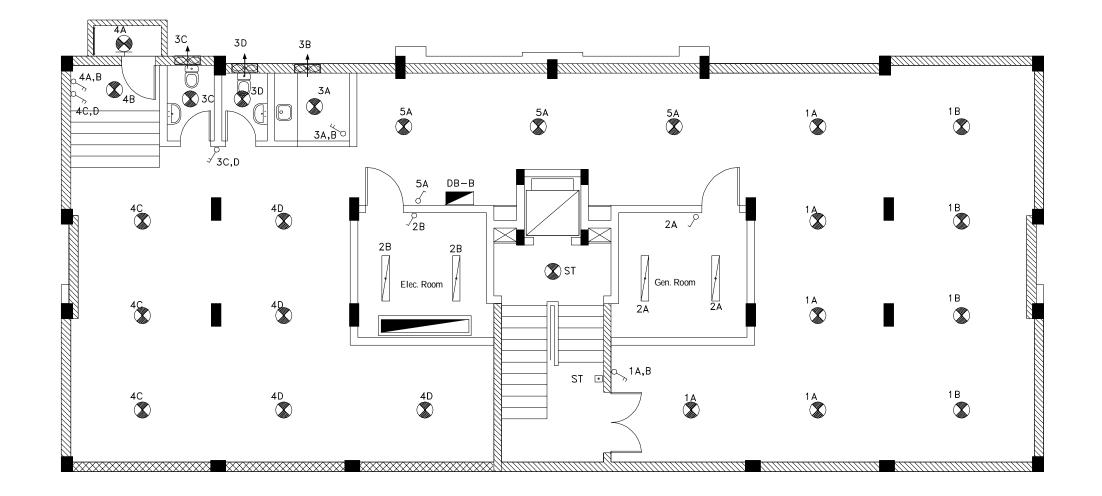


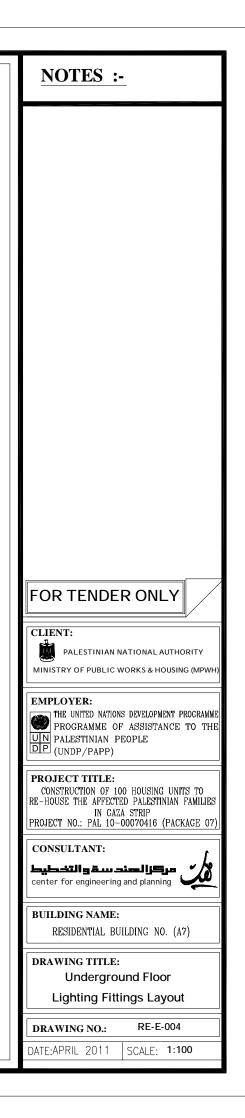


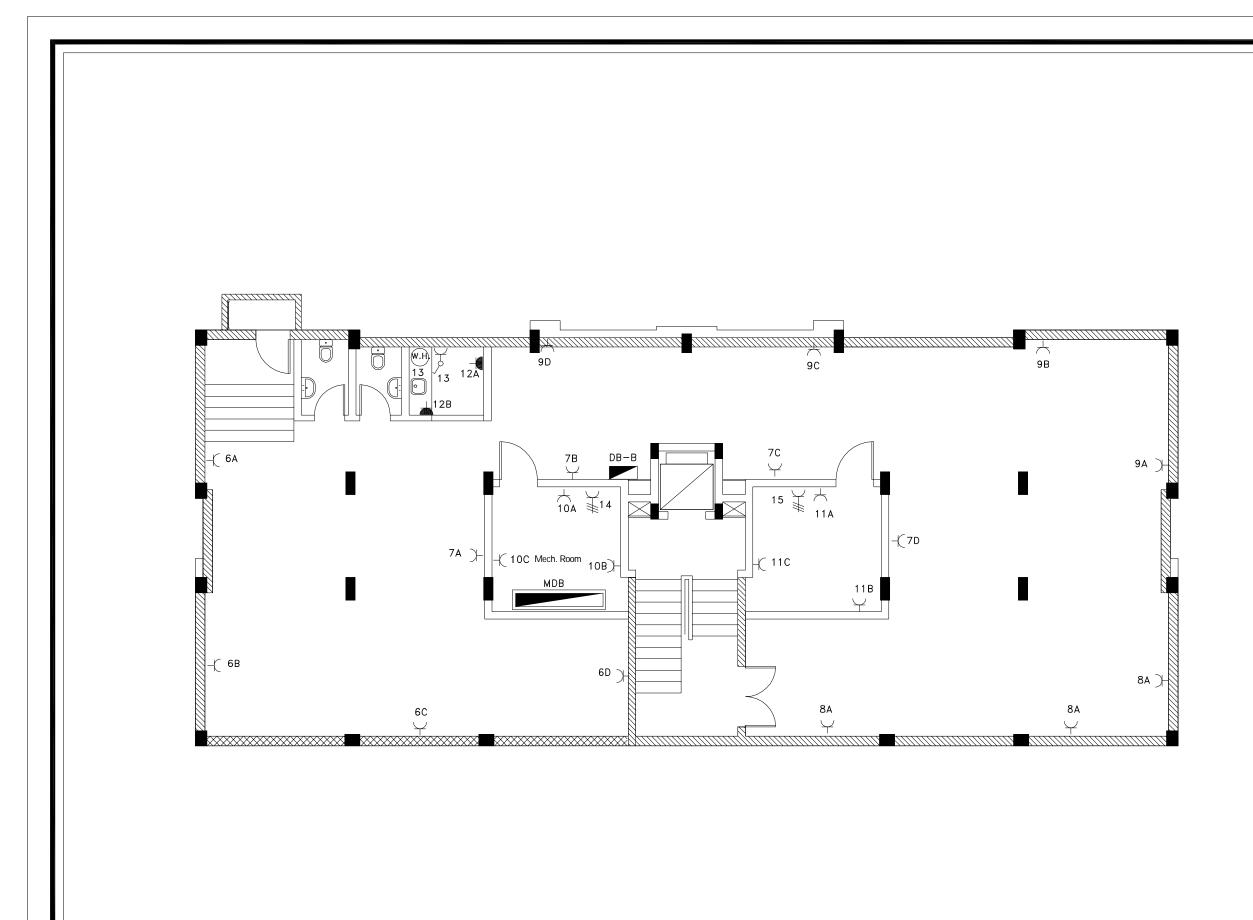


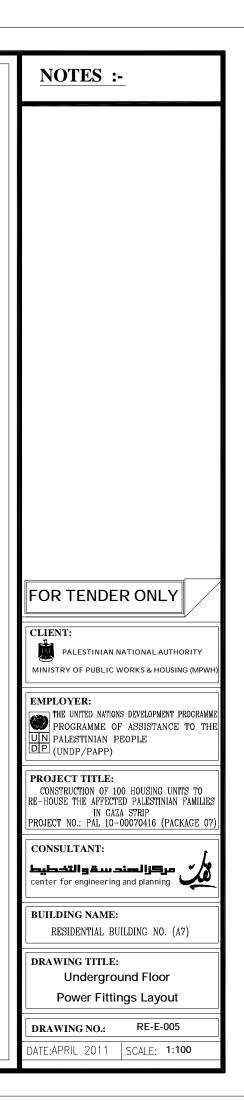


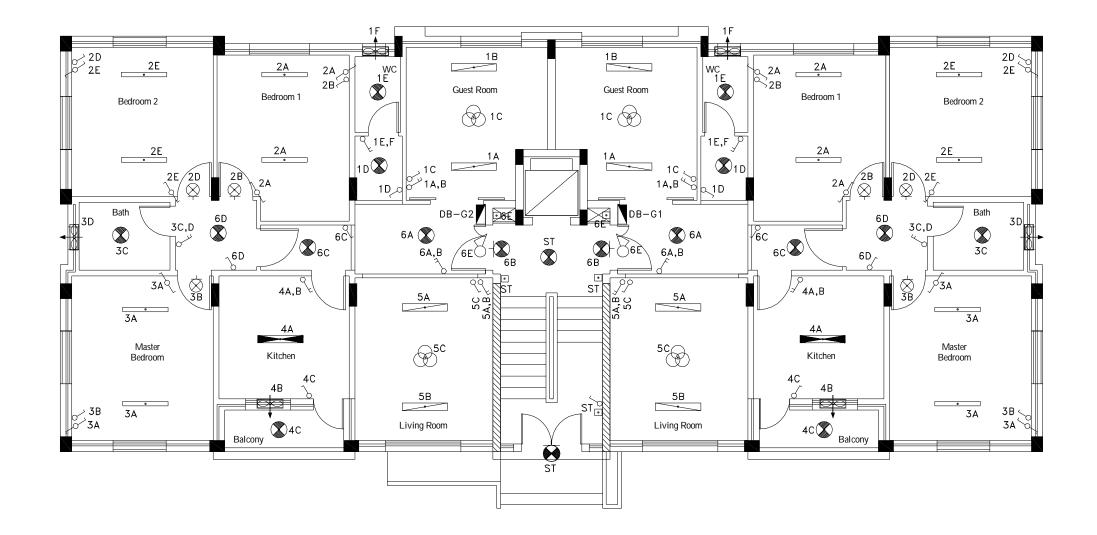


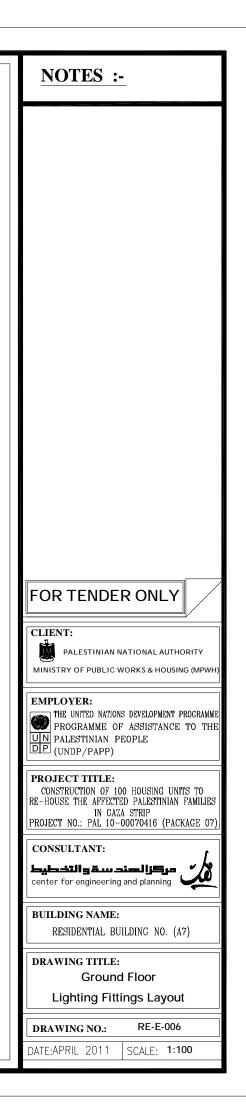


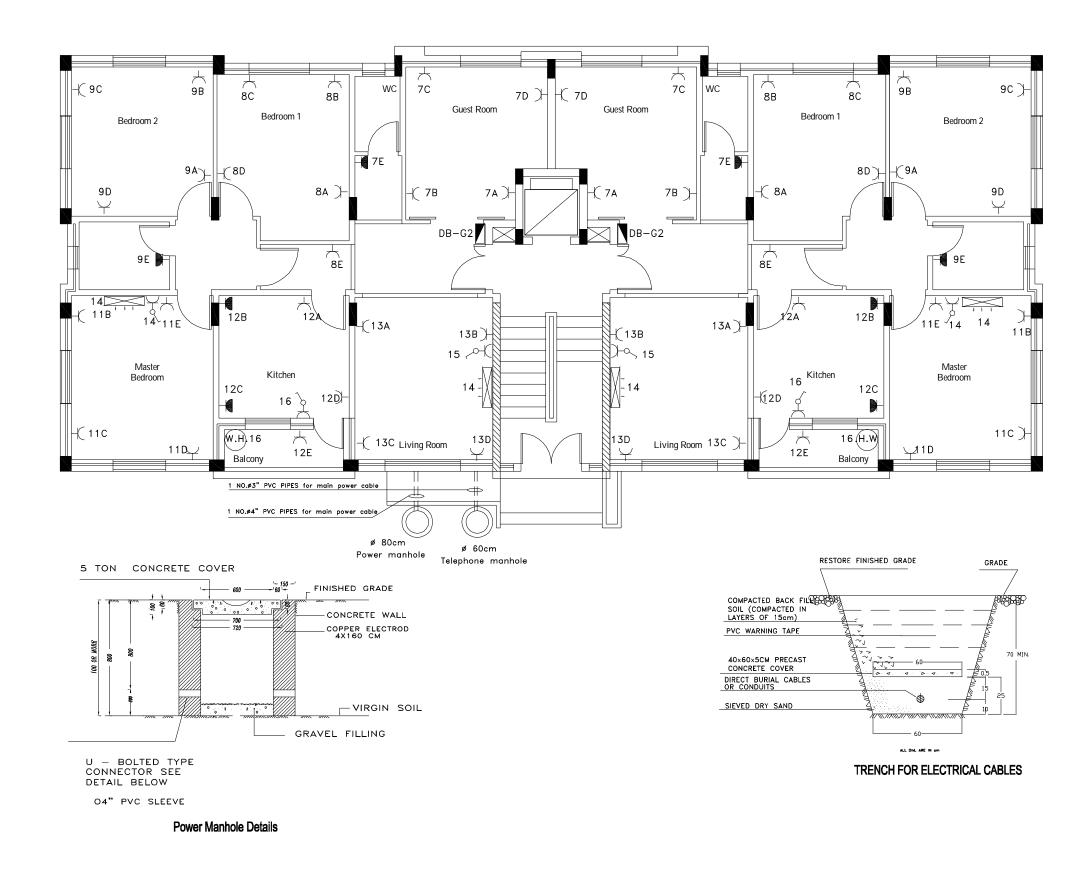


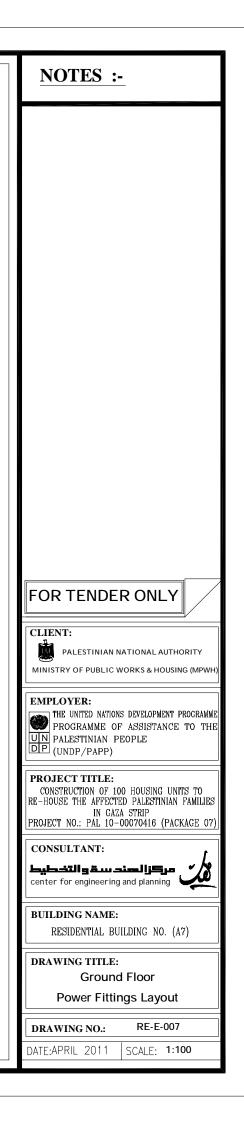


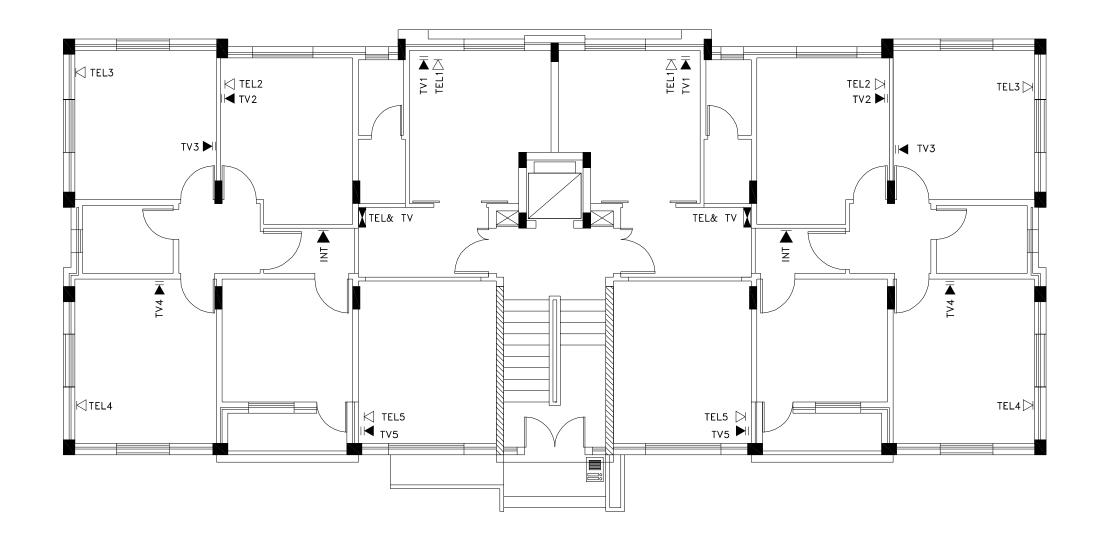


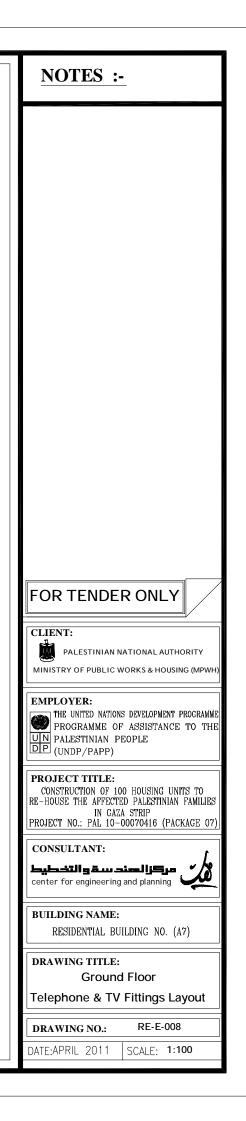


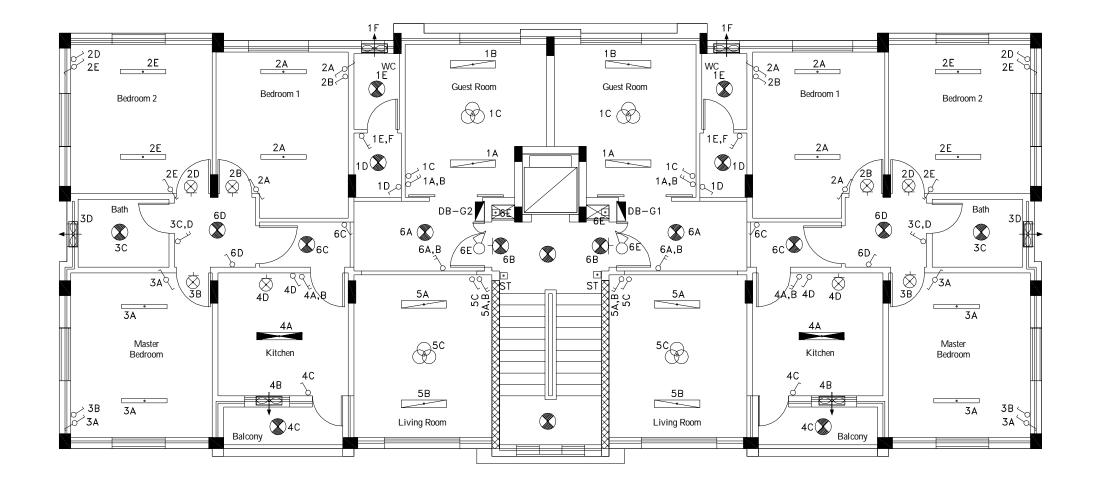


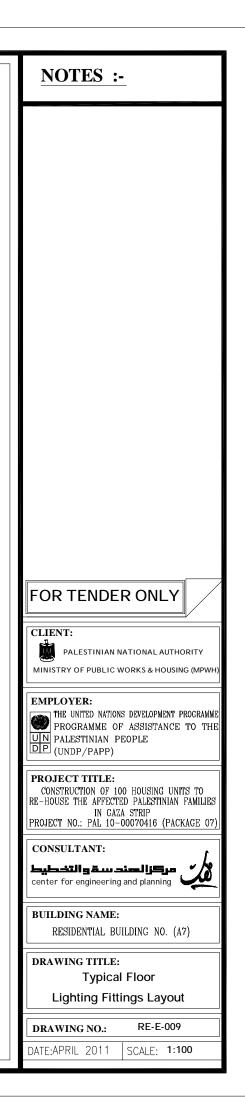


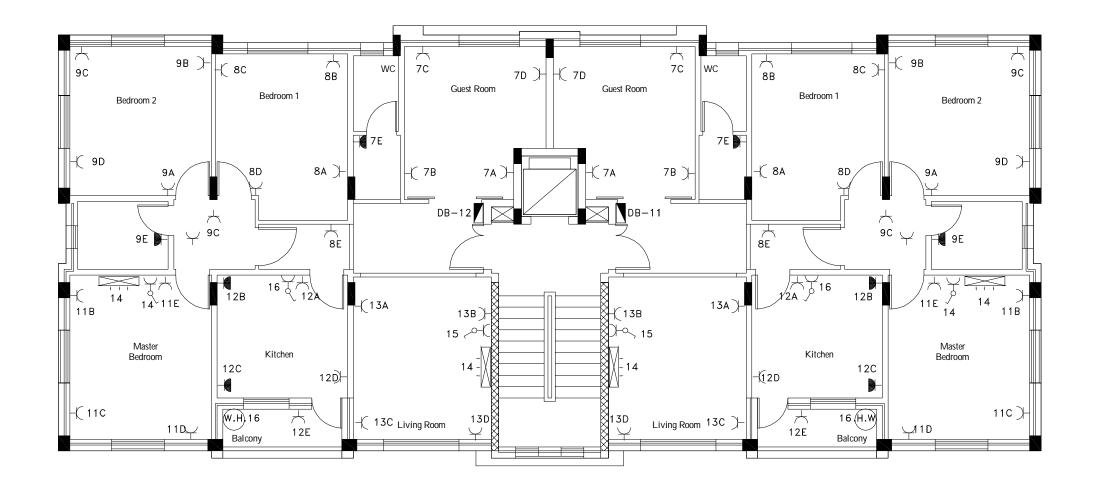


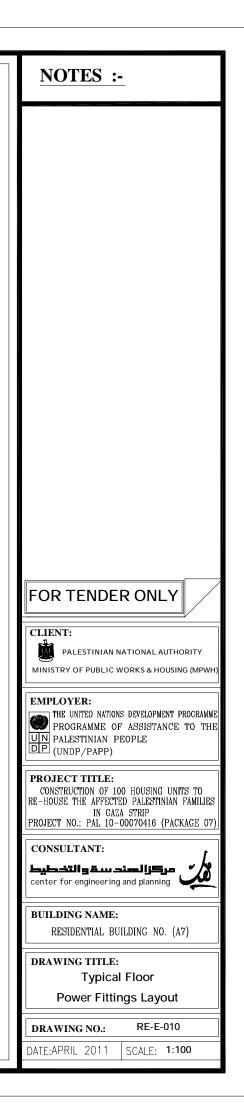


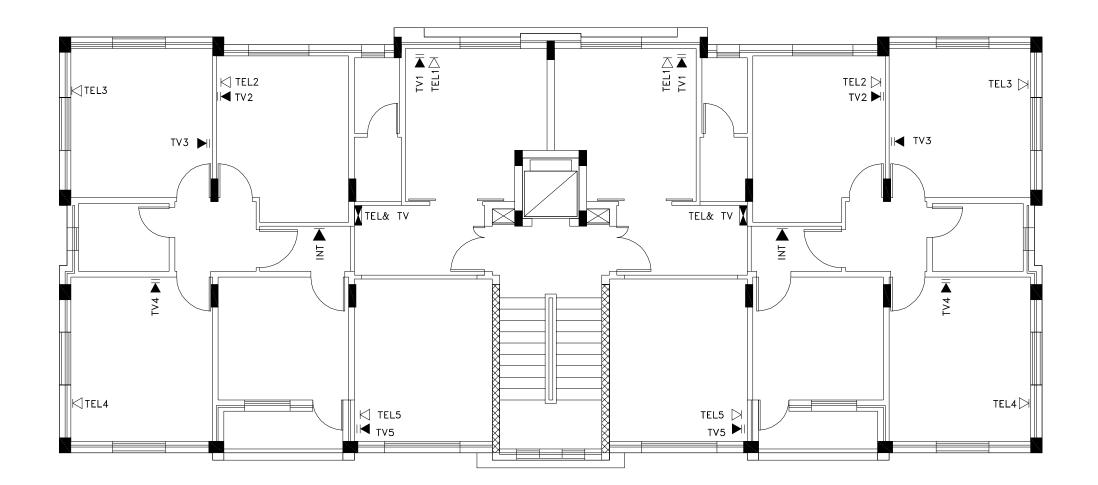


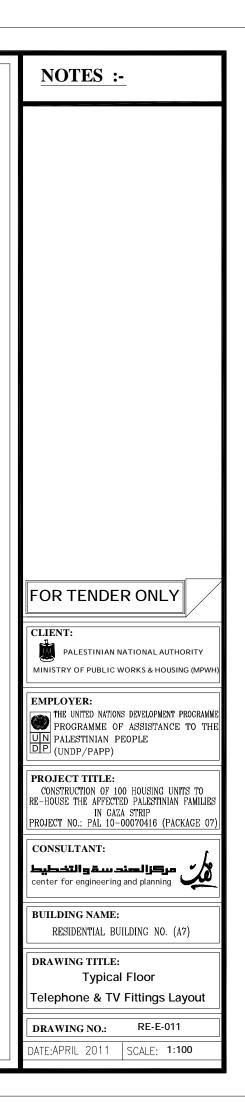


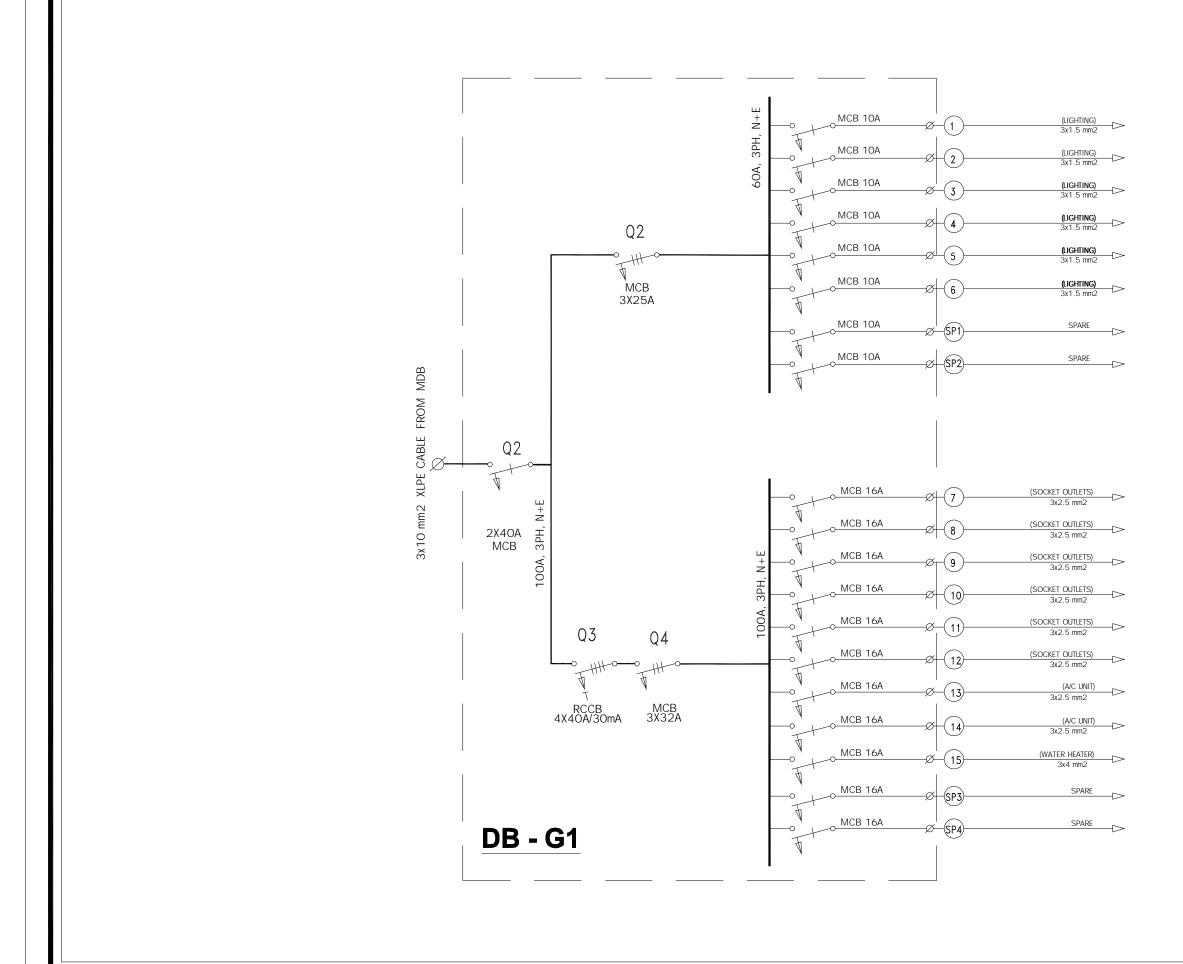


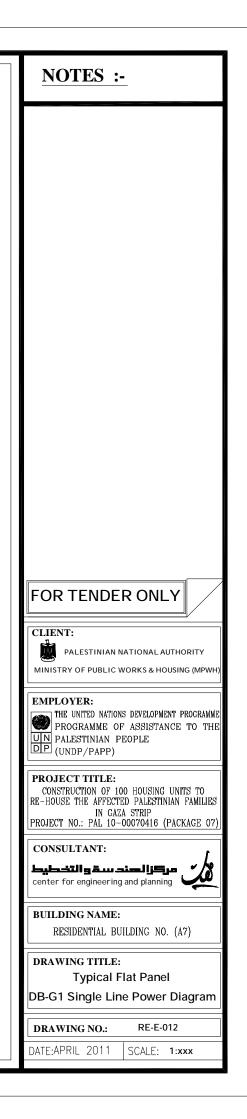


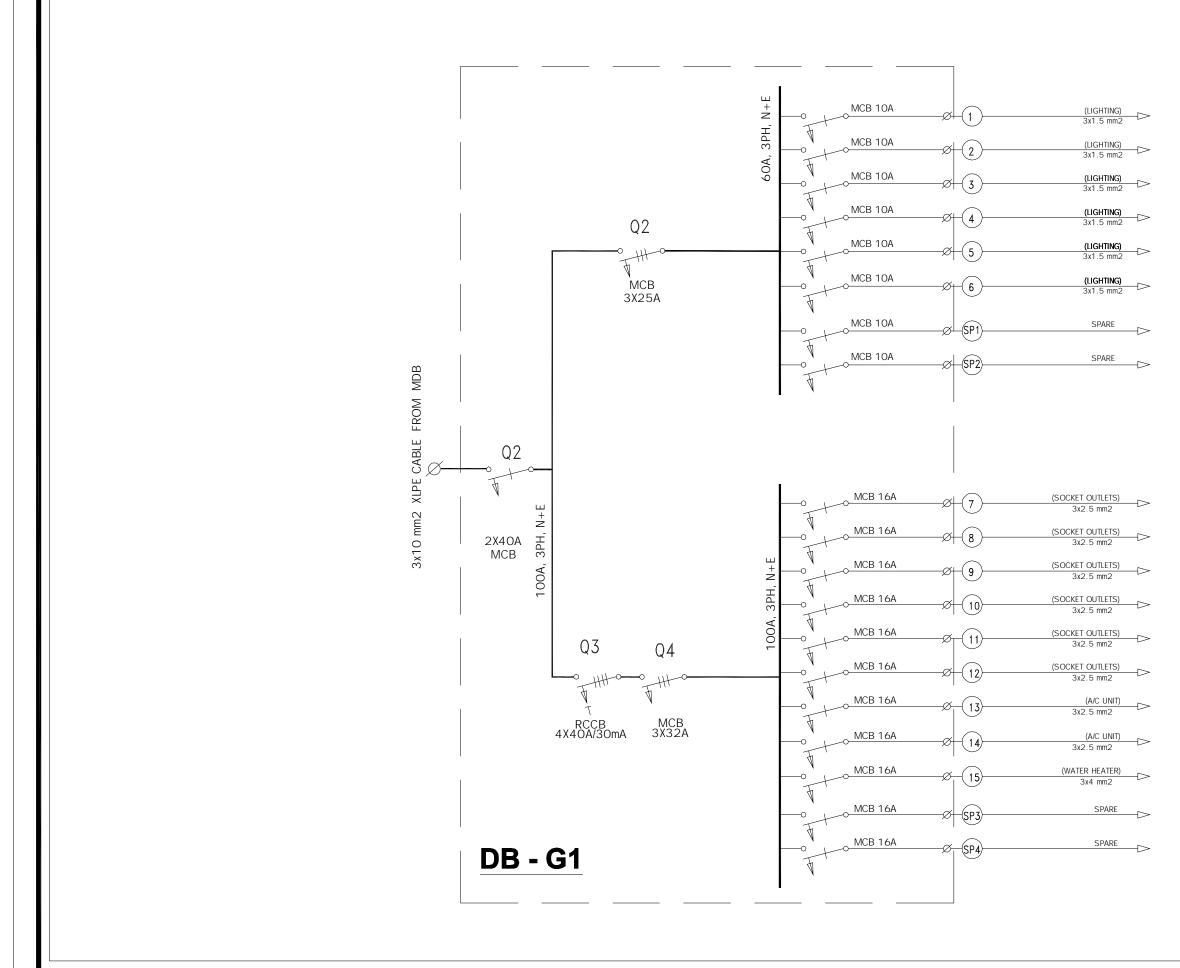


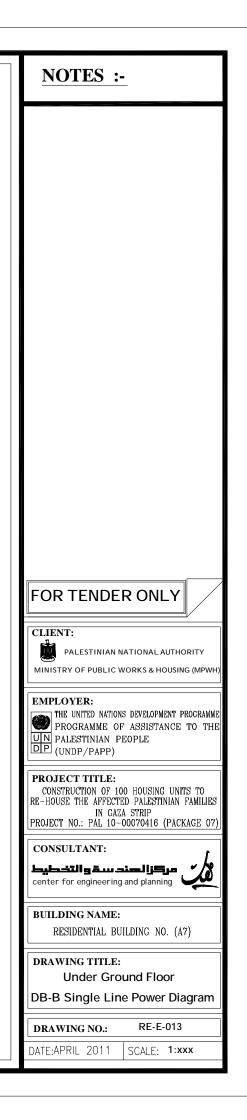


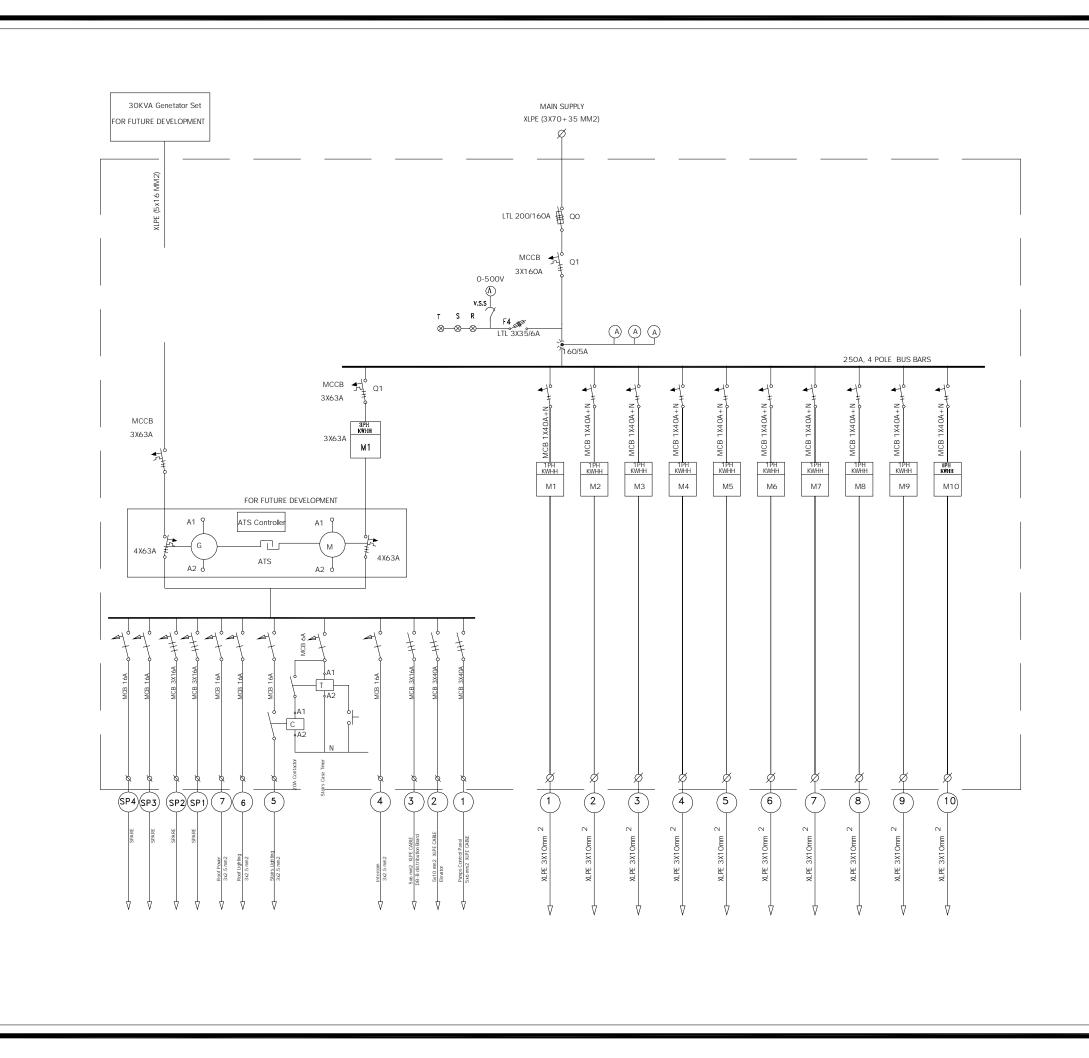


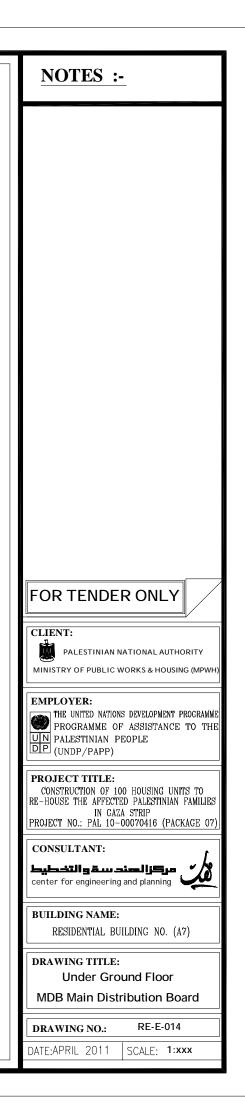


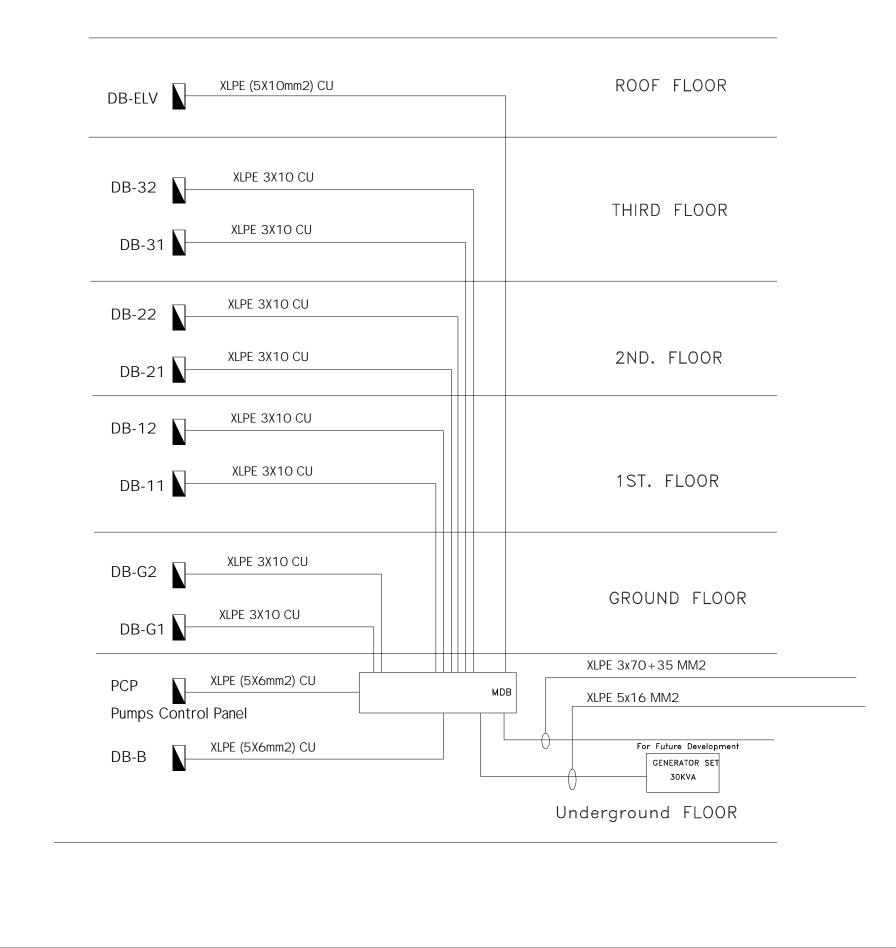

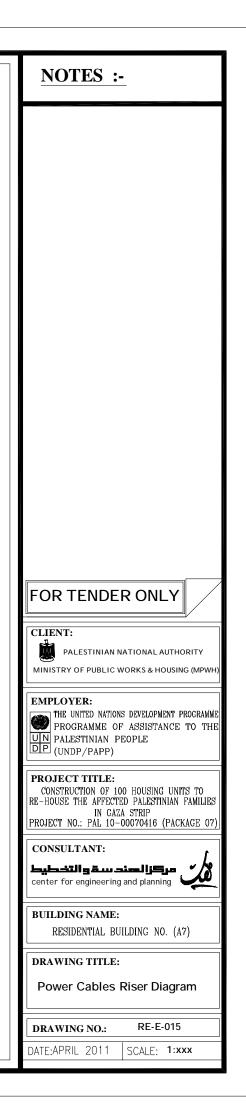

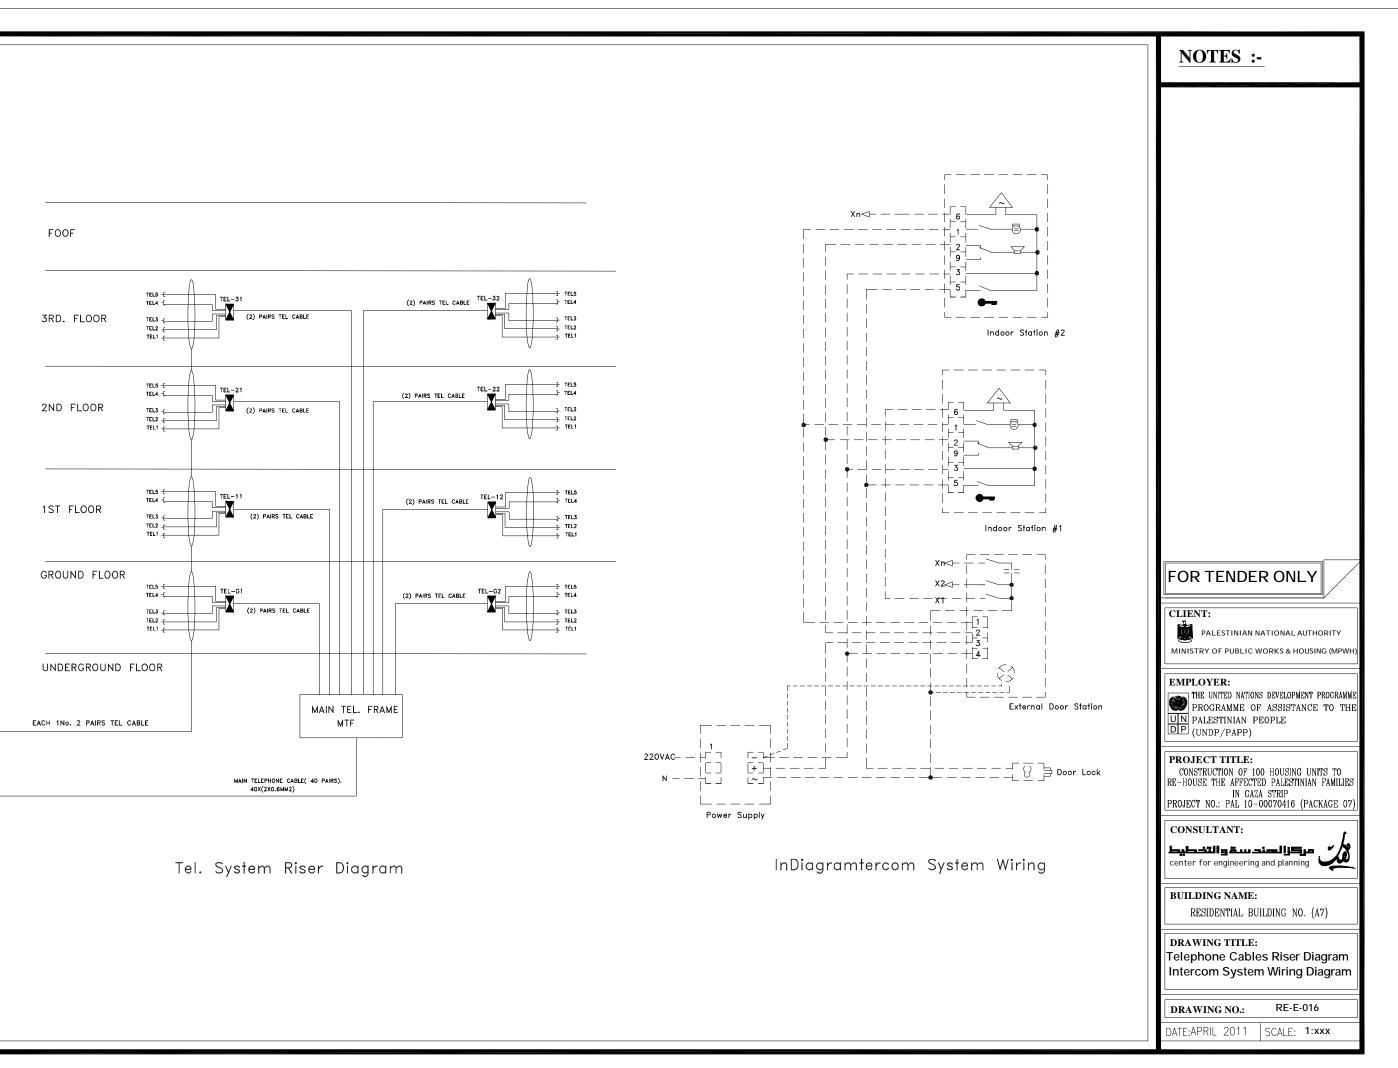

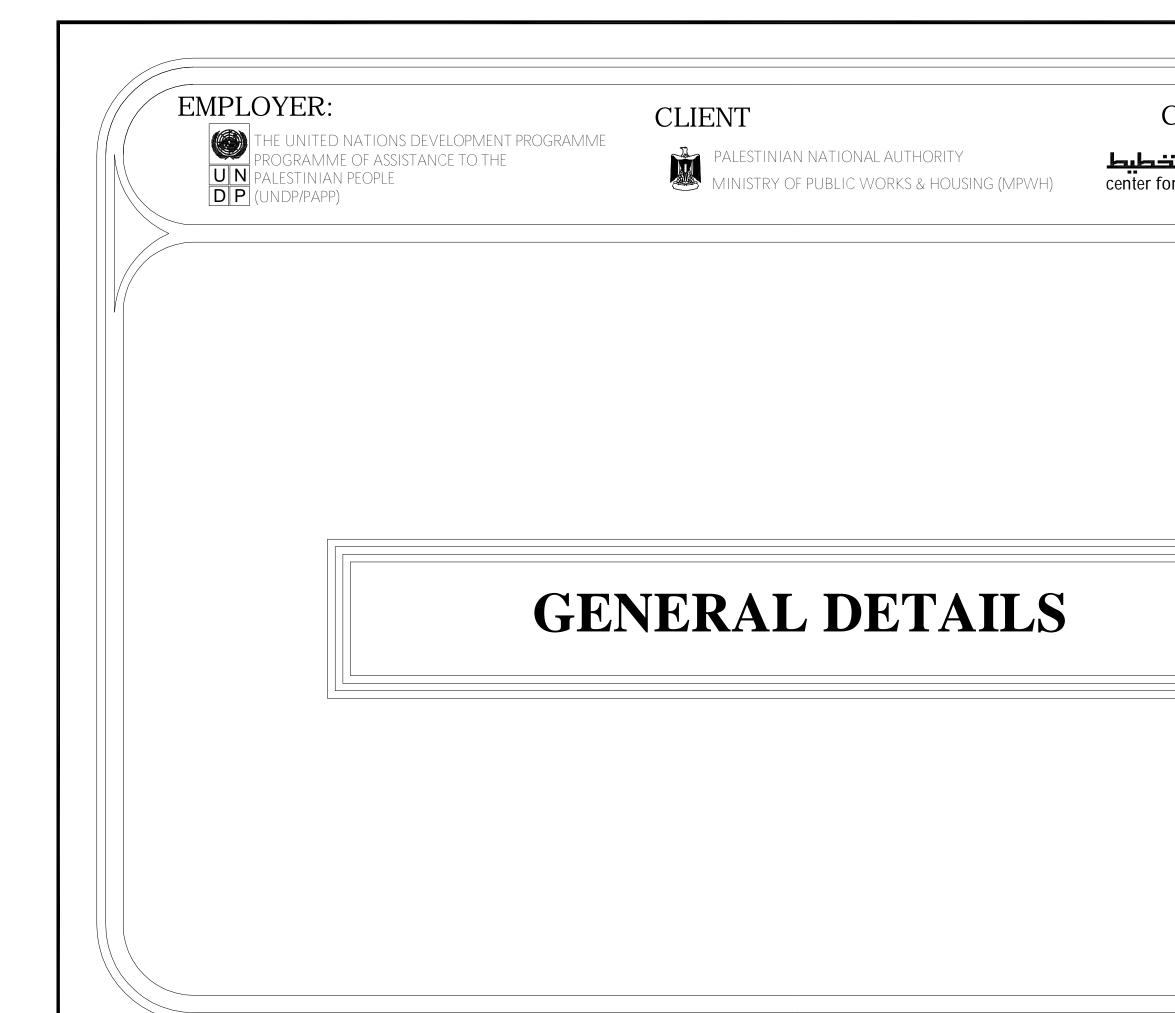

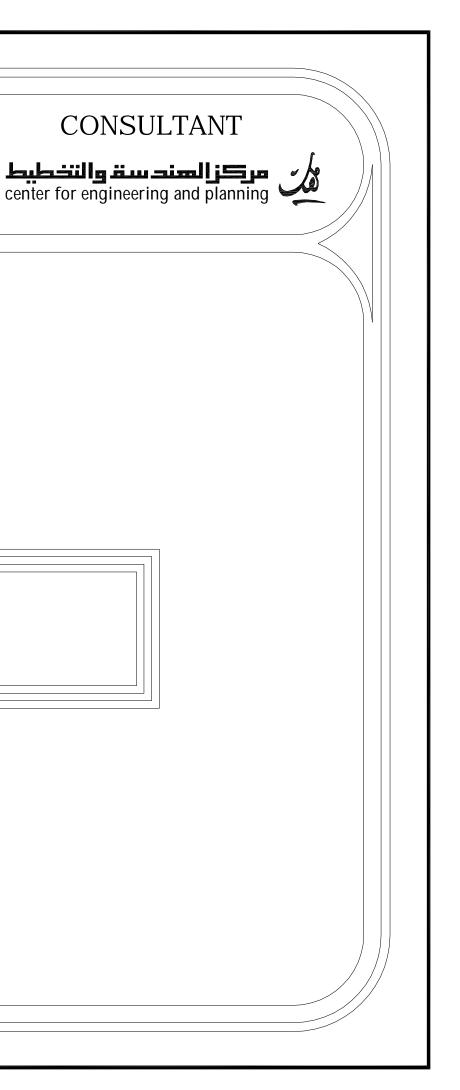

EMPLOYER:




THE UNITED NATIONS DEVELOPMENT PROGRAMME PROGRAMME OF ASSISTANCE TO THE UN PALESTINIAN PEOPLE DP (UNDP/PAPP)

CLIENT





PALESTINIAN NATIONAL AUTHORITY MINISTRY OF PUBLIC WORKS & HOUSIN MINISTRY OF PUBLIC WORKS & HOUSING (MPWH)

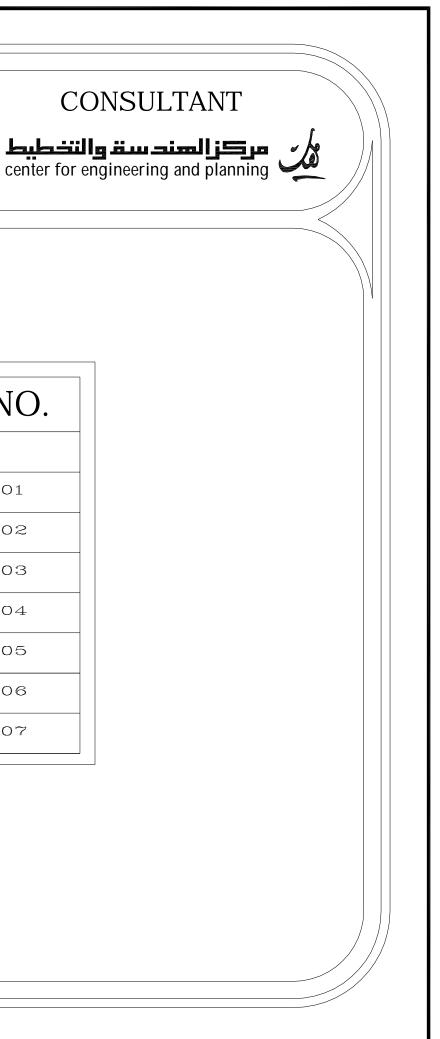



LIST OF DRAWINGS


S/NO.	DRAWING NAME	DRG. NO.
	GENERAL DETAILS	
01/07	GENERAL DETAILS (1)	RE-GD-001
02/07	GENERAL DETAILS (2)	RE-GD-002
03/07	GENERAL DETAILS (3)	RE-GD-003
04/07	GENERAL DETAILS (4)	RE-GD-004
05/07	GENERAL DETAILS (5)	RE-GD-005
06/07	GENERAL DETAILS (6)	RE-GD-006
07/07	GENERAL DETAILS (7)	RE-GD-007

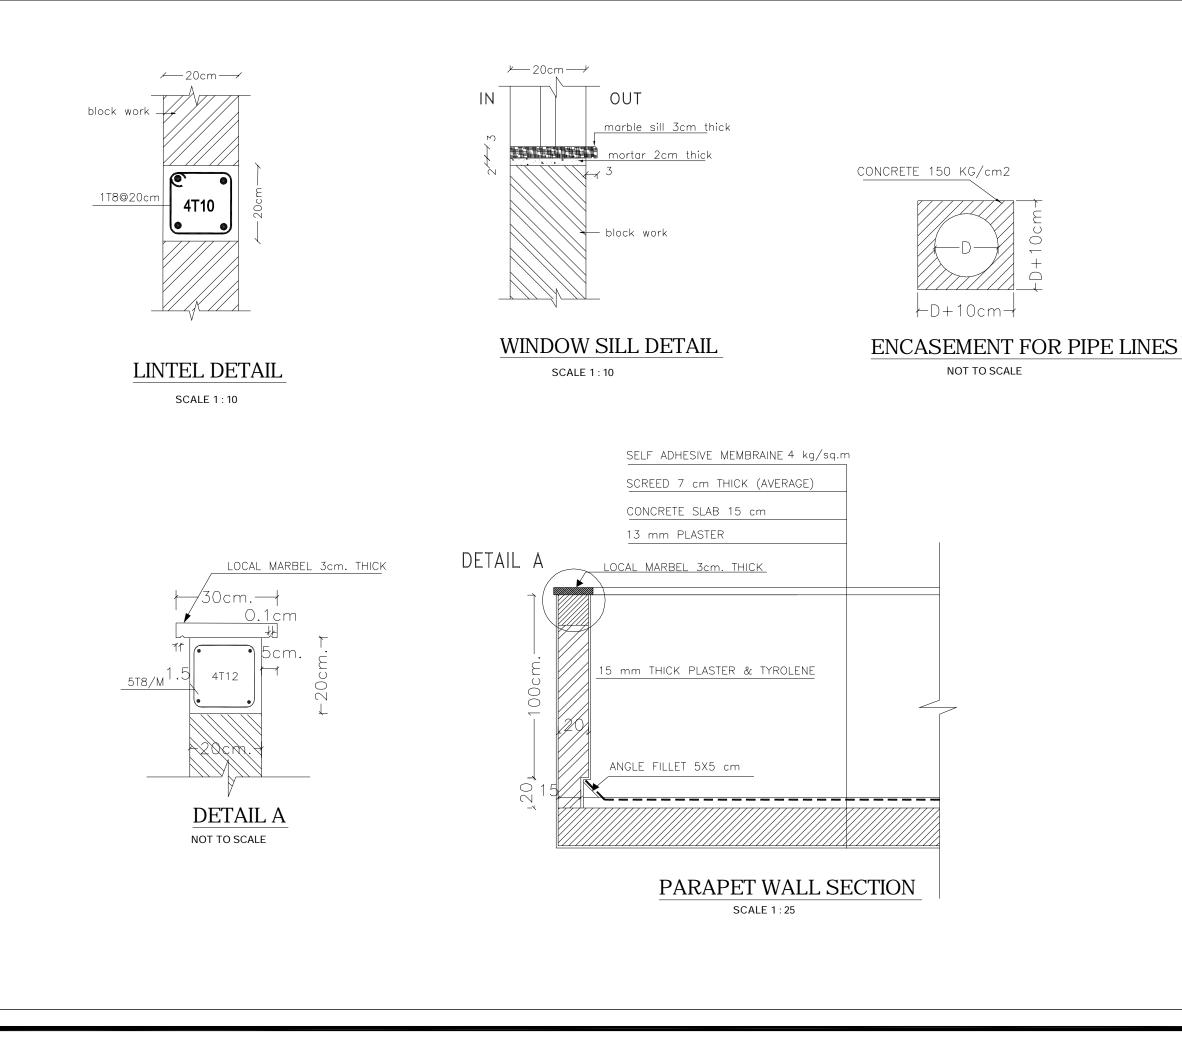


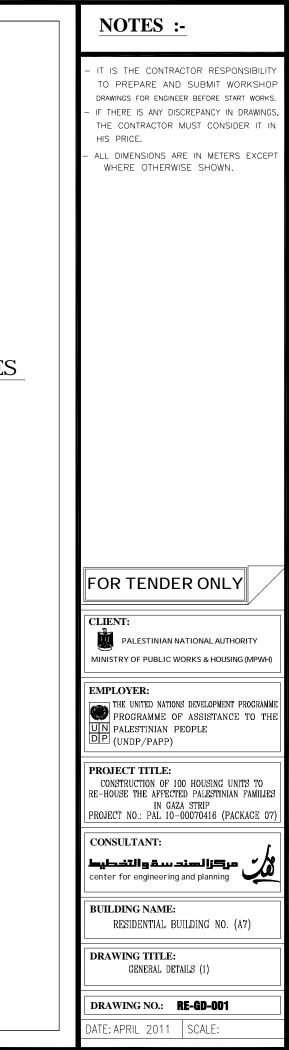


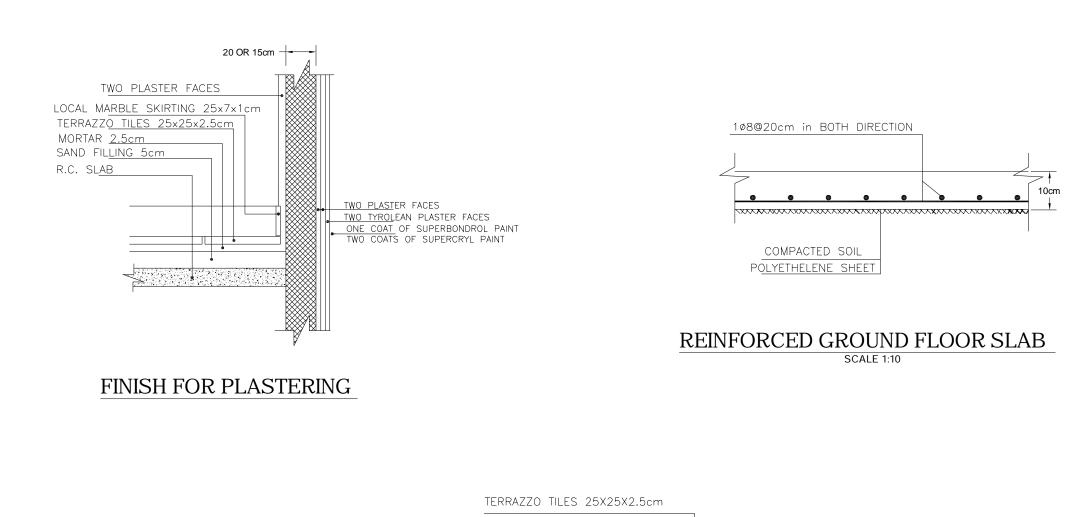


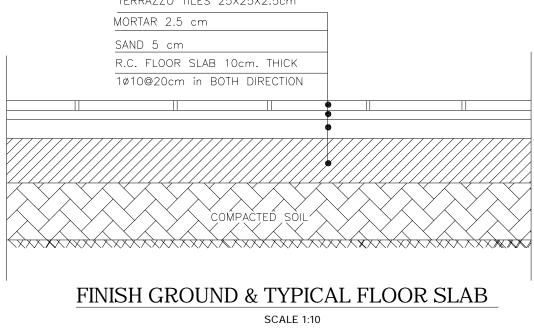


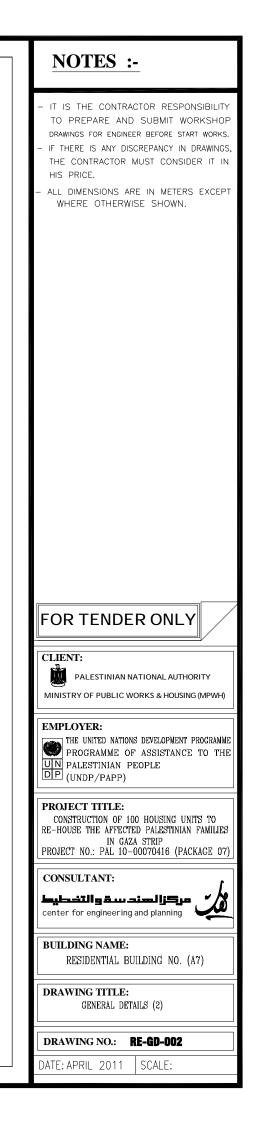


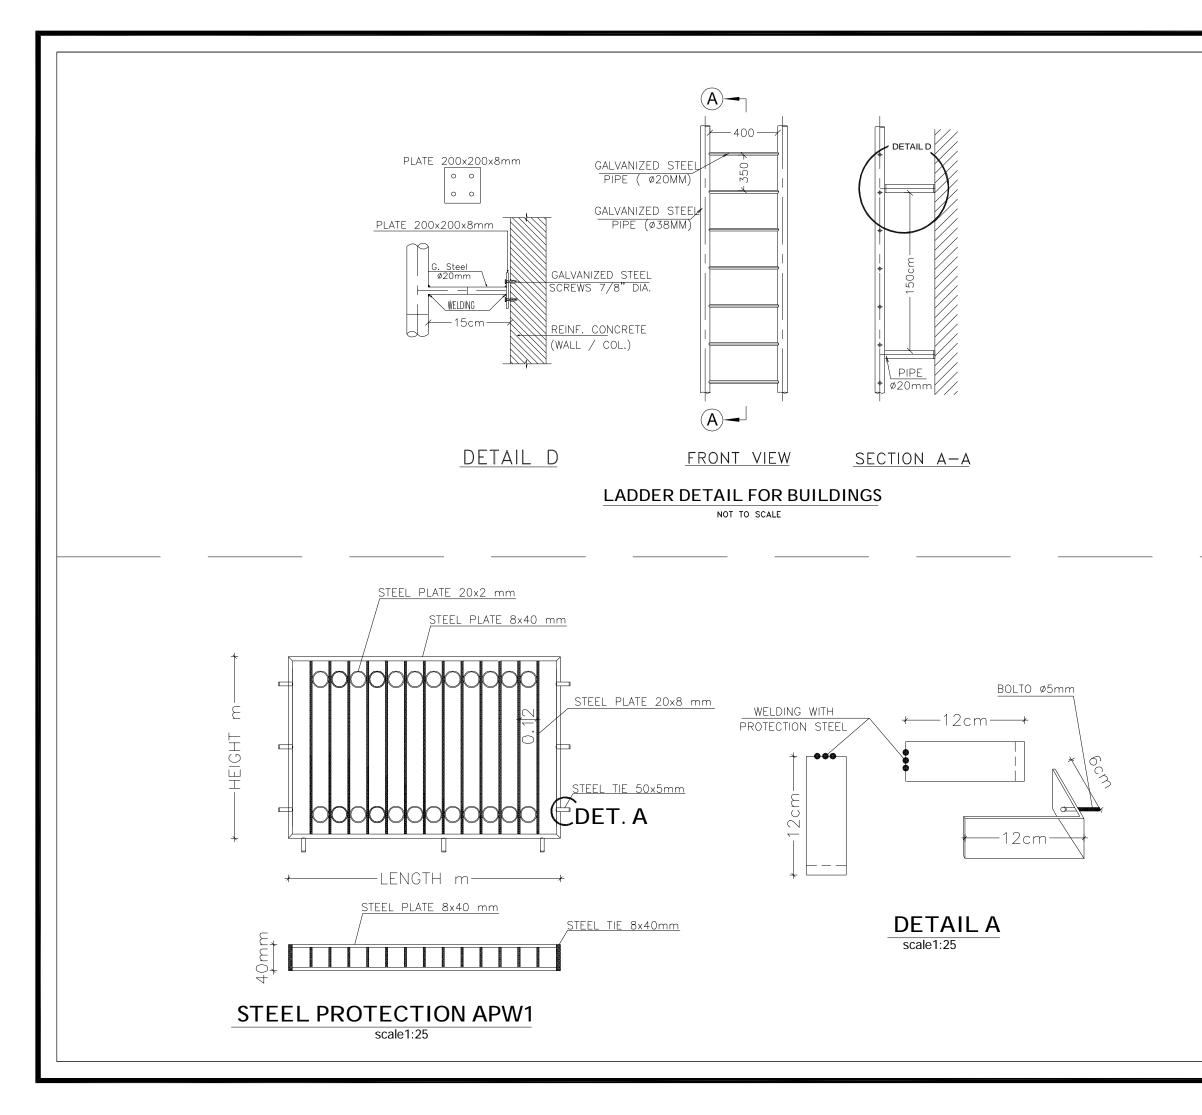


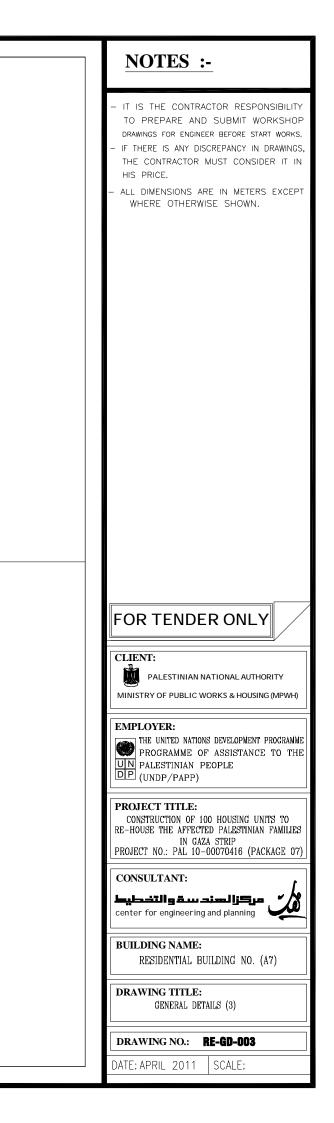

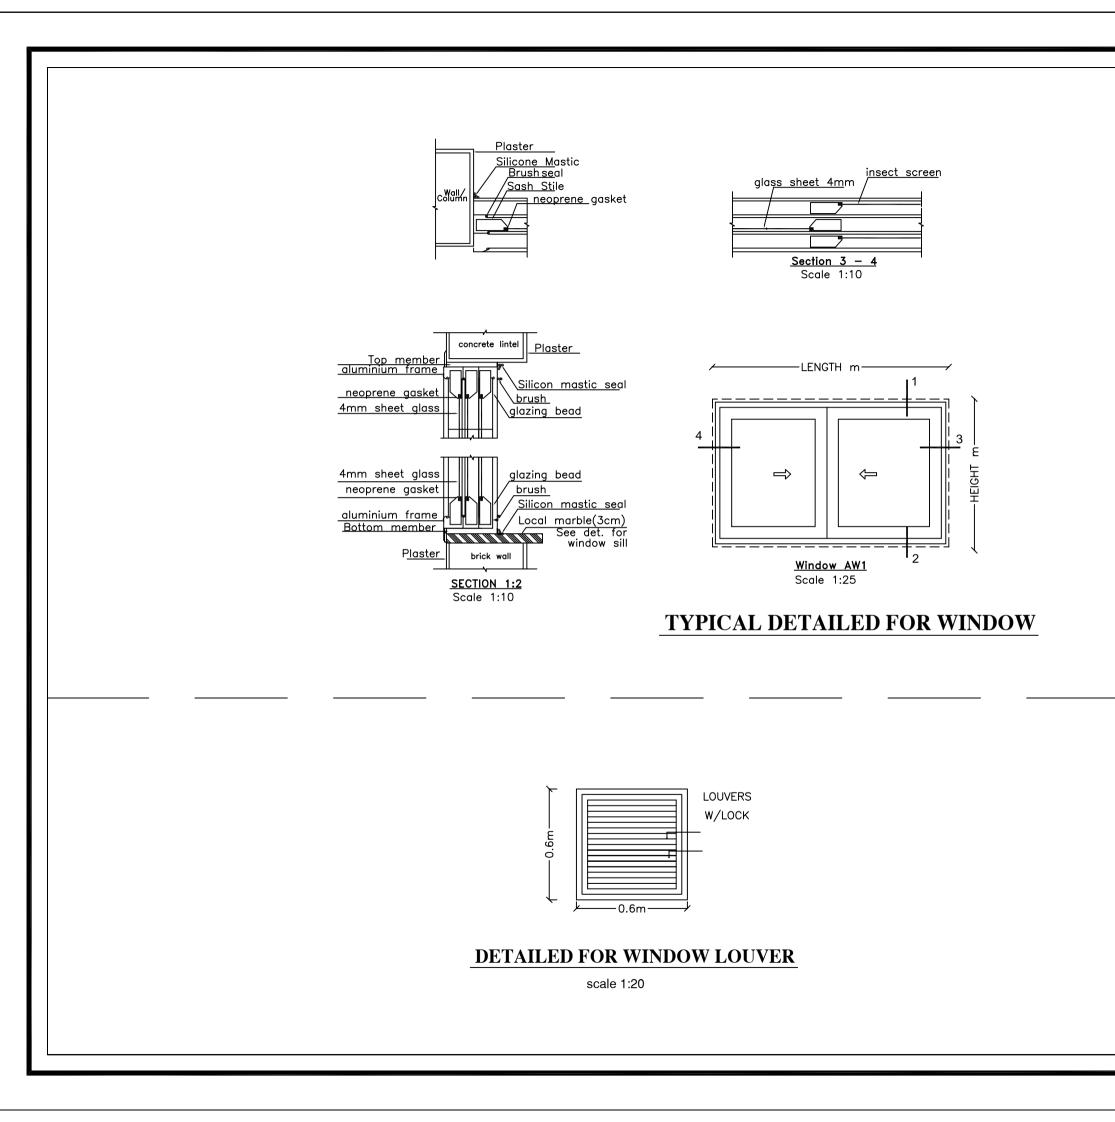

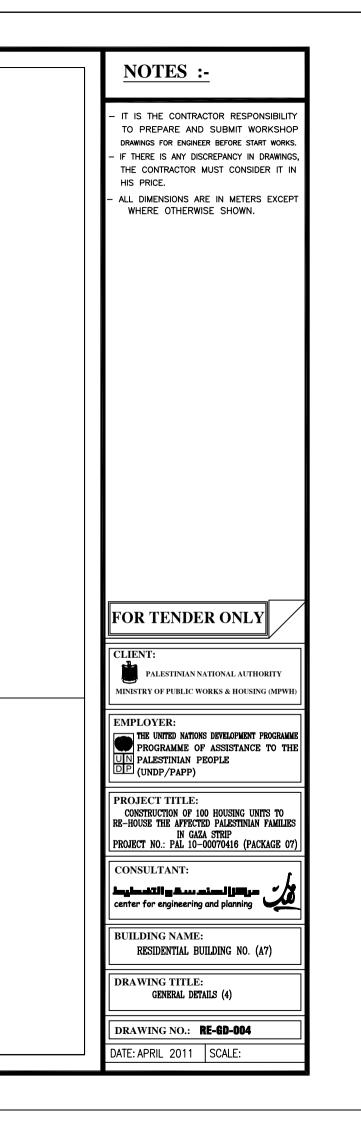


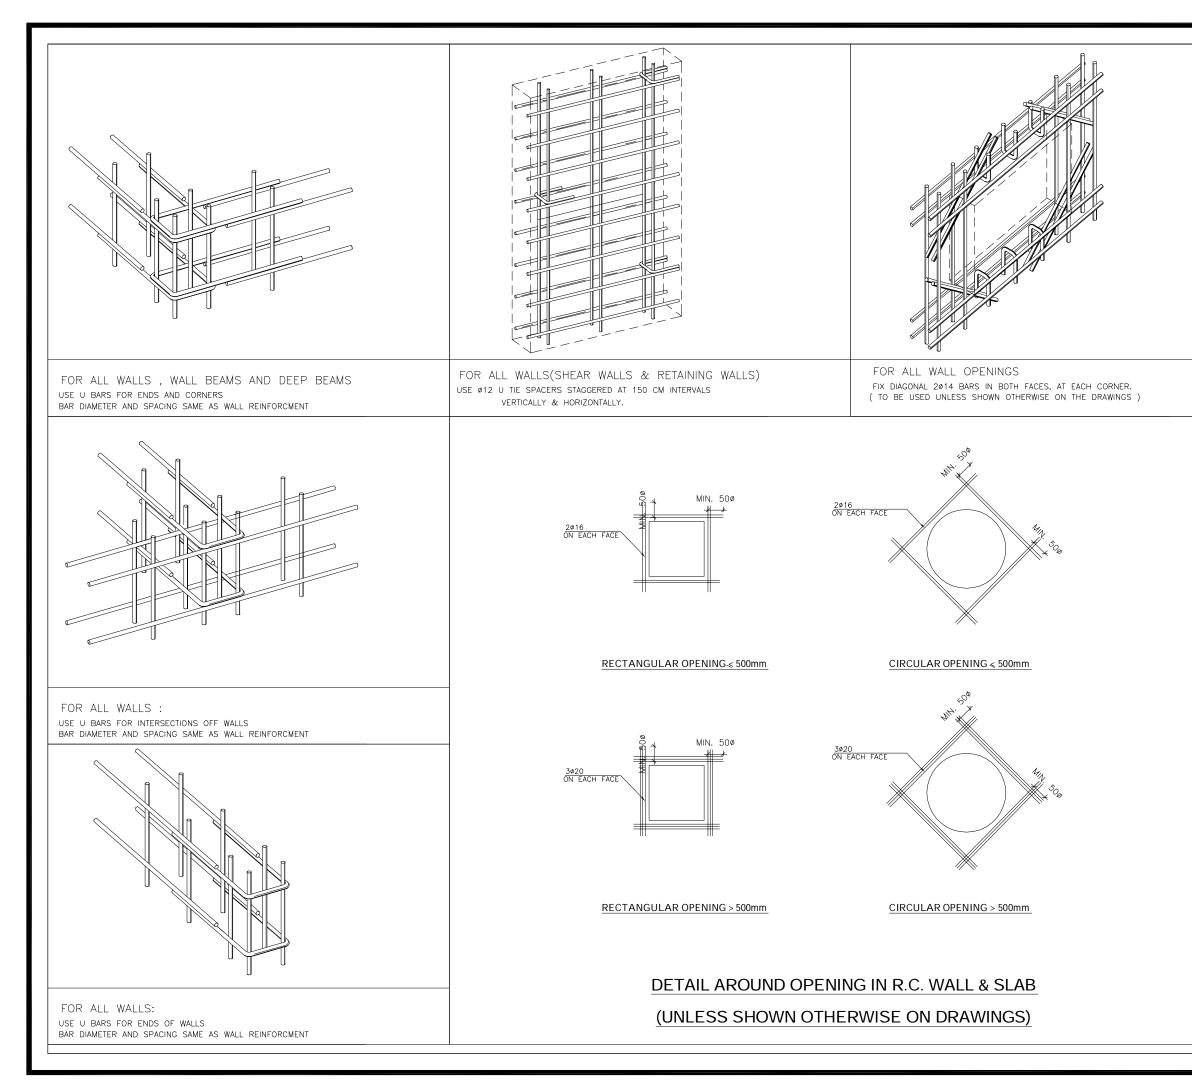


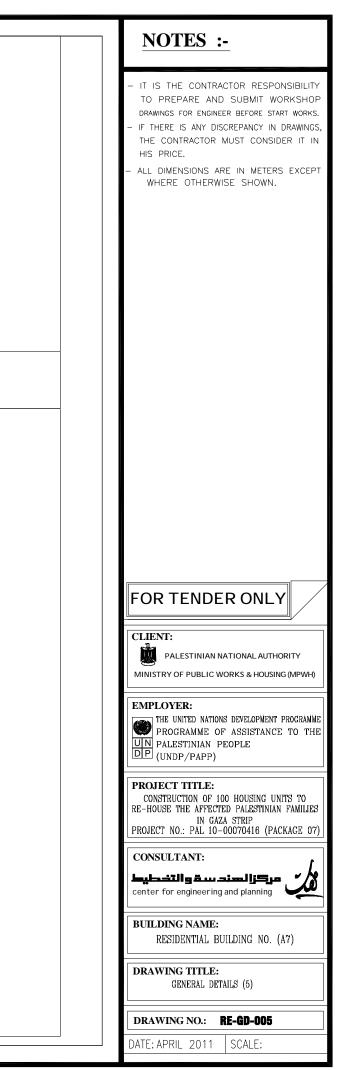


LINTELS DETAILS.


SCHEDULE OF LINTELS REINFORCEMENT										
LINTEL WIDTH	b=10cm.				b=15cm.		b=20cm./30cm.		DEPTH=	CTIPPUPC
CLEAR SPAN	TOP REINF.	BOTTOM REINF.	TOP REINF.	BOTTOM REINF.	TOP REINF.	BOTTOM REINF.	d	STIRRUPS		
< 200	1T12	1T14	2T12	2T12	2T12	2T14	20	1ø8@200mm		
200-300	1T12	1T14	2T12	2T14	2T12	2T16	25	1ø8@200mm		
301-400	1T12	1T16	2T12	2T14	2T12	2T16	30	1ø8@200mm		
401-500	1T12	1T16	2T14	2T16	2T14	2T20	35	1ø8@200mm		
501-600	1T14	1T20	2T14	2T16	2T14	2T20	40	1ø8@200mm		
601-700	1T14	1T20	2T14	2T20	2T14	2T20	50	1ø8@200mm		
701-800	1T14	1T20	2T16	2T20	2T16	3T20	55	1ø8@200mm		

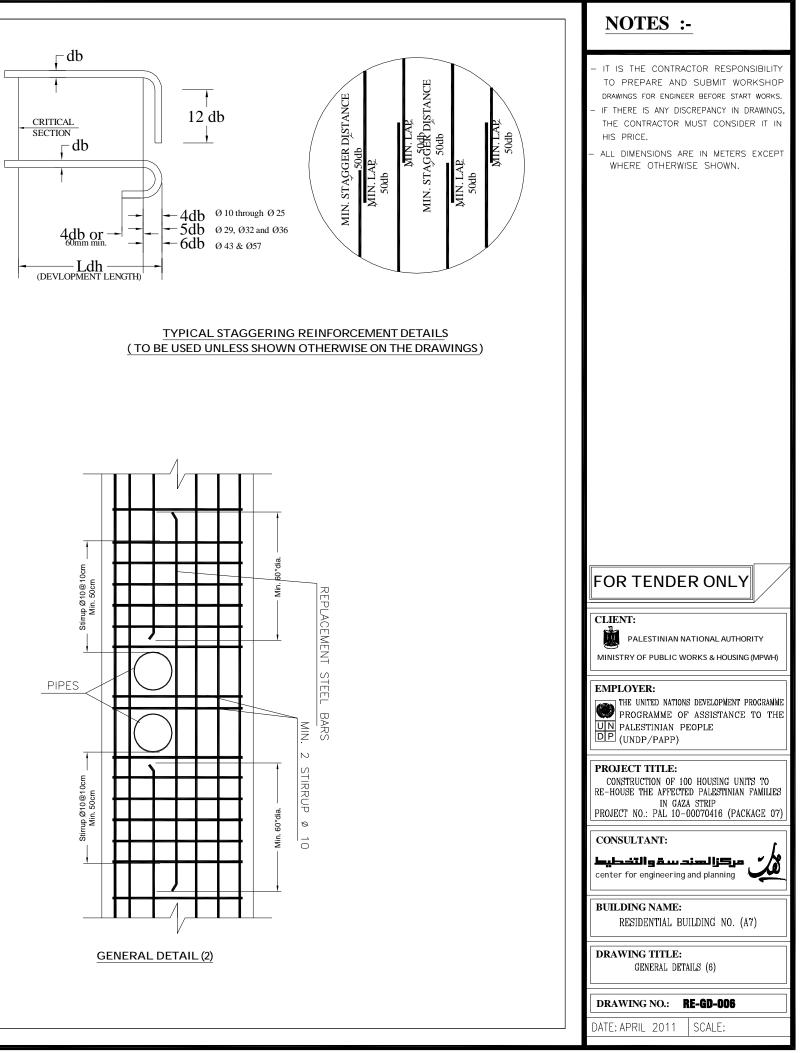


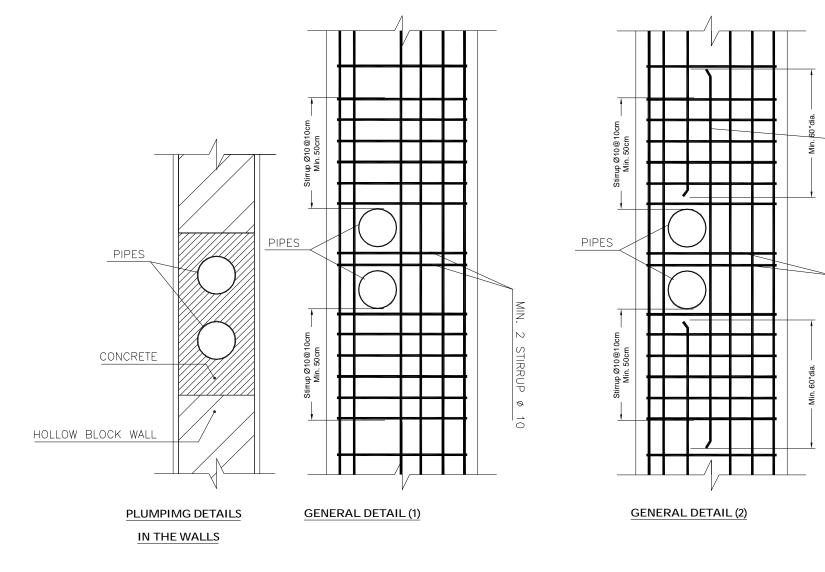

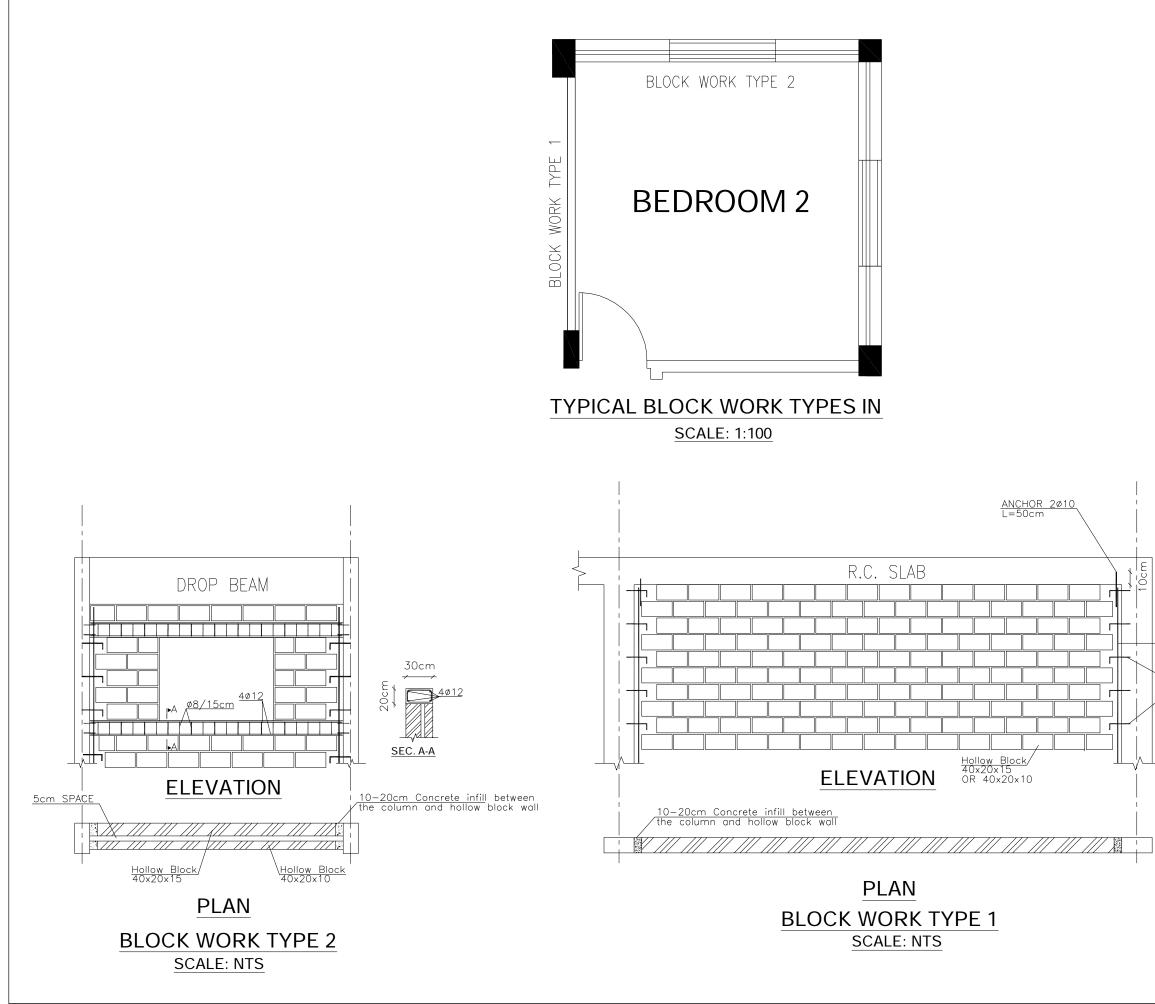


NOTES :-IT IS THE CONTRACTOR RESPONSIBILITY TO PREPARE AND SUBMIT WORKSHOP DRAWINGS FOR ENGINEER BEFORE START WORKS. IF THERE IS ANY DISCREPANCY IN DRAWINGS, THE CONTRACTOR MUST CONSIDER IT IN HIS PRICE, ALL DIMENSIONS ARE IN METERS EXCEPT WHERE OTHERWISE SHOWN. FOR TENDER ONLY 25cm 15 CLIENT: PALESTINIAN NATIONAL AUTHORITY MINISTRY OF PUBLIC WORKS & HOUSING (MPWH) 2ø10 EMPLOYER: THE UNITED NATIONS DEVELOPMENT PROGRAMME PROGRAMME OF ASSISTANCE TO THE ø8@42cm UN PALESTINIAN PEOPLE DP (UNDP/PAPP) **PROJECT TITLE:** CONSTRUCTION OF 100 HOUSING UNITS TO RE-HOUSE THE AFFECTED PALESTINIAN FAMILIES IN GAZA STRIP PROJECT NO.: PAL 10-00070416 (PACKAGE 07) CONSULTANT: ٍ مركزا لهند سة والتخطيط للأ center for engineering and planning BUILDING NAME: RESIDENTIAL BUILDING NO. (A7) DRAWING TITLE: GENERAL DETAILS (7) DRAWING NO.: **RE-GD-007** DATE: APRIL 2011 SCALE:

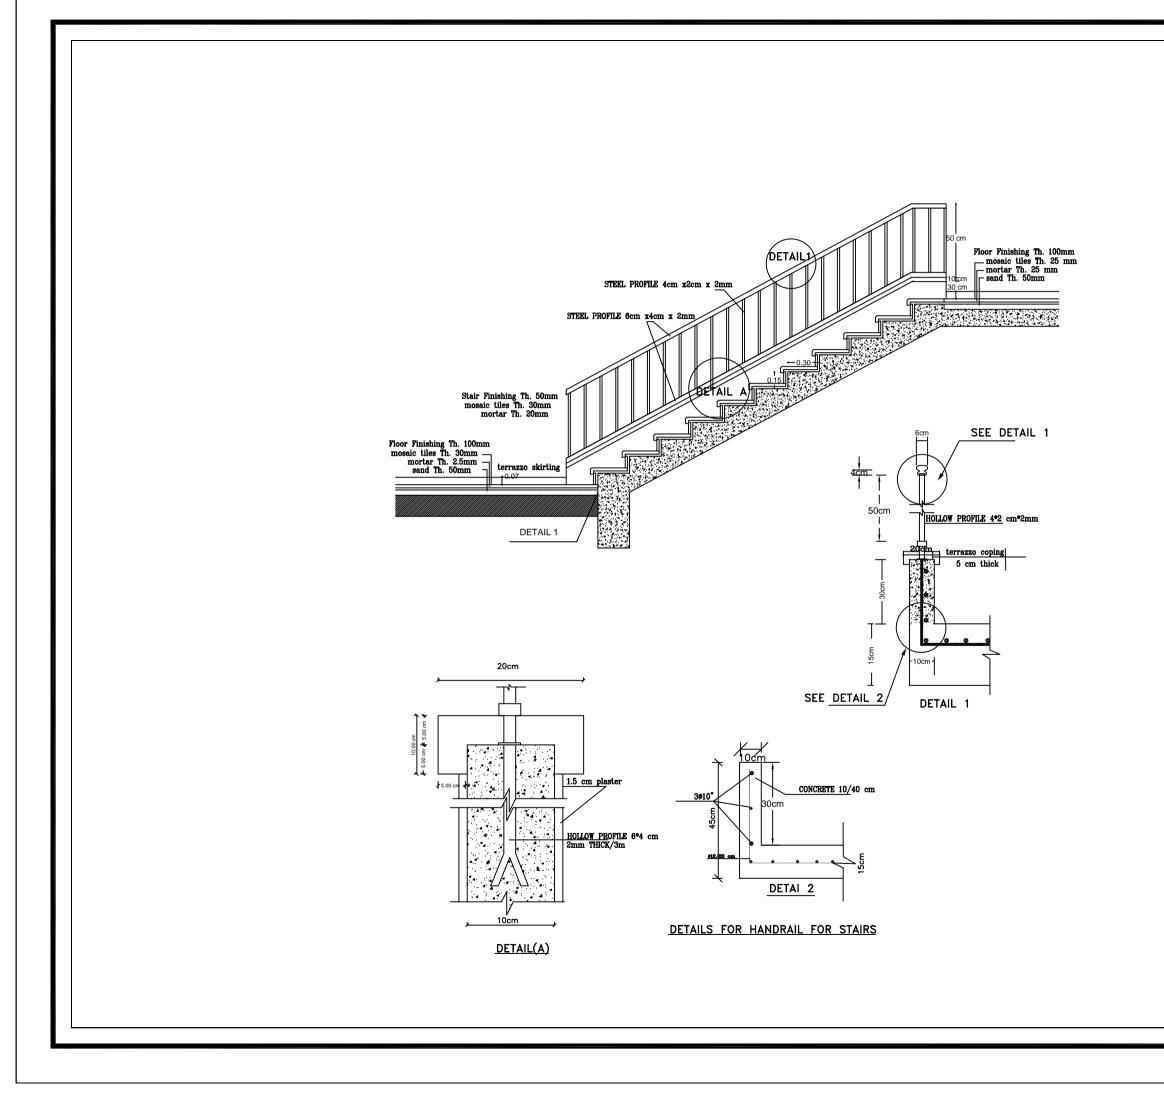

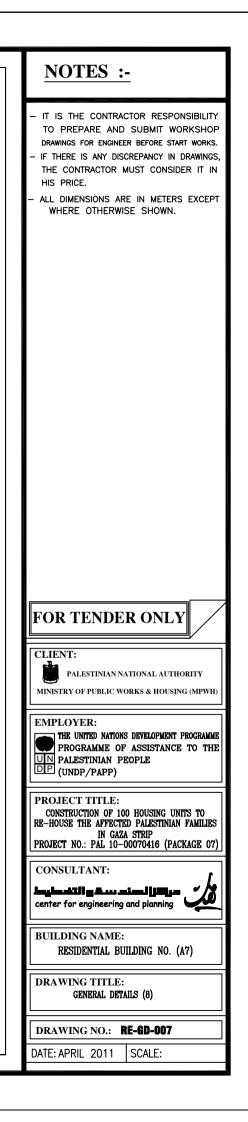



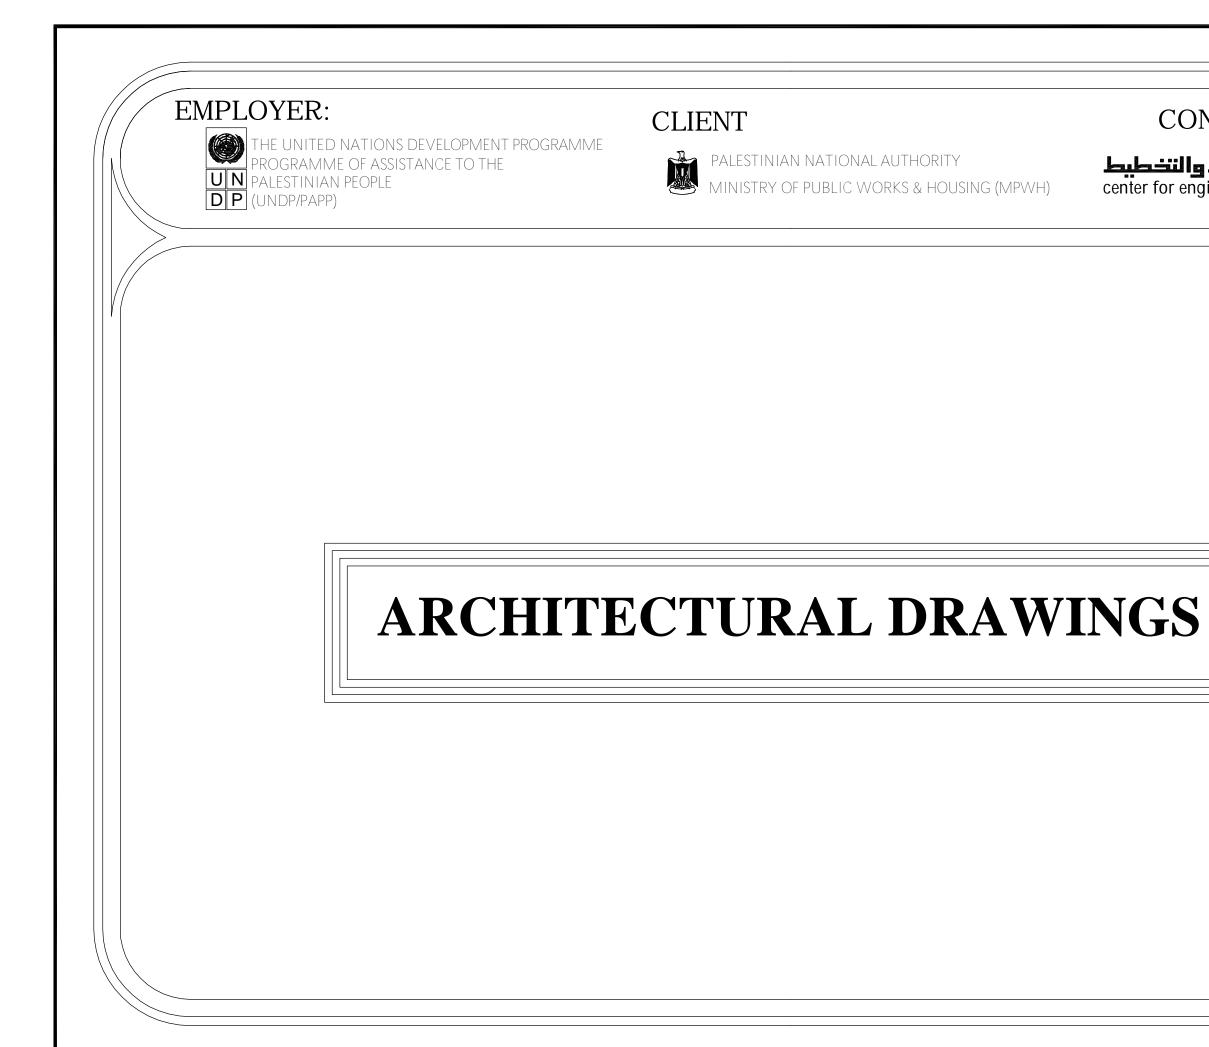



EMPLOYER:




THE UNITED NATIONS DEVELOPMENT PROGRAMME PROGRAMME OF ASSISTANCE TO THE UN PALESTINIAN PEOPLE DP (UNDP/PAPP)

CLIENT




PALESTINIAN NATIONAL AUTHORITY MINISTRY OF PUBLIC WORKS & HOUSI MINISTRY OF PUBLIC WORKS & HOUSING (MPWH)

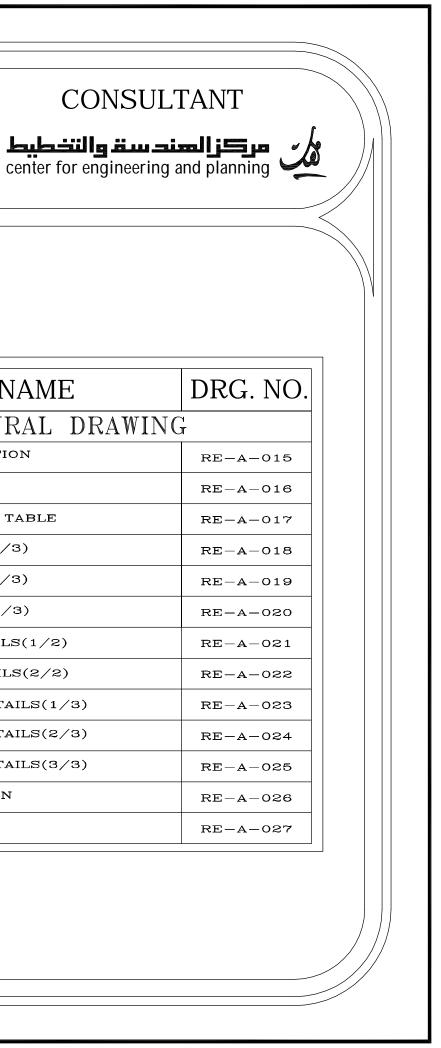


LIST OF DRAWINGS

S/NO.	DRAWING NAME	DRG. NO.	S/	NO.	DRAWING NAME
ARCHITECTURAL DRAWING				ARCHITECTURAL DR.	
01/27	GENERAL LAYOUT, LOCATION AND DESIGN LEVEL OF THE BUILDING	RE-A-001	1	5/27	LONGITUDINAL SECTION
02/27	COORDINATES FOR THE BUILDING	RE-A-002	1	6/27	CROSS SECTIONS
03/27	EXISTING LEVEL FOR THE BUILDING SITE	RE-A-003	1	7/27	WINDOWS & DOORS TABLE
04/27	FURNITURE FOR UNDERGROUND FLOOR	RE-A-004	1	8/27	FINISHES TABLE $(1/3)$
05/27	FURNITURE FOR GROUND FLOOR	RE-A-005	1	9/27	FINISHES TABLE (2/3)
06/27	FURNITURE FOR TYPICAL FLOOR	RE-A-006	2	0/27	FINISHES TABLE (3/3)
07/27	UNDERGROUND FLOOR PLAN	RE-A-007	2	1/27	METAL DOOR DETAILS(1/2)
08/27	GROUND FLOOR PLAN	RE-A-008	2	2/27	METAL DOOR DETAILS(2/2)
09/27	TYPICAL FLOOR PLAN	RE-A-009	2	3/27	WOODEN DOOR DETAILS(1/3)
10/27	ROOF PLAN	RE-A-010	2	4/27	WOODEN DOOR DETAILS(2/3)
11/27	FINAL ROOF PLAN	RE-A-011	2	5/27	WOODEN DOOR DETAILS(3/3)
12/27	FRONT ELEVATION	RE-A-012	2	6/27	WINDOWS ELEVATION
13/27	BACK ELEVATION	RE-A-013	2	7/27	KITCHEN DETAILS
14/27	SIDE ELEVATIONS	RE-A-014			

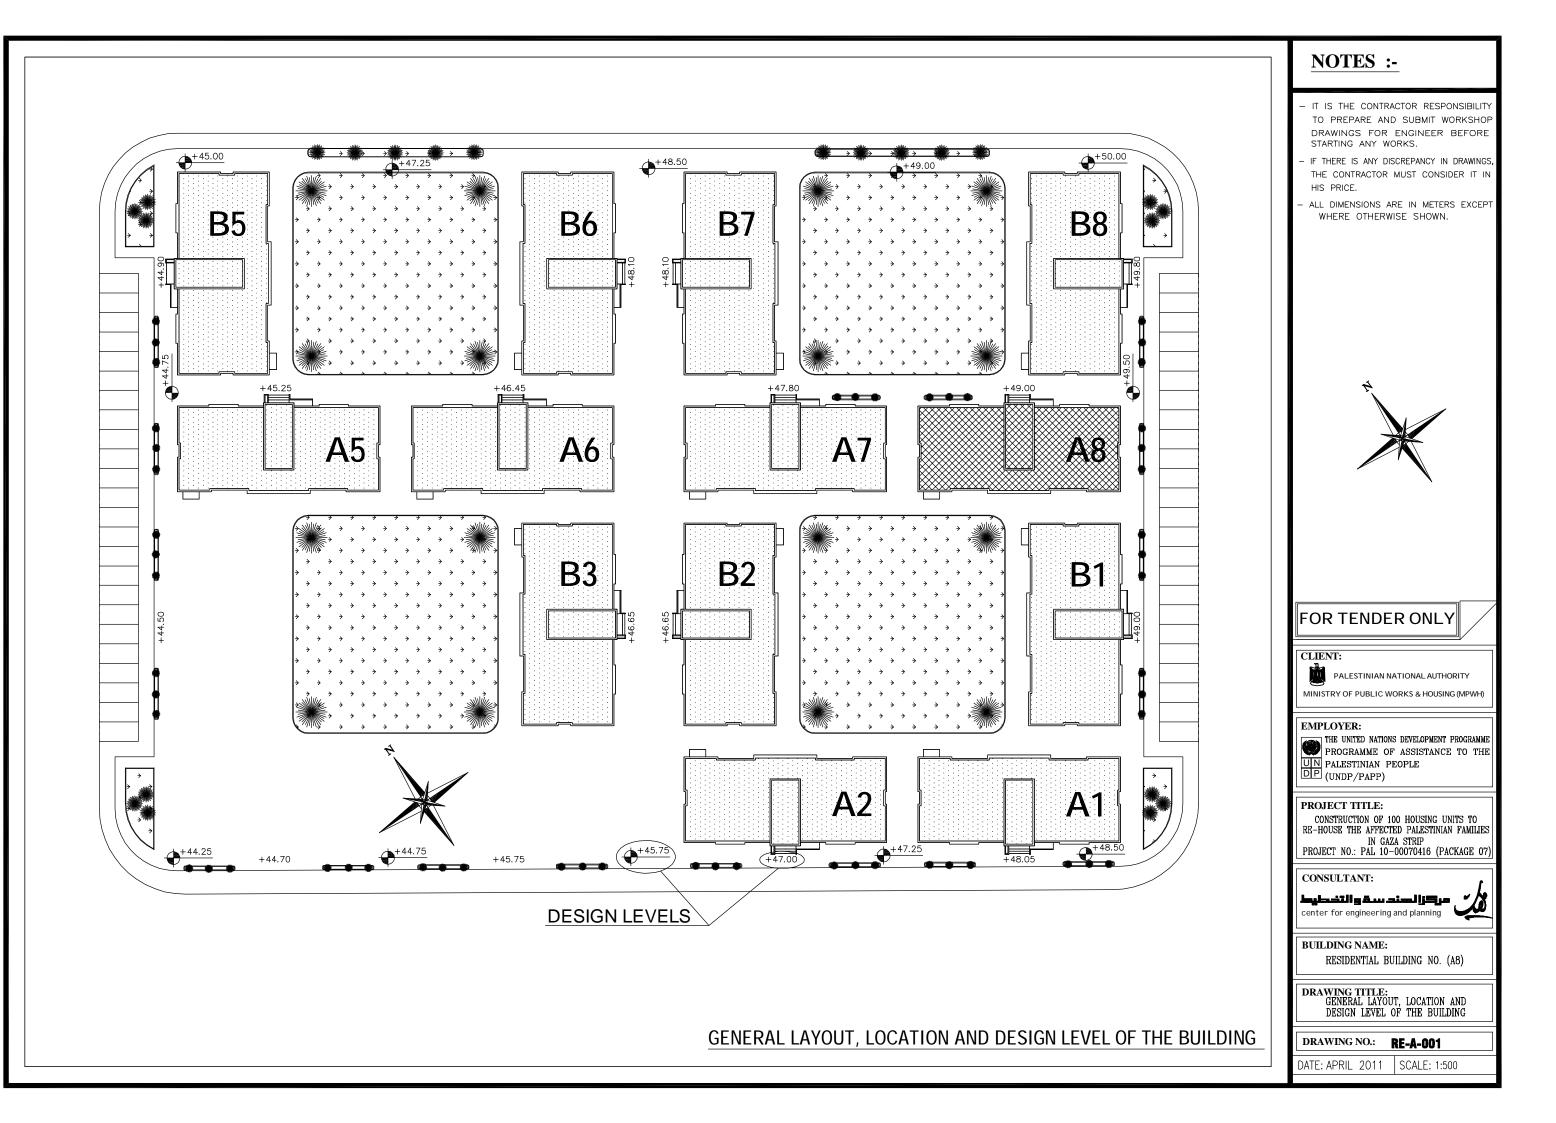


BUILDING NO. A8	BUI	LDING	NO.	A
-----------------	-----	-------	-----	---


Piont	Х	Y
1	100629.2633	107608.9168
2	100632.8394	107306.4402
3	100632.9533	107306.6046
4	100636.6211	107303.9850
5	100636.6211	107303.8212
6	100643.2810	107299.2096
7	100643.3940	107299.3740
8	100647.1757	107296.7550
9	100647.0618	107296.5906
10	100650.6396	107294.1164
11	100653.1715	107297.7724
12	100653.0071	107297.8862
13	100654.3671	107299.6126
14	100634.3671	107299.4988
15	100656.9007	107303.1571
16	100635.5260	107317.9599
17	100632.9924	107314.3016
18	100632.1568	107314.1877
19	100631.9612	107312.4613
20	100631.7968	107312.5751

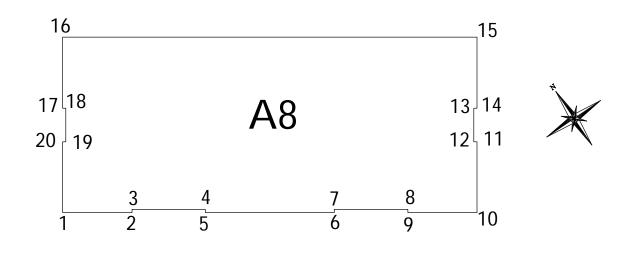



COORDINATES FOR THE BUILDING

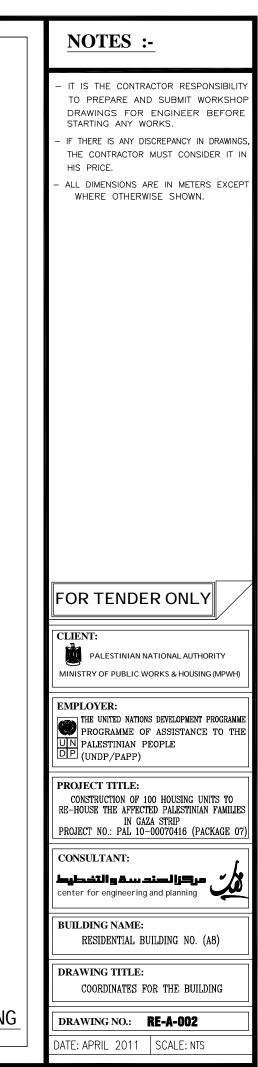




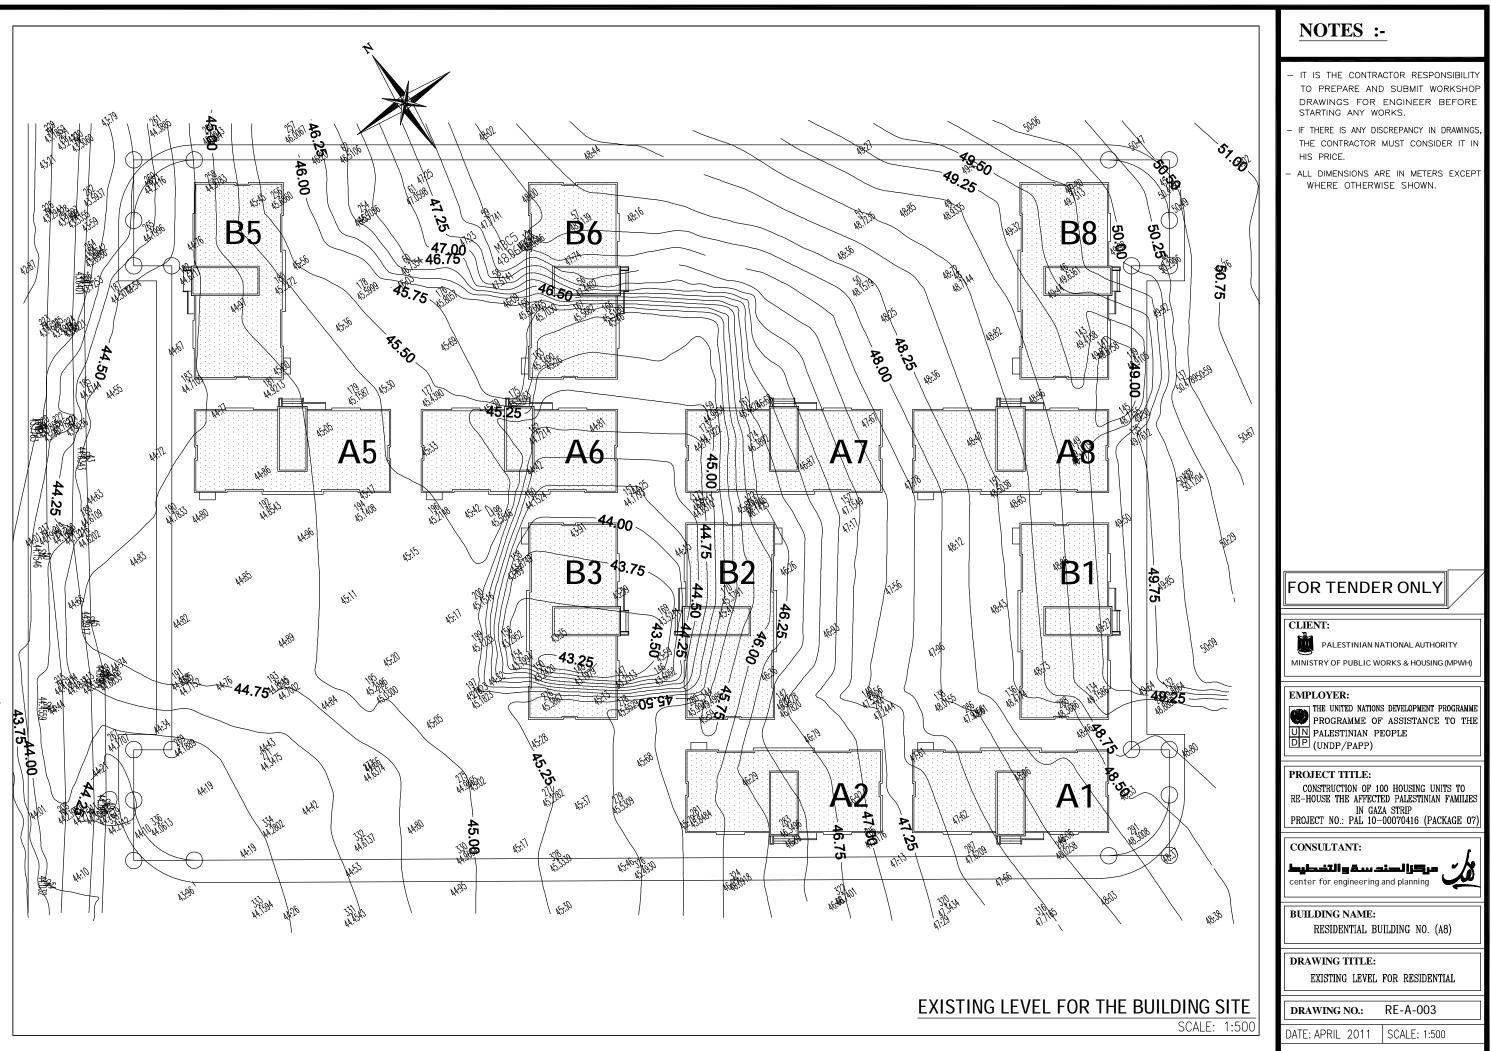

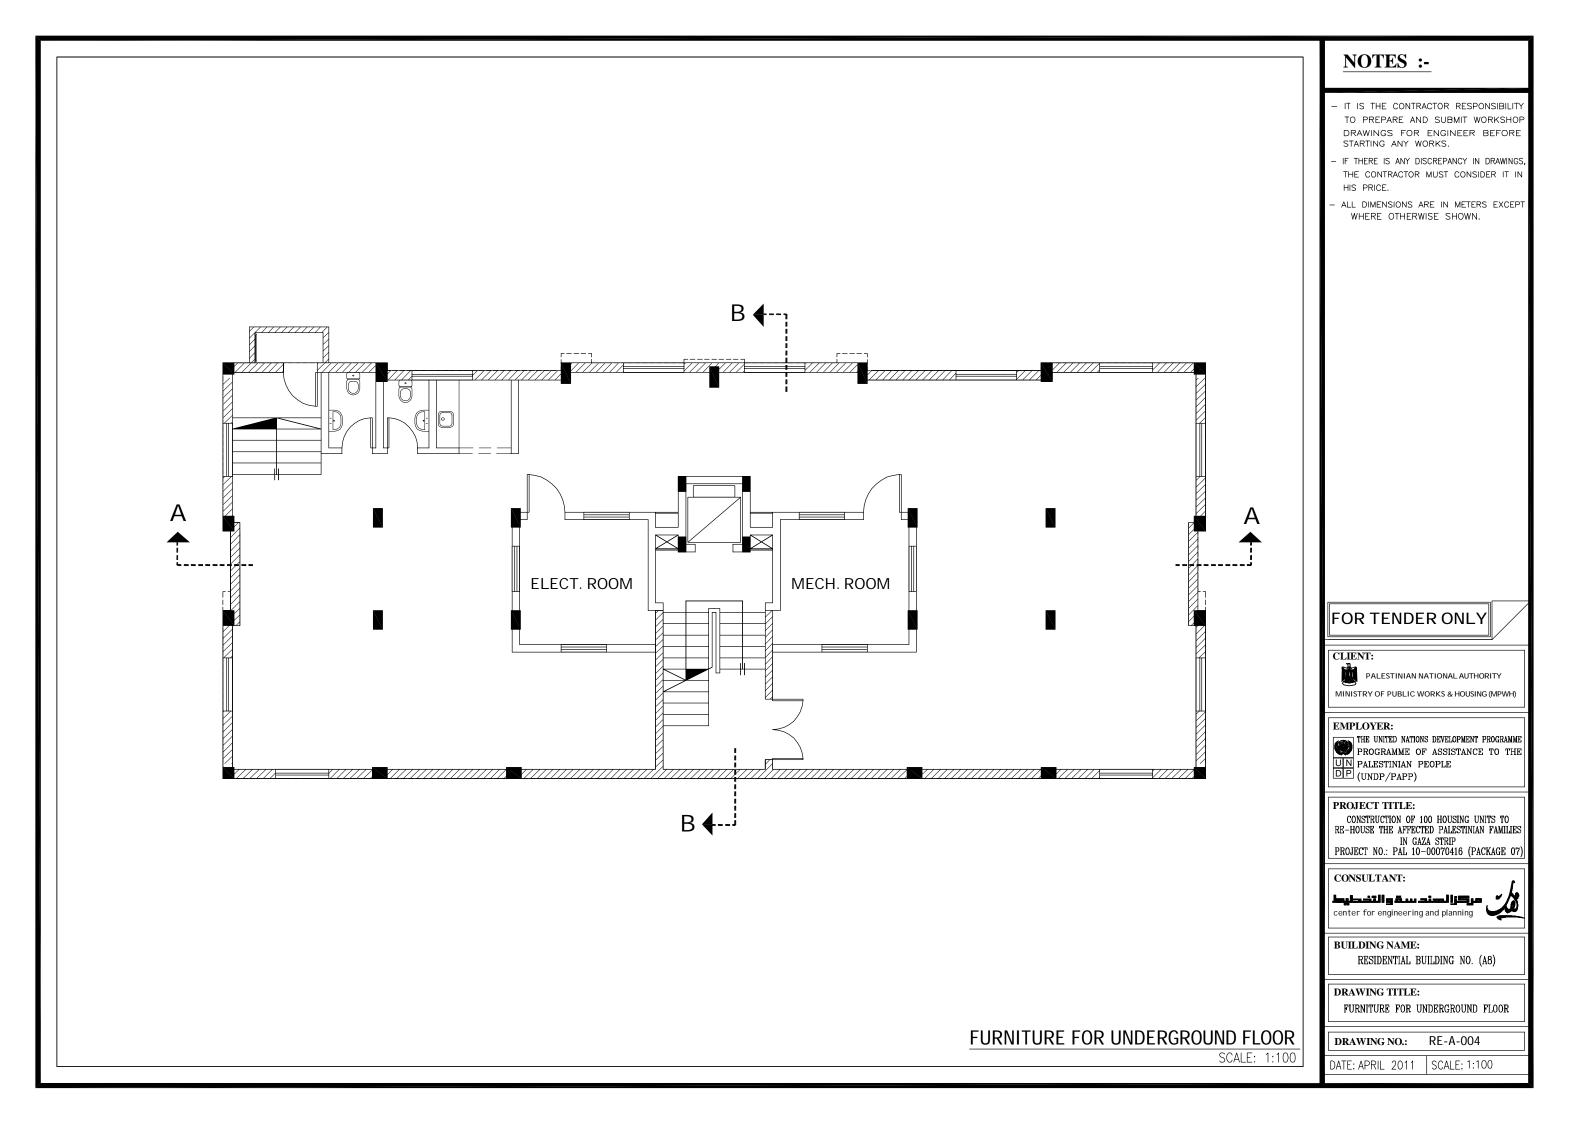


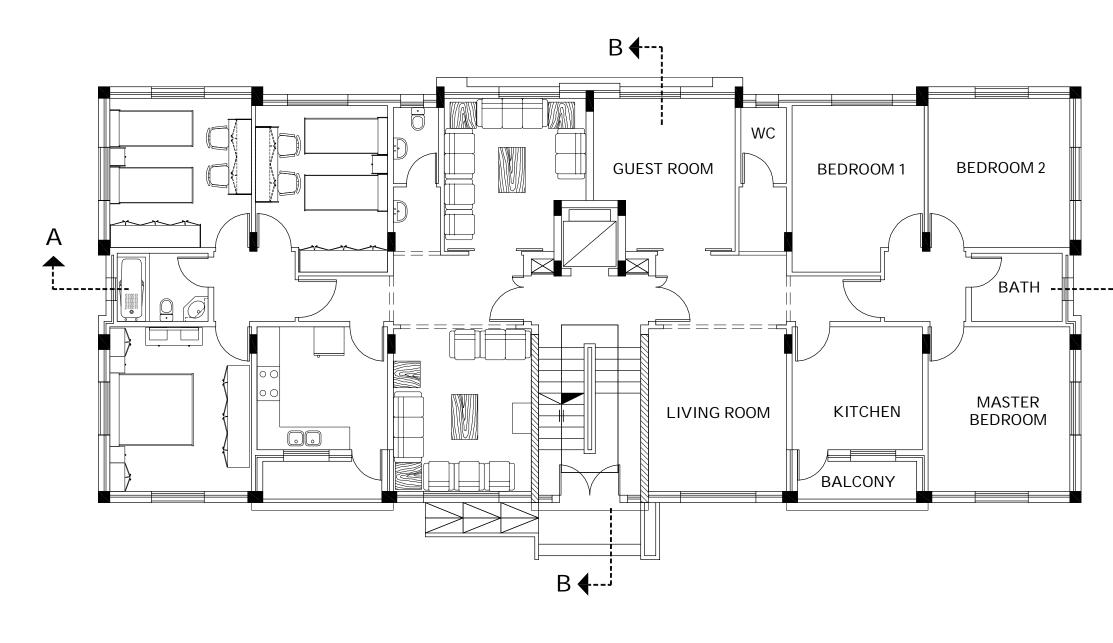

FURNITURE FOR GROUND FLOOR

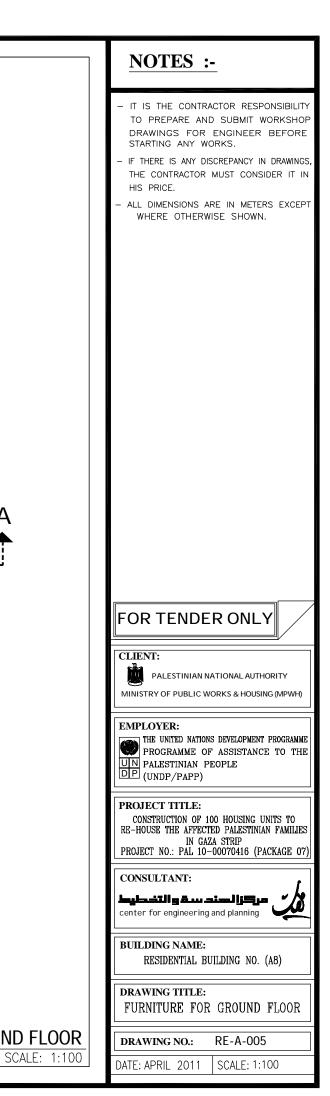


Α

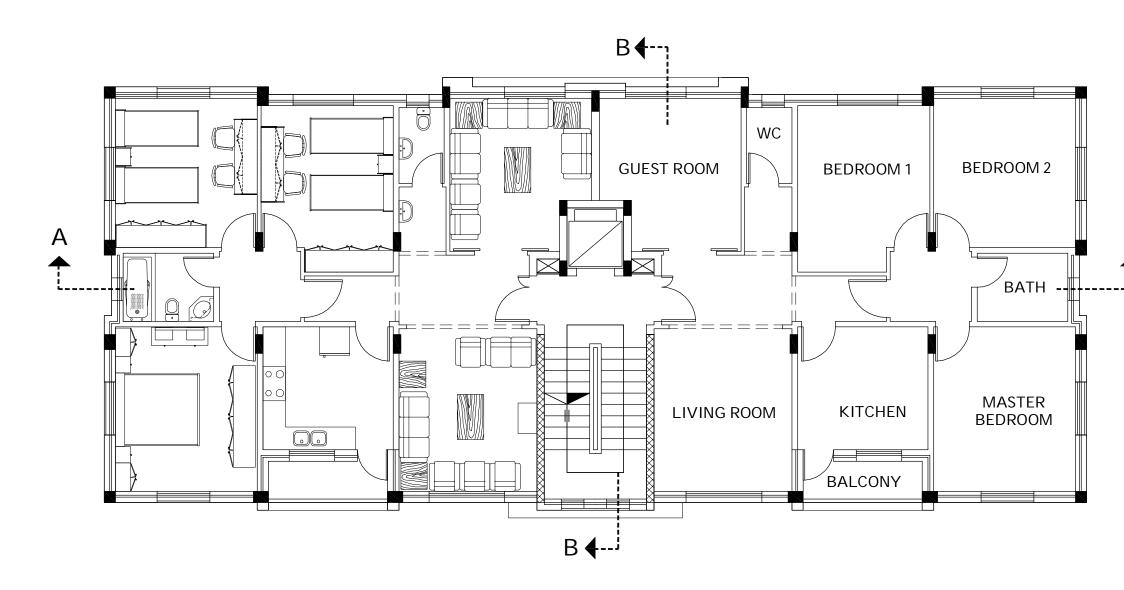



FURNITURE FOR TYPICAL FLOOR




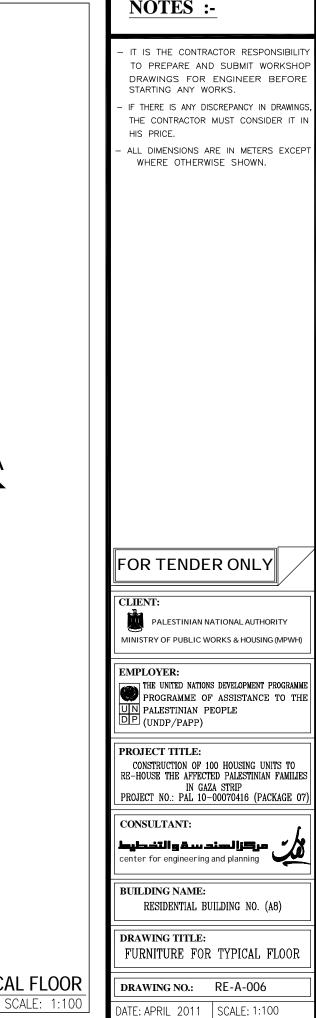



Α

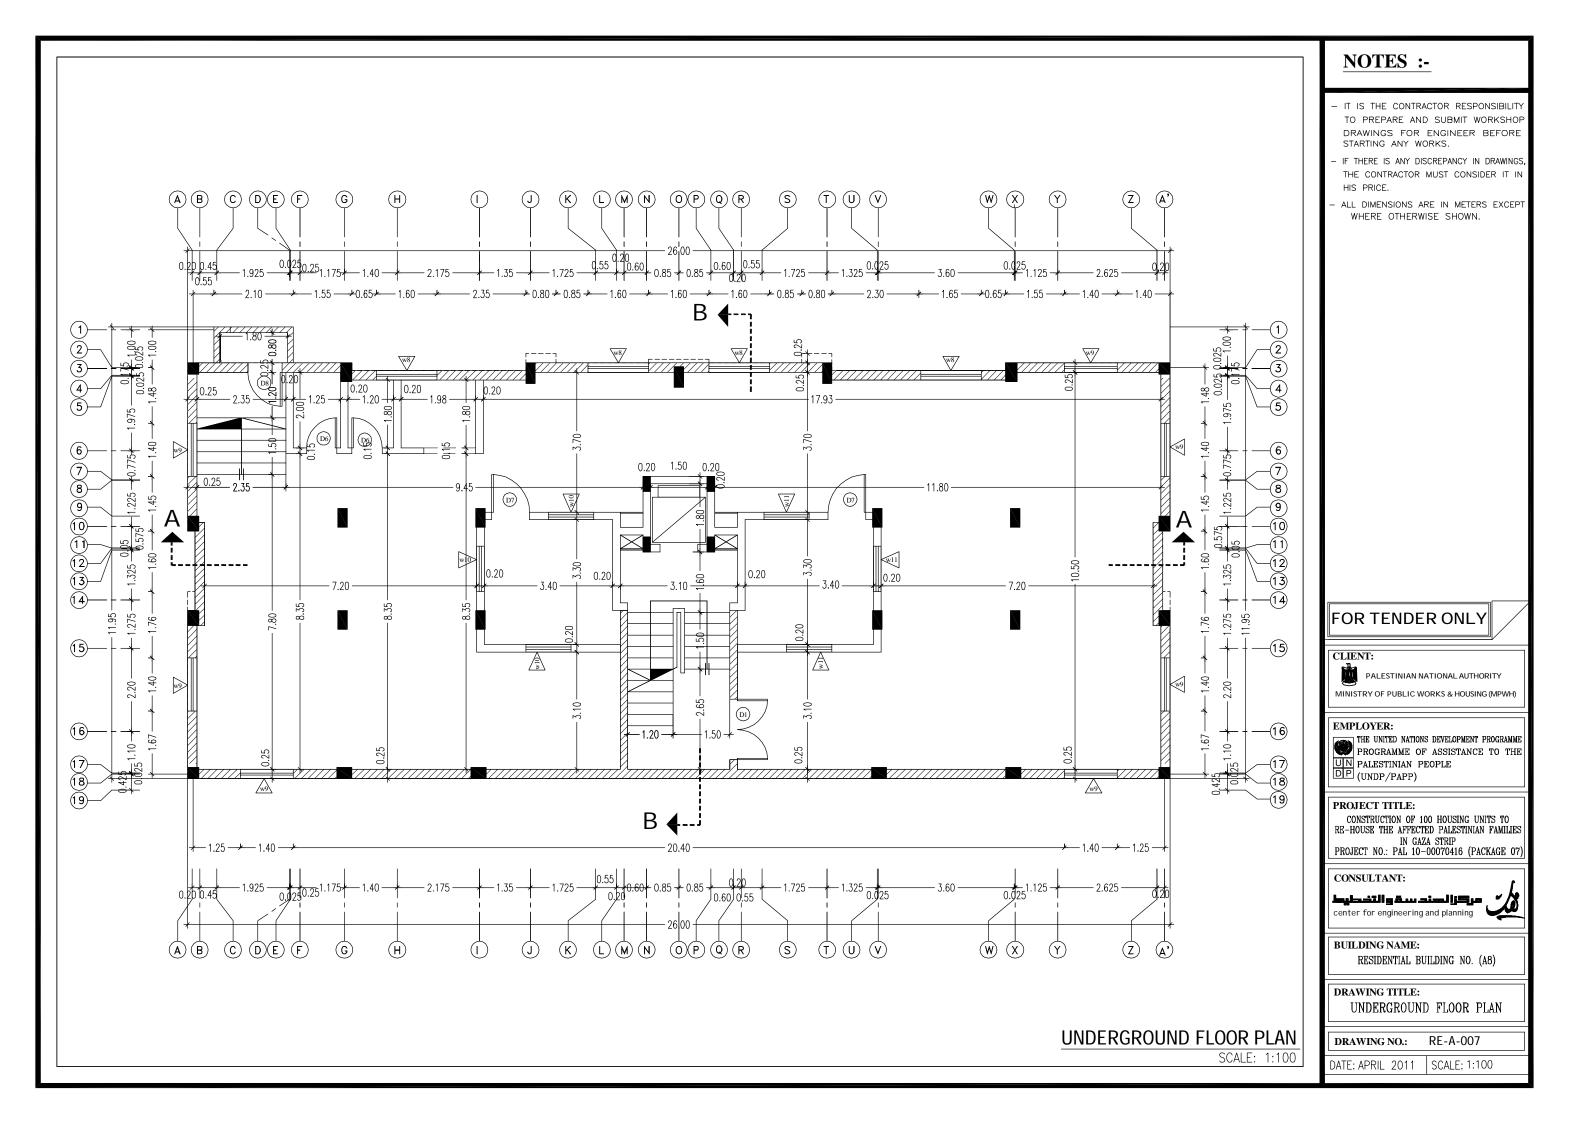

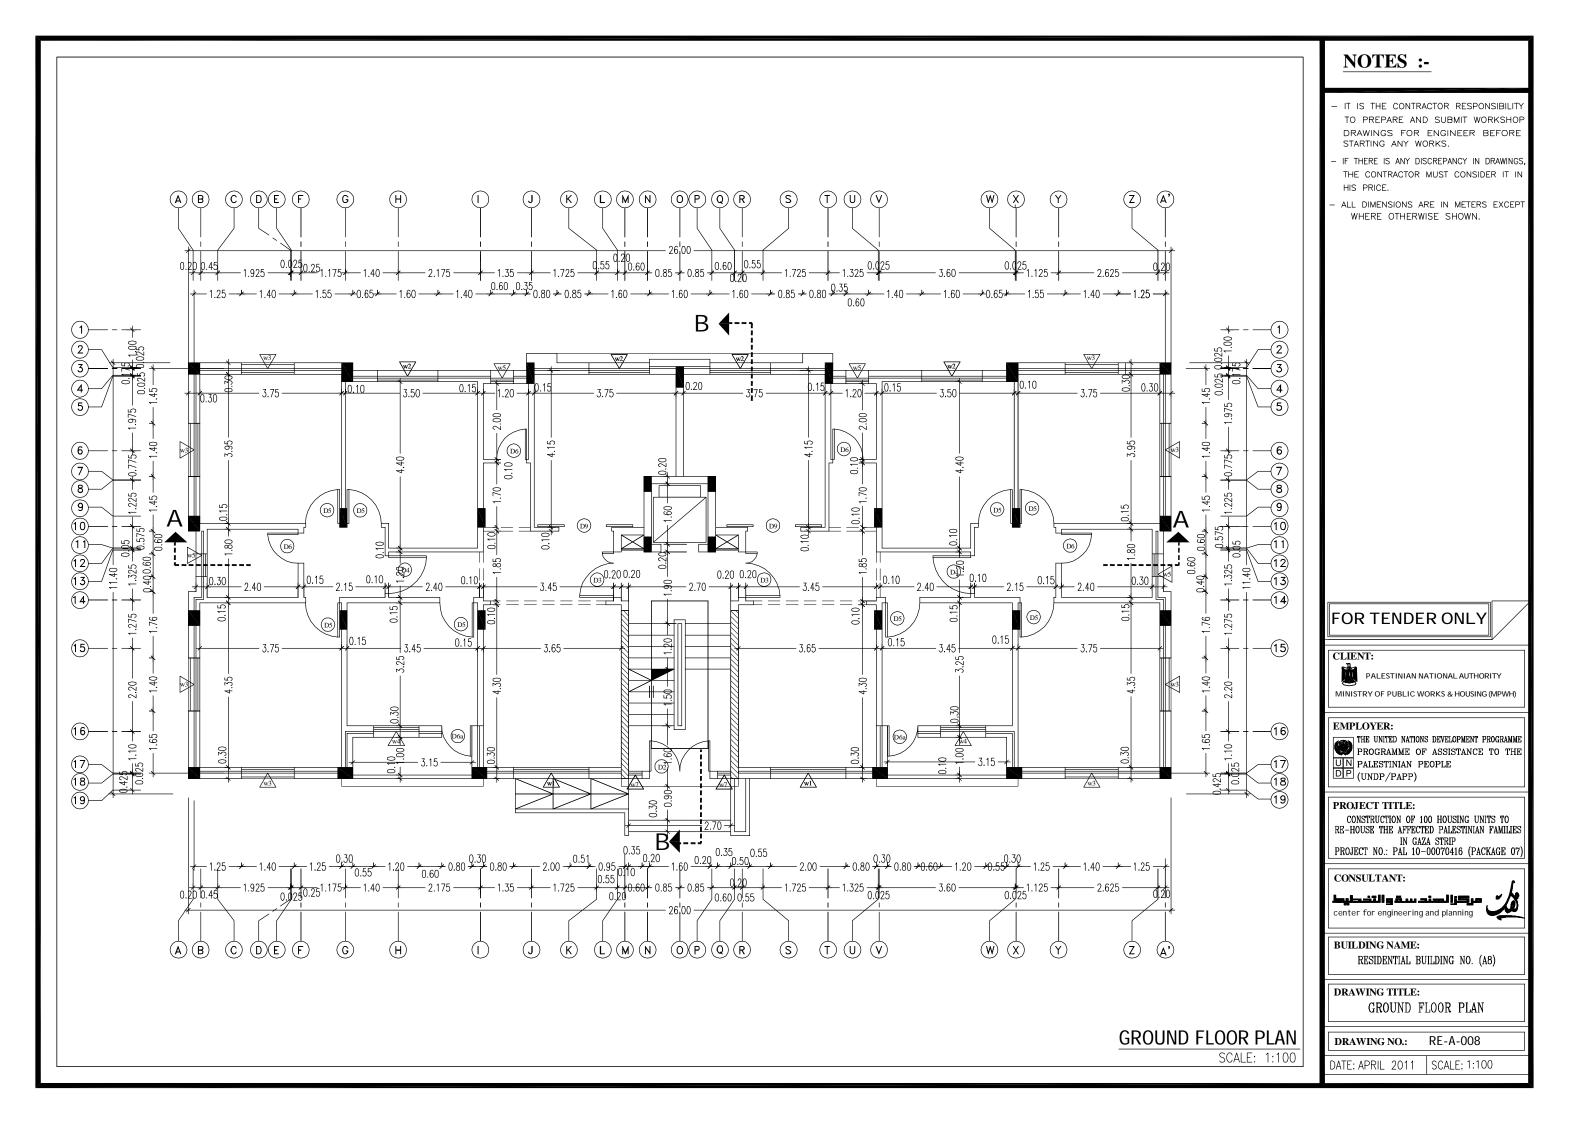


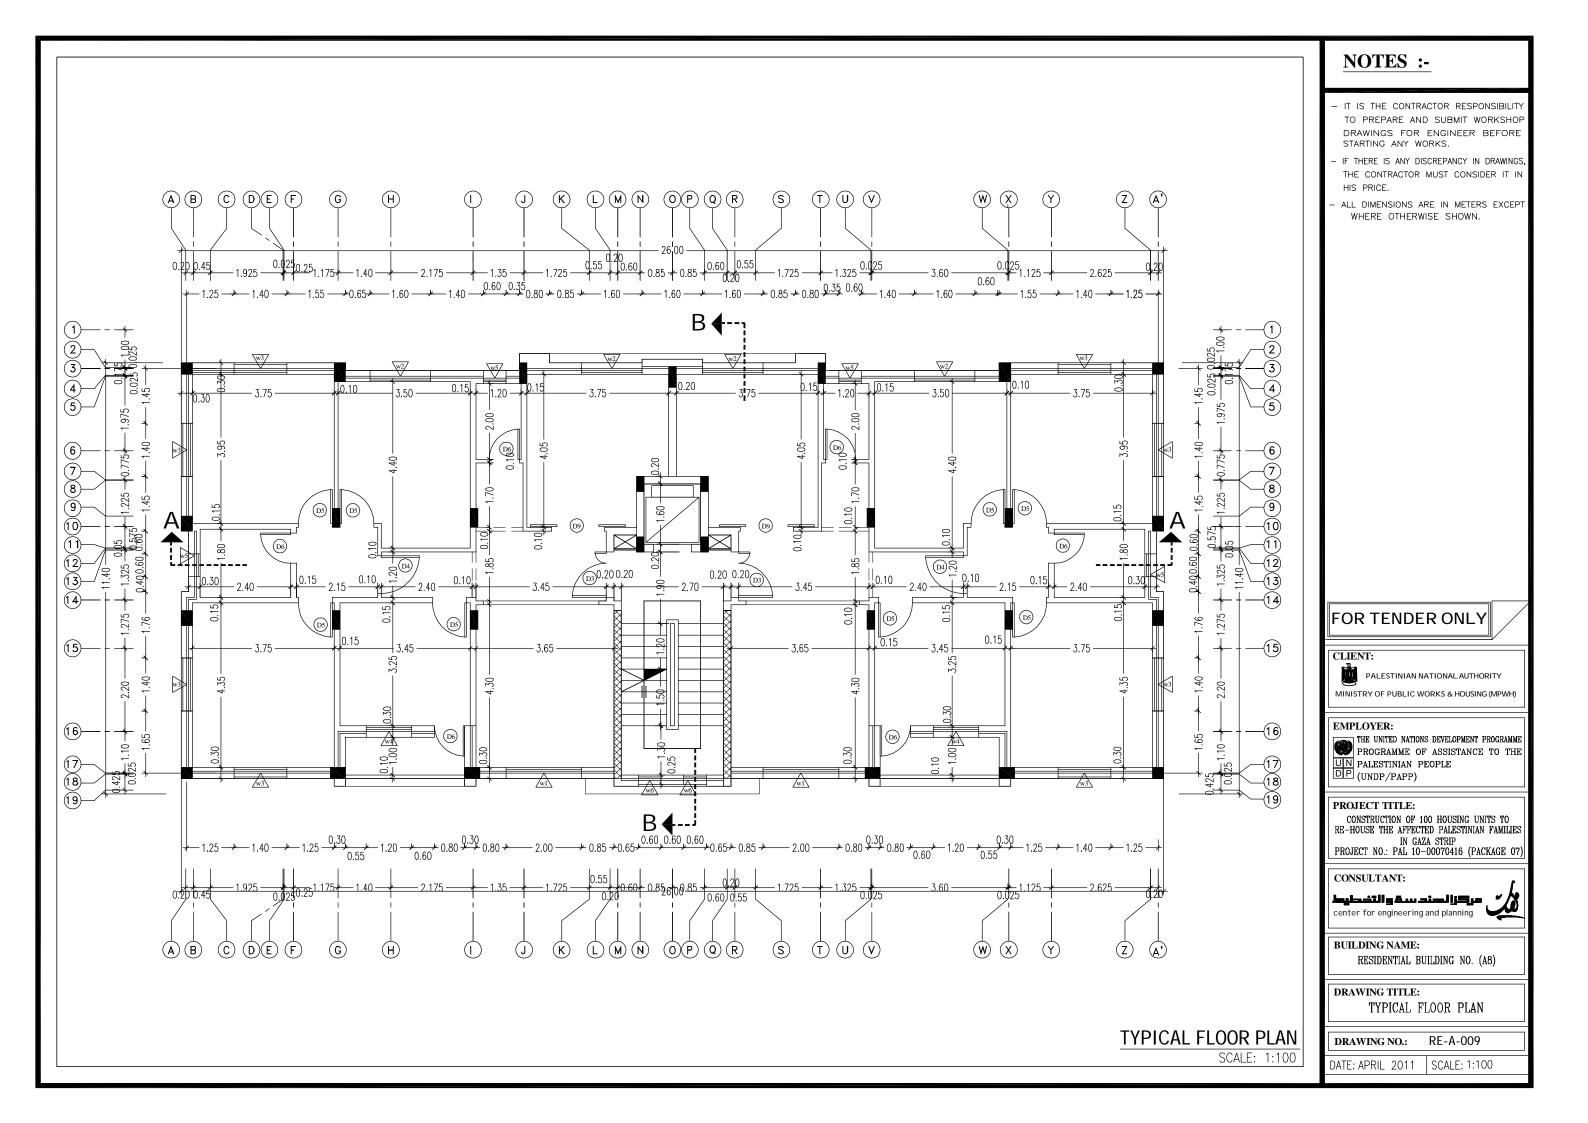


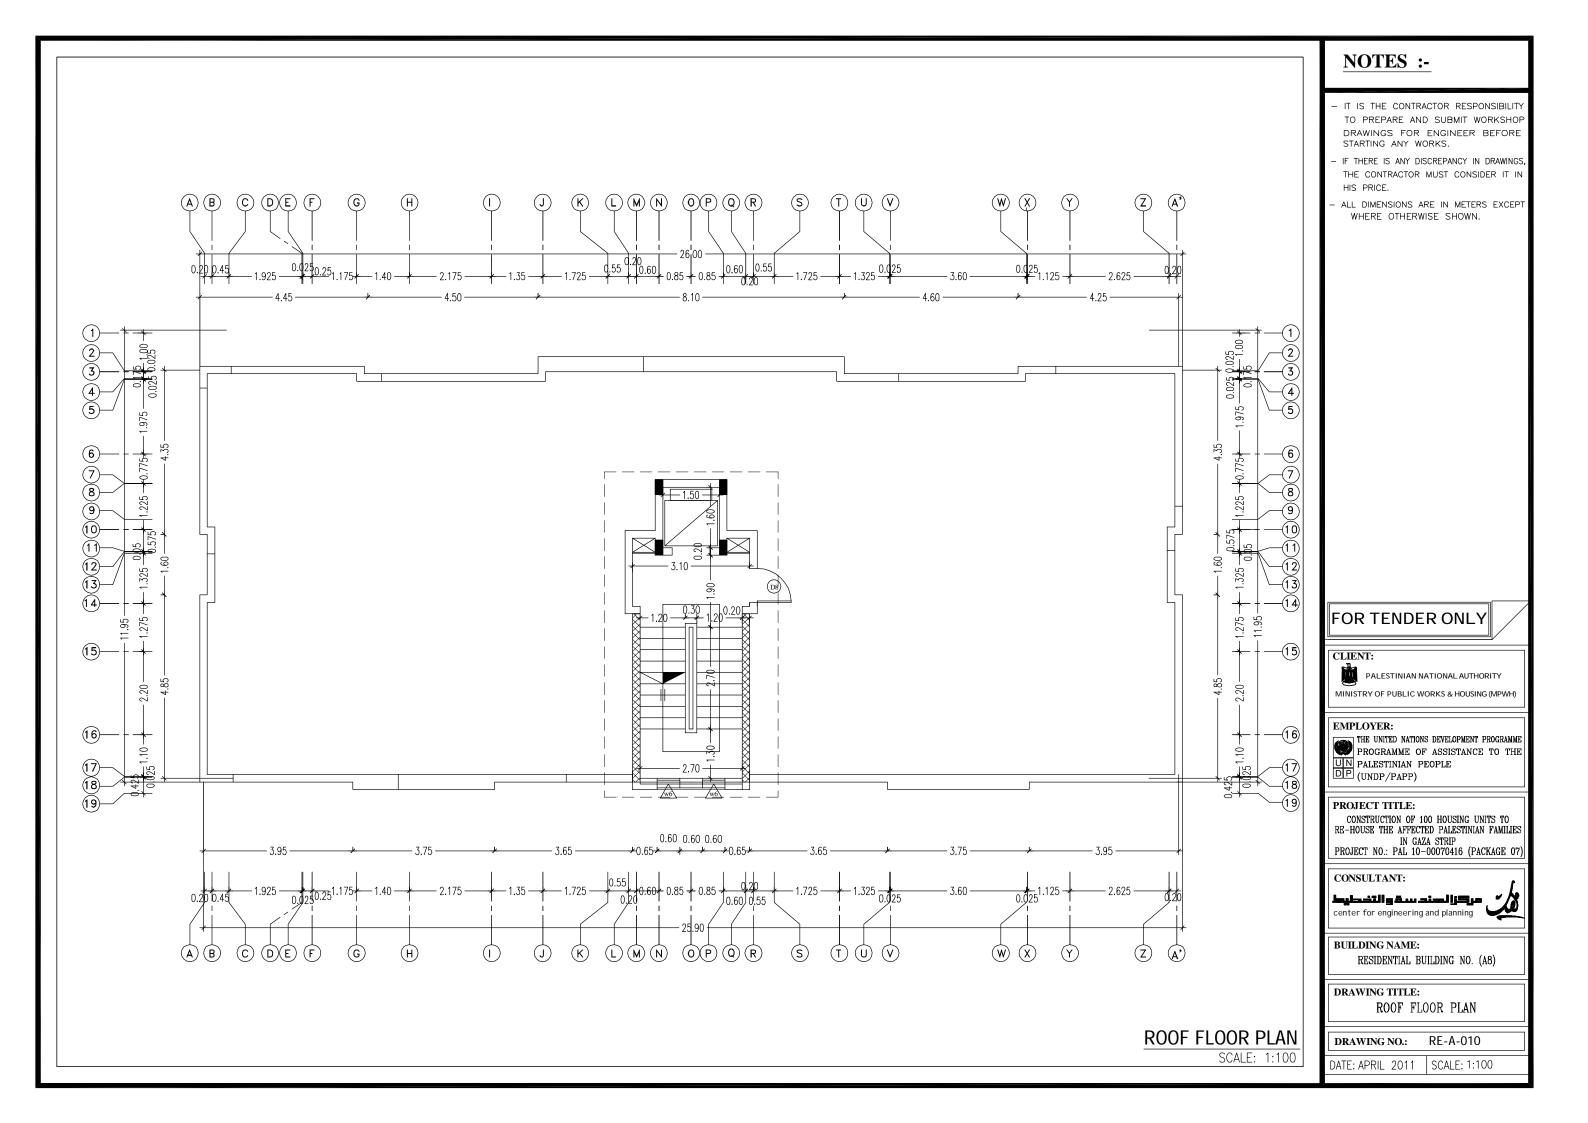


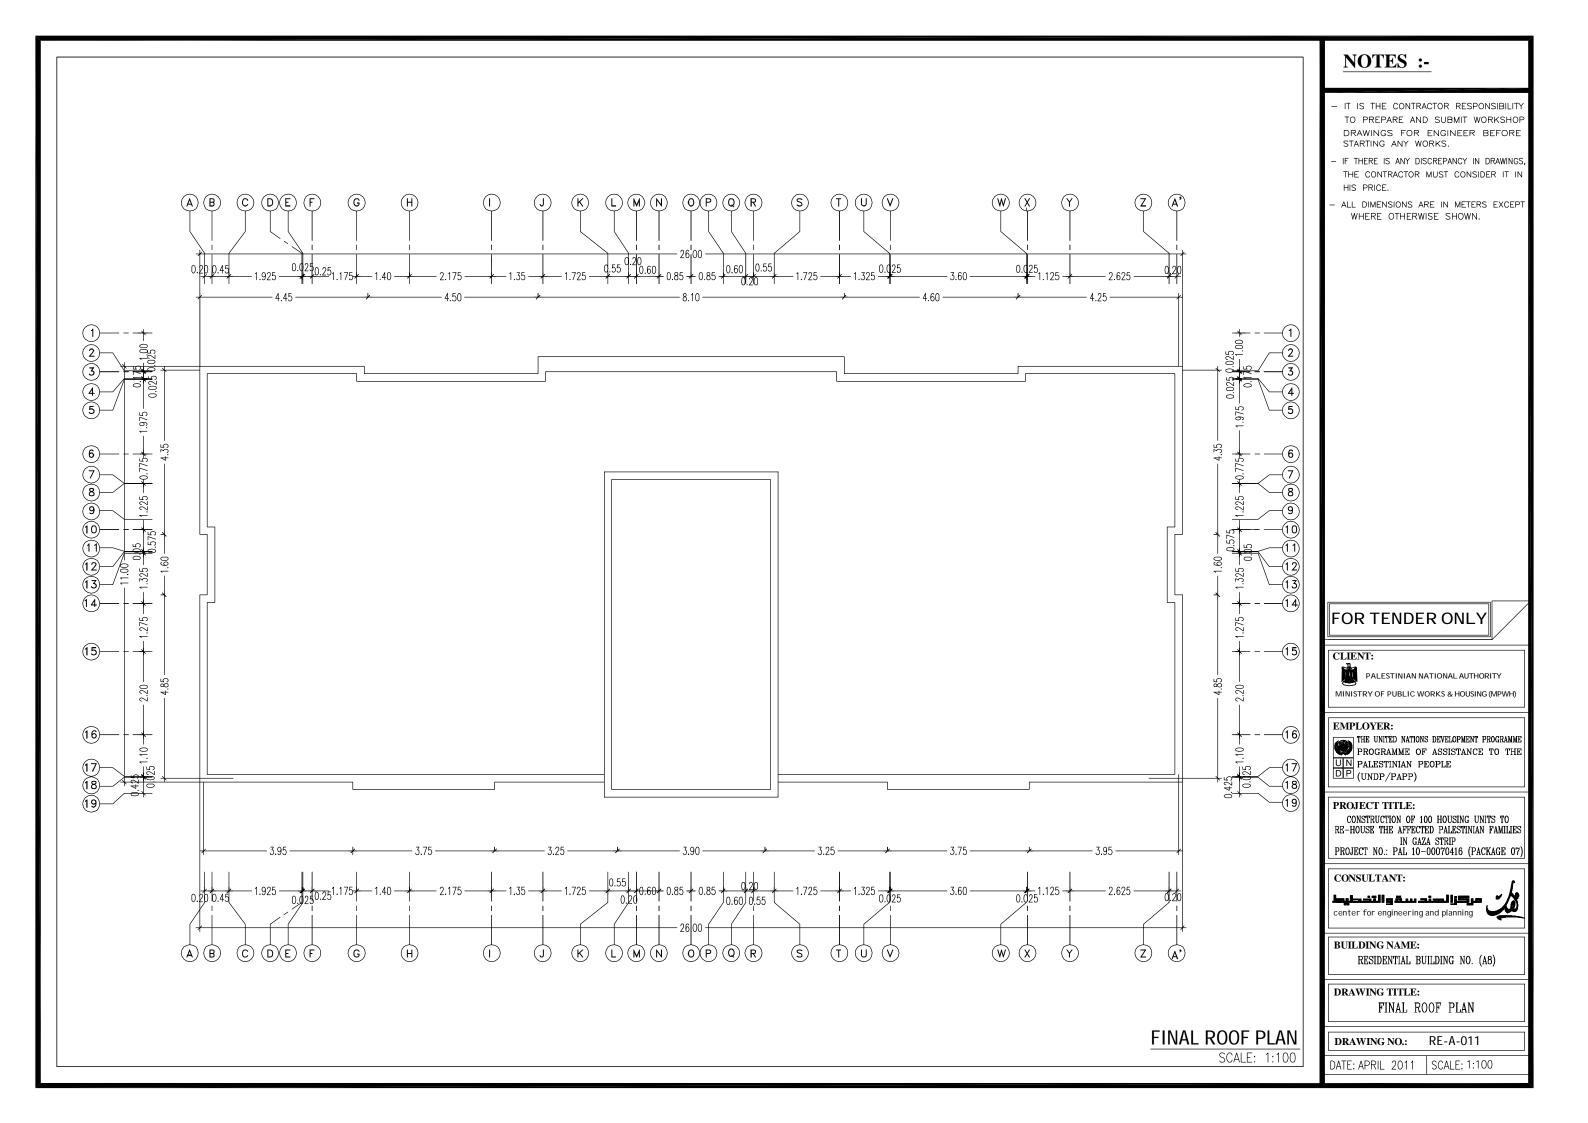



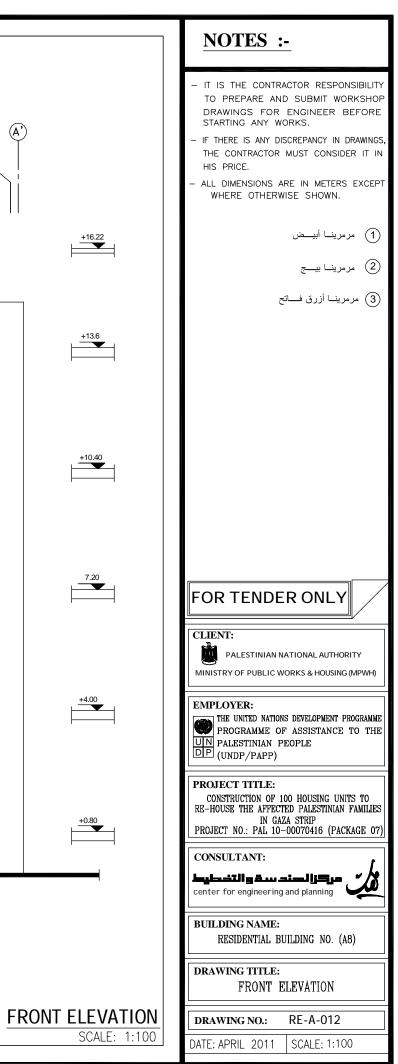


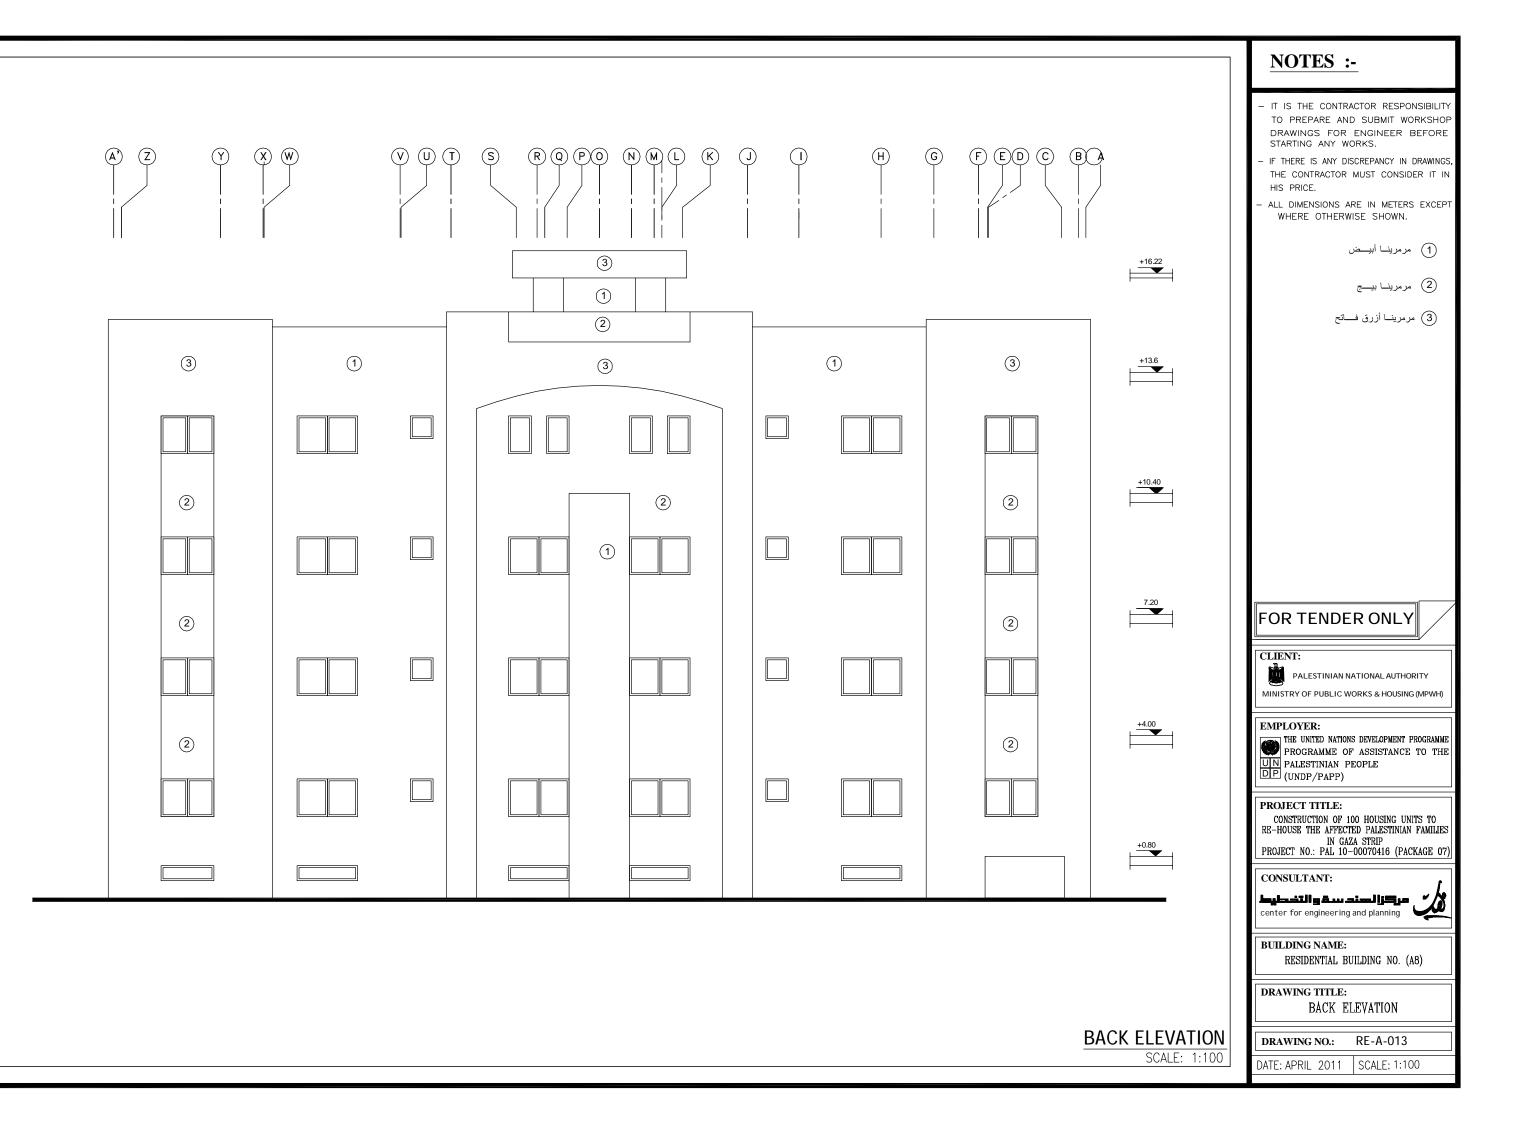


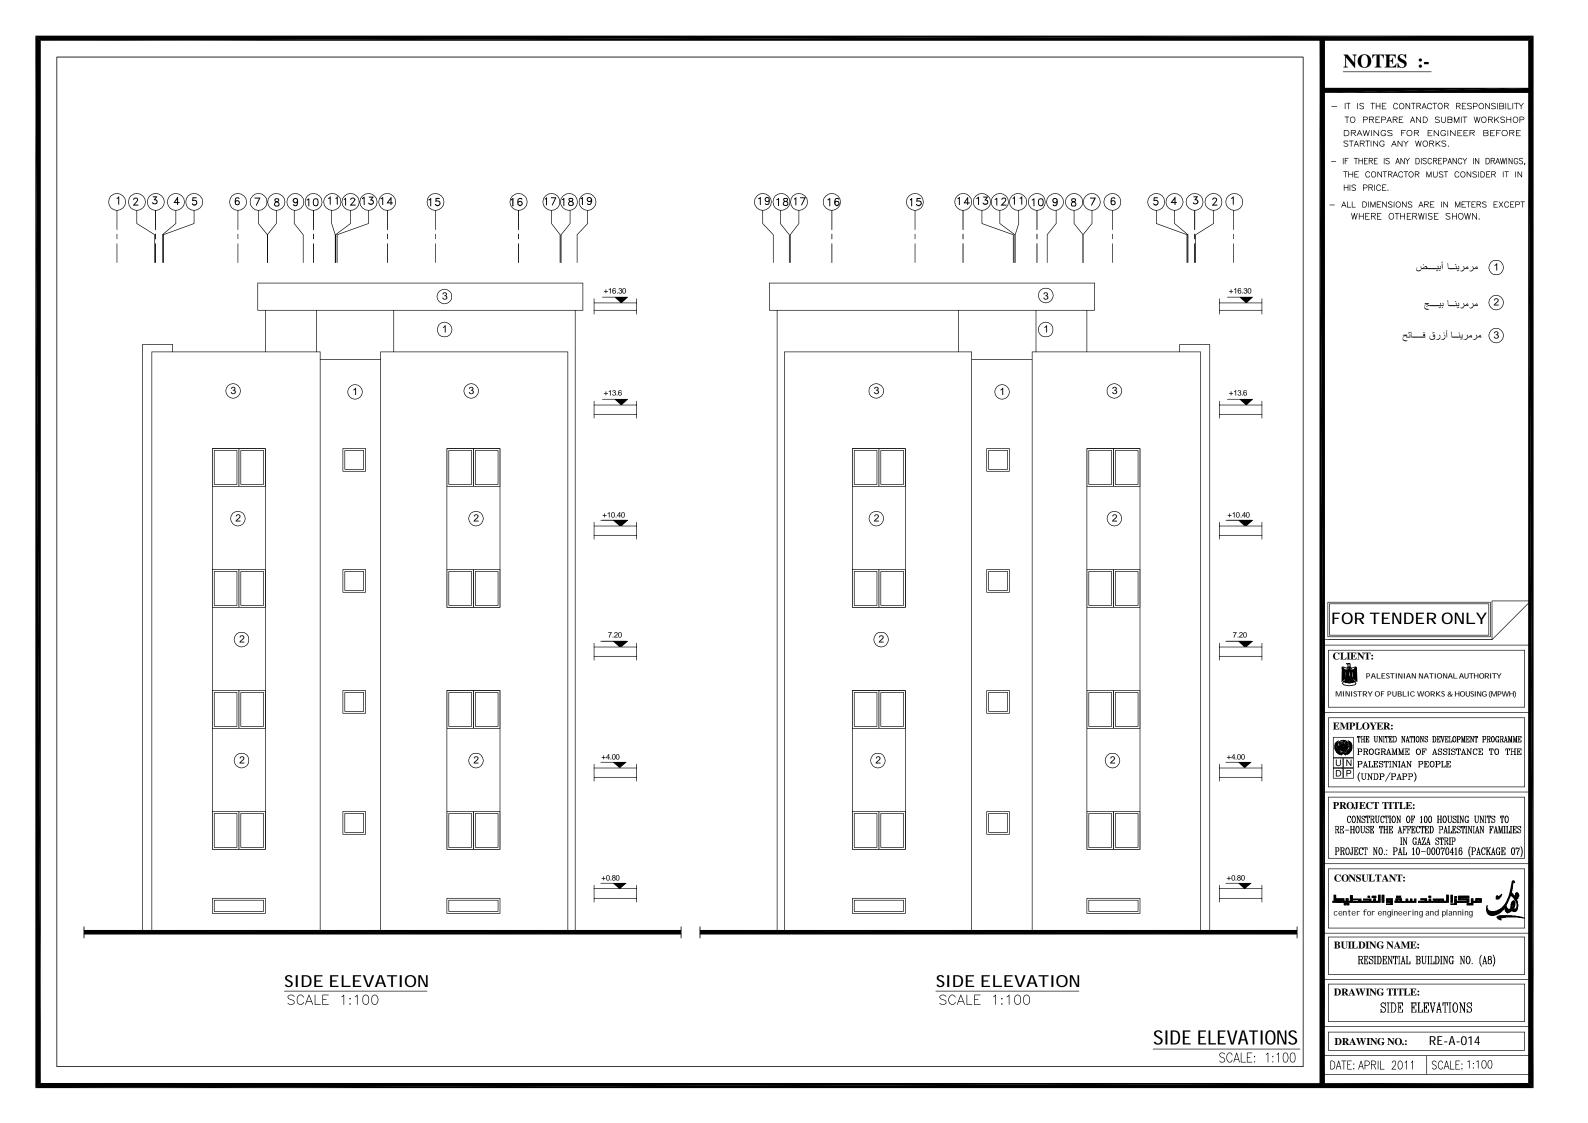




LONGITUDINAL SECTION A-A

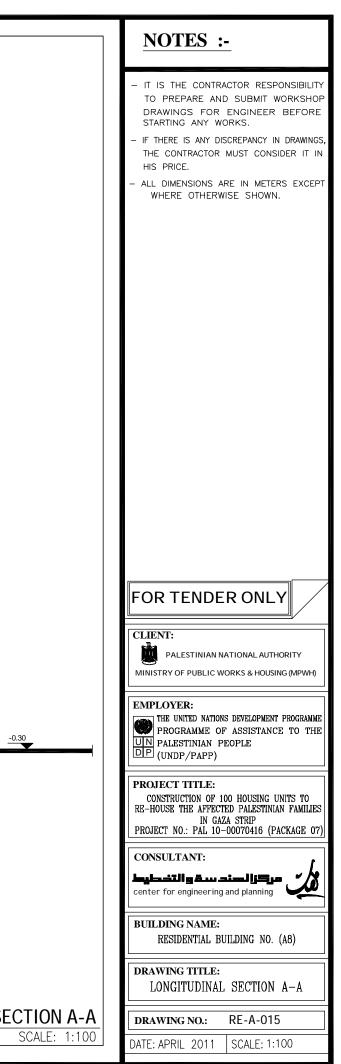

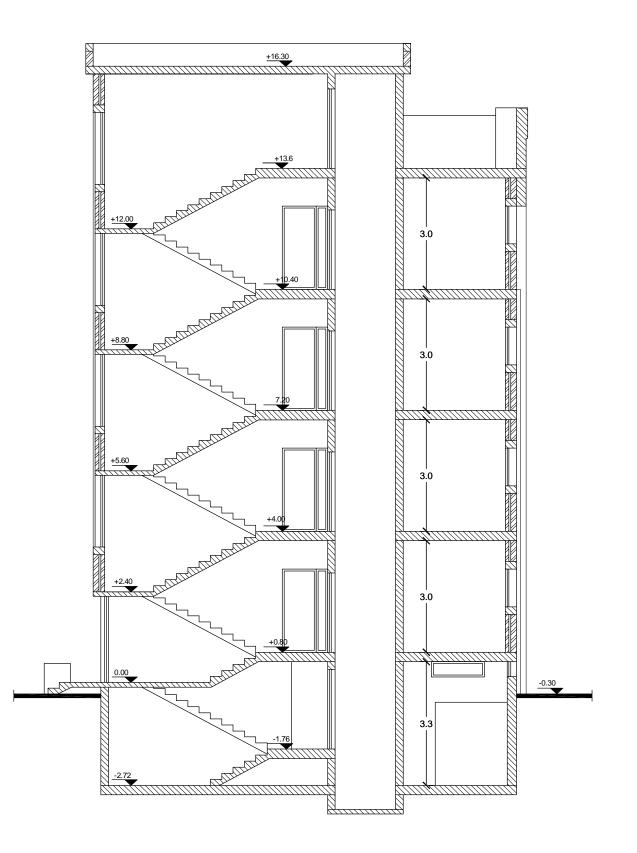

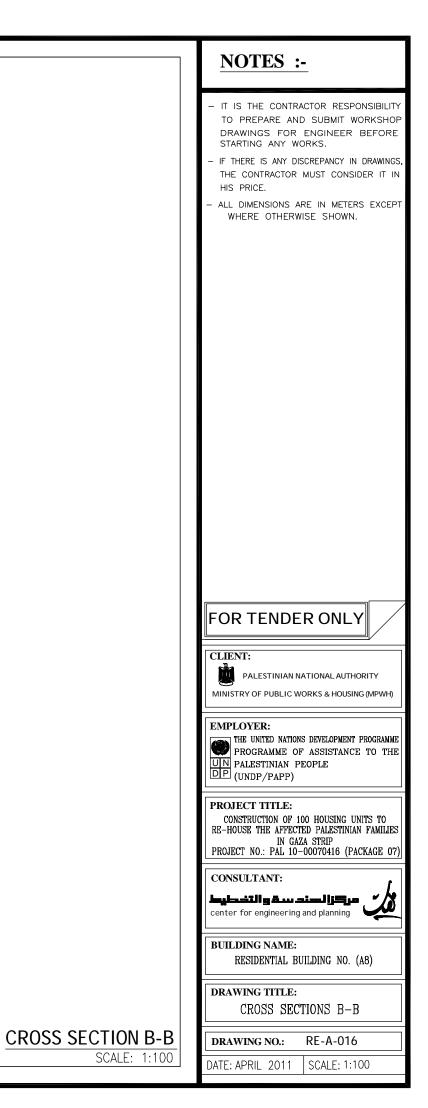

جدول الشبابيك الفتحة الانشاكية نظام الفتح رقم الشباك نظام الفتح المادة الفتحة الانشائية المادة رقم الشباك \$ \$ ġ W1 المئيرم سحاب W9 المنيوم سحا ب هباڪ اليدررم ≁____2.00-00-1-1.00 المنيرم W10 سحا ب W2 سحاب المنيرم **┼**___1.60──↓ ¢ ¢ W11 لوفر حديد W3 سحا ب المنيرم +1.20--1.40-¢ ¢ 1 W4 المنيوم سحا ب +1.20-+ € 0.60+ W5 قلاب المنيوم -1.90 W6 المنيرم قلاب شياڪ الدرجہ +0.60+ -1.42 W7 المنيرم قلاب شياڪ يجوار 0.40 مدغل العمارة -0.40 المنيوم سدا ب W8 -1.60 شياك اليدروم

جدول الابواب


نظام الفتح وعدد الضلف	801-11	الانشافية	الفتحة
لحفام المنع وعدة العيام	حدید عدید عدید خشب خشب خشب مدید مید	الارتفاع	العرض
مفعلي ضلفتين	حديد	230	160
مفصلي ضلفتين	حەيە	230	160
مفصلي ضلفتين	خشب	230	120
مفصلي ضلفة راحدة	خشب	230	100
مفصلي ضلفة واحدة	خشب	230	90
مفصلي ضلفة راحدة	خشب	230	80
مفصلي ضلفة واحدة	ھەيھ	230	80
مفصلي ضلفة راحدة	حديد	230	100
مفصلي ضلفة واحدة	حەيە	230	90
سحاب ضلفتين	خشب	230	140

WINDOWS & DOO

	NOTES :-
	 IT IS THE CONTRACTOR RESPONSIBILITY TO PREPARE AND SUBMIT WORKSHOP DRAWINGS FOR ENGINEER BEFORE STARTING ANY WORKS. IF THERE IS ANY DISCREPANCY IN DRAWINGS, THE CONTRACTOR MUST CONSIDER IT IN HIS PRICE. ALL DIMENSIONS ARE IN METERS EXCEPT WHERE OTHERWISE SHOWN.
رقم الباب	
D1	
D2	
D3	
D4	
D5	
D6	
D6a	
D7	FOR TENDER ONLY
D8	CLIENT: PALESTINIAN NATEONAL ADJEIORITY MUNISTRY OF FUELIC WORKS & HOUBING (APPWE)
D9	EMPLOYER:
	THE UNITED NATIONS DEVELOPMENT PROGRAMME PROGRAMME OF ASSISTANCE TO THE UN PALESTINIAN PEOPLE UNDP/PAPP)
	PROJECT TITLE: CONSTRUCTION OF 100 HOUSING UNITS TO RE-HOUSE THE AFFECTED PALESTINIAN FAMILIES IN GAZA STRIP PROJECT NO.: PAL 10-00070416 (PACKAGE 07)
	CONSULTANT:
	BUILDING NAME: RESIDENTIAL BUILDING NO. (A8)
	DRAWING TITLE: WINDOWS & DOORS TABLE
RS TABL SCALE: 1:10	
JUALE: 1:10	DATE: APRIL 2011 SCALE: 1:100


جدول التشطيبات الطبق التحت أرضي

الادراج	دورات العياه	الغرف الهيكانيكية	الهطبخ	المورعا ت	العيالة	الرقم	نوع التشطيب	البند
		۲			0	1	بلاط کسر رخام	
	۲		•			2	بلاط کرا میکا	€) • •
۲						3	رځام أو جرانيت	
۲		٩		•	٥	1	قصارة ودهان سوبركريل	Hangel I
	۲		0			2	بلاط کرامیکا حتی السقف	
					٩	1	قصارة ودهان بوليسيد	in the state
					0	1	ڪسر رځام	
•						2	رځام أو جرانيت	J. J

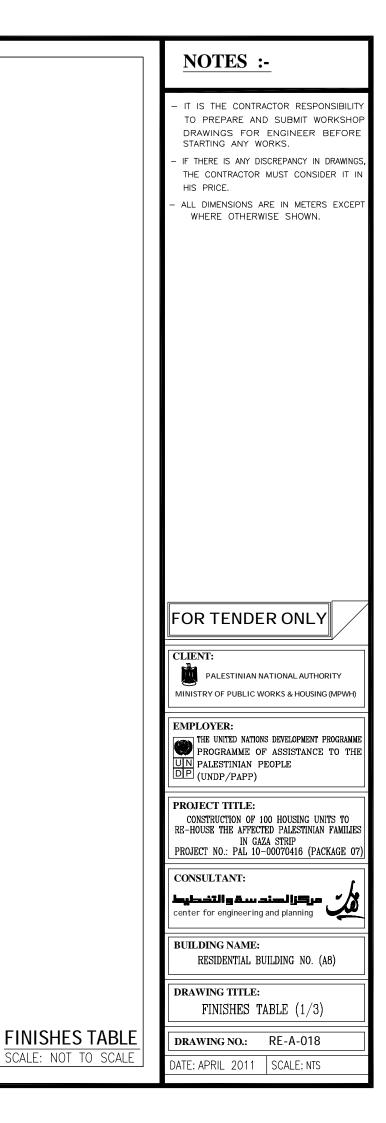


جدول التشطيبات الطابق الارضي


البلاكين	الادراج	دورات العياه	الحما ما ت	غرف النوم	الموزعات	المطابخ	صالات المدخل	غرف المعيشة	غرف الفيوف	الرقم	نوع التشطيب	البنه
۲				٢	٢		۲	٥	٢	1	بلاط کسر رخام	J. J
		۲	۲			۲				2	بلاط کرا میکا	<i>?</i>
	•									3	رخام أو جرانيت	
•	•			•	٩		•	•	٩	1	قصارة ودهان سوبرڪريا	A JAN
			۲			٢				2	بلاط كراميكا حتى السقف	
۲	۲	۲	۲	۲	٢	۲	۲	٢	٢	1	قصارة ودهان بوليسيد	in the second second
۲	•			•	٢		•	•	٩	1	ڪسر رځام	
	٩									2	رخام أو جرانيت	J. J.
											مرمرينا	الحوائط الخارجية

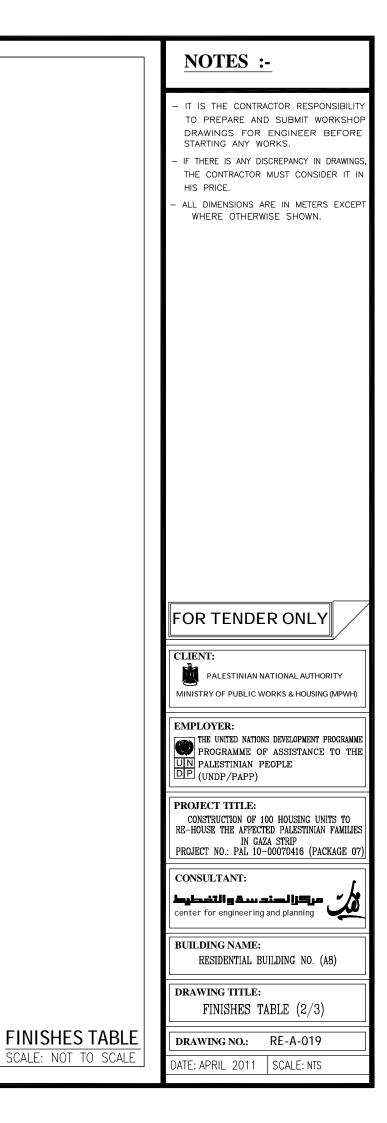



جدول التشطيبات
الطابق المتكرر

البلاكين	الادراج	دورات الصياه	الدمامات	غرف النوم	ا لمورْعا ت	المطابخ	ميالات المدخل	غرف الصعيشة	غرف الفيوف	الرقح	نوع التشطيب	البند
۲				٢	•		٠	۲	٩	1	بلاط کسر رخام	A Contraction of the second se
		۲	۲			۲				2	بلاط کرا میکا	€
	۲									3	رځام أو جرانيت	
۲	۲			•	٢		•	•	۲	1	قصارة ودهان سوبرڪريل	
		۲	•			٢				2	بلاط كراميكا حتى السقف	A Part
٩	۲	۲	0	۲	٠	٠	•	•	•	1	قصارة ودهان بوليسيد	. of the second
۲	•			٩	٩		۲	۲	۲	1	کسر رځام	
	۲									2	رځام أو جرانيت	y.
											مرمرينا	الحوائط الخارجية

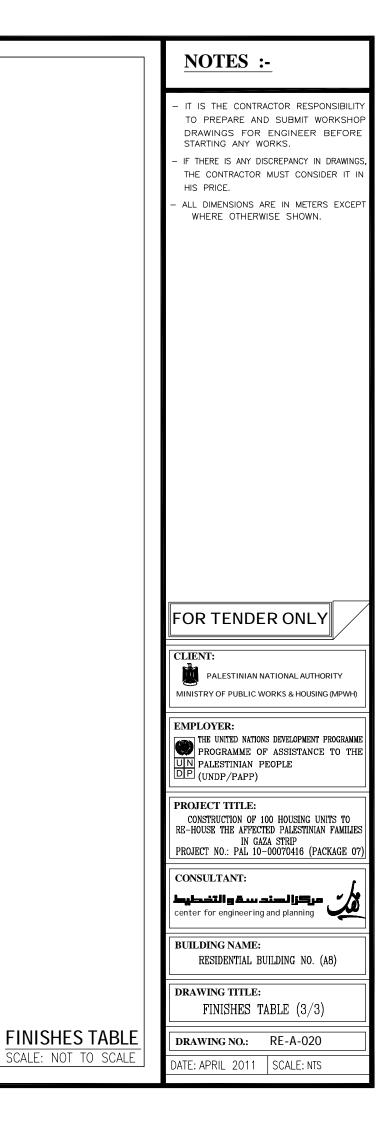

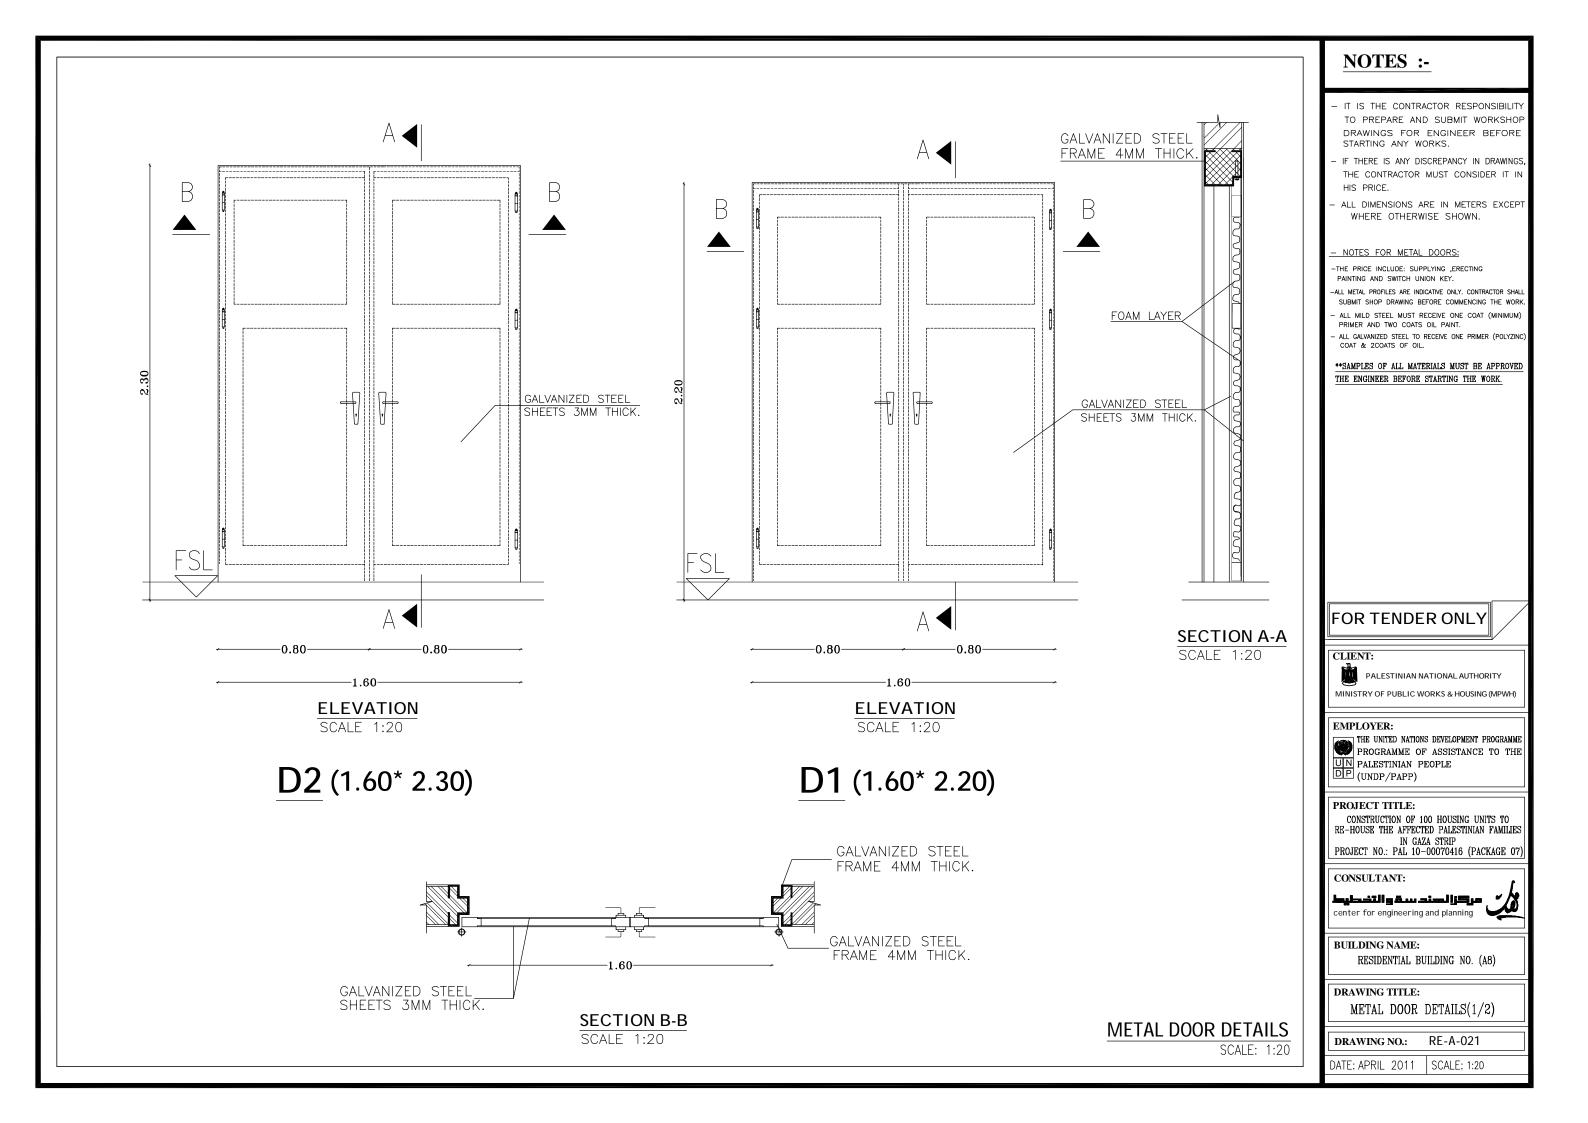


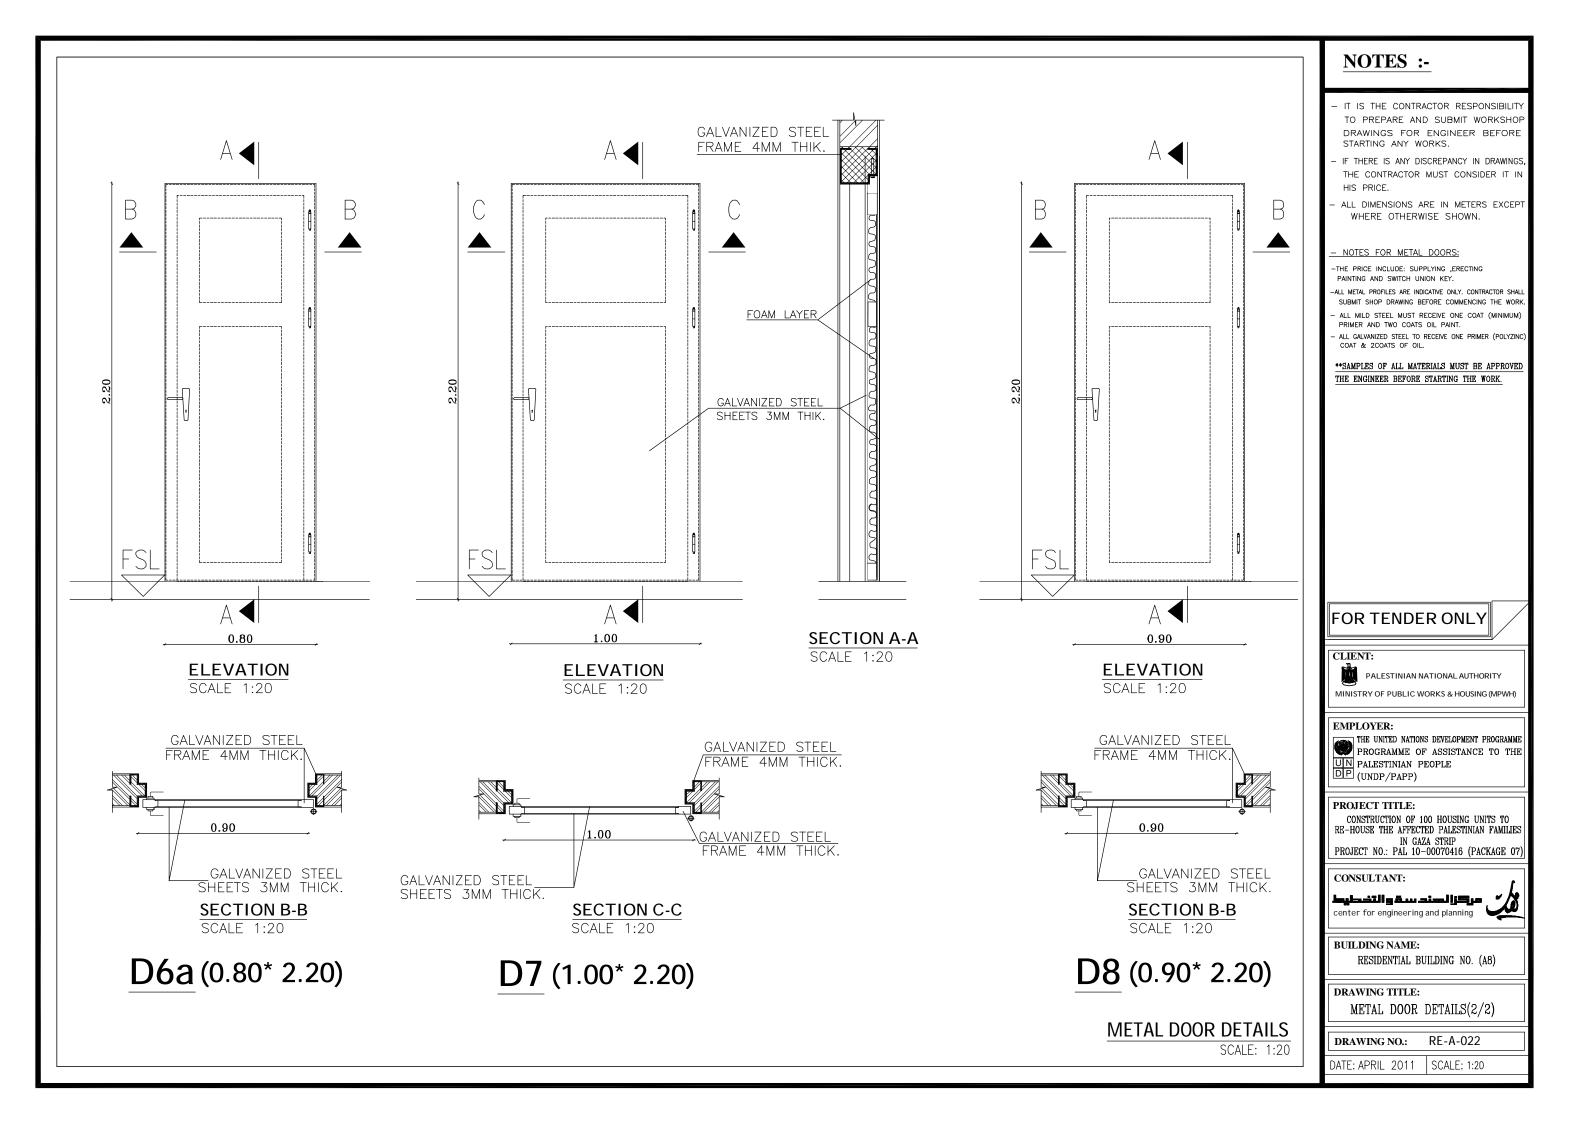


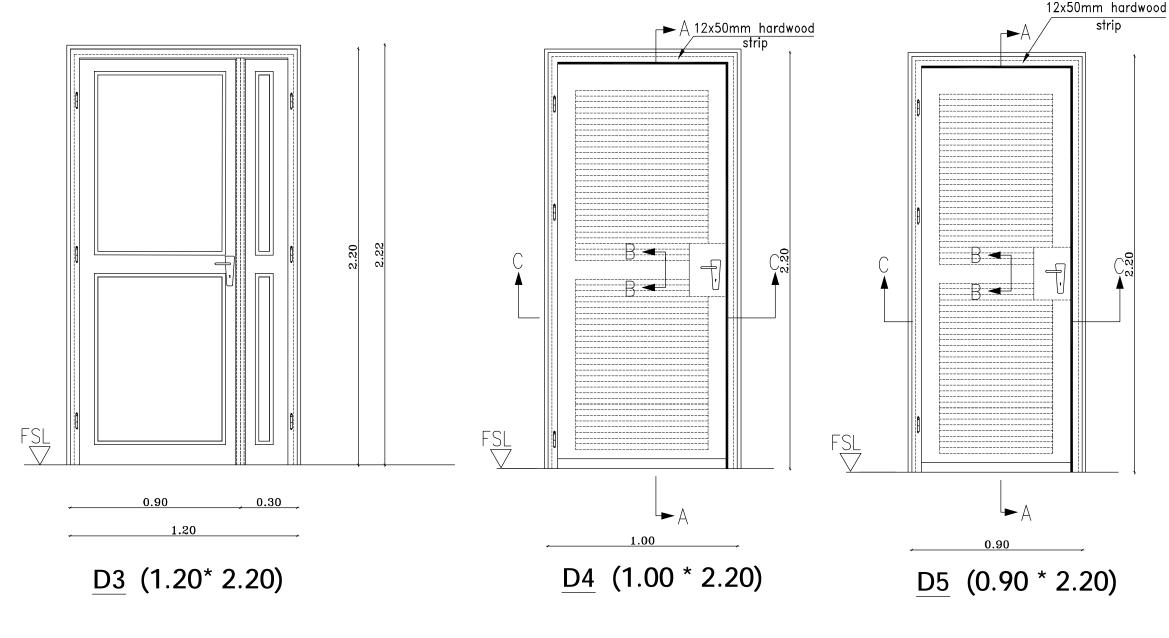



WOODEN DOOR DETAILS

NOTES :-- IT IS THE CONTRACTOR RESPONSIBILITY TO PREPARE AND SUBMIT WORKSHOP DRAWINGS FOR ENGINEER BEFORE STARTING ANY WORKS. IF THERE IS ANY DISCREPANCY IN DRAWINGS, THE CONTRACTOR MUST CONSIDER IT IN HIS PRICE. ALL DIMENSIONS ARE IN METERS EXCEPT WHERE OTHERWISE SHOWN. - NOTES FOR WOODEN DOORS: - ALL TIMBER TO BE SWEDISH CLASS A UNLESS OTHERWISE SHOWN. ARCHITRAVES AND COVER MOULDS TO BE FIXED TO DOOR FRAMES WITH PANEL PINS. 3 HINGES WHERE NECESSARY BUTT HINGES PER DOOR LEAF. WOODEN FRAMES: FRAMES ABUTTING BLOCKWORK TO BE BUILT IN WITH MILD STEEL CRAMPS AS PER SPECIFICATION & DRAWINGS. FRAMES ABUTTING CONCRETE TO BE DRILLED COUNTERSUNK AND FIXED WITH EXPANSION BOLTS 3 PER JAMB. DOORSTOPS: PROJECTING WALL MOUNTED TYPE10CM LONG WOODEN DOORS (FIRST CLASS) WOOD AND 4MM THICK PLYWOOD. ALL TIMBER WILL BE PAINTED ACCORDING TO THE SPECIFICATIONS. THE DOOR LOCK IS "SWITCH UNION" (BEST QUALITY). \land **SAMPLES OF ALL MATERIALS MUST BE APPROVED *i*w' THE ENGINEER BEFORE STARTING THE WORK. FOR TENDER ONLY CLIENT: PALESTINIAN NATIONAL AUTHORITY MINISTRY OF PUBLIC WORKS & HOUSING (MPWH) **EMPLOYER:** PROGRAMME OF ASSISTANCE TO THE UN PALESTINIAN PEOPLE DP (UNDP/PAPP) PROJECT TITLE: CONSTRUCTION OF 100 HOUSING UNITS TO RE-HOUSE THE AFFECTED PALESTINIAN FAMILIES IN GAZA STRIP PROJECT NO.: PAL 10-00070416 (PACKAGE 07) CONSULTANT: مرکزا لسند سقو التخطيط center for engineering and planning **BUILDING NAME:** RESIDENTIAL BUILDING NO. (A8) DRAWING TITLE: WOODEN DOOR DETAILS (1/3)RE-A-023 DRAWING NO .: SCALE: 1:20 DATE: APRIL 2011 | SCALE: 1:20

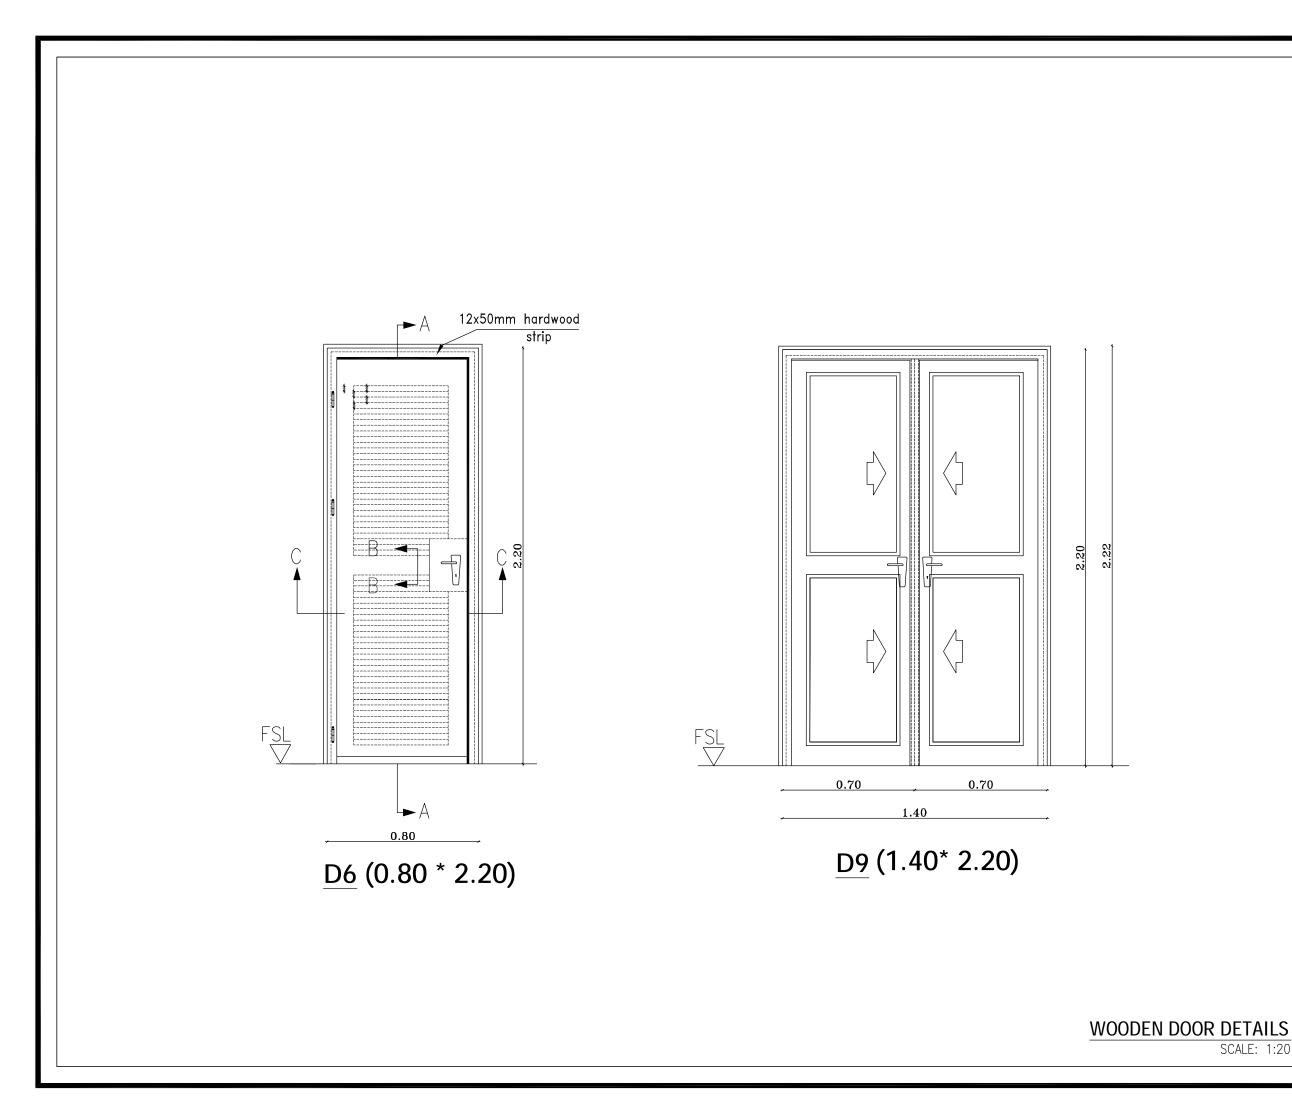


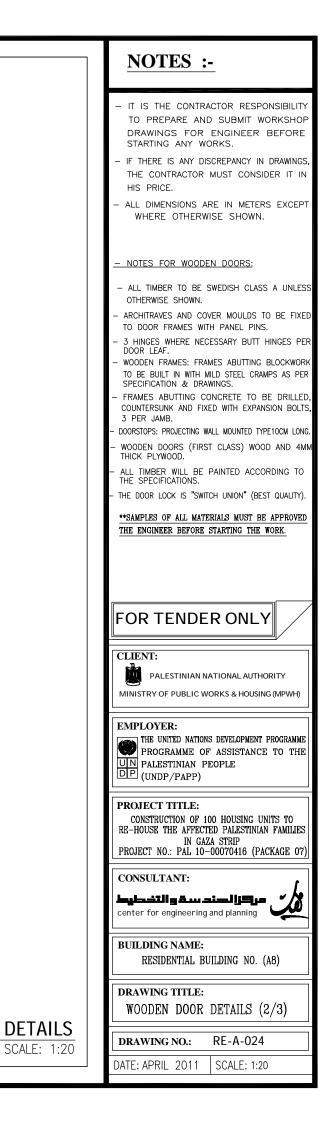


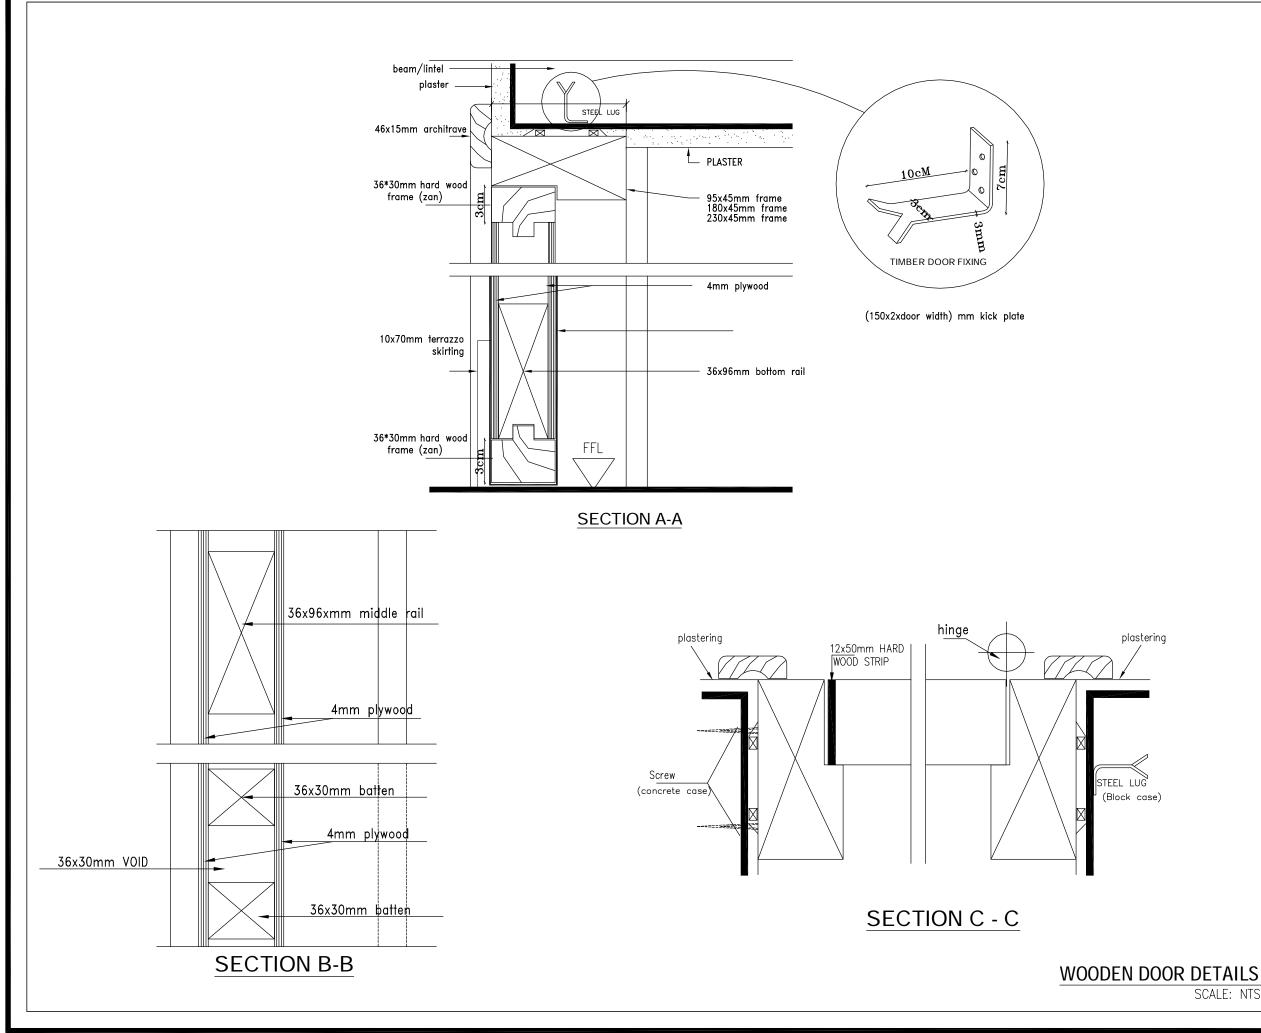


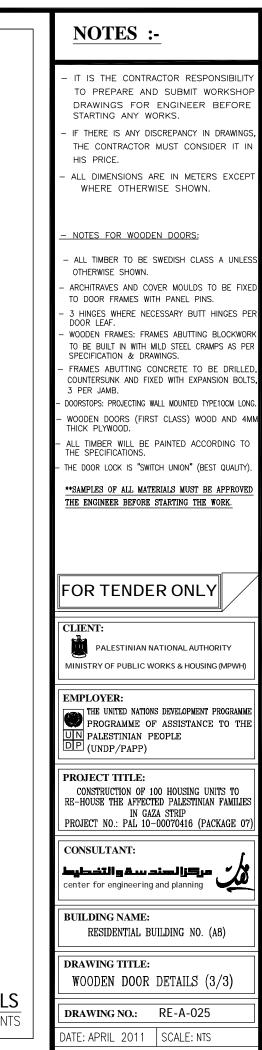


SCALE: NTS

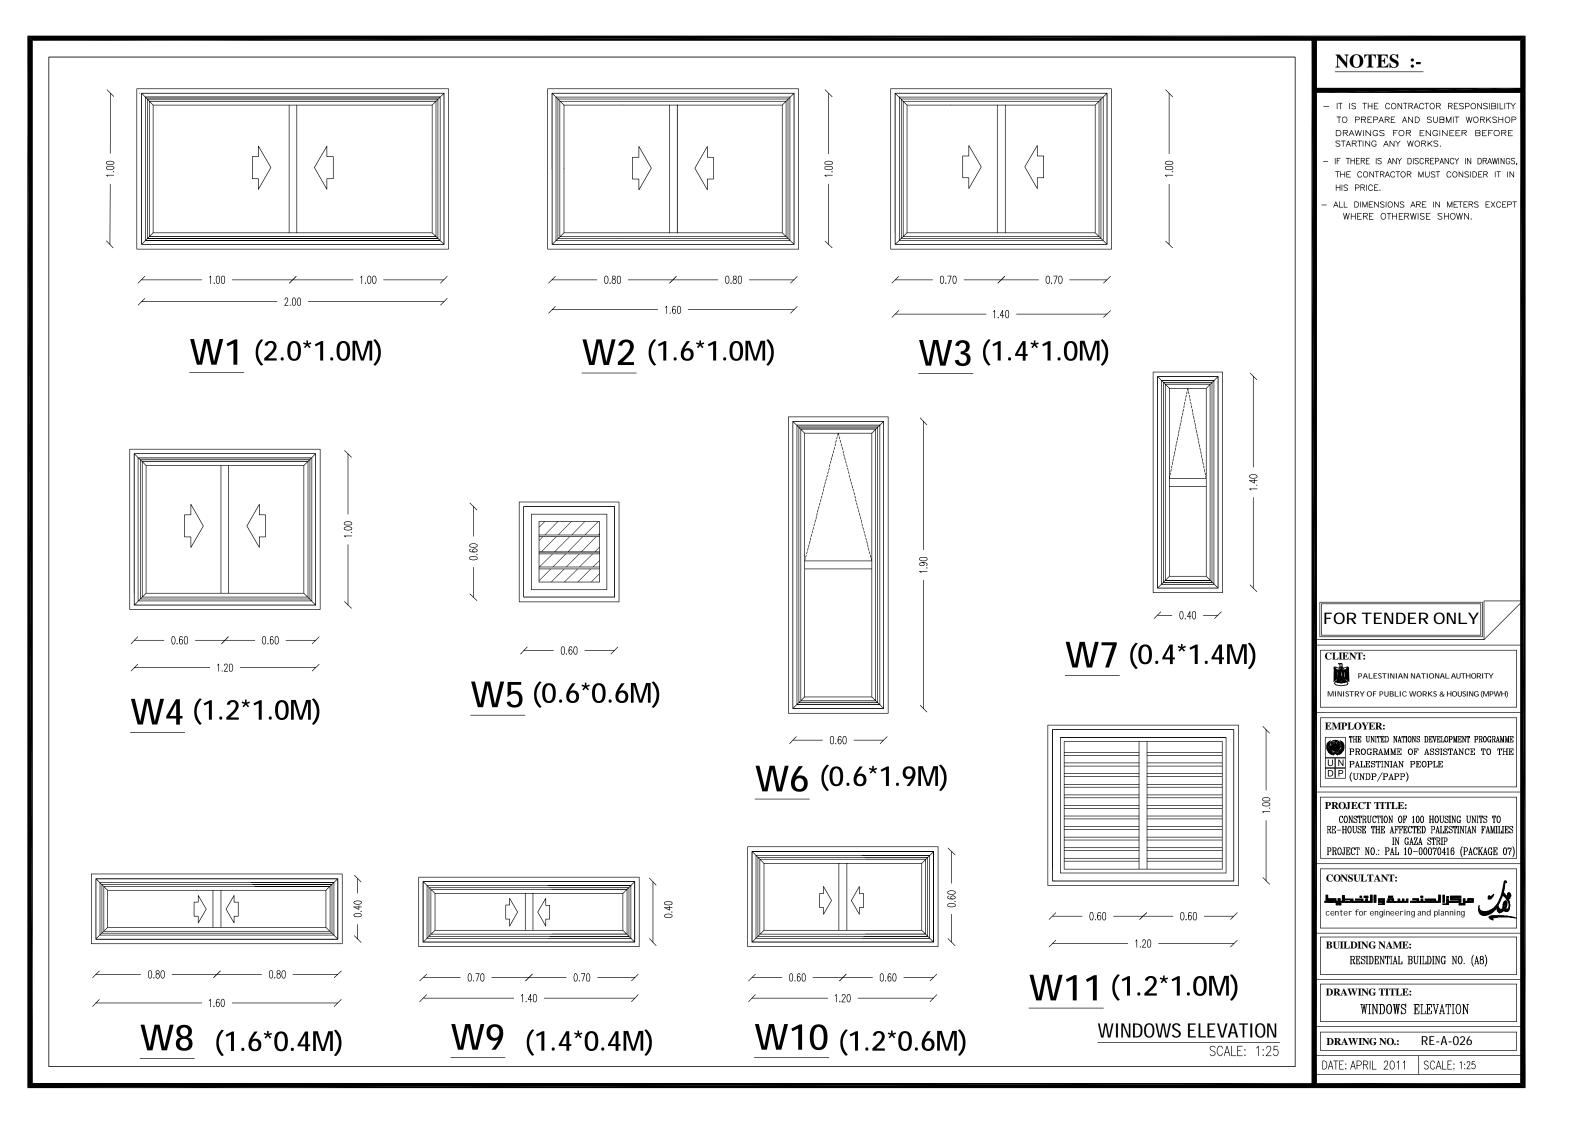

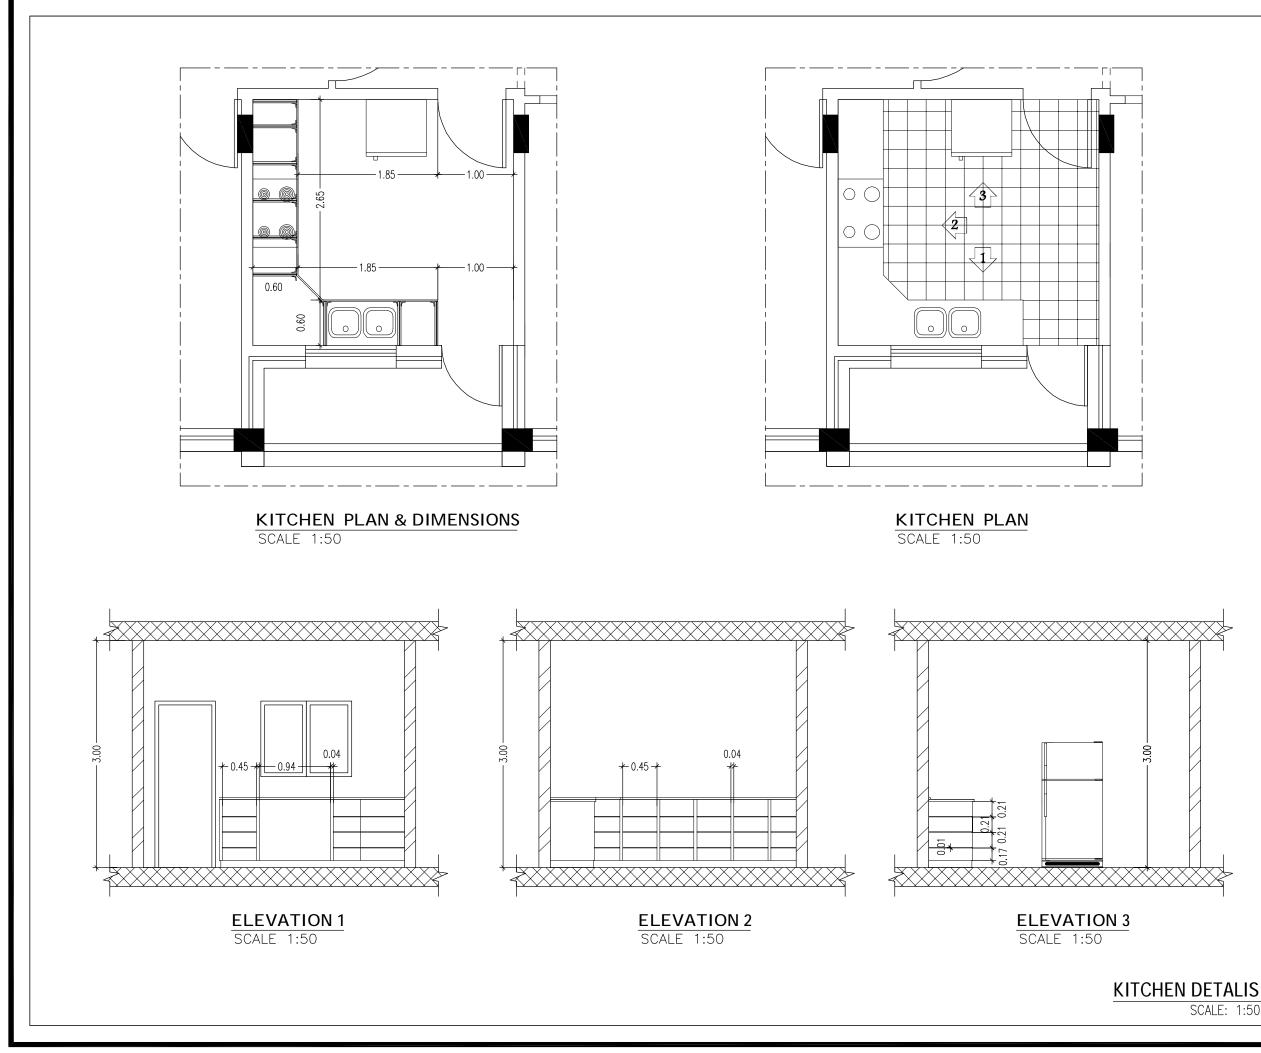

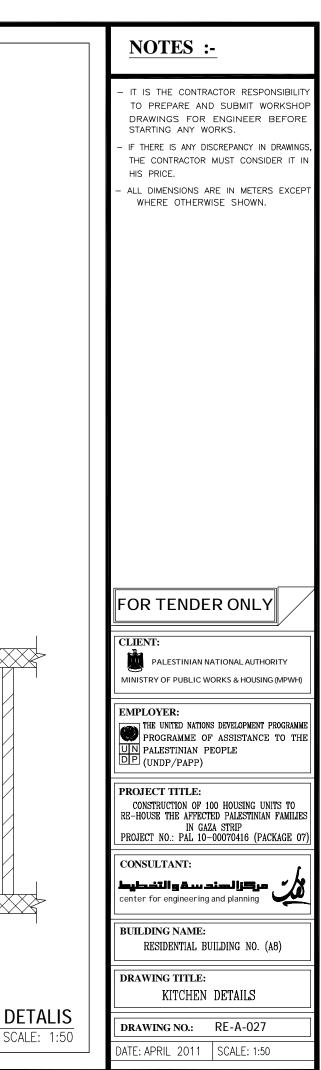

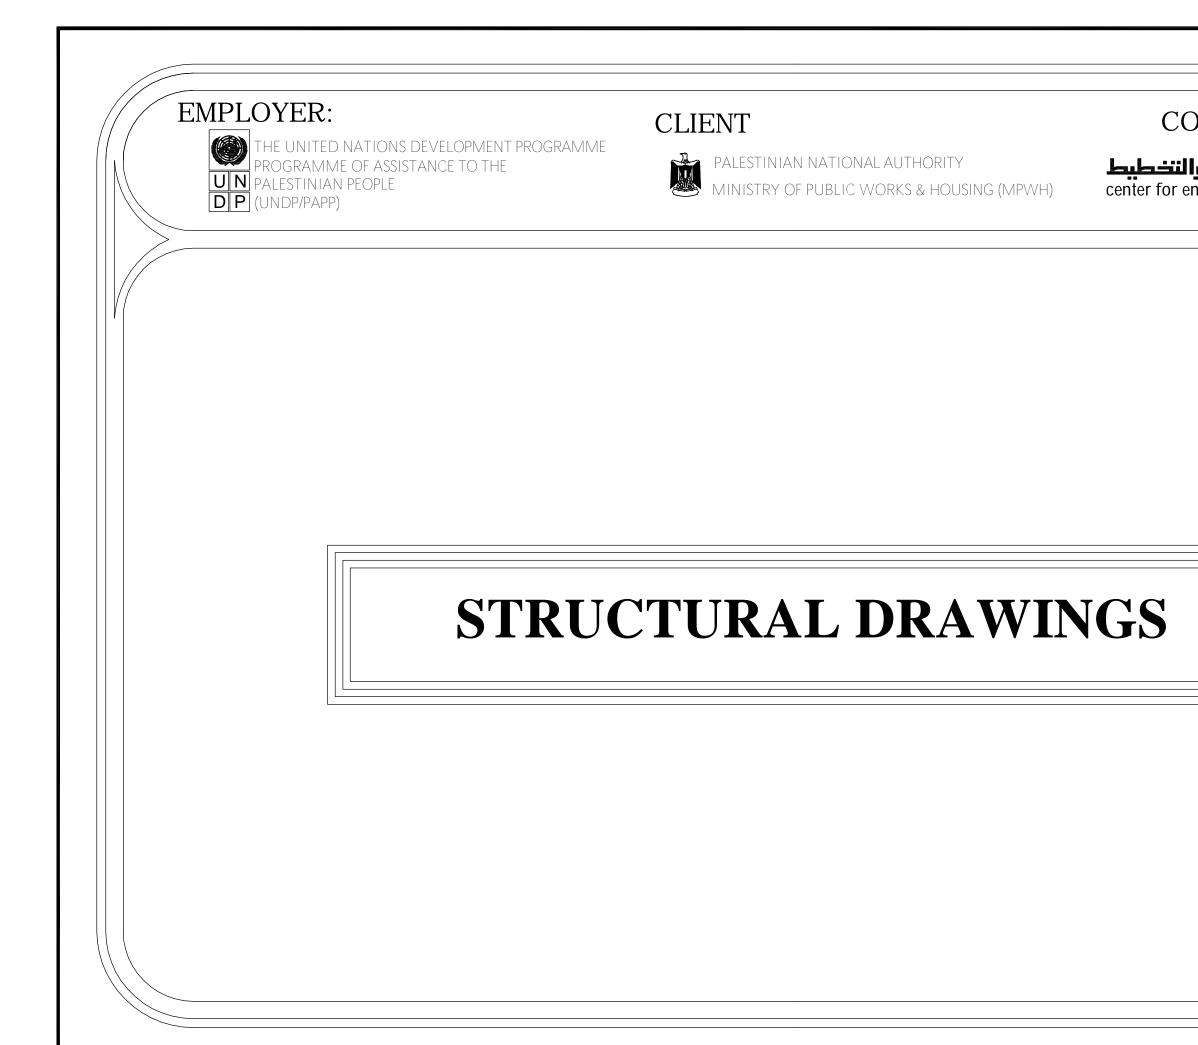



EMPLOYER:




THE UNITED NATIONS DEVELOPMENT PROGRAMME PROGRAMME OF ASSISTANCE TO THE PALESTINIAN PEOPLE DP (UNDP/PAPP)

CLIENT




PALESTINIAN NATIONAL AUTHORITY MINISTRY OF PUBLIC WORKS & HOUSI MINISTRY OF PUBLIC WORKS & HOUSING (MPWH)

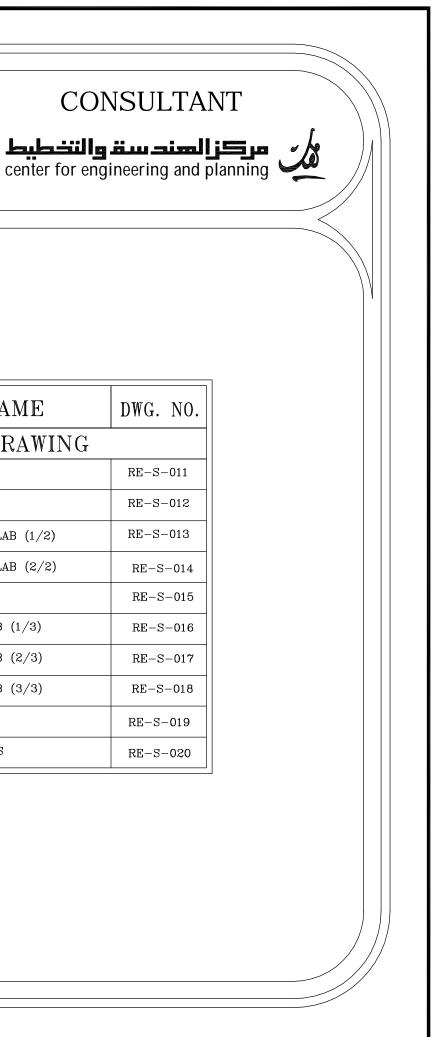



LIST OF DRAWINGS

S/NO.	DRAWING NAME	DWG. NO.									
	STRUCTURAL DRAWING										
01/21	GENERAL STRUCTURAL DETAILS	RE-S-000									
02/21	COLUMN AXES	RE-S-001									
03/21	GENERAL LAYOUT AND DIMENSIONS FOR FOOTINGS	RE-S-002									
04/21	FOOTING DETAILS (1/2)	RE-S-003									
05/21	FOUNDATIONS DETAILS (2/2)	RE-S-004									
06/21	BASEMENT WALL & SHEAR WALL DETAILS	RE-S-005									
07/21	ELEVATOR WALL DETAILS	RE-S-006									
08/21	COLUMNS DETAILS (1/4)	RE-S-007									
09/21	COLUMNS DETAILS (2/4)	RE-S-008									
10/21	COLUMNS DETAILS (3/4)	RE-S-009									
11/21	COLUMNS DETAILS (4/4)	RE-S-010									

S/NO.	DRAWING NAME
	STRUCTURAL DRAWING
12/21	GROUND BEAMS DETAILS
13/21	BASEMENT SLAB DETAILS
14/21	BEAMS DETAILS OF BASEMENT SLAB (1/2)
15/21	BEAMS DETAILS OF BASEMENT SLAB (2/2)
16/21	TYPICAL SLAB DETAILS
17/21	BEAMS DETAILS OF TYPICAL SLAB (1/3)
18/21	BEAMS DETAILS OF TYPICAL SLAB (2/3)
19/21	BEAMS DETAILS OF TYPICAL SLAB (3/3)
20/21	STAIRS ROOF SLAB DETAILS
21/21	STRUCTURAL DETAILS FOR STAIRS
	•

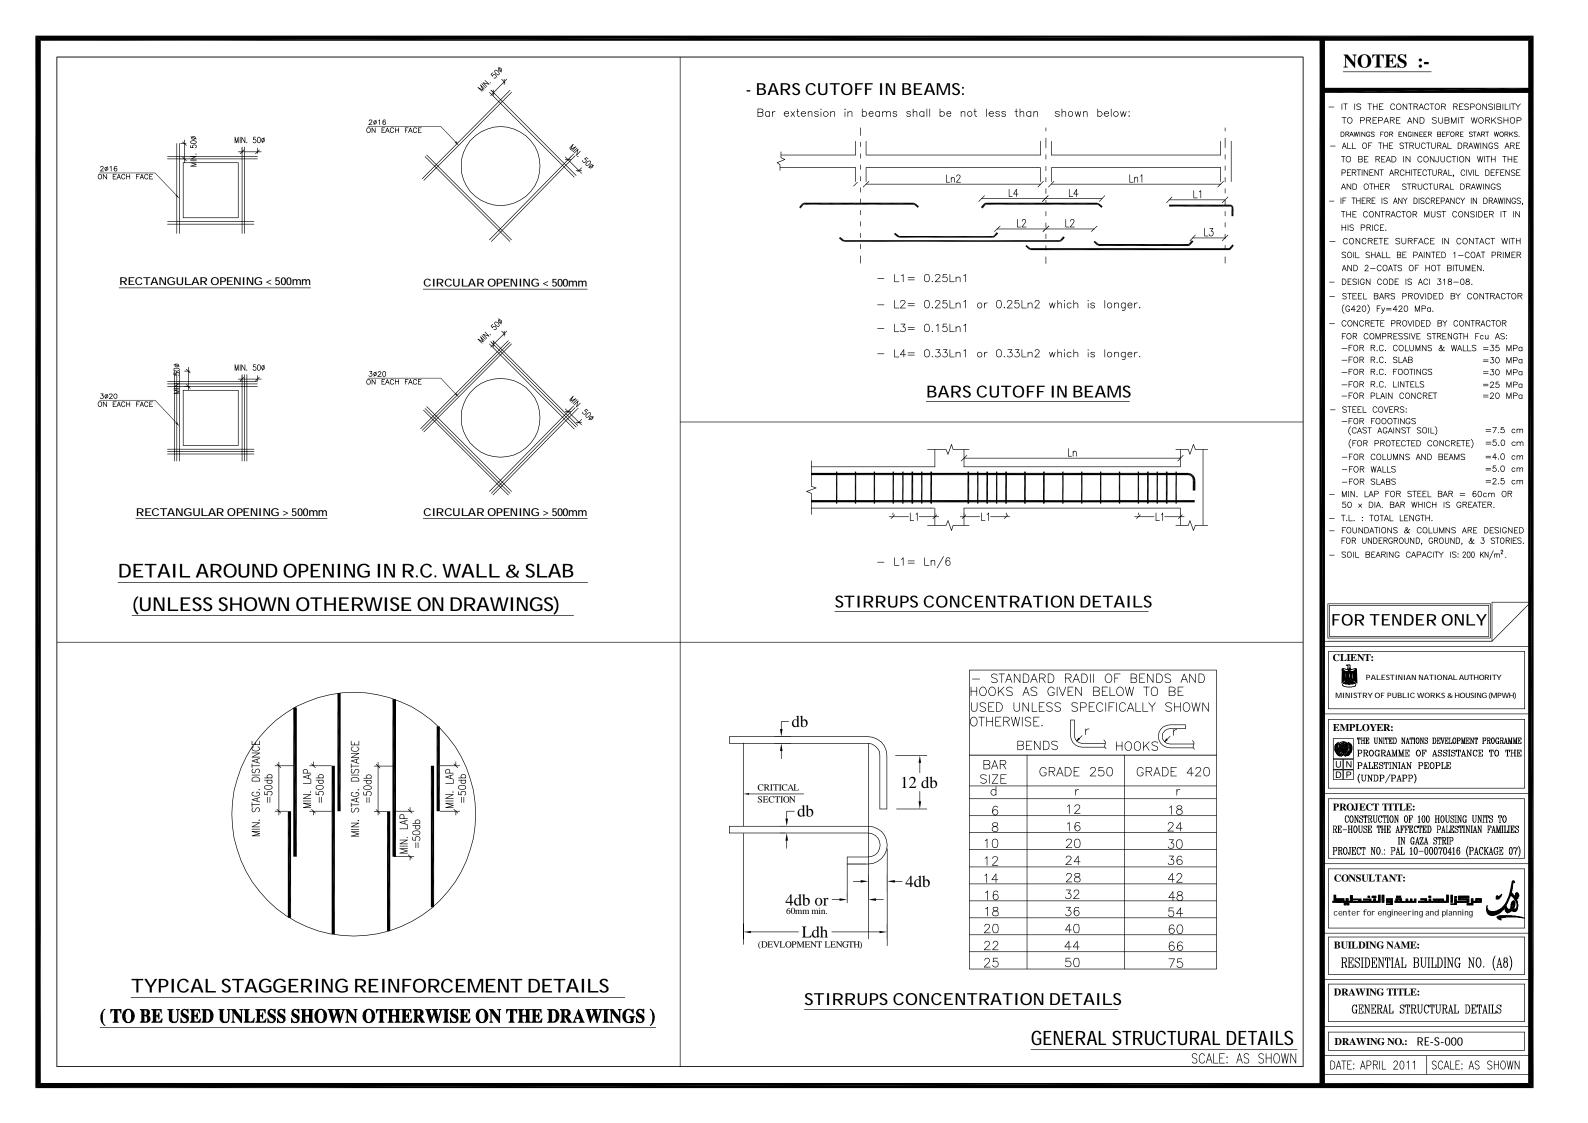

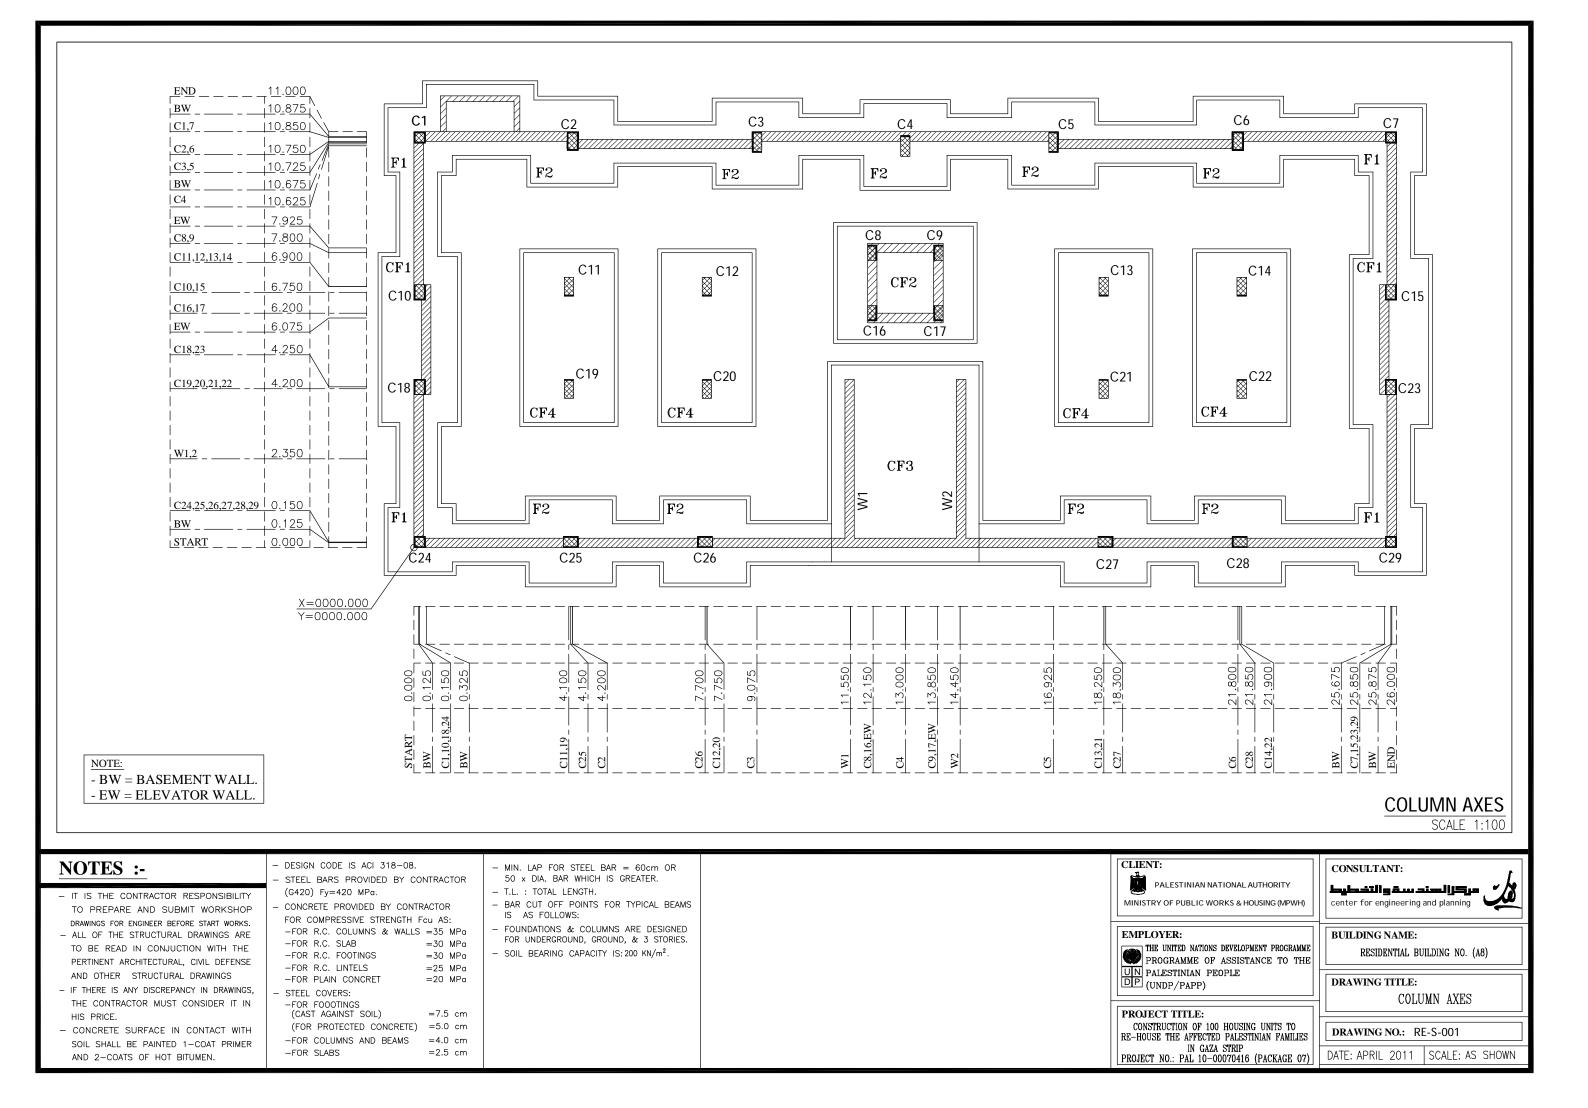

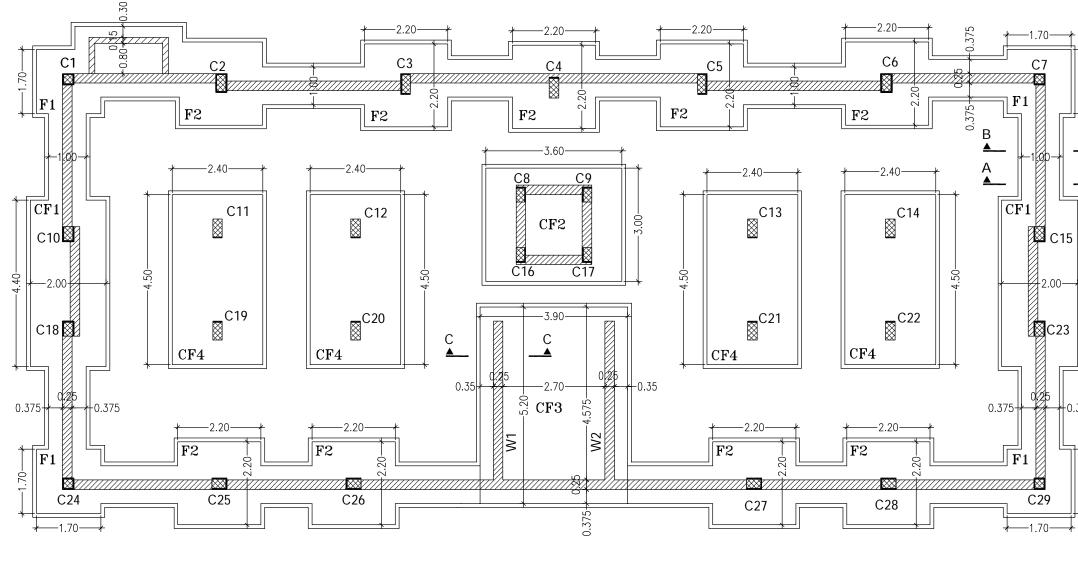


GENERAL LAYOUT AND DIMENSIONS FOR FOOTINGS

-FOR DETAILS OF SEC. A-A, B-B & C-C REFER TO DWG. NO. RE-S-005 -FOR DETAILS OF FOOTING (CF2) REFER TO DWG. NO. RE-S-006


 \bigotimes ፟፟፟ቚ----THE COL. SIZE IS FIXED FROM ALL SIDES ALONG THE COL. SIZE IS FIXED THE COL. SIZE IS FIXED THE COL. SIZE IS FIXED FROM THREE SIDES. FROM TWO SIDES. FROM ONE SIDE. THE BUILDING HEIGHT C3,5,10,15,18,23 C8,9,16,17 C4,11,12,13,14 C1,2,6,7,24,29 25,26,27,28 19,20,21,22

DIRECTIONS OF COLUMN SIZE CHANGE

GENERAL LAYOUT AND DIMENSIONS FOR FOOTINGS

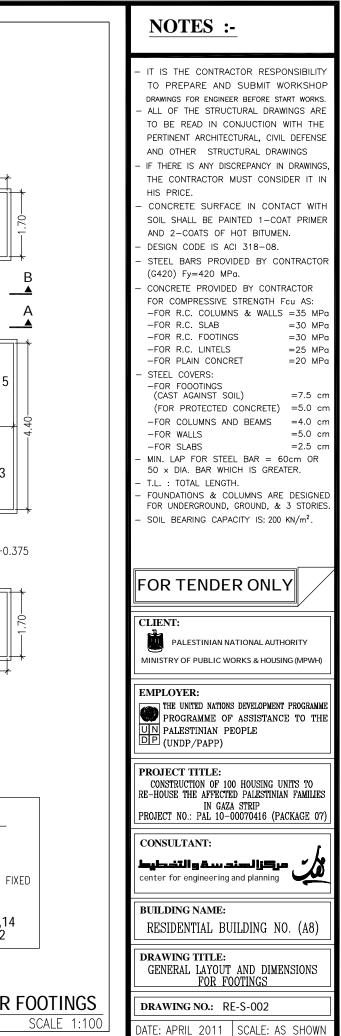

г									
	Foot	tal	Foot	ings	size	F	Reinforcer	nent	
	FOOT. NO.	COL. NO.	-0 E	L(cm)	W(cm)	h(cm)	LONG DIR.	SHORT DIR.	Shape
	F1	1,7,24,29	4	170	170	40	1ø12@15cm	1ø12@15cm	TOP/160cm 20 BOT/160cm T.L=200cm
	F2	2,3,4,5,6 25,26,27,28	9	220	220	40	1ø12@15cm	1ø12@15cm	TOP/210cm 20 BOT/210cm T.L=250cm

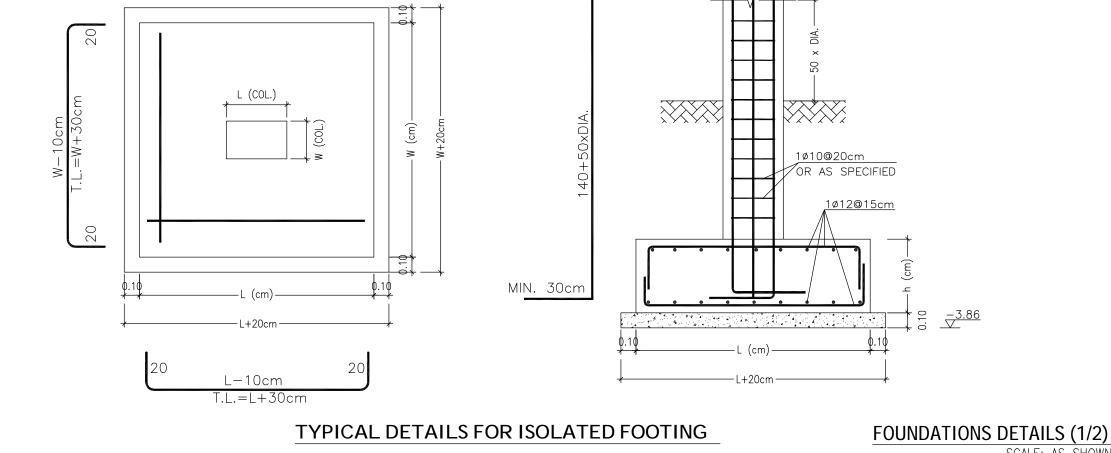

SCALE: AS SHOWN


	NOTES :-
I	 IT IS THE CONTRACTOR RESPONSIBILITY TO PREPARE AND SUBMIT WORKSHOP
	DRAWINGS FOR ENGINEER BEFORE START WORKS. - ALL OF THE STRUCTURAL DRAWINGS ARE TO BE READ IN CONJUCTION WITH THE PERTINENT ARCHITECTURAL, CIVIL DEFENSE
	AND OTHER STRUCTURAL DRAWINGS - IF THERE IS ANY DISCREPANCY IN DRAWINGS, THE CONTRACTOR MUST CONSIDER IT IN
	HIS PRICE. - CONCRETE SURFACE IN CONTACT WITH SOIL SHALL BE PAINTED 1-COAT PRIMER
	AND 2-COATS OF HOT BITUMEN. - DESIGN CODE IS ACI 318-08. - STEEL BARS PROVIDED BY CONTRACTOR (C400) Fr. 420 MP-
	 (G420) Fy=420 MPa. CONCRETE PROVIDED BY CONTRACTOR FOR COMPRESSIVE STRENGTH Fcu AS: FOR R.C. COLUMNS & WALLS =35 MPa
	-FOR R.C. SLAB =30 MPa -FOR R.C. FOOTINGS =30 MPa -FOR R.C. LINTELS =25 MPa -FOR PLAIN CONCRET =20 MPa
	- STEEL COVERS: -FOR FOODTINGS (CAST AGAINST SOIL) =7.5 cm (FOR PROTECTED CONCRETE) =5.0 cm
	-FOR COLUMNS AND BEAMS=4.0 cm-FOR WALLS=5.0 cm-FOR SLABS=2.5 cm
	 MIN. LAP FOR STEEL BAR = 60cm OR 50 × DIA. BAR WHICH IS GREATER. T.L. : TOTAL LENGTH. FOUNDATIONS & COLUMNS ARE DESIGNED
	FOR UNDERGROUND, GROUND, & 3 STORIES. - SOIL BEARING CAPACITY IS: 200 KN/m ² .
	FOR TENDER ONLY
	CLIENT: PALESTINIAN NATIONAL AUTHORITY MINISTRY OF PUBLIC WORKS & HOUSING (MPWH)
	EMPLOYER: THE UNITED NATIONS DEVELOPMENT PROGRAMME PROGRAMME OF ASSISTANCE TO THE PALESTINIAN PEOPLE UP (UNDP/PAPP)
	PROJECT TITLE: CONSTRUCTION OF 100 HOUSING UNITS TO RE-HOUSE THE AFFECTED PALESTINIAN FAMILIES IN GAZA STRIP PROJECT NO.: PAL 10-00070416 (PACKAGE 07)
	CONSULTANT: مرکزالسند سقوالتخطیط center for engineering and planning
	building name: RESIDENTIAL BUILDING NO. (A8)
	DRAWING TITLE: FOOTING DETAILS (1/2)
	DRAWING NO.: RE-S-003

DATE: APRIL 2011 SCALE: AS SHOWN



Table of Footings (COMBINED)


Foc	tal	Foot	ings	size	F	Reinforce	ment	
FOOT. NO.	COL. NO.	Total	L(cm)	W(cm)	h(cm)	LONG DIR. (TOP & BOT.)	SHORT DIR. (TOP & BOT.)	Shape
CF1	10,15,18,23	2	440	200	40	1ø12@15cm	1ø12@15cm	20 BOT. L OR W-10cm
CF2	8,9,16,17	1	360	300	30	1ø12@20cm	1ø12@20cm	TOP 15 BOT. L OR W-10cm
CF3	W1,W2	1	520	390	50	1ø12@10cm	1ø12@10cm	TOP 30 BOT. L OR W-10cm
CF4	11,19,12,20 13,21,14,22	4	450	240	50	1ø12@10cm	1ø12@10cm	30 BOT. L OR W-10cm

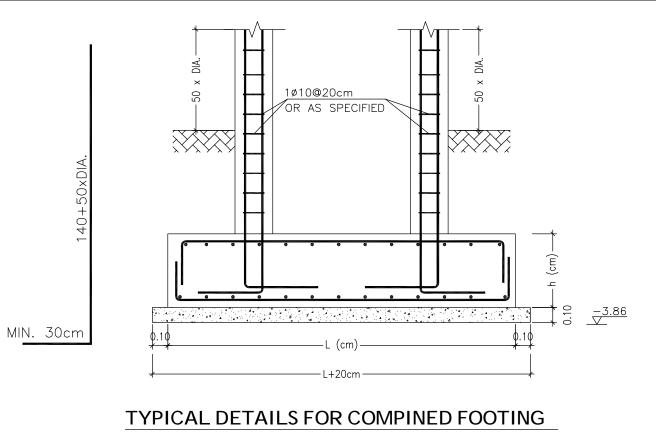


NOTES :-

	 IT IS THE CONTRACTOR RESPONSIBILITY TO PREPARE AND SUBMIT WORKSHOP DRAWINGS FOR ENGINEER BEFORE START WORKS. ALL OF THE STRUCTURAL DRAWINGS ARE TO BE READ IN CONJUCTION WITH THE PERTINENT ARCHITECTURAL, CIVIL DEFENSE AND OTHER STRUCTURAL DRAWINGS IF THERE IS ANY DISCREPANCY IN DRAWINGS, THE CONTRACTOR MUST CONSIDER IT IN HIS PRICE. CONCRETE SURFACE IN CONTACT WITH SOIL SHALL BE PAINTED 1-COAT PRIMER AND 2-COATS OF HOT BITUMEN. DESIGN CODE IS ACI 318-08. STEEL BARS PROVIDED BY CONTRACTOR (G420) Fy=420 MPa. CONCRETE PROVIDED BY CONTRACTOR FOR COMPRESSIVE STRENGTH FCU AS: -FOR R.C. CLUMNS & WALLS =35 MPa -FOR R.C. SLAB = 30 MPa -FOR R.C. SLAB = 30 MPa -FOR R.C. LINTELS = 25 MPa -FOR R.C. LINTELS = 25 MPa -FOR PLAIN CONCRET = 20 MPa STEEL COVERS: -FOR FOOTINGS (CAST AGAINST SOIL) =7.5 cm (FOR PROTECTED CONCRETE) =5.0 cm -FOR WALLS =5.0 cm -FOR WALLS =5.0 cm -FOR WALLS =5.0 cm
	 MIN. LAP FOR STEEL BAR = 60cm OR 50 x DIA. BAR WHICH IS GREATER. T.L. : TOTAL LENGTH. FOUNDATIONS & COLUMNS ARE DESIGNED FOR UNDERGROUND, GROUND, & 3 STORIES. SOIL BEARING CAPACITY IS: 200 KN/m².
	FOR TENDER ONLY
	FOR TENDER ONLY
	CLIENT: PALESTINIAN NATIONAL AUTHORITY
	CLIENT: PALESTINIAN NATIONAL AUTHORITY MINISTRY OF PUBLIC WORKS & HOUSING (MPWH) EMPLOYER: THE UNITED NATIONS DEVELOPMENT PROGRAMME PROGRAMME OF ASSISTANCE TO THE PALESTINIAN PEOPLE
	CLIENT: PALESTINIAN NATIONAL AUTHORITY MINISTRY OF PUBLIC WORKS & HOUSING (MPWH) EMPLOYER: THE UNITED NATIONS DEVELOPMENT PROGRAMME PROGRAMME OF ASSISTANCE TO THE PROGRAMME OF ASSISTANCE TO THE UN PALESTINIAN PEOPLE DP (UNDP/PAPP) PROJECT TITLE: CONSTRUCTION OF 100 HOUSING UNITS TO RE-HOUSE THE AFFECTED PALESTINIAN FAMILIES IN GAZA STRIP
	CLIENT: PALESTINIAN NATIONAL AUTHORITY MINISTRY OF PUBLIC WORKS & HOUSING (MPWH) EMPLOYER: THE UNITED NATIONS DEVELOPMENT PROGRAMME PROGRAMME OF ASSISTANCE TO THE PROGRAMME OF ASSISTANCE TO THE UN PALESTINIAN PEOPLE UN PALESTINIAN PEOPLE (UNDP/PAPP) PROJECT TITLE: CONSTRUCTION OF 100 HOUSING UNITS TO RE-HOUSE THE AFFECTED PALESTINIAN FAMILIES IN GAZA STRIP PROJECT NO.: PAL 10-00070416 (PACKAGE 07) CONSULTANT: Luberting & Loring (Ling) (Ling)
	CLIENT: PALESTINIAN NATIONAL AUTHORITY MINISTRY OF PUBLIC WORKS & HOUSING (MPWH) EMPLOYER: THE UNITED NATIONS DEVELOPMENT PROGRAMME PROGRAMME OF ASSISTANCE TO THE PROJECT TITLE: (UNDP/PAPP) PROJECT TITLE: CONSTRUCTION OF 100 HOUSING UNITS TO RE-HOUSE THE AFFECTED PALESTINIAN FAMILIES IN GAZA STRIP PROJECT NO.: PAL 10-00070416 (PACKAGE 07) CONSULTANT: Labertill g & Labertill Schemer
_	CLIENT: PALESTINIAN NATIONAL AUTHORITY MINISTRY OF PUBLIC WORKS & HOUSING (MPWH) EMPLOYER: PROGRAMME OF ASSISTANCE TO THE PROGRAMME OF ASSISTANCE TO THE UN PALESTINIAN PEOPLE DP (UNDP/PAPP) PROJECT TITLE: CONSTRUCTION OF 100 HOUSING UNITS TO RE-HOUSE THE AFFECTED PALESTINIAN FAMILIES IN GAZA STRIP PROJECT NO.: PAL 10-00070416 (PACKAGE 07) CONSULTANT: LALASTIN B & LALASTIC FOR center for engineering and planning ENGLIDING NAME: RESIDENTIAL BUILDING NO. (A8) DRAWING TITLE:

FOUNDATIONS DETAILS (2/2) SCALE: AS SHOWN

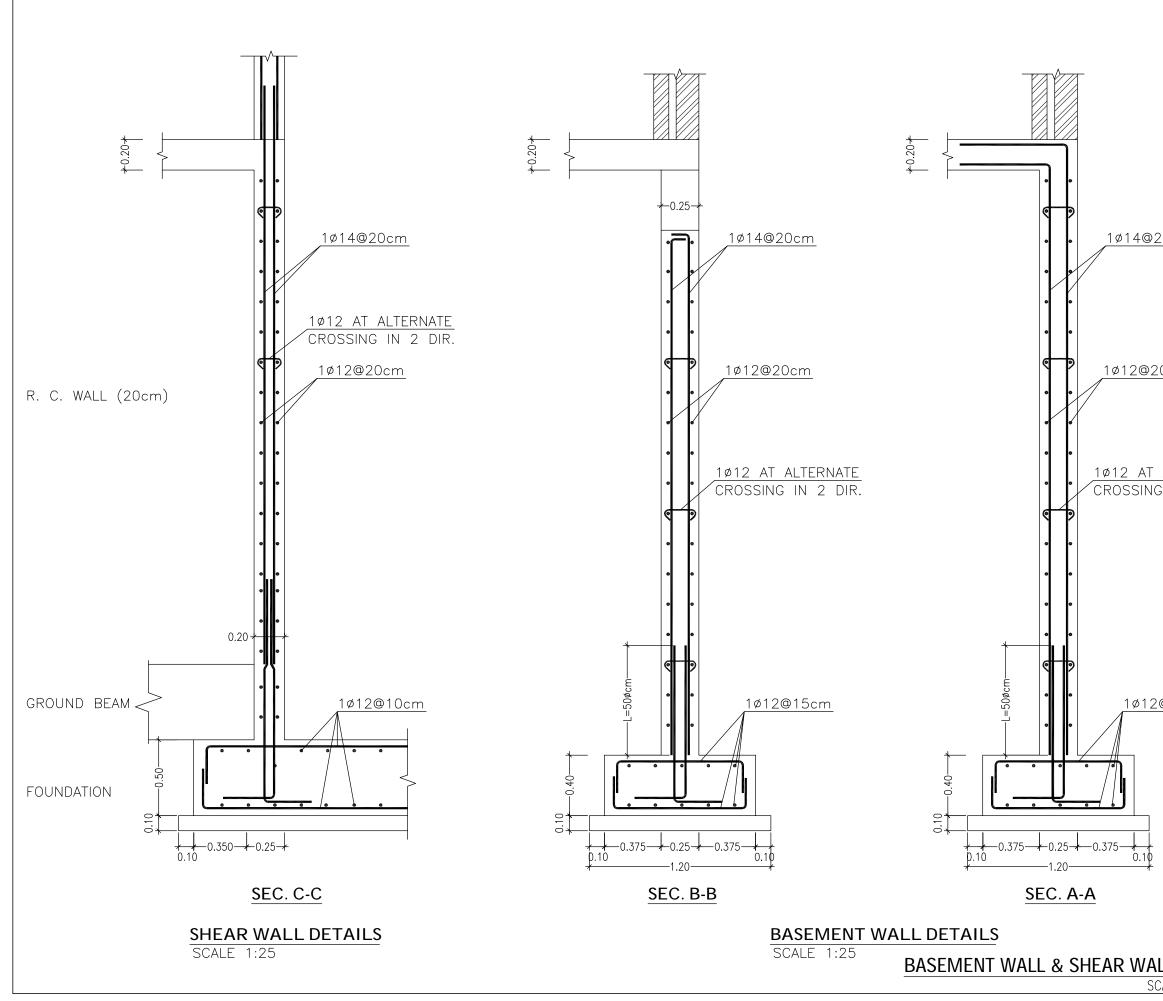


	<u>NOTES :-</u>
<u>20cm</u>	 IT IS THE CONTRACTOR RESPONSIBILITY TO PREPARE AND SUBMIT WORKSHOP DRAWINGS FOR ENGINEER BEFORE START WORKS. ALL OF THE STRUCTURAL DRAWINGS ARE TO BE READ IN CONJUCTION WITH THE PERTINENT ARCHITECTURAL, CIVIL DEFENSE AND OTHER STRUCTURAL DRAWINGS IF THERE IS ANY DISCREPANCY IN DRAWINGS, THE CONTRACTOR MUST CONSIDER IT IN HIS PRICE. CONCRETE SURFACE IN CONTACT WITH SOIL SHALL BE PAINTED 1–COAT PRIMER AND 2–COATS OF HOT BITUMEN. DESIGN CODE IS ACI 318–08. STEEL BARS PROVIDED BY CONTRACTOR (G420) Fy=420 MPa. CONCRETE PROVIDED BY CONTRACTOR FOR COMPRESSIVE STRENGTH FCU AS:
<u>ALTERNATE</u> G IN 2 DIR.	-FOR R.C. COLUMNS & WALLS = 35 MPa -FOR R.C. SLAB = 30 MPa -FOR R.C. FOOTINGS = 30 MPa -FOR R.C. LINTELS = 25 MPa -FOR PLAIN CONCRET = 20 MPa -FOR FOOTINCS (CAST AGAINST SOIL) (CAST AGAINST SOIL) = 7.5 cm (FOR PROTECTED CONCRETE) = 5.0 cm -FOR COLUMNS AND BEAMS = 4.0 cm -FOR SLABS = 2.5 cm MIN. LAP FOR STEEL BAR = 60cm OR 50 x DIA. BAR WHICH IS GREATER. T.L. : TOTAL LENGTH. -FOR UNDERGROUND, GROUND, & 3 STORIES. SOIL BEARING CAPACITY IS: 200 KN/m².
	FOR TENDER ONLY
<u>@15cm</u>	EMPLOYER: THE UNITED NATIONS DEVELOPMENT PROGRAMME PROGRAMME OF ASSISTANCE TO THE PALESTINIAN PEOPLE UNDP/PAPP) PROJECT TITLE: CONSTRUCTION OF 100 HOUSING UNITS TO
	RE-HOUSE THE AFFECTED PALESTINIAN FAMILIES IN GAZA STRIP PROJECT NO.: PAL 10-00070416 (PACKAGE 07) CONSULTANT:
	BUILDING NAME: RESIDENTIAL BUILDING NO. (A8)
	DRAWING TITLE: BASEMENT WALL & SHEAR WALL DETAILS
LL DETAILS	DRAWING NO.: RE-S-005
CALE: AS SHOWN	DATE: APRIL 2011 SCALE: AS SHOWN

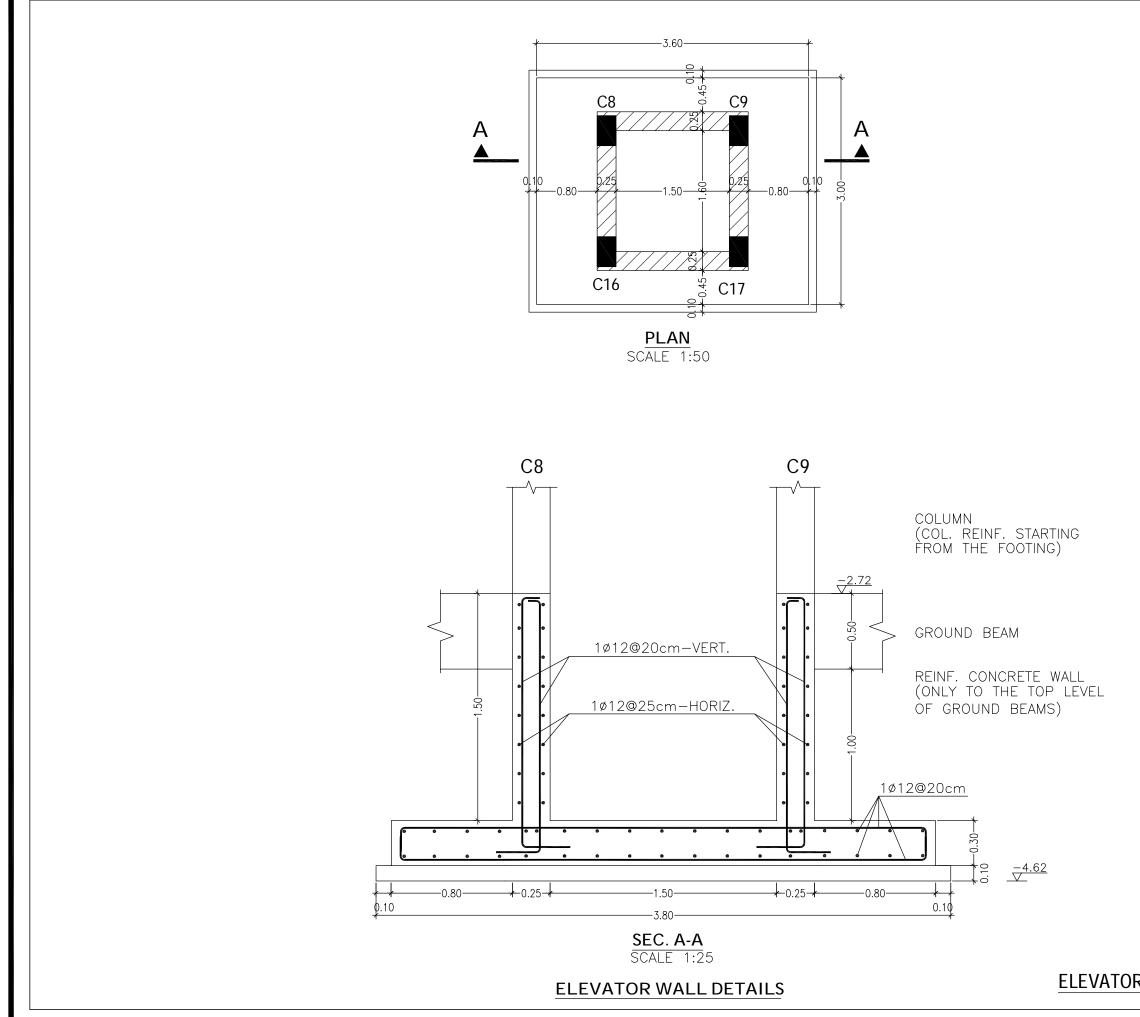


NOTES :-

	 IT IS THE CONTRACTOR RESPONSIBILITY TO PREPARE AND SUBMIT WORKSHOP DRAWINGS FOR ENGINEER BEFORE START WORKS. ALL OF THE STRUCTURAL DRAWINGS ARE TO BE READ IN CONJUCTION WITH THE PERTINENT ARCHITECTURAL, CIVIL DEFENSE AND OTHER STRUCTURAL DRAWINGS IF THERE IS ANY DISCREPANCY IN DRAWINGS,
	 THE CONTRACTOR MUST CONSIDER IT IN HIS PRICE. CONCRETE SURFACE IN CONTACT WITH SOIL SHALL BE PAINTED 1-COAT PRIMER AND 2-COATS OF HOT BITUMEN. DESIGN CODE IS ACI 318-08. CITED DADE OPOUNDED DX CONTRACTOR
	 STEEL BARS PROVIDED BY CONTRACTOR (G420) Fy=420 MPa. CONCRETE PROVIDED BY CONTRACTOR FOR COMPRESSIVE STRENGTH Fcu AS: -FOR R.C. COLUMNS & WALLS =35 MPa -FOR R.C. SLAB = 30 MPa -FOR R.C. LINTELS =25 MPa
	-FOR PLAIN CONCRET =20 MPa - STEEL COVERS: -FOR FOODTINGS (CAST AGAINST SOIL) =7.5 cm (FOR PROTECTED CONCRETE) =5.0 cm -FOR COLUMNS AND BEAMS =4.0 cm -FOR WALLS =5.0 cm -FOR SLABS =2.5 cm
	 MIN. LAP FOR STEEL BAR = 60cm OR 50 × DIA. BAR WHICH IS GREATER. T.L. : TOTAL LENGTH. FOUNDATIONS & COLUMNS ARE DESIGNED FOR UNDERGROUND, GROUND, & 3 STORIES. SOIL BEARING CAPACITY IS: 200 KN/m².
	FOR TENDER ONLY
	FOR TENDER ONLY
	CLIENT: PALESTINIAN NATIONAL AUTHORITY
	CLIENT: PALESTINIAN NATIONAL AUTHORITY MINISTRY OF PUBLIC WORKS & HOUSING (MPWH) EMPLOYER: THE UNITED NATIONS DEVELOPMENT PROGRAMME PROGRAMME OF ASSISTANCE TO THE PALESTINIAN PEOPLE
	CLIENT: PALESTINIAN NATIONAL AUTHORITY MINISTRY OF PUBLIC WORKS & HOUSING (MPWH) EMPLOYER: THE UNITED NATIONS DEVELOPMENT PROGRAMME PROGRAMME OF ASSISTANCE TO THE PROGRAMME OF ASSISTANCE TO THE UN PALESTINIAN PEOPLE (UNDP/PAPP) PROJECT TITLE: CONSTRUCTION OF 100 HOUSING UNITS TO RE-HOUSE THE AFFECTED PALESTINIAN FAMILIES IN GAZA STRIP
	CLIENT: PALESTINIAN NATIONAL AUTHORITY MINISTRY OF PUBLIC WORKS & HOUSING (MPWH) EMPLOYER: PROGRAMME OF ASSISTANCE TO THE PROGRAMME OF ASSISTANCE TO THE UN PALESTINIAN PEOPLE UN PALESTINIAN PEOPLE UNDP/PAPP) PROJECT TITLE: CONSTRUCTION OF 100 HOUSING UNITS TO RE-HOUSE THE AFFECTED PALESTINIAN FAMILIES IN GAZA STRIP PROJECT NO.: PAL 10-00070416 (PACKAGE 07) CONSULTANT: CONSULTAN
	CLIENT: PALESTINIAN NATIONAL AUTHORITY MINISTRY OF PUBLIC WORKS & HOUSING (MPWH) EMPLOYER: THE UNITED NATIONS DEVELOPMENT PROGRAMME PROGRAMME OF ASSISTANCE TO THE PROGRAMME OF ASSISTANCE TO THE UN PALESTINIAN PEOPLE (UNDP/PAPP) PROJECT TITLE: CONSTRUCTION OF 100 HOUSING UNITS TO RE-HOUSE THE AFFECTED PALESTINIAN FAMILIES IN GAZA STRIP PROJECT NO.: PAL 10-00070416 (PACKAGE 07) CONSULTANT: Labering a constant of planning center for engineering and planning
<u> </u>	CLIENT: PALESTINIAN NATIONAL AUTHORITY MINISTRY OF PUBLIC WORKS & HOUSING (MPWH) EMPLOYER: PROGRAMME OF ASSISTANCE TO THE PROGRAMME OF ASSISTANCE TO THE UN PALESTINIAN PEOPLE UN PALESTINIAN PEOPLE (UNDP/PAPP) PROJECT TITLE: CONSTRUCTION OF 100 HOUSING UNITS TO RE-HOUSE THE AFFECTED PALESTINIAN FAMILIES IN GAZA STRIP PROJECT NO.: PAL 10-00070416 (PACKAGE 07) CONSULTANT: Labertian Baun and Jaming CONSULTANT: Consultant: RESIDENTIAL BUILDING NO. (A8) DRAWING TITLE:



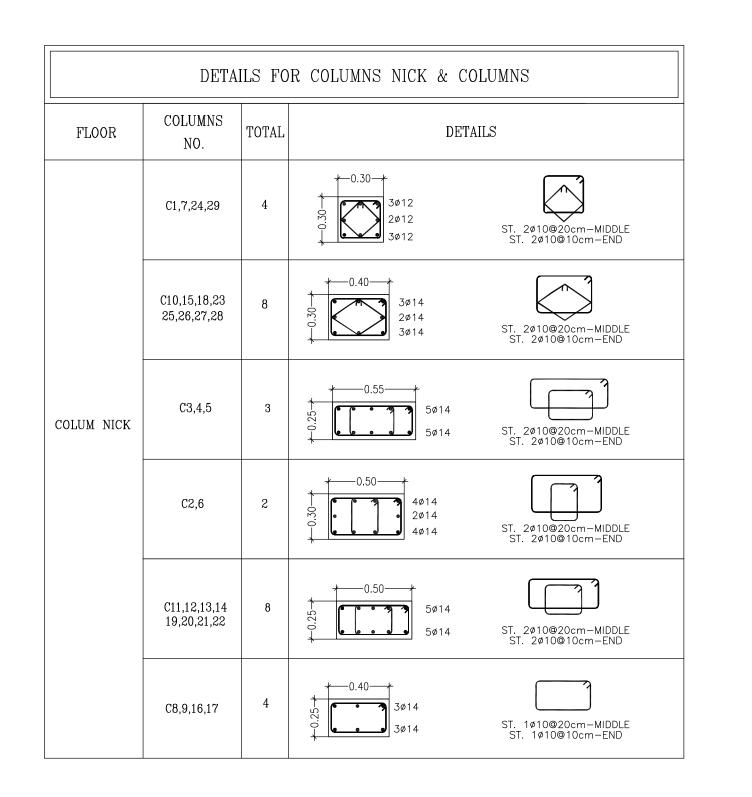

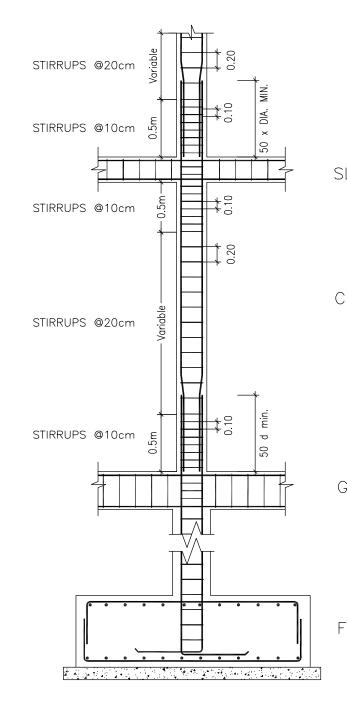

TYPICAL DETAILS FOR COLUMN STIRRUP SPACING


NOT TO SCALE


COLUMNS DE

SC

	<u>NOTES :-</u>
LAB	 IT IS THE CONTRACTOR RESPONSIBILITY TO PREPARE AND SUBMIT WORKSHOP DRAWINGS FOR ENGINEER BEFORE START WORKS. ALL OF THE STRUCTURAL DRAWINGS ARE TO BE READ IN CONJUCTION WITH THE PERTINENT ARCHITECTURAL, CIVIL DEFENSE AND OTHER STRUCTURAL DRAWINGS IF THERE IS ANY DISCREPANCY IN DRAWINGS, THE CONTRACTOR MUST CONSIDER IT IN HIS PRICE. CONCRETE SURFACE IN CONTACT WITH SOIL SHALL BE PAINTED 1–COAT PRIMER AND 2–COATS OF HOT BITUMEN. DESIGN CODE IS ACI 318–08. STEEL BARS PROVIDED BY CONTRACTOR (G420) Fy=420 MPa. CONCRETE PROVIDED BY CONTRACTOR FOR COMPRESSIVE STRENGTH Fcu AS: –FOR R.C. COLUMNS & WALLS =35 MPa –FOR R.C. COTINGS =30 MPa –FOR R.C. LINTELS =25 MPa –FOR PLAIN CONCRET =20 MPa
OLUMN	 -FOR FOOOTINGS (CAST AGAINST SOIL) =7.5 cm (FOR PROTECTED CONCRETE) =5.0 cm -FOR COLUMNS AND BEAMS =4.0 cm -FOR WALLS =5.0 cm -FOR SLABS =2.5 cm MIN. LAP FOR STEEL BAR = 60cm OR 50 × DIA. BAR WHICH IS GREATER. T.L. : TOTAL LENGTH. - FOUNDATIONS & COLUMNS ARE DESIGNED FOR UNDERGROUND, GROUND, & 3 STORIES. - SOIL BEARING CAPACITY IS: 200 KN/m².
G. BEAM	FOR TENDER ONLY
	PALESTINIAN NATIONAL AUTHORITY MINISTRY OF PUBLIC WORKS & HOUSING (MPWH) EMPLOYER: THE UNITED NATIONS DEVELOPMENT PROGRAMME
OUND.	PROGRAMME OF ASSISTANCE TO THE UN PALESTINIAN PEOPLE UNDP/PAPP) PROJECT TITLE: CONSTRUCTION OF 100 HOUSING UNITS TO RE-HOUSE THE AFFECTED PALESTINIAN FAMILIES IN CATA SETUP
	IN GAZA STRIP PROJECT NO.: PAL 10-00070416 (PACKAGE 07) CONSULTANT:
	BUILDING NAME: RESIDENTIAL BUILDING NO. (A8)
	DRAWING TITLE: COLUMNS DETAILS (1/4)
TAILS (1/3) CALE: AS SHOWN	DRAWING NO.: RE-S-007 DATE: APRIL 2011 SCALE: AS SHOWN


DETAILS FOR COLUMNS NICK & COLUMNS					
FLOOR	COLUMNS NO.	TOTAL	DETAILS		
	C1,7,24,29	4	0.30 3ø12 2ø12 3ø12 3ø12	ST. 2ø10@20cm-MIDDLE ST. 2ø10@10cm-END	
	C10,15,18,23 25,26,27,28	8	0.40 3ø14 2ø14 3ø14	ST. 2010@20cm-MIDDLE ST. 2010@10cm-END	
	C3,4,5	3	0.55 5ø14 5ø14 5ø14	ST. 2¢10@20cm-MIDDLE ST. 2¢10@10cm-END	
BASEMENT FLOOR	C2,6	2	0.50 4ø14 2ø14 4ø14	ST. 2¢10@20cm-MIDDLE ST. 2¢10@10cm-END	
	C11,12,13,14 19,20,21,22	8	0.50 5ø14 5ø14 5ø14	ST. 2¢10@20cm-MIDDLE ST. 2¢10@10cm-END	
	C8,9,16,17	4	3ø14 3ø14	ST. 1ø10@20cm-MIDDLE ST. 1ø10@10cm-END	

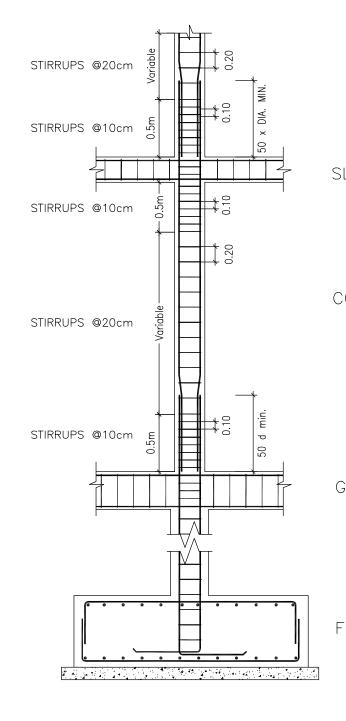


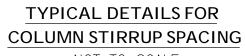

COLUMNS DE

	<u>NOTES :-</u>
LAB	 IT IS THE CONTRACTOR RESPONSIBILITY TO PREPARE AND SUBMIT WORKSHOP DRAWINGS FOR ENCINEER BEFORE START WORKS. ALL OF THE STRUCTURAL DRAWINGS ARE TO BE READ IN CONJUCTION WITH THE PERTINENT ARCHITECTURAL, CIVIL DEFENSE AND OTHER STRUCTURAL DRAWINGS IF THERE IS ANY DISCREPANCY IN DRAWINGS, THE CONTRACTOR MUST CONSIDER IT IN HIS PRICE. CONCRETE SURFACE IN CONTACT WITH SOIL SHALL BE PAINTED 1-COAT PRIMER AND 2-COATS OF HOT BITUMEN. DESIGN CODE IS ACI 318-08. STEEL BARS PROVIDED BY CONTRACTOR (G420) Fy=420 MPa. CONCRETE PROVIDED BY CONTRACTOR FOR COMPRESSIVE STRENGTH Fcu AS: -FOR R.C. COLUMNS & WALLS =35 MPa -FOR R.C. SLAB =30 MPa -FOR R.C. FOOTINGS =30 MPa -FOR R.C. LINTELS =25 MPa -FOR R.C. LINTELS =25 MPa -FOR R.C. CONTRACTOR (CAST AGAINST SOIL) =7.5 cm (FOR PROTECTED CONCRET) =5.0 cm -FOR WALLS =5.0 cm -FOR SLABS =2.5 cm MIN. LAP FOR STEEL BAR =60cm OR 50 x DIA. BAR WHICH IS GREATER.
S. BEAM	 50 × DIA. BAR WHICH IS GREATER. T.L. : TOTAL LENGTH. FOUNDATIONS & COLUMNS ARE DESIGNED FOR UNDERGROUND, GROUND, & 3 STORIES. SOIL BEARING CAPACITY IS: 200 KN/m².
	CLIENT: PALESTINIAN NATIONAL AUTHORITY MINISTRY OF PUBLIC WORKS & HOUSING (MPWH) EMPLOYER:
OUND.	THE UNITED NATIONS DEVELOPMENT PROGRAMME PROGRAMME OF ASSISTANCE TO THE UIN PALESTINIAN PEOPLE (UNDP/PAPP)
	PROJECT TITLE: CONSTRUCTION OF 100 HOUSING UNITS TO RE-HOUSE THE AFFECTED PALESTINIAN FAMILIES IN GAZA STRIP PROJECT NO.: PAL 10-00070416 (PACKAGE 07)
	CONSULTANT: مرکزالسند سقوالتخطیط center for engineering and planning
	BUILDING NAME: RESIDENTIAL BUILDING NO. (A8)
	DRAWING TITLE: COLUMNS DETAILS (2/4)
TAILS (1/3) DALE: AS SHOWN	DRAWING NO.: RE-S-008 DATE: APRIL 2011 SCALE: AS SHOWN

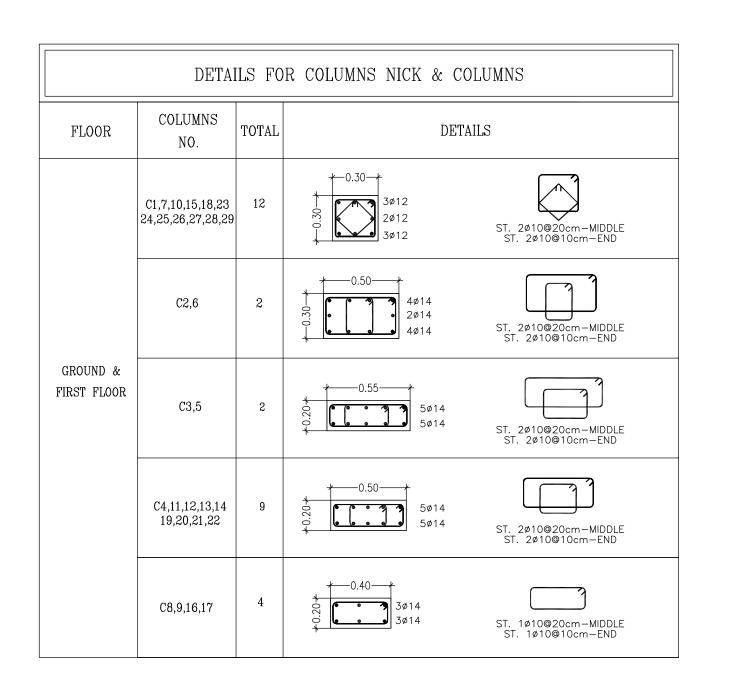


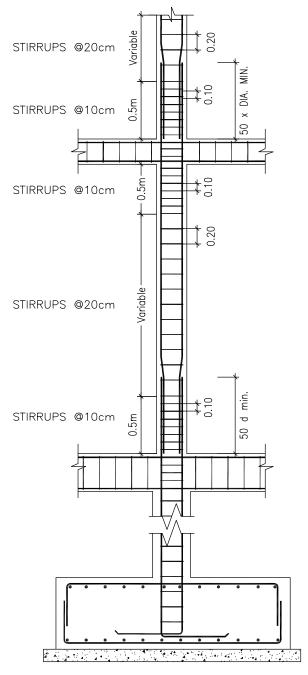


TYPICAL DETAILS FOR COLUMN STIRRUP SPACING NOT TO SCALE

COLUMNS DE

	NOTES :-
SLAB	 IT IS THE CONTRACTOR RESPONSIBILITY TO PREPARE AND SUBMIT WORKSHOP DRAWINGS FOR ENGINEER BEFORE START WORKS. ALL OF THE STRUCTURAL DRAWINGS ARE TO BE READ IN CONJUCTION WITH THE PERTINENT ARCHITECTURAL, CIVIL DEFENSE AND OTHER STRUCTURAL DRAWINGS IF THERE IS ANY DISCREPANCY IN DRAWINGS, THE CONTRACTOR MUST CONSIDER IT IN HIS PRICE. CONCRETE SURFACE IN CONTACT WITH SOIL SHALL BE PAINTED 1-COAT PRIMER AND 2-COATS OF HOT BITUMEN. DESIGN CODE IS ACI 318-08. STEEL BARS PROVIDED BY CONTRACTOR (G420) Fy=420 MPa. CONCRETE PROVIDED BY CONTRACTOR FOR COMPRESSIVE STRENGTH Fcu AS: -FOR R.C. COLUMNS & WALLS =35 MPa -FOR R.C. SLAB =30 MPa -FOR R.C. LINTELS =25 MPa -FOR R.C. LINTELS =20 MPa FOR R.C. LINTELS =20 MPa FOR ROOTINGS (CAST AGAINST SOIL) =7.5 cm (FOR PROTECTED CONCRET) =5.0 cm -FOR VALLS =5.0 cm -FOR VALLS =5.0 cm FOR VALLS =5.0 cm FOR SIZEL BARS STELL BAR = 60 cm OR 50 × DIA. BAR WHICH IS GREATER. TL. : TOTAL LENGTH. FOUNDATIONS & COLUMNS ARE DESIGNED FOR UNDERGROUND, GROUND, & 3 STORIES.
G. BEAM	- SOIL BEARING CAPACITY IS: 200 KN/m ² .
G. DEAM	CLIENT: PALESTINIAN NATIONAL AUTHORITY MINISTRY OF PUBLIC WORKS & HOUSING (MPWH)
FOUND.	EMPLOYER: THE UNITED NATIONS DEVELOPMENT PROGRAMME PROGRAMME OF ASSISTANCE TO THE PALESTINIAN PEOPLE UNDP/PAPP)
	PROJECT TITLE: CONSTRUCTION OF 100 HOUSING UNITS TO RE-HOUSE THE AFFECTED PALESTINIAN FAMILIES IN GAZA STRIP PROJECT NO.: PAL 10-00070416 (PACKAGE 07)
	CONSULTANT: الخطيط الخطيط والتخطيط center for engineering and planning
	BUILDING NAME: RESIDENTIAL BUILDING NO. (A8)
	DRAWING TITLE: COLUMNS DETAILS (3/4)
DETAILS (2/3) SCALE: AS SHOWN	DRAWING NO.: RE-S-009 DATE: APRIL 2011 SCALE: AS SHOWN

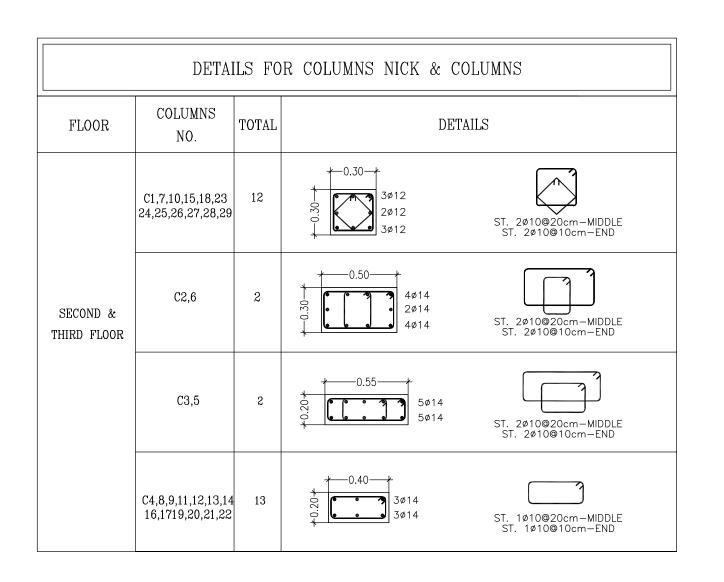


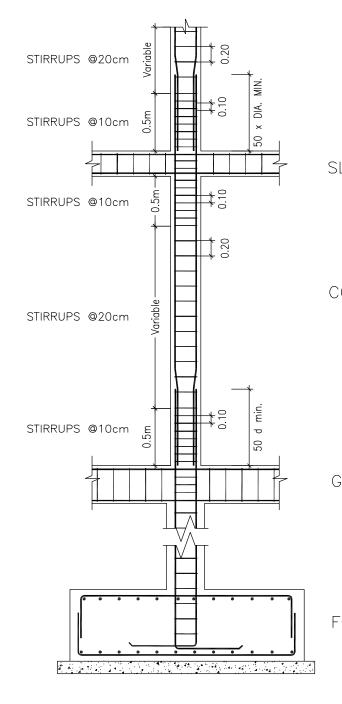

TYPICAL DETAILS FORCOLUMN STIRRUP SPACINGNOT TO SCALE


COLUMNS DE


	<u>NOTES :-</u>
LAB	 IT IS THE CONTRACTOR RESPONSIBILITY TO PREPARE AND SUBMIT WORKSHOP DRAWINGS FOR ENGINEER BEFORE START WORKS. ALL OF THE STRUCTURAL DRAWINGS ARE TO BE READ IN CONJUCTION WITH THE PERTINENT ARCHITECTURAL, CIVIL DEFENSE AND OTHER STRUCTURAL DRAWINGS IF THERE IS ANY DISCREPANCY IN DRAWINGS, THE CONTRACTOR MUST CONSIDER IT IN HIS PRICE. CONCRETE SURFACE IN CONTACT WITH SOIL SHALL BE PAINTED 1-COAT PRIMER AND 2-COATS OF HOT BITUMEN. DESIGN CODE IS ACI 318-08. STEEL BARS PROVIDED BY CONTRACTOR (G420) Fy=420 MPa. CONCRETE PROVIDED BY CONTRACTOR FOR COMPRESSIVE STRENGTH Fcu AS: -FOR R.C. COLUMNS & WALLS =35 MPa -FOR R.C. FOOTINGS = 30 MPa -FOR R.C. LINTELS = 25 MPa -FOR R.C. LINTELS = 20 MPa STEEL COVERS: -FOR FOOTINGS (CAST AGAINST SOIL) =7.5 cm
OLUMN	 (FOR PROTECTED CONCRETE) =5.0 cm FOR COLUMNS AND BEAMS =4.0 cm FOR WALLS =5.0 cm FOR SLABS =2.5 cm MIN. LAP FOR STEEL BAR = 60cm OR 50 × DIA. BAR WHICH IS GREATER. T.L. : TOTAL LENGTH. FOUNDATIONS & COLUMNS ARE DESIGNED FOR UNDERGROUND, CROUND, & 3 STORIES. SOIL BEARING CAPACITY IS: 200 KN/m².
G. BEAM	CLIENT: PALESTINIAN NATIONAL AUTHORITY MINISTRY OF PUBLIC WORKS & HOUSING (MPWH)
OUND.	EMPLOYER: THE UNITED NATIONS DEVELOPMENT PROGRAMME PROGRAMME OF ASSISTANCE TO THE PALESTINIAN PEOPLE DP (UNDP/PAPP)
	PROJECT TITLE: CONSTRUCTION OF 100 HOUSING UNITS TO RE-HOUSE THE AFFECTED PALESTINIAN FAMILIES IN GAZA STRIP PROJECT NO.: PAL 10-00070416 (PACKAGE 07)
	CONSULTANT: مرکزا لسند سط والتخطیط center for engineering and planning
	BUILDING NAME: RESIDENTIAL BUILDING NO. (A8)
	DRAWING TITLE: COLUMNS DETAILS (4/4)
TAILS (3/3)	DRAWING NO.: RE-S-010
CALE: AS SHOWN	DATE: APRIL 2011 SCALE: AS SHOWN

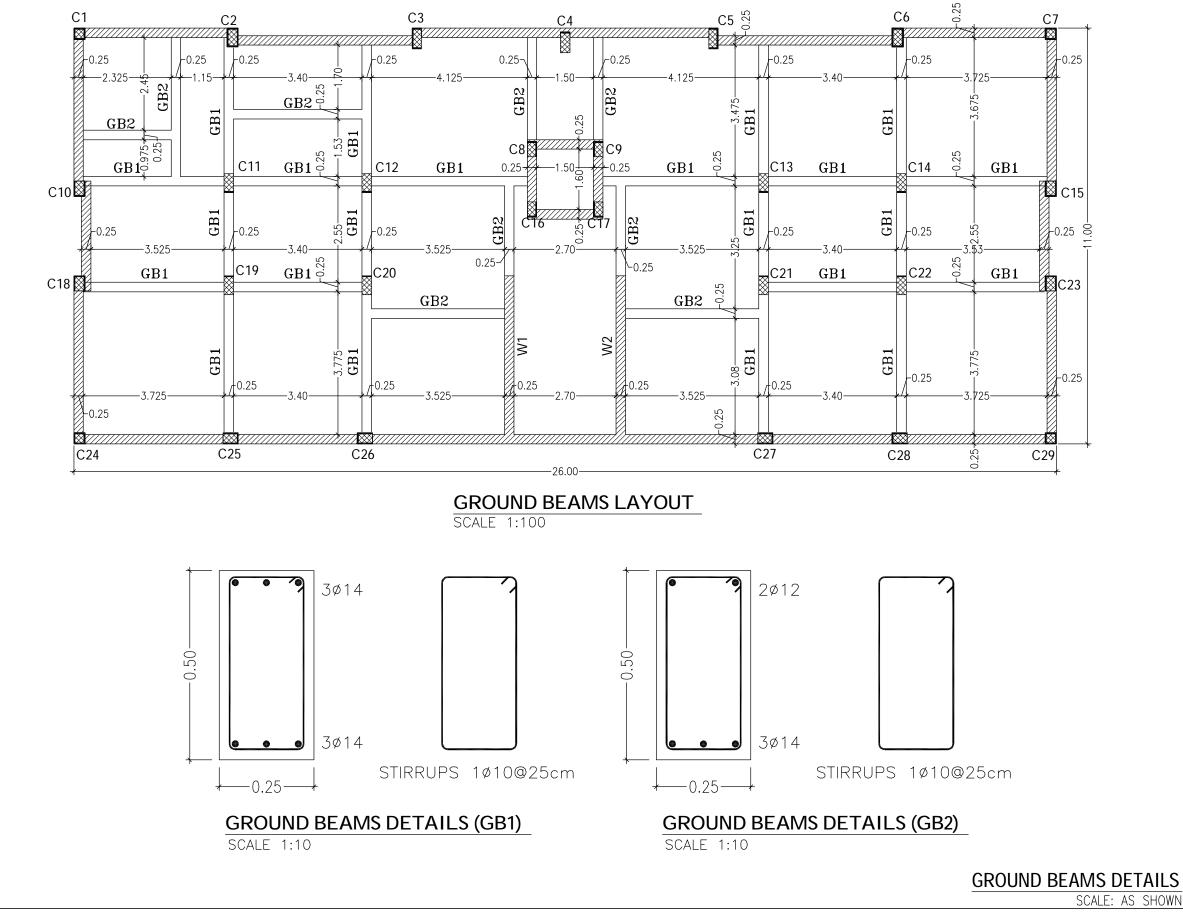


NOTES :-

 IT IS THE CONTRACTOR RESPONSIBILITY TO PREPARE AND SUBMIT WORKSHOP DRAWINGS FOR ENGINEER BEFORE START WORKS. ALL OF THE STRUCTURAL DRAWINGS ARE TO BE READ IN CONJUCTION WITH THE PERTINENT ARCHITECTURAL, CIVIL DEFENSE AND OTHER STRUCTURAL DRAWINGS IF THERE IS ANY DISCREPANCY IN DRAWINGS, THE CONTRACTOR MUST CONSIDER IT IN HIS PRICE. CONCRETE SURFACE IN CONTACT WITH SOIL SHALL BE PAINTED 1-COAT PRIMER AND 2-COATS OF HOT BITUMEN. DESIGN CODE IS ACI 318-08. STEEL BARS PROVIDED BY CONTRACTOR (G420) Fy=420 MPa. CONCRETE PROVIDED BY CONTRACTOR FOR COMPRESSIVE STRENGTH Fcu AS: -FOR R.C. COLUMNS & WALLS =35 MPa -FOR R.C. SLAB =30 MPa -FOR R.C. LINTELS =25 MPa -FOR R.C. LINTELS =25 MPa -FOR PLAIN CONCRET =20 MPa STEEL COVERS: -FOR FOOTINGS (CAST AGAINST SOIL) =7.5 cm (FOR PROTECTED CONCRETE) =5.0 cm -FOR WALLS =5.0 cm -FOR WALLS =2.5 cm MIN. LAP FOR STEEL BAR = 60cm OR 50 × DIA. BAR WHICH IS GREATER. T.L. : TOTAL LENGTH. FOUNDATIONS & COLUMNS ARE DESIGNED FOR DINDATIONS & COLUMNS ARE DESIGNED FOR DINDATIONS & COLUMNS ARE DESIGNED
- SOIL BEARING CAPACITY IS: 200 KN/m ² .
FOR TENDER ONLY
FOR TENDER ONLY
FOR TENDER ONLY
CLIENT: PALESTINIAN NATIONAL AUTHORITY
CLIENT: PALESTINIAN NATIONAL AUTHORITY MINISTRY OF PUBLIC WORKS & HOUSING (MPWH) EMPLOYER: THE UNITED NATIONS DEVELOPMENT PROGRAMME PROGRAMME OF ASSISTANCE TO THE PALESTINIAN PEOPLE
CLIENT: PALESTINIAN NATIONAL AUTHORITY MINISTRY OF PUBLIC WORKS & HOUSING (MPWH) EMPLOYER: THE UNITED NATIONS DEVELOPMENT PROGRAMME PROGRAMME OF ASSISTANCE TO THE PROGRAMME OF ASSISTANCE TO THE PALESTINIAN PEOPLE UN PALESTINIAN PEOPLE (UNDP/PAPP) PROJECT TITLE: CONSTRUCTION OF 100 HOUSING UNITS TO RE-HOUSE THE AFFECTED PALESTINIAN FAMILIES IN GAZA STRIP
CLIENT: PALESTINIAN NATIONAL AUTHORITY MINISTRY OF PUBLIC WORKS & HOUSING (MPWH) EMPLOYER: PROGRAMME OF ASSISTANCE TO THE PROGRAMME OF ASSISTANCE TO THE UN PALESTINIAN PEOPLE DF (UNDP/PAPP) PROJECT TITLE: CONSTRUCTION OF 100 HOUSING UNITS TO RE-HOUSE THE AFFECTED PALESTINIAN FAMILIES IN GAZA STRIP PROJECT NO.: PAL 10-00070416 (PACKAGE 07) CONSULTANT: LL-111 g a u
CLIENT: PALESTINIAN NATIONAL AUTHORITY MINISTRY OF PUBLIC WORKS & HOUSING (MPWH) EMPLOYER: PROGRAMME OF ASSISTANCE TO THE PROJECT TITLE: CONSTRUCTION OF 100 HOUSING UNITS TO RE-HOUSE THE AFFECTED PALESTINIAN FAMILIES IN GAZA STRIP PROJECT NO.: PAL 10-00070416 (PACKAGE 07) CONSULTANT: LELII B & LELII B &
CLIENT: PALESTINIAN NATIONAL AUTHORITY MINISTRY OF PUBLIC WORKS & HOUSING (MPWH) EMPLOYER: PROGRAMME OF ASSISTANCE TO THE PROGRAMME OF ASSISTANCE TO THE UN PALESTINIAN PEOPLE DF (UNDP/PAPP) PROJECT TITLE: CONSTRUCTION OF 100 HOUSING UNITS TO RE-HOUSE THE AFFECTED PALESTINIAN FAMILIES IN GAZA STRIP PROJECT NO.: PAL 10-00070416 (PACKAGE 07) CONSULTANT: LL-111 g a u
CLIENT: PALESTINIAN NATIONAL AUTHORITY MINISTRY OF PUBLIC WORKS & HOUSING (MPWH) EMPLOYER: PROGRAMME OF ASSISTANCE TO THE PROGRAMME OF ASSISTANCE TO THE PROJECT TITLE: CONSTRUCTION OF 100 HOUSING UNITS TO RE-HOUSE THE AFFECTED PALESTINIAN FAMILIES IN GAZA STRIP PROJECT NO.: PAL 10-00070416 (PACKAGE 07) CONSULTANT: LILLING BALL BUILDING NO. (A8) DRAWING TITLE:

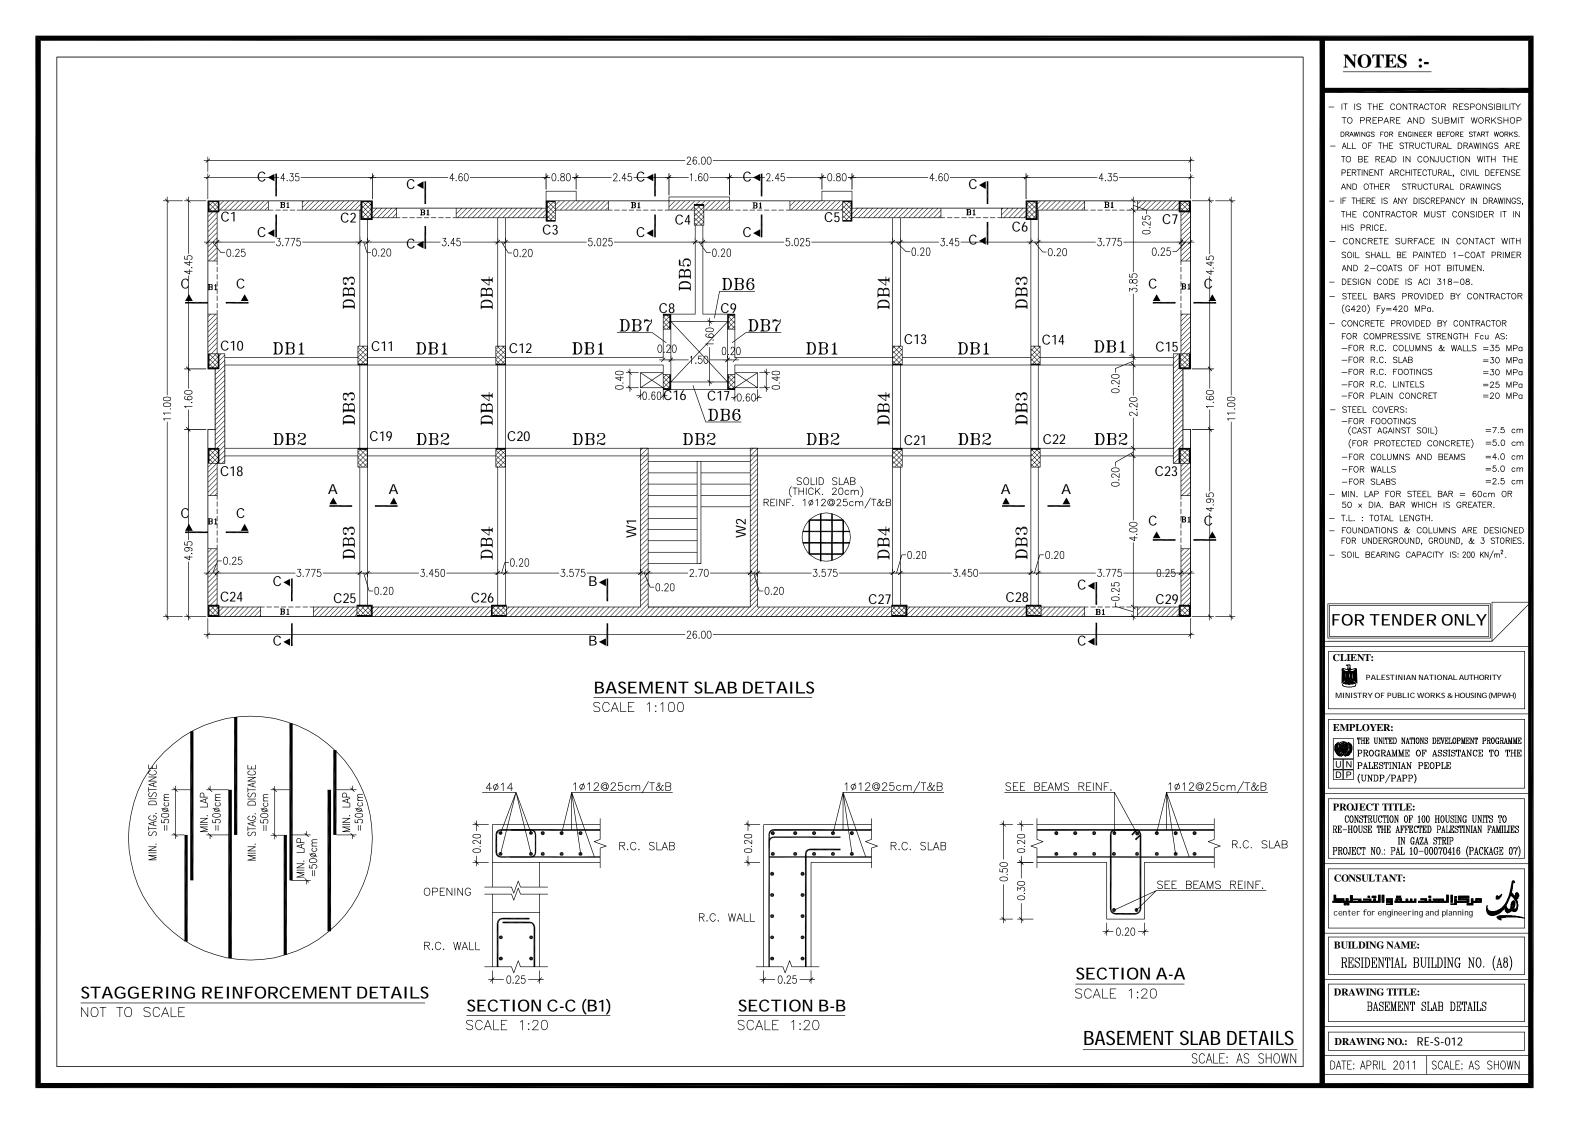

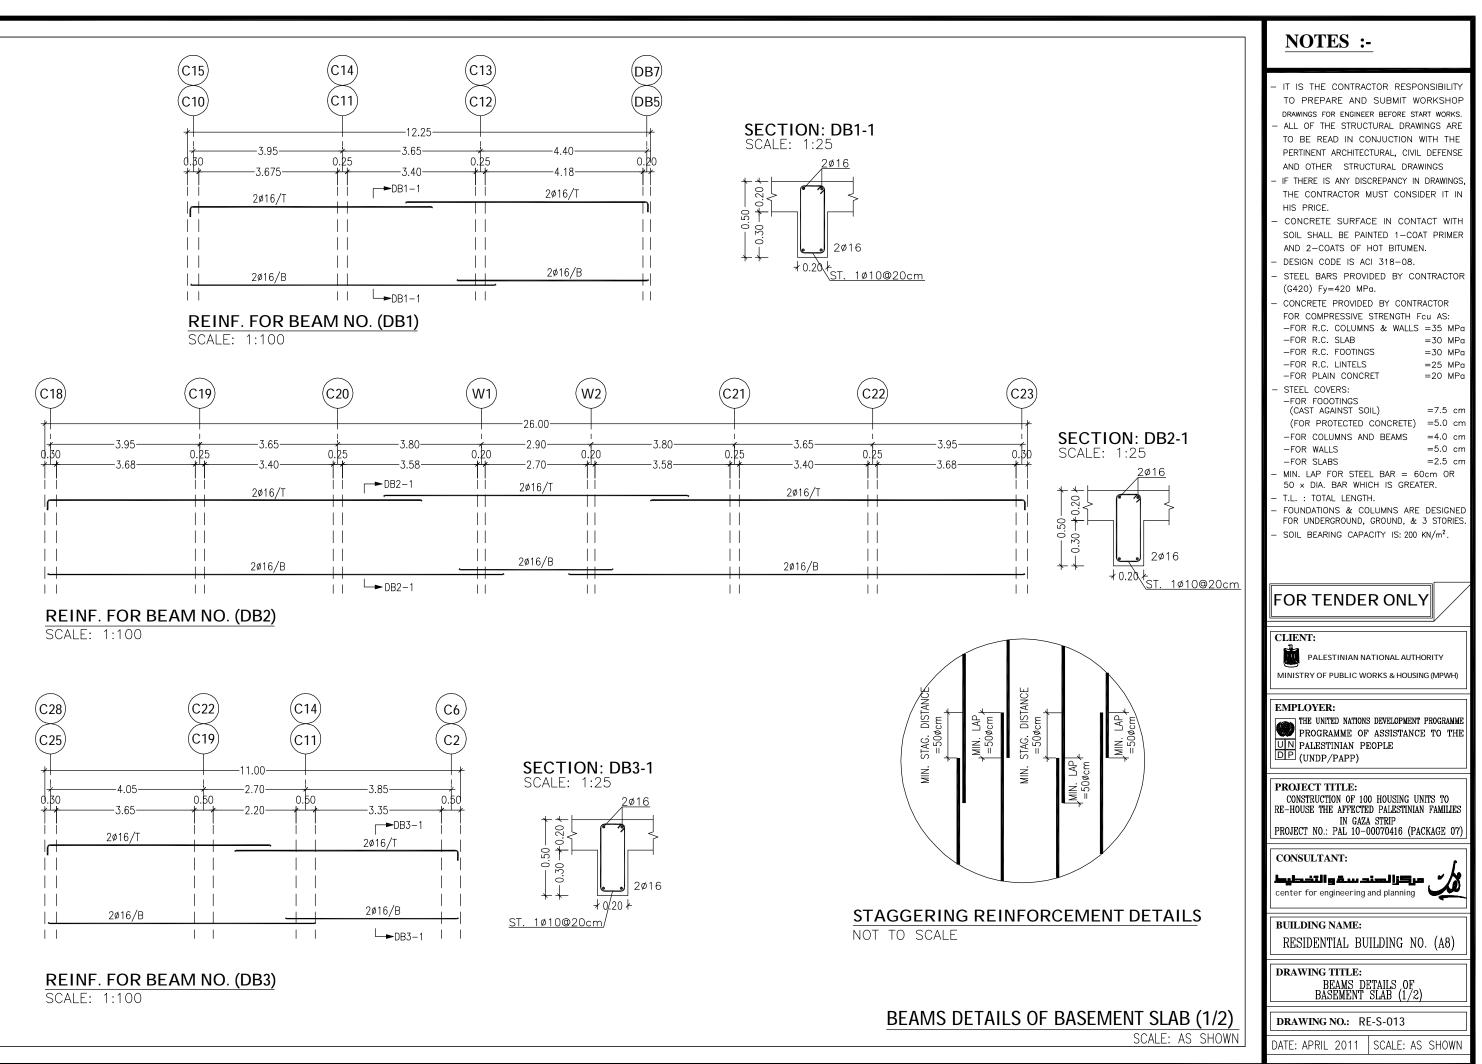

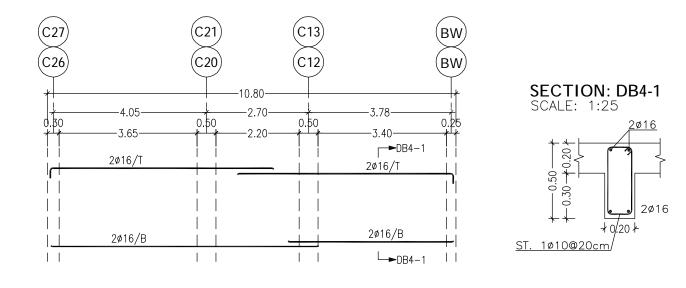

REINF. FOR BEAM NO. (DB4) SCALE: 1:100

BEAMS REINFORCEMENT TABLE FOR GROUND SLAB


NO.	DIM		BOTTOM	ТОР	STIRRUPS
	<i>W</i> .	Н.	REINF.	REINF.	
DB5	20	50	2ø16	2ø16	1ø10/20cm
DB6	20	50	2ø16	2ø16	1ø10/20cm
DB7	20	50	2ø16	2ø16	1ø10/20cm

BEAMS DETAILS OF BASEMENT SLAB (2)

NOTES .


 IT IS THE CONTRACTOR RESPONSIBILITY TO PREPARE AND SUBMIT WORKSHOP DRAWINGS FOR ENGINEER BEFORE START WORKS. ALL OF THE STRUCTURAL DRAWINGS ARE TO BE READ IN CONJUCTION WITH THE PERTINENT ARCHITECTURAL DRAWINGS, THE CONTRACTOR MUST CONSIDER IT IN HIS PRICE. CONCRETE SURFACE IN CONTACT WITH SOIL SHALL BE PAINTED 1-COAT PRIMER AND 2-COATS OF HOT BITUMEN. DESIGN CODE IS ACI 318-08. STEEL BARS PROVIDED BY CONTRACTOR (G420) Fy=420 MPa. CONCRETE PROVIDED BY CONTRACTOR FOR COMPRESSIVE STRENCTH FCU AS: -FOR R.C. COLUMNS & WALLS = 35 MPG -FOR R.C. COLUMNS AND BEAMS = 4.0 cm -FOR RCL INTELS = 25 MPG -FOR R.C. COLUMNS AND BEAMS = 4.0 cm -FOR RCL INTELS = 25.0 mm -FOR COLUMNS AND BEAMS = 4.0 cm -FOR SLABS COLUMNS AND BEAMS = 4.0 cm -FOR SLABS SEED CONCRETE = 2.0 mm -FOR COLUMNS AND BEAMS = 4.0 cm -FOR SLABS SEED COLUMNS ARE DESIGNED FOR UNDERGROUND, GROUND, & 3 STORES. SOIL BEARING CAPACITY IS: 200 KN/m². FORT ENDER ONLY ENDECT TITLE: MELL TOTAL LENGTH. THE UNTER NATIONS DEVELOPMENT PROGRAME PROGRAMME OF ASSISTANCE TO THE PROJECT NO: PALL ID-00070416 (PACKAGE 07) CONSULTANT: CONSULTANT: CONSULTANT: CONSULTANT: DRIECT TITLE: DRIECT TITLE: DRIECT TITLE: DRIECT TITLE: DRIECT TITLE: DRIECT TITLE: DRADENT		<u>NOTES :-</u>
- SOIL BEARING CAPACITY IS: 200 KN/m ² . FOR TENDER ONLY CLIENT: PALESTINIAN NATIONAL AUTHORITY MINISTRY OF PUBLIC WORKS & HOUSING (MPWH) EMPLOYER: THE UNITED NATIONS DEVELOPMENT PROGRAMME PROGRAMME OF ASSISTANCE TO THE PROJECT TITLE: CONSTRUCTION OF 100 HOUSING UNITS TO RE-HOUSE THE AFFECTED PALESTINIAN FAMILIES IN GAZA STRIP PROJECT NO.: PAL 10-00070416 (PACKAGE 07) CONSULTANT: LICE-STID B CONSULTANT: IN GAZA STRIP PROJECT NO.: PAL 10-00070416 (PACKAGE 07) CONSULTANT: LICE-SIDENTIAL BUILDING NO. (A8) BUILDING NAME: RESIDENTIAL BUILDING NO. (A8) DRAWING TITLE: BEAMS DETAILS OF BASEMENT SLAB (2/2) DRAWING NO.: RE-S-014		TO PREPARE AND SUBMIT WORKSHOP DRAWINGS FOR ENCINEER BEFORE START WORKS. ALL OF THE STRUCTURAL DRAWINGS ARE TO BE READ IN CONJUCTION WITH THE PERTINENT ARCHITECTURAL, CIVIL DEFENSE AND OTHER STRUCTURAL DRAWINGS IF THERE IS ANY DISCREPANCY IN DRAWINGS, THE CONTRACTOR MUST CONSIDER IT IN HIS PRICE. CONCRETE SURFACE IN CONTACT WITH SOIL SHALL BE PAINTED 1–COAT PRIMER AND 2–COATS OF HOT BITUMEN. DESIGN CODE IS ACI 318–08. STEEL BARS PROVIDED BY CONTRACTOR (G420) Fy=420 MPa. CONCRETE PROVIDED BY CONTRACTOR FOR COMPRESSIVE STRENGTH Fcu AS: –FOR R.C. COLUMNS & WALLS =35 MPa –FOR R.C. SLAB =30 MPa –FOR R.C. LINTELS =25 MPa –FOR R.C. LINTELS =25 MPa –FOR R.C. LINTELS =20 MPa –FOR R.C. LINTELS =20 MPa –FOR PLAIN CONCRET =20 MPa –FOR FOODTINGS (CAST AGAINST SOIL) =7.5 cm (FOR PROTECTED CONCRETE) =5.0 cm –FOR WALLS =5.0 cm –FOR WALLS =5.0 cm –FOR SLABS =2.5 cm MIN. LAP FOR STEEL BAR =60cm OR 50 × DIA. BAR WHICH IS GREATER. T.L. : TOTAL LENGTH. FOUNDATIONS & COLUMNS ARE DESIGNED
EMPLOYER: Image: Programme of Assistance to the Programme of Assistance to the UN PALESTINIAN PEOPLE Image: Project title: CONSTRUCTION OF 100 HOUSING UNITS TO RE-HOUSE THE AFFECTED PALESTINIAN FAMILIES IN GAZA STRIP PROJECT NO.: PAL 10-00070416 (PACKAGE 07) CONSULTANT: Image: Project for engineering and planning Center for engineering and planning BUILDING NAME: RESIDENTIAL BUILDING NO. (A8) DRAWING TITLE: BASEMENT SLAB (2/2) DRAWING NO.: RE-S-014		- SOIL BEARING CAPACITY IS: 200 KN/m ² . FOR TENDER ONLY CLIENT: PALESTINIAN NATIONAL AUTHORITY
CONSTRUCTION OF 100 HOUSING UNITS TO RE-HOUSE THE AFFECTED PALESTINIAN FAMILIES IN GAZA STRIP PROJECT NO.: PAL 10-00070416 (PACKAGE 07) CONSULTANT: Local Consultant: Center for engineering and planning Center for engineering and planning BUILDING NAME: RESIDENTIAL BUILDING NO. (A8) DRAWING TITLE: BEAMS DETAILS OF BASEMENT SLAB (2/2) DRAWING NO.: RE-S-014		EMPLOYER: THE UNITED NATIONS DEVELOPMENT PROGRAMME PROGRAMME OF ASSISTANCE TO THE UN PALESTINIAN PEOPLE
BUILDING NAME: RESIDENTIAL BUILDING NO. (A8) DRAWING TITLE: BEAMS DETAILS OF BASEMENT SLAB (2/2) DRAWING NO.: RE-S-014		CONSTRUCTION OF 100 HOUSING UNITS TO RE-HOUSE THE AFFECTED PALESTINIAN FAMILIES IN GAZA STRIP
2/2) RESIDENTIAL BUILDING NO. (A8) DRAWING TITLE: BEAMS DETAILS OF BASEMENT SLAB (2/2) DRAWING NO.: RE-S-014		🦽 🖌 مركزالهند سقوالتخطيط
2/2) BASEMENT SLAB (2/2) DRAWING NO.: RE-S-014		
DRAWING NO.: RE-S-014		
	2)/2)	DRAWING NO · RE-S-014
	HOWN	DATE: APRIL 2011 SCALE: AS SHOWN

SCALE: AS SH

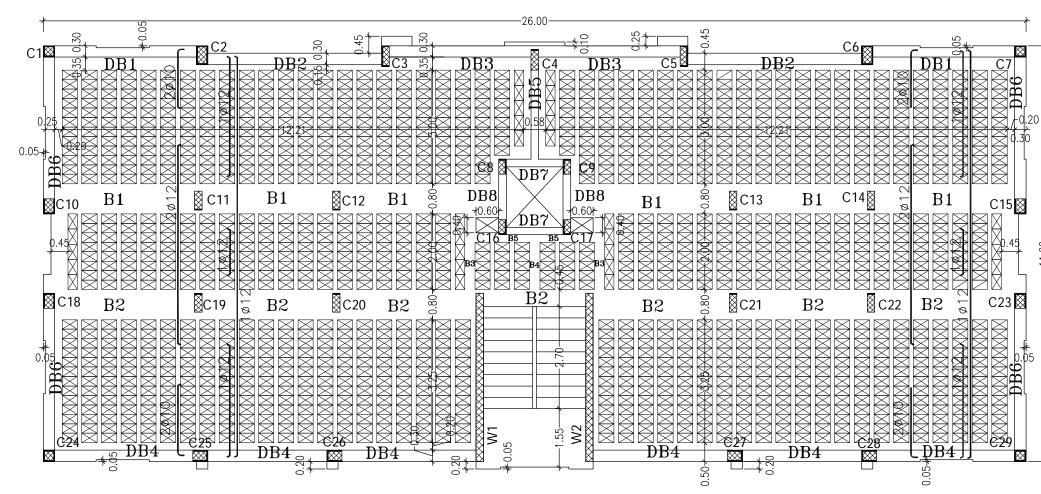


REINF. DETAILS FOR TYPICAL SLAB

SCALE 1:100

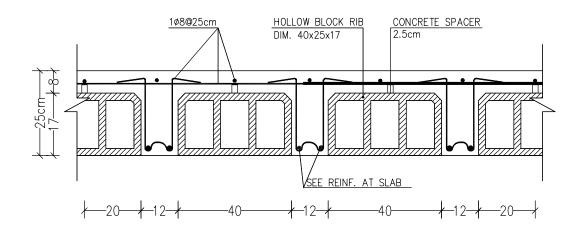



SECTION DETAIL FOR RIBS NOT TO SCALE

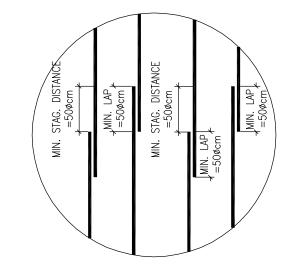


STAGGERING REINFORCEMENT DETAILS NOT TO SCALE


TYPICAL SLAB DETAILS

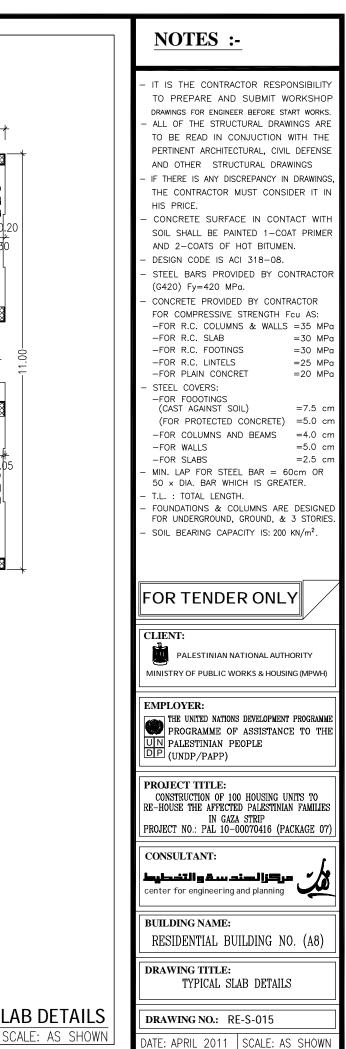

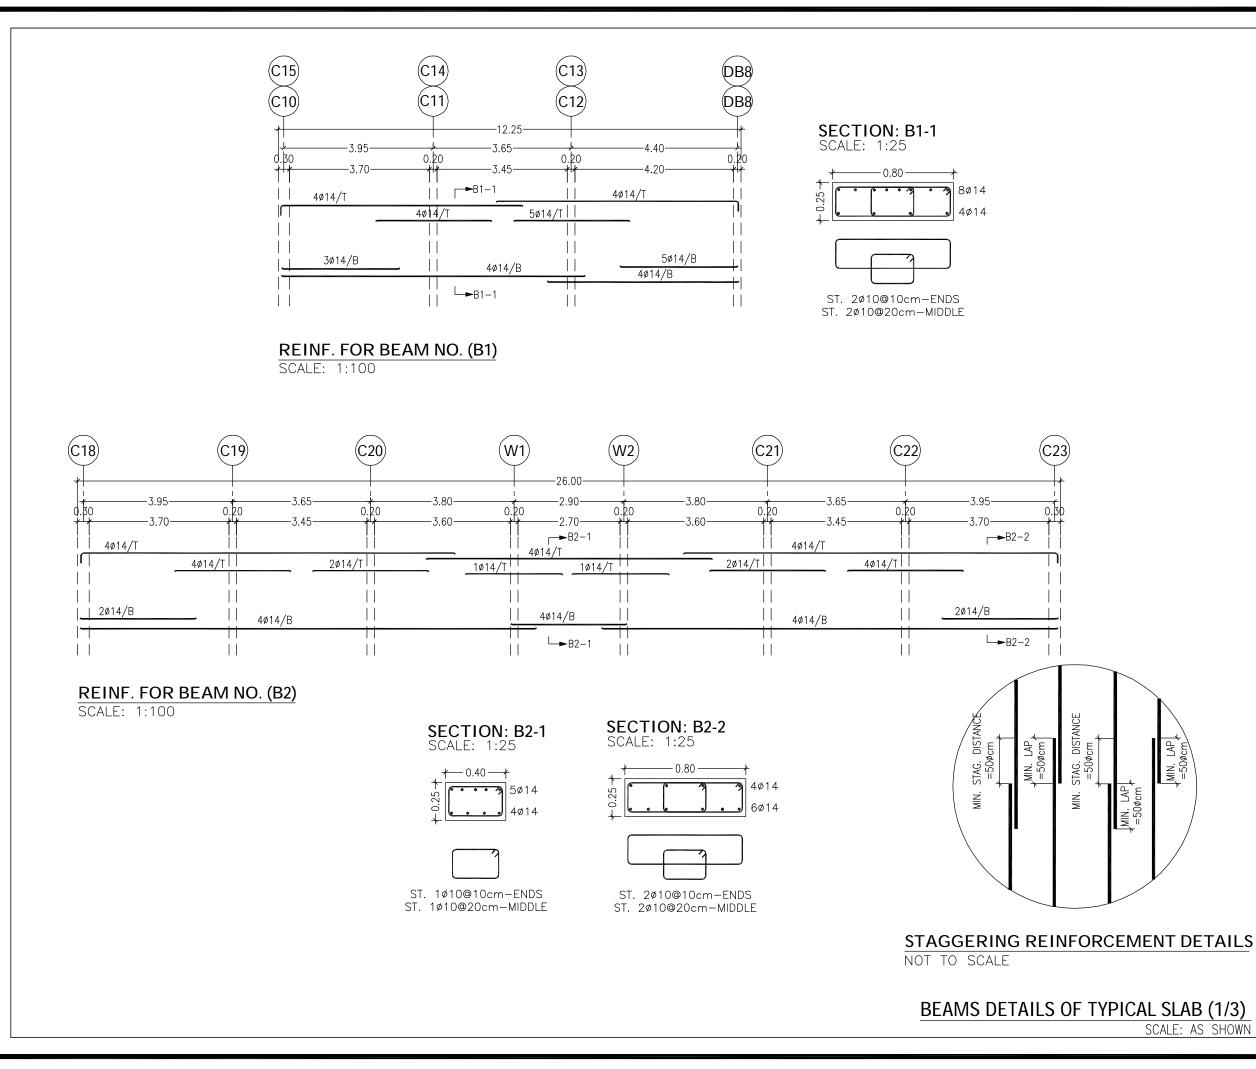


NOTES :-

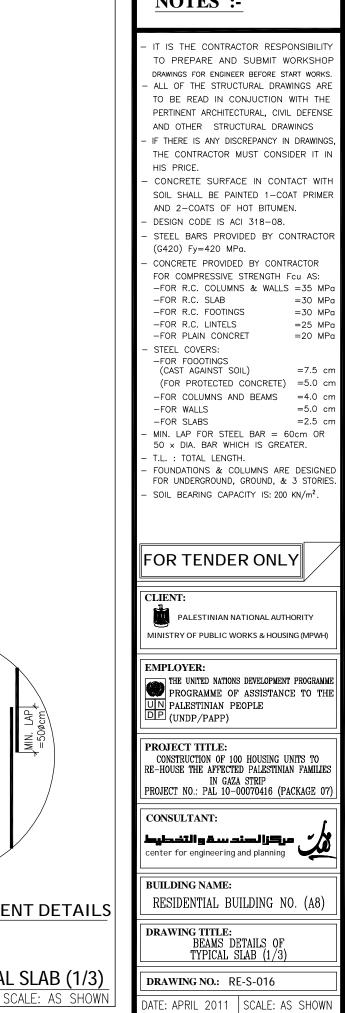


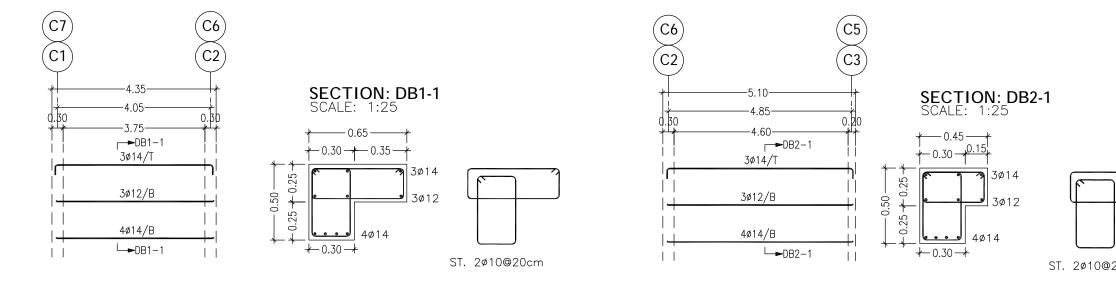

REINF. FOR BEAM NO. (DB1)

SCALE: 1:100

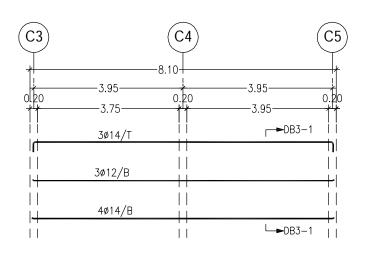

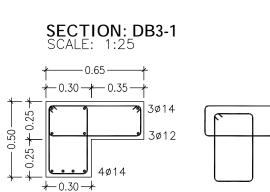

ST. 2ø10@20cm

SECTION: DB4-1 SCALE: 1:25

4ø14

3ø14

y 3ø12

ST. 2ø10@20cm

∤ 0.50 − **∤**

+ 0.30 + 0.20 +

+−0.30*-+*


0.25

- 0.50 -- 0.25 + 0

+ +

REINF. FOR BEAM NO. (DB3)

SCALE: 1:100

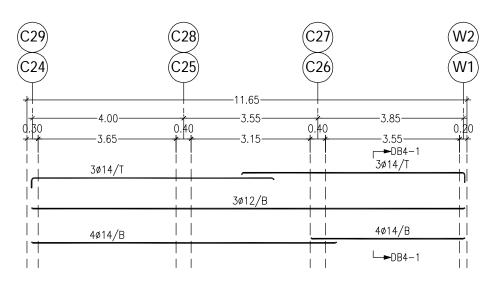

REINF. FOR BEAM NO. (DB4)


SCALE: 1:100

BEAMS DETAILS OF TYPICAL SI

SCAL

NOTES :-

2 0cm	 IT IS THE CONTRACTOR RESPONSIBILITY TO PREPARE AND SUBMIT WORKSHOP DRAWINGS FOR ENGINEER BEFORE START WORKS. ALL OF THE STRUCTURAL DRAWINGS ARE TO BE READ IN CONJUCTION WITH THE PERTINENT ARCHITECTURAL, CIVIL DEFENSE AND OTHER STRUCTURAL DRAWINGS IF THERE IS ANY DISCREPANCY IN DRAWINGS, THE CONTRACTOR MUST CONSIDER IT IN HIS PRICE. CONCRETE SURFACE IN CONTACT WITH SOIL SHALL BE PAINTED 1-COAT PRIMER AND 2-COATS OF HOT BITUMEN. DESIGN CODE IS ACI 318-08. STEEL BARS PROVIDED BY CONTRACTOR (G420) Fy=420 MPa. CONCRETE PROVIDED BY CONTRACTOR FOR COLUMNS & WALLS =35 MPa -FOR R.C. COLUMNS & WALLS =35 MPa -FOR R.C. COLUMNS & WALLS =35 MPa -FOR R.C. COLUMNS & WALLS =30 MPa -FOR R.C. LINTELS =25 MPa -FOR R.C. LINTELS =25 MPa -FOR R.C. LINTELS =25 MPa -FOR R.C. LINTELS =20 MPa STEEL COVERS: -FOR FOODTINGS (CAST AGAINST SOIL) =7.5 cm (FOR PROTECTED CONCRETE) =5.0 cm -FOR SLABS =4.0 cm -FOR SLABS =2.5 cm MIN. LAP FOR STEEL BAR = 60cm OR 50 × DIA. BAR WHICH IS GREATER. T.L. : TOTAL LENGTH. FOUNDATIONS & COLUMNS ARE DESIGNED FOR UNDERGROUND, GROUND, & 3 STORIES. SOIL BEARING CAPACITY IS: 200 KN/m².
	FOR TENDER ONLY
	EMPLOYER: THE UNITED NATIONS DEVELOPMENT PROGRAMME PROGRAMME OF ASSISTANCE TO THE UN PALESTINIAN PEOPLE DP (UNDP/PAPP)
	PROJECT TITLE: CONSTRUCTION OF 100 HOUSING UNITS TO RE-HOUSE THE AFFECTED PALESTINIAN FAMILIES IN GAZA STRIP PROJECT NO.: PAL 10-00070416 (PACKAGE 07)
	CONSULTANT: صركزا لصند سقو التخطيط center for engineering and planning
	BUILDING NAME: RESIDENTIAL BUILDING NO. (A8)
	DRAWING TITLE: BEAMS DETAILS OF TYPICAL SLAB (2/3)
LAB (2/3)	DRAWING NO.: RE-S-017
E: AS SHOWN	DATE: APRIL 2011 SCALE: AS SHOWN

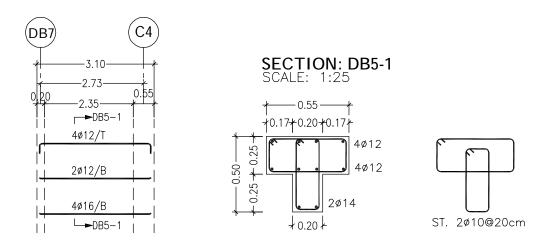

REINF. FOR BEAM NO. (DB5)

SCALE: 1:100


BEAMS REINFORCEMENT TABLE FOR TYPICAL SLAB


NO.	DI.	M	воттом	TOP	STIRRUPS
	<i>W</i> .	Н.	REINF.	REINF.	
DB6	30	50	4ø16	2ø12	1ø10/20cm
DB7	20	40	2ø14	2ø12	1ø10/20cm
DB8	20	40	2ø14	2ø12	1ø10/20cm
<i>B3</i>	25	25	2ø12	2ø12	1ø10/20cm
B4	25	25	2ø12	2ø12	1ø10/20cm
B5	20	25	2ø14	2ø12	1ø10/20cm


NOTEC

 IT IS THE CONTRACTOR RESPONSIBILITY TO PREPARE AND SUBMIT WORKSHOP DRAWINGS FOR ENGINEER BEFORE START WORKS. ALL OF THE STRUCTURAL DRAWINGS ARE TO BE READ IN CONJUCTION WITH THE PERTINENT ARCHITECTURAL, CALL DEFENSE AND OTHER STRUCTURAL DRAWINGS. IF THERE IS ANY DISCREPANCY IN DRAWINGS. IF THERE SARE SUBMED AND THE AND TH		<u>NOTES :-</u>
CLIENT: PALESTINIAN NATIONAL AUTHORITY MINISTRY OF PUBLIC WORKS & HOUSING (MPWH) EMPLOYER: THE UNITED NATIONS DEVELOPMENT PROGRAMME PROGRAMME OF ASSISTANCE TO THE PROJECT TITLE: CONSTRUCTION OF 100 HOUSING UNITS TO RE-HOUSE THE AFFECTED PALESTINIAN PAMILIES IN GAZA STRIP PROJECT NO.: PAL 10-00070416 (PACKAGE 07) CONSTULTANT: LEGENTIAL BUILDING (PACKAGE 07) CONSULTANT: LESTIDENTIAL BUILDING NO. (A8) BUILDING NAME: RESIDENTIAL BUILDING NO. (A8) DRAWING TITLE: BEAMS DETAILS OF TYPICAL SLAB (3/3) DRAWING NO.: RE-S-018		 TO PREPARE AND SUBMIT WORKSHOP DRAWINGS FOR ENGINEER BEFORE START WORKS. ALL OF THE STRUCTURAL DRAWINGS ARE TO BE READ IN CONJUCTION WITH THE PERTINENT ARCHITECTURAL, CIVIL DEFENSE AND OTHER STRUCTURAL DRAWINGS IF THERE IS ANY DISCREPANCY IN DRAWINGS, THE CONTRACTOR MUST CONSIDER IT IN HIS PRICE. CONCRETE SURFACE IN CONTACT WITH SOIL SHALL BE PAINTED 1-COAT PRIMER AND 2-COATS OF HOT BITUMEN. DESIGN CODE IS ACI 318-08. STEEL BARS PROVIDED BY CONTRACTOR (G420) Fy=420 MPa. CONCRETE PROVIDED BY CONTRACTOR FOR COMPRESSIVE STRENGTH Fcu AS: -FOR R.C. COLUMNS & WALLS =35 MPa -FOR R.C. SLAB =30 MPa -FOR R.C. SLAB =30 MPa -FOR R.C. LINTELS =25 MPa -FOR PLAIN CONCRET =20 MPa STEEL COVERS: -FOR FOODTINGS (CAST AGAINST SOIL) =7.5 cm (FOR PROTECTED CONCRETE) =5.0 cm -FOR WALLS =5.0 cm -FOR WALLS =5.0 cm MIN. LAP FOR STEEL BAR = 60cm OR S0 × DIA. BAR WHICH IS GREATER. T.L. : TOTAL LENGTH. FOUNDATIONS & COLUMNS ARE DESIGNED FOR UNDERGROUND, GROUND, & 3 STORIES.
S SHOWN		FOR TENDER ONLY CLIENT: PALESTINIAN NATIONAL AUTHORITY MINISTRY OF PUBLIC WORKS & HOUSING (MPWH) EMPLOYER: THE UNITED NATIONS DEVELOPMENT PROGRAMME PROGRAMME OF ASSISTANCE TO THE PROGRAMME OF ASSISTANCE TO THE PALESTINIAN PEOPLE (UNDP/PAPP) PROJECT TITLE: CONSTRUCTION OF 100 HOUSING UNITS TO RE-HOUSE THE AFFECTED PALESTINIAN FAMILIES IN GAZA STRIP PROJECT NO.: PAL 10-00070416 (PACKAGE 07) CONSULTANT: Labertill B & London Jing Consultant center for engineering and planning BUILDING NAME: RESIDENTIAL BUILDING NO. (A8) DRAWING TITLE: BEAMS DETAILS OF
	3 (3/3) As shown	DRAWING NO.: RE-S-018 DATE: APRIL 2011 SCALE: AS SHOWN

SCALE: A

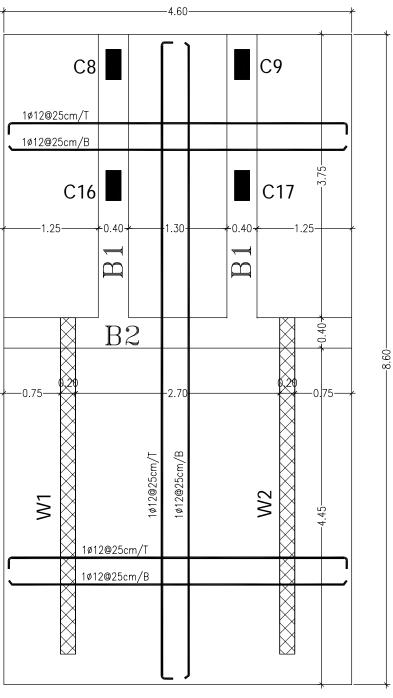

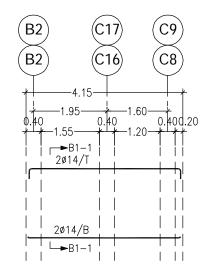


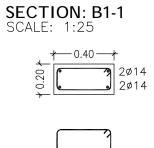


ST. 1ø10@7.5cm-ENDS ST. 1ø10@15cm-MIDDLE



SCALE: 1:100

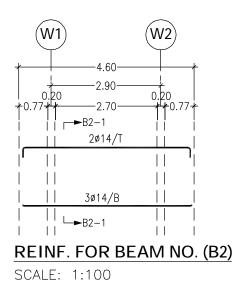



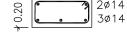

ST. 1ø10@7.5cm-ENDS ST. 1ø10@15cm-MIDDLE


STAIRS ROOF SLAB DETAILS SCALE 1:50

STAIRS ROOF SLAB DETAILS

NOTES :-


	 IT IS THE CONTRACTOR RESPONSIBILITY TO PREPARE AND SUBMIT WORKSHOP DRAWINGS FOR ENGINEER BEFORE START WORKS. ALL OF THE STRUCTURAL DRAWINGS ARE TO BE READ IN CONJUCTION WITH THE PERTINENT ARCHITECTURAL, CIVIL DEFENSE AND OTHER STRUCTURAL DRAWINGS. IF THERE IS ANY DISCREPANCY IN DRAWINGS, THE CONTRACTOR MUST CONSIDER IT IN HIS PRICE. CONCRETE SURFACE IN CONTACT WITH SOIL SHALL BE PAINTED 1-COAT PRIMER AND 2-COATS OF HOT BITUMEN. DESIGN CODE IS ACI 318-08. STEEL BARS PROVIDED BY CONTRACTOR (G420) Fy=420 MPa. CONCRETE PROVIDED BY CONTRACTOR FOR COMPRESSIVE STRENGTH FCU AS: -FOR R.C. COLUMNS & WALLS =35 MPa -FOR R.C. SLAB = 30 MPa -FOR R.C. SLAB = 30 MPa -FOR R.C. CONCRET = 20 MPa STEEL COVERS: -FOR FOROTINGS = 30 MPa -FOR R.C. LINTELS = 25 MPa -FOR R.C. JUNTELS = 25 MPa -FOR R.C. CONCRET = 20 MPa STEEL COVERS: -FOR FOROTINGS = 30 MPa -FOR R.C. LINTELS = 25 MPa -FOR R.C. SLAB = 30 MPa FOR PLAIN CONCRET = 20 MPa STEEL COVERS: -FOR FOROTINGS = 30 MPa FOR R.C. LINTELS = 25 MPa FOR PLAIN CONCRET = 20 MPa STEEL COVERS: -FOR FOROTINGS = 3.0 MPa FOR R.C. LINTELS = 2.5 Cm FOR COLUMNS AND BEAMS = 4.0 cm FOR SLABS = 2.5 cm MIN. LAP FOR STEEL BAR = 60cm OR 50 × DIA. BAR WHICH IS GREATER. T.L. : TOTAL LENGTH. FOUNDATIONS & COLUMNS ARE DESIGNED FOR UNDERGROUND, GROUND, & 3 STORIES.
	 SOIL BEARING CAPACITY IS: 200 KN/m².
	FOR TENDER ONLY
	CLIENT: PALESTINIAN NATIONAL AUTHORITY
	CLIENT: PALESTINIAN NATIONAL AUTHORITY MINISTRY OF PUBLIC WORKS & HOUSING (MPWH) EMPLOYER: THE UNITED NATIONS DEVELOPMENT PROGRAMME PROGRAMME OF ASSISTANCE TO THE PROGRAMME OF ASSISTANCE TO THE UIN PALESTINIAN PEOPLE UIN PALESTINIAN PEOPLE (UNDP/PAPP) PROJECT TITLE: CONSTRUCTION OF 100 HOUSING UNITS TO RE-HOUSE THE AFFECTED PALESTINIAN FAMILIES IN GAZA STRIP PROJECT NO.: PAL 10-00070416 (PACKAGE 07) CONSULTANT:
	CLIENT: PALESTINIAN NATIONAL AUTHORITY MINISTRY OF PUBLIC WORKS & HOUSING (MPWH) EMPLOYER: THE UNITED NATIONS DEVELOPMENT PROGRAMME PROGRAMME OF ASSISTANCE TO THE PROGRAMME OF ASSISTANCE TO THE UN PALESTINIAN PEOPLE (UNDP/PAPP) PROJECT TITLE: CONSTRUCTION OF 100 HOUSING UNITS TO RE-HOUSE THE AFFECTED PALESTINIAN FAMILIES IN GAZA STRIP PROJECT NO.: PAL 10-00070416 (PACKAGE 07)
	CLIENT: PALESTINIAN NATIONAL AUTHORITY MINISTRY OF PUBLIC WORKS & HOUSING (MPWH) EMPLOYER: THE UNITED NATIONS DEVELOPMENT PROGRAMME PROGRAMME OF ASSISTANCE TO THE PROJECT TITLE: (UNDP/PAPP) PROJECT TITLE: CONSTRUCTION OF 100 HOUSING UNITS TO RE-HOUSE THE AFFECTED PALESTINIAN FAMILIES IN GAZA STRIP PROJECT NO.: PAL 10-00070416 (PACKAGE 07) CONSULTANT: Laberting Ban simplicate center for engineering and planning BUILDING NAME:
S	CLIENT: PALESTINIAN NATIONAL AUTHORITY MINISTRY OF PUBLIC WORKS & HOUSING (MPWH) EMPLOYER: PROGRAMME OF ASSISTANCE TO THE PROGRAMME OF ASSISTANCE TO THE PROJECT TITLE: CONSTRUCTION OF 100 HOUSING UNITS TO RE-HOUSE THE AFFECTED PALESTINIAN FAMILIES IN GAZA STRIP PROJECT NO.: PAL 10-00070416 (PACKAGE 07) CONSULTANT: Labertill Bau simplify for center for engineering and planning BUILDING NAME: RESIDENTIAL BUILDING NO. (A8)

SCALE: AS SHOW

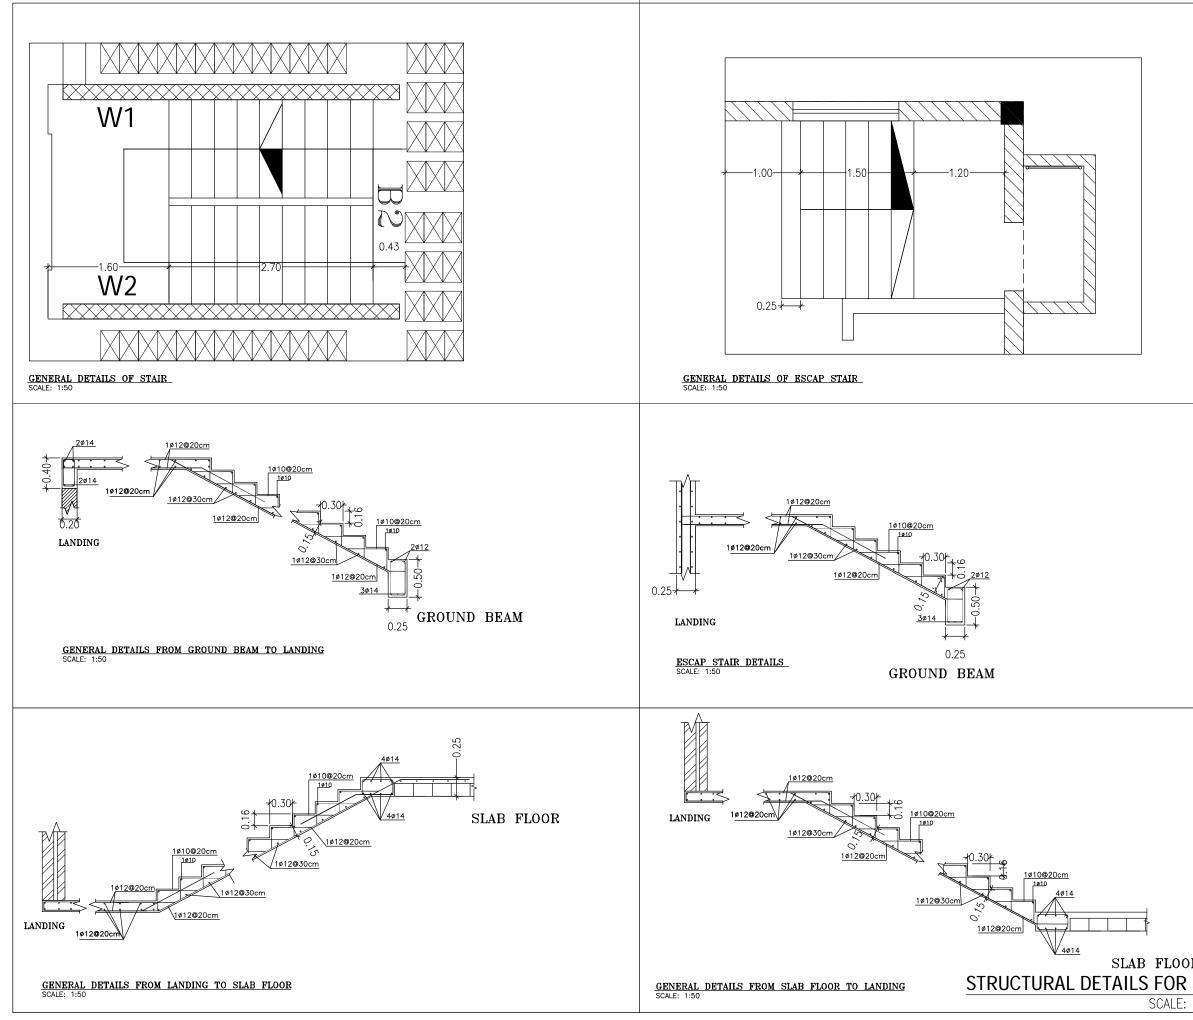

	NOTES :-
	 IT IS THE CONTRACTOR RESPONSIBILITY TO PREPARE AND SUBMIT WORKSHOP DRAWINGS FOR ENGINEER BEFORE START WORKS. ALL OF THE STRUCTURAL DRAWINGS ARE TO BE READ IN CONJUCTION WITH THE PERTINENT ARCHITECTURAL, CIVIL DEFENSE AND OTHER STRUCTURAL DRAWINGS IF THERE IS ANY DISCREPANCY IN DRAWINGS, THE CONTRACTOR MUST CONSIDER IT IN HIS PRICE. CONCRETE SURFACE IN CONTACT WITH SOIL SHALL BE PAINTED 1-COAT PRIMER AND 2-COATS OF HOT BITUMEN. DESIGN CODE IS ACI 318-08. STEEL BARS PROVIDED BY CONTRACTOR (G420) Fy=420 MPa. CONCRETE PROVIDED BY CONTRACTOR FOR COMPRESSIVE STRENGTH FCU AS: -FOR R.C. COLUMNS & WALLS =35 MPa -FOR R.C. SLAB =30 MPa -FOR R.C. SLAB =30 MPa -FOR R.C. LINTELS =25 MPa -FOR PLAIN CONCRET =20 MPa STEEL COVERS: -FOR FOOTINGS (CAST AGAINST SOIL) =7.5 cm (FOR PROTECTED CONCRETE) =5.0 cm -FOR SLABS =2.5 cm FOR SLABS =2.5 cm FOR SLABS =2.5 cm FOR SLABS =2.5 cm MIN. LAP FOR STEEL BAR = 60cm OR SO × DIA. BAR WHICH IS GREATER. T.L. : TOTAL LENSTH. FOUNDATIONS & COLUMNS ARE DESIGNED FOR UNDERGROUND, GROUND, & 3 STORIES. SOIL BEARING CAPACITY IS: 200 KN/m².
	FOR TENDER ONLY
	CLIENT: PALESTINIAN NATIONAL AUTHORITY MINISTRY OF PUBLIC WORKS & HOUSING (MPWH)
	EMPLOYER: THE UNITED NATIONS DEVELOPMENT PROGRAMME PROGRAMME OF ASSISTANCE TO THE UN PALESTINIAN PEOPLE DIP (UNDP/PAPP)
	PROJECT TITLE: CONSTRUCTION OF 100 HOUSING UNITS TO RE-HOUSE THE AFFECTED PALESTINIAN FAMILIES IN GAZA STRIP PROJECT NO.: PAL 10-00070416 (PACKAGE 07)
	CONSULTANT: مركزا لسند سقو التخطيط center for engineering and planning
	BUILDING NAME:
	RESIDENTIAL BUILDING NO. (A8)
R	DRAWING TITLE: STRUCTURAL DETAILS FOR STAIRS
STAIRS	DRAWING NO.: RE-S-020
AS SHOWN	DATE: APRIL 2011 SCALE: AS SHOWN

SCALE:

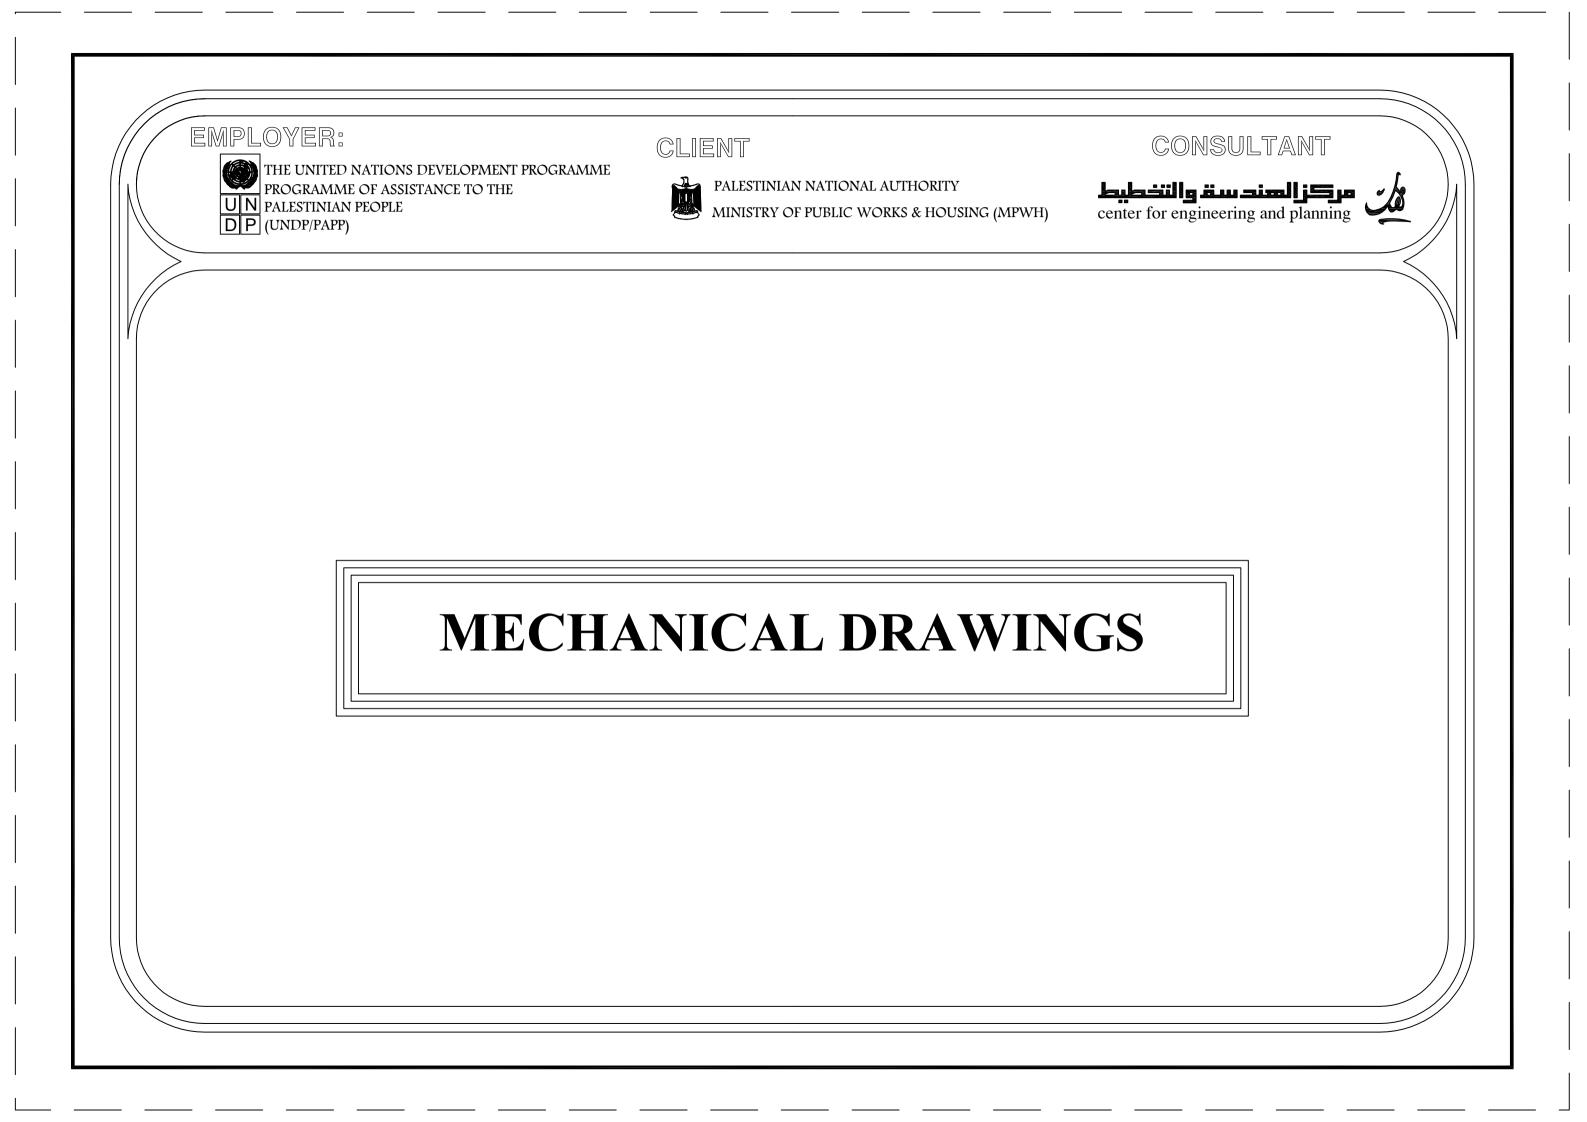

EMPLOYER:



THE UNITED NATIONS DEVELOPMENT PROGRAMME PROGRAMME OF ASSISTANCE TO THE **UN** PALESTINIAN PEOPLE

CLIENT




PALESTINIAN NATIONAL AUTHORITY MINISTRY OF PUBLIC WORKS & HOUS


MINISTRY OF PUBLIC WORKS & HOUSING (MPWH)

LIST OF DRAWINGS FOR PLUMBING

NO.	DRAWING NAME	DWG NO.
00	SANITARY NETWORK FOR HOUSING UNITS	RE-M-000
01	SEWER PIPE FOR THE BUILDING	RE-M-001
02	WATER NETWORK FOR UNDERGROUND FLOOR	RE-M-002
03	WATER NETWORK FOR GROUND FLOOR	RE-M-003
04	WATER NETWORK FOR TYPICAL FLOOR	RE-M-004
05	SANITARY NETWORK FOR UNDERGROUND FLOOR	RE-M-005
06	SANITARY NETWORK FOR GROUND FLOOR	RE-M-006


NO.	DRAWING NAME
07	SANITARY NETWORK FOR TYPICAL FLOOR
08	RAIN WATER FOR ROOF PLAN
09	WATER NETWORK FOR UNDERGROUND FLOOR
10	WATER NETWORK FORROOF FLOOR
11	WATER NETWORK FOR ROOF FLOOR
12	GENERAL DETAILS FOR MECHANICAL (1/2)
13	GENERAL DETAILS FOR MECHANICAL (2/2)

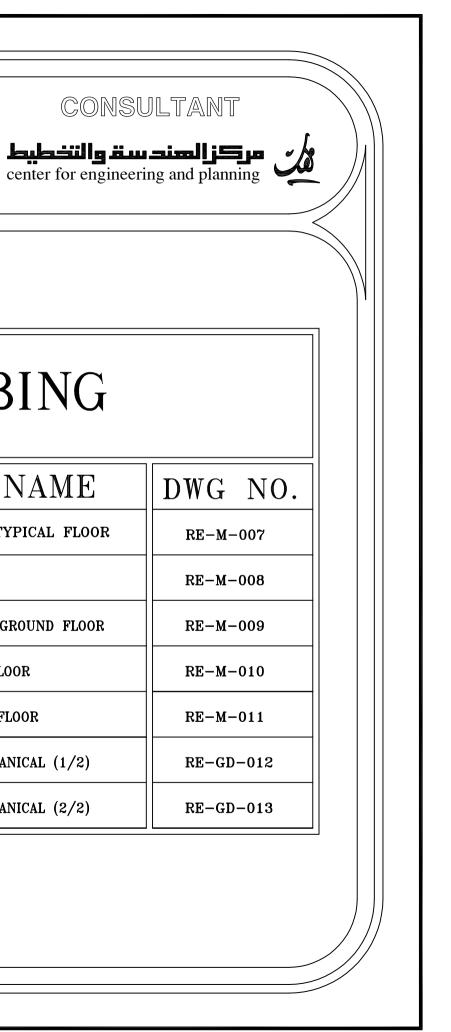


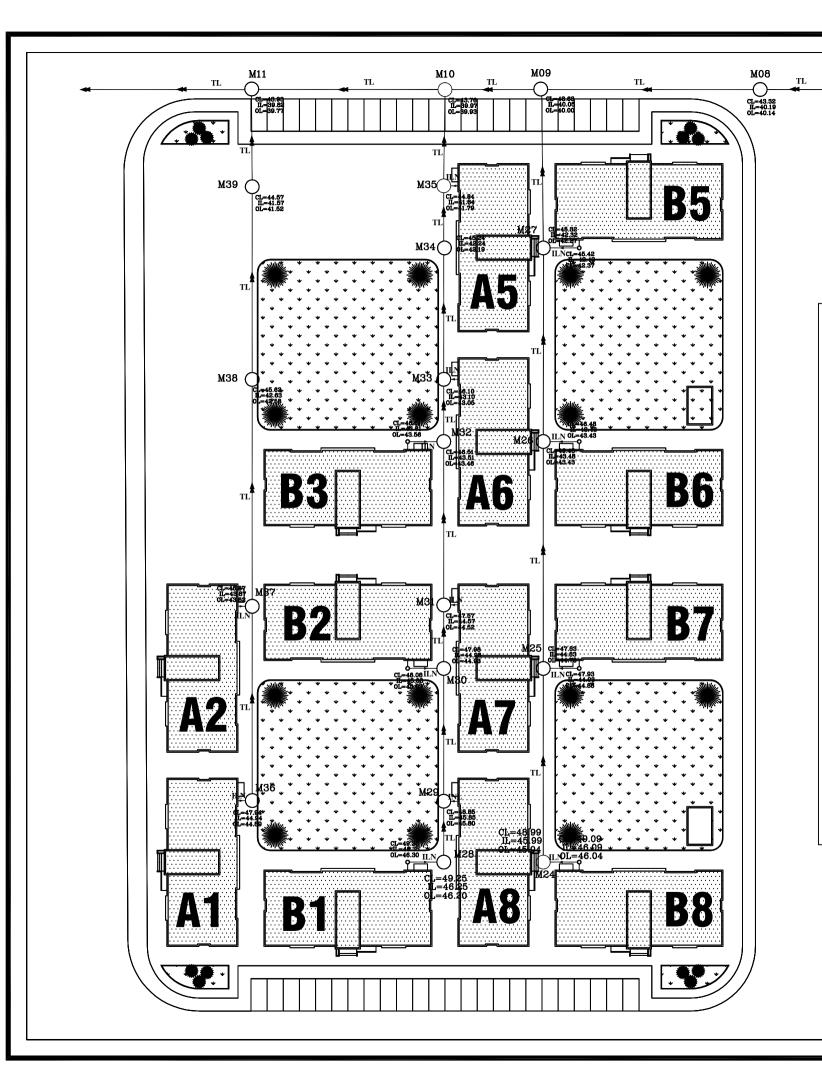



MANHOLES SCHEDULE


M.No.	COVER LEVEL	INVERT LEVEL	OUTLET LEVEL	DEPTH (m)
M08	43.32	40.19	40.14	3.13
M09	43.63	40.05	40.00	3.58
M10	43.76	39.97	39.93	3.79
M11	43.93	39.82	39.77	4.11
M24	48.99	45.99	45.94	3.00
M25	47.83	44.83	44.78	3.00
M26	46.48	43.48	43.43	3.00
M27	45.32	42.32	42.17	3.00
M28	49.25	46.25	46.20	3.00
M29	48.85	45.85	45.80	3.00
М30	47.98	44.98	44.93	3.00
M31	47.57	44.57	44.52	3.00
M32	46.51	43.51	43.46	3.00
М33	46.10	43.10	43.05	3.00
M34	45.24	42.24	42.19	3.00
M35	44.84	41.84	41.79	3.00
M36	47.94	44.94	44.89	3.00
M37	46.87	43.87	43.82	3.00
M38	45.63	42.63	42.58	3.00
M39	44.57	41.57	41.52	3.00

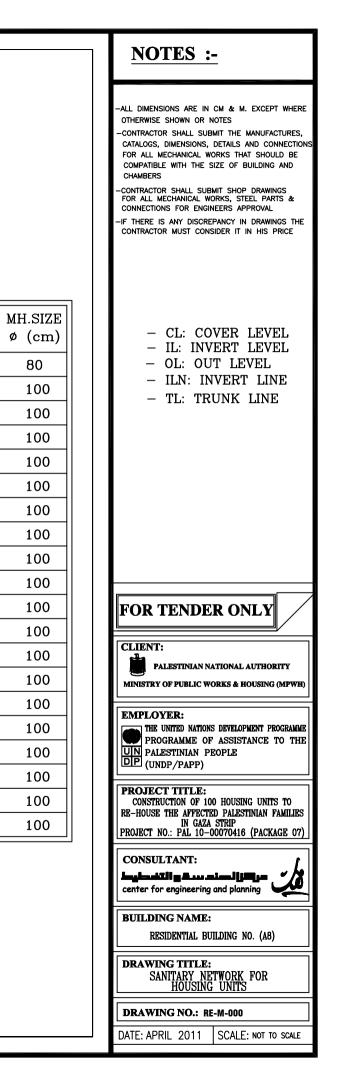


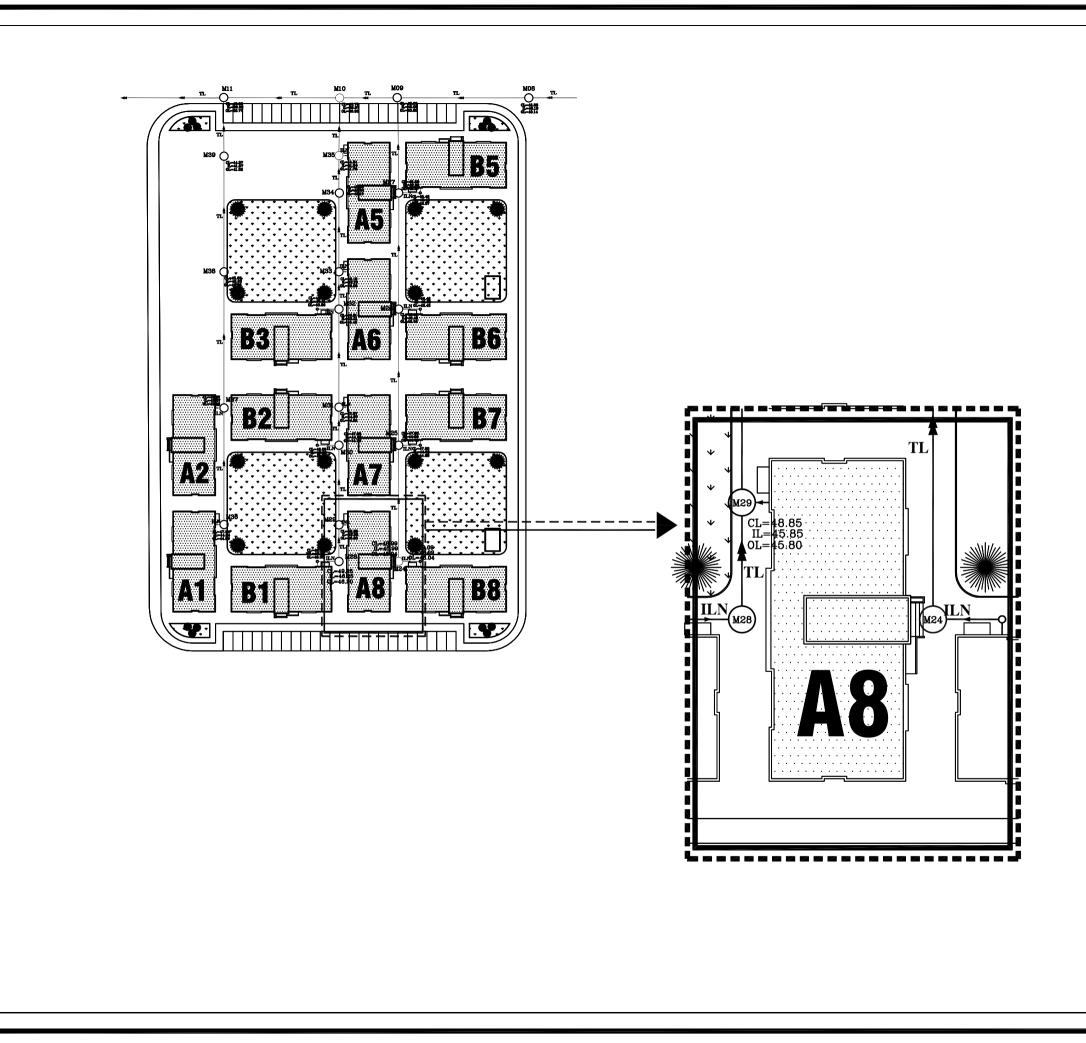


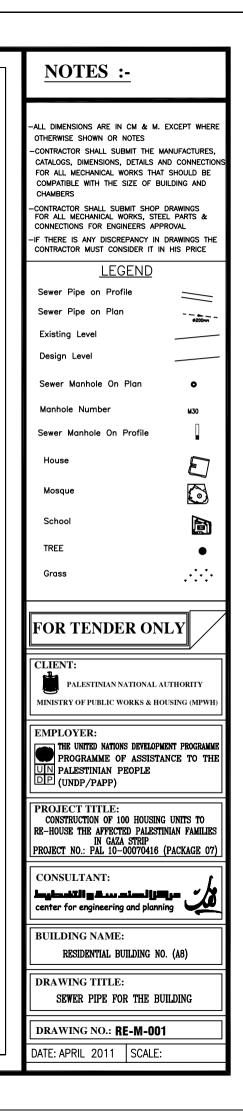


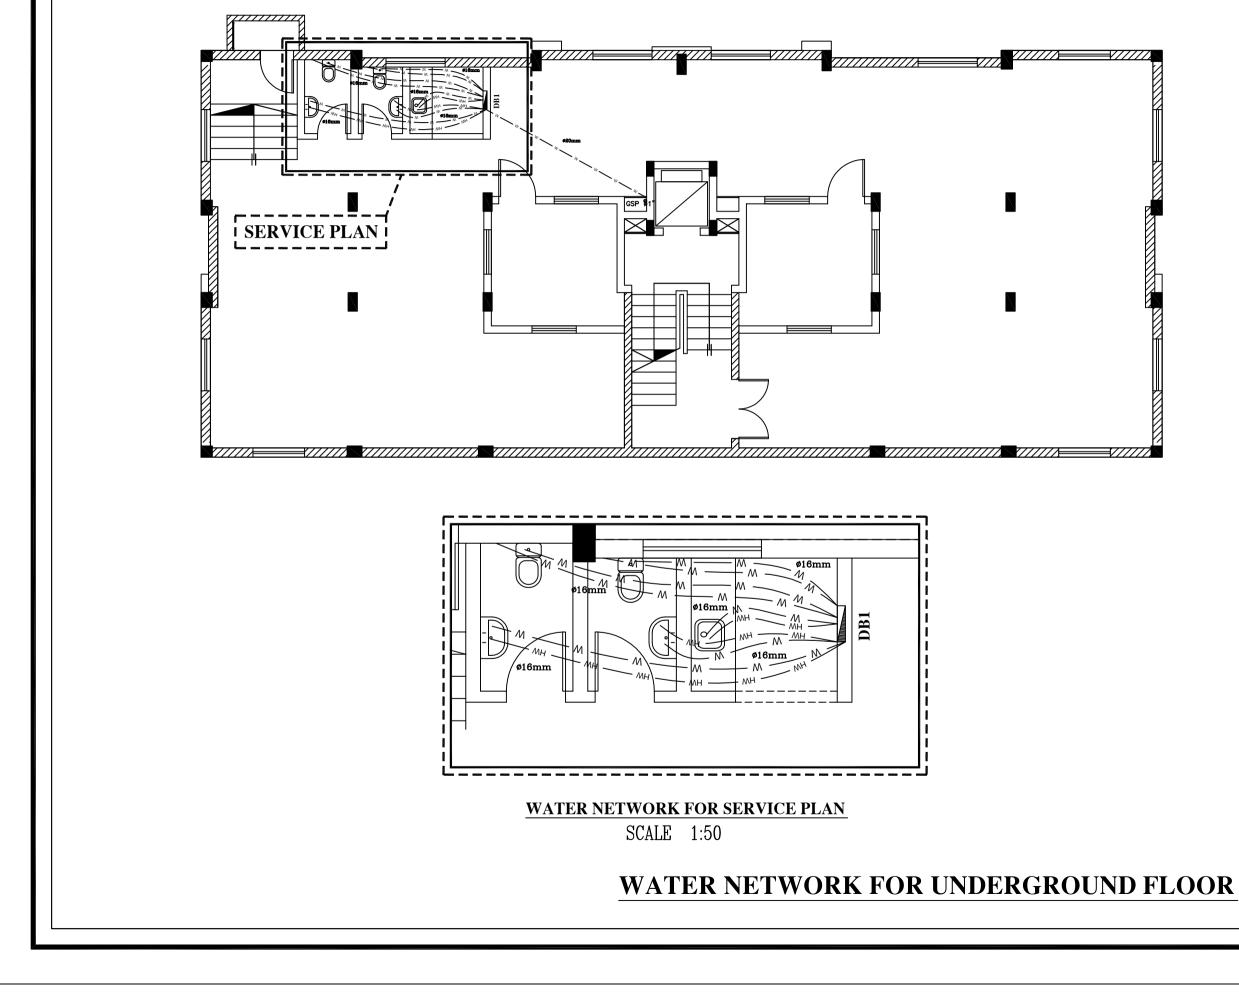


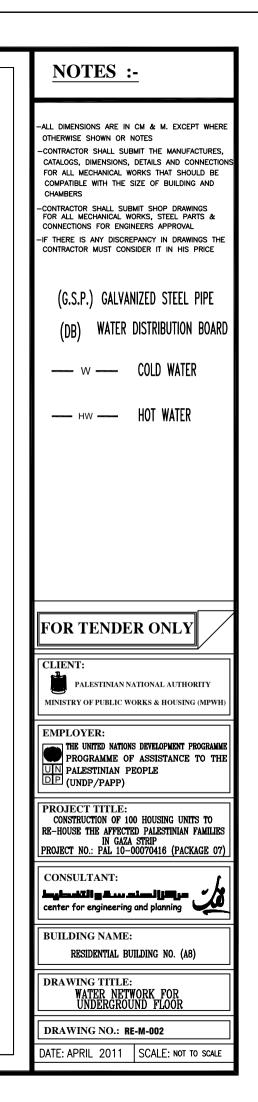


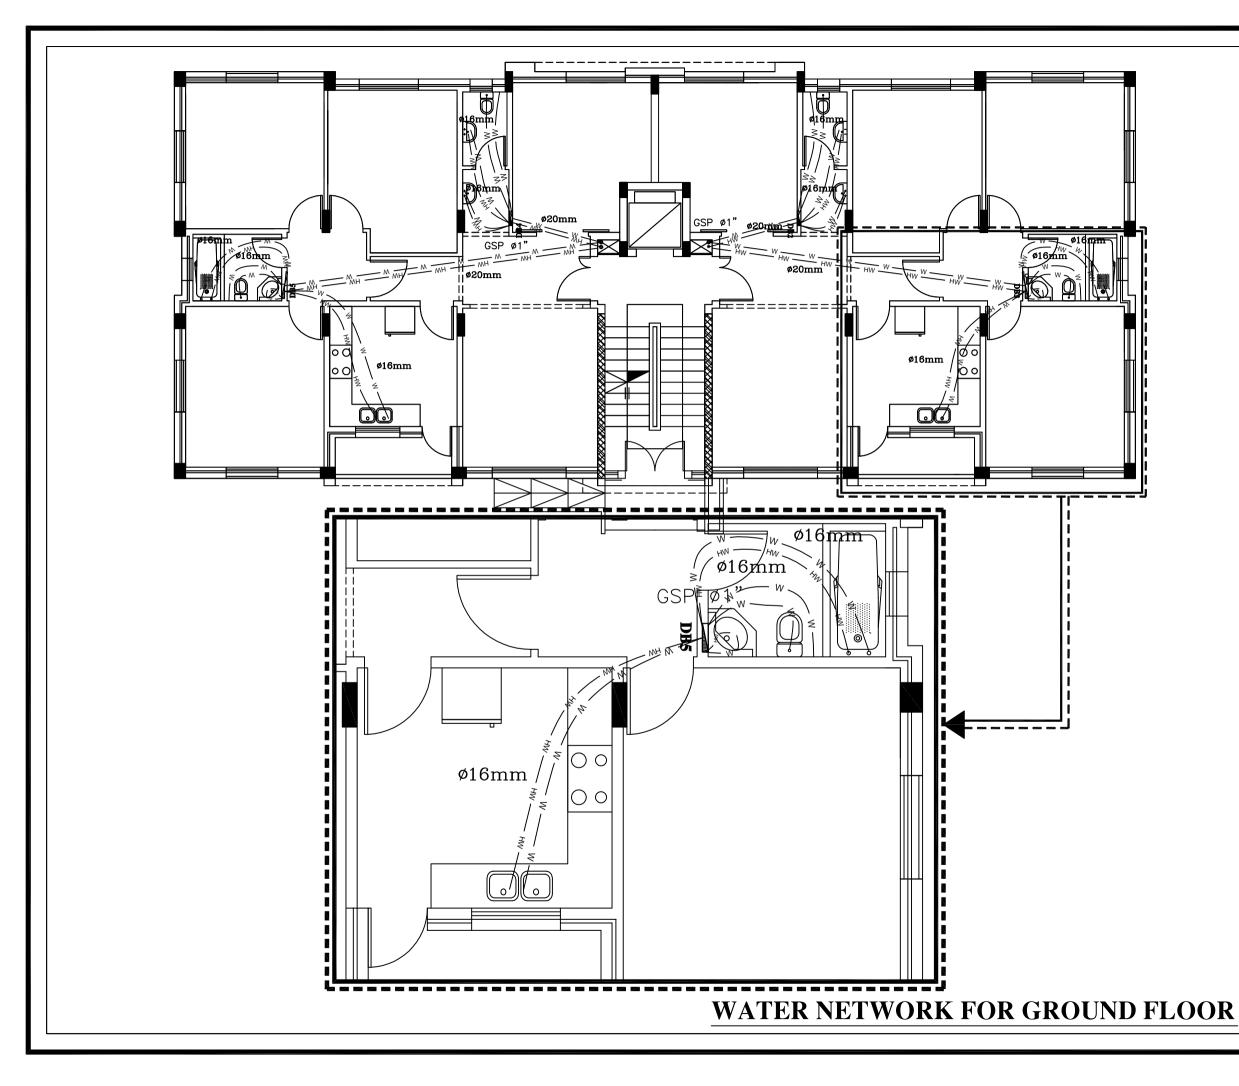


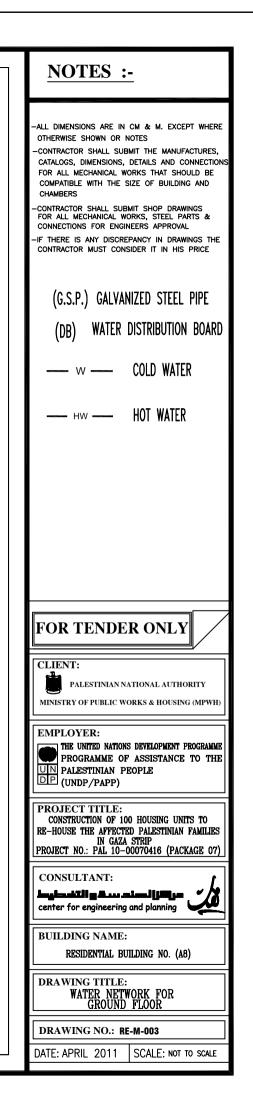

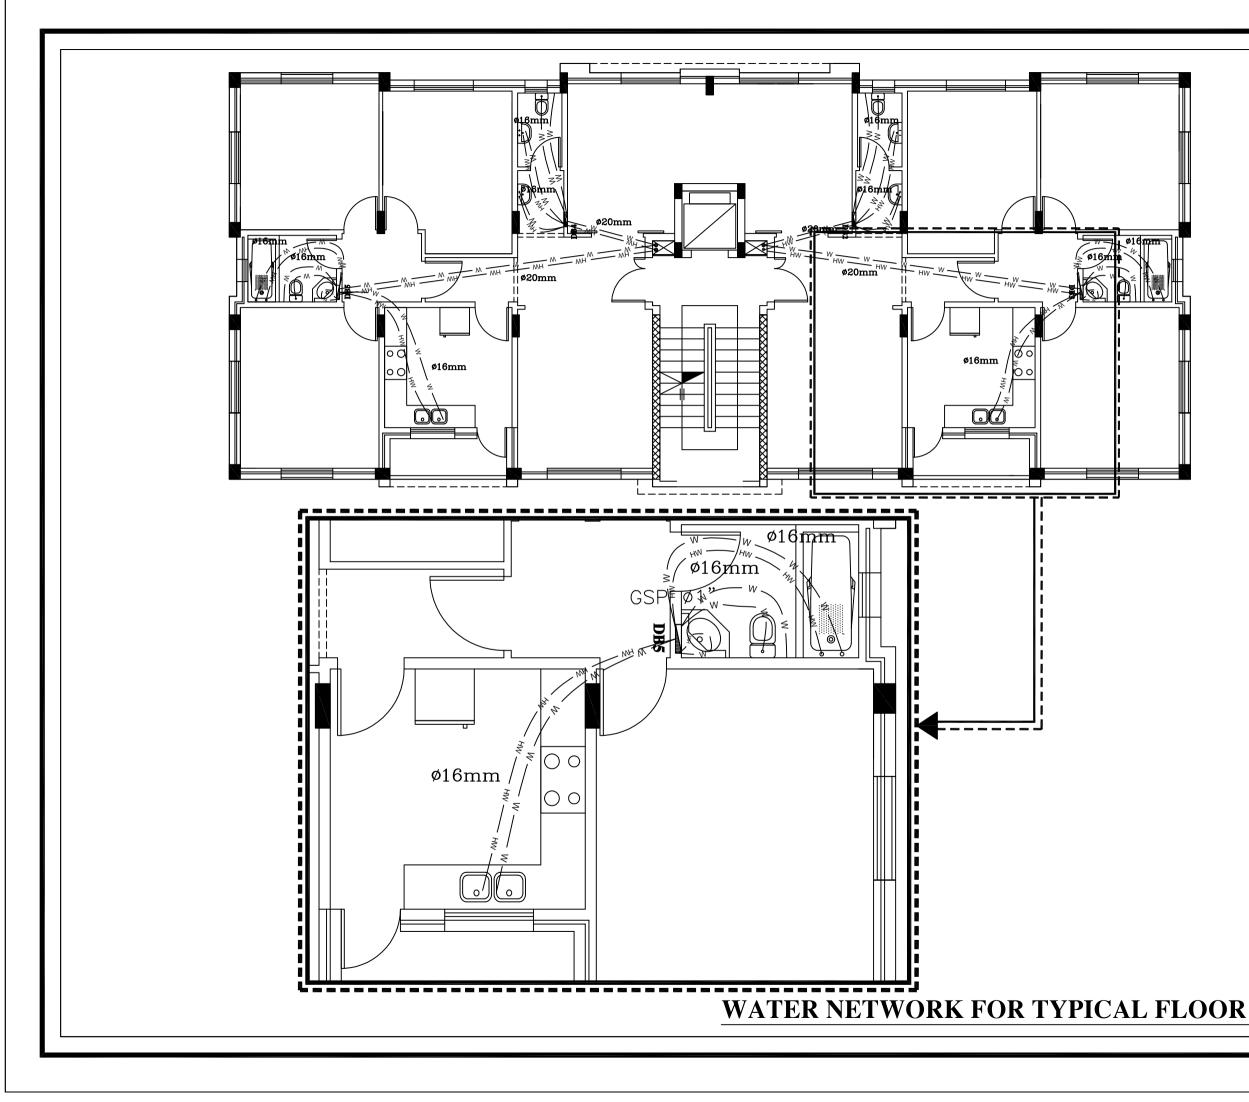


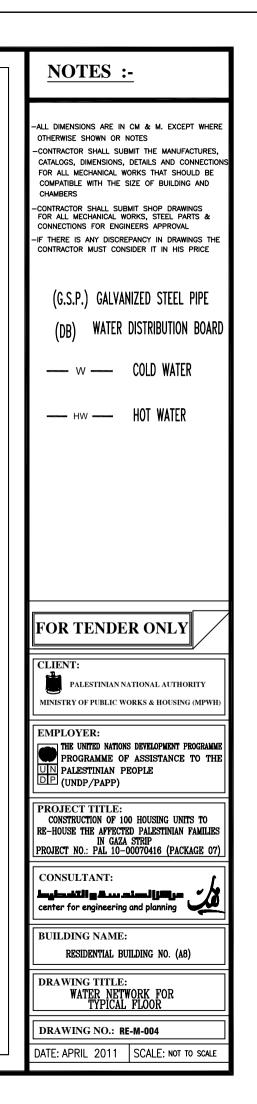


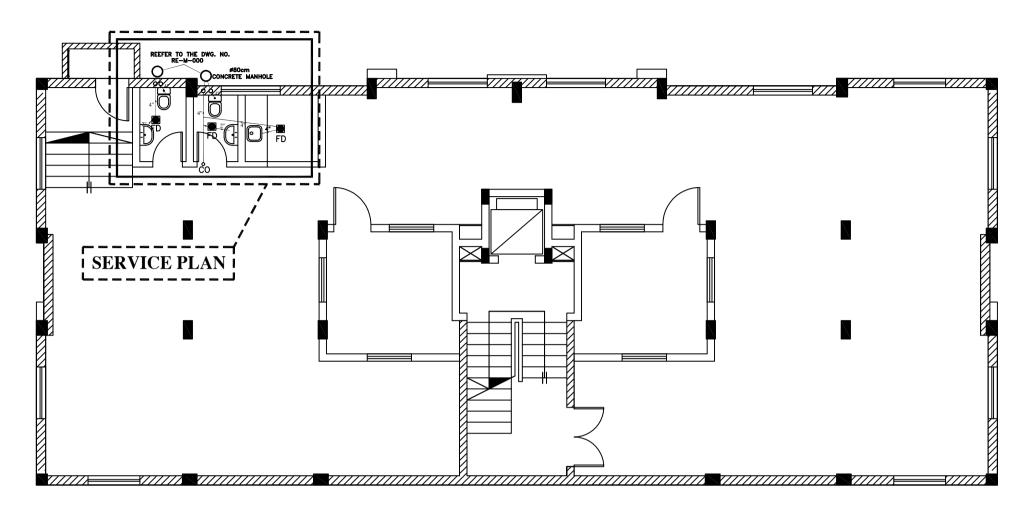


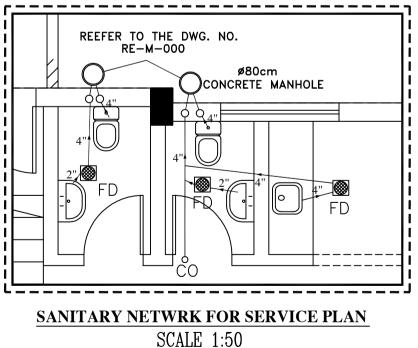



SANITARY NETWORK FOR UNDERGROUND FLOOR

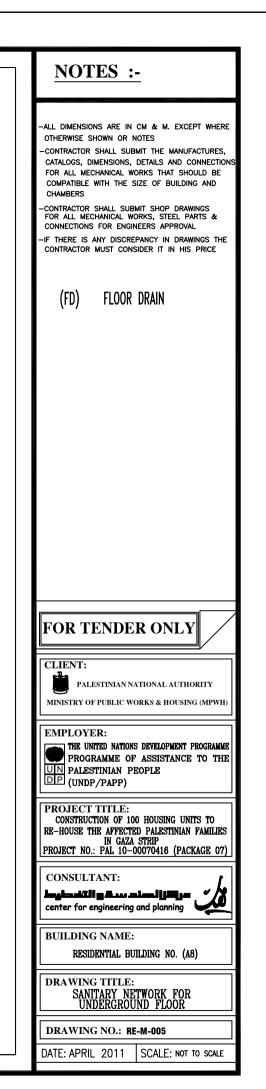


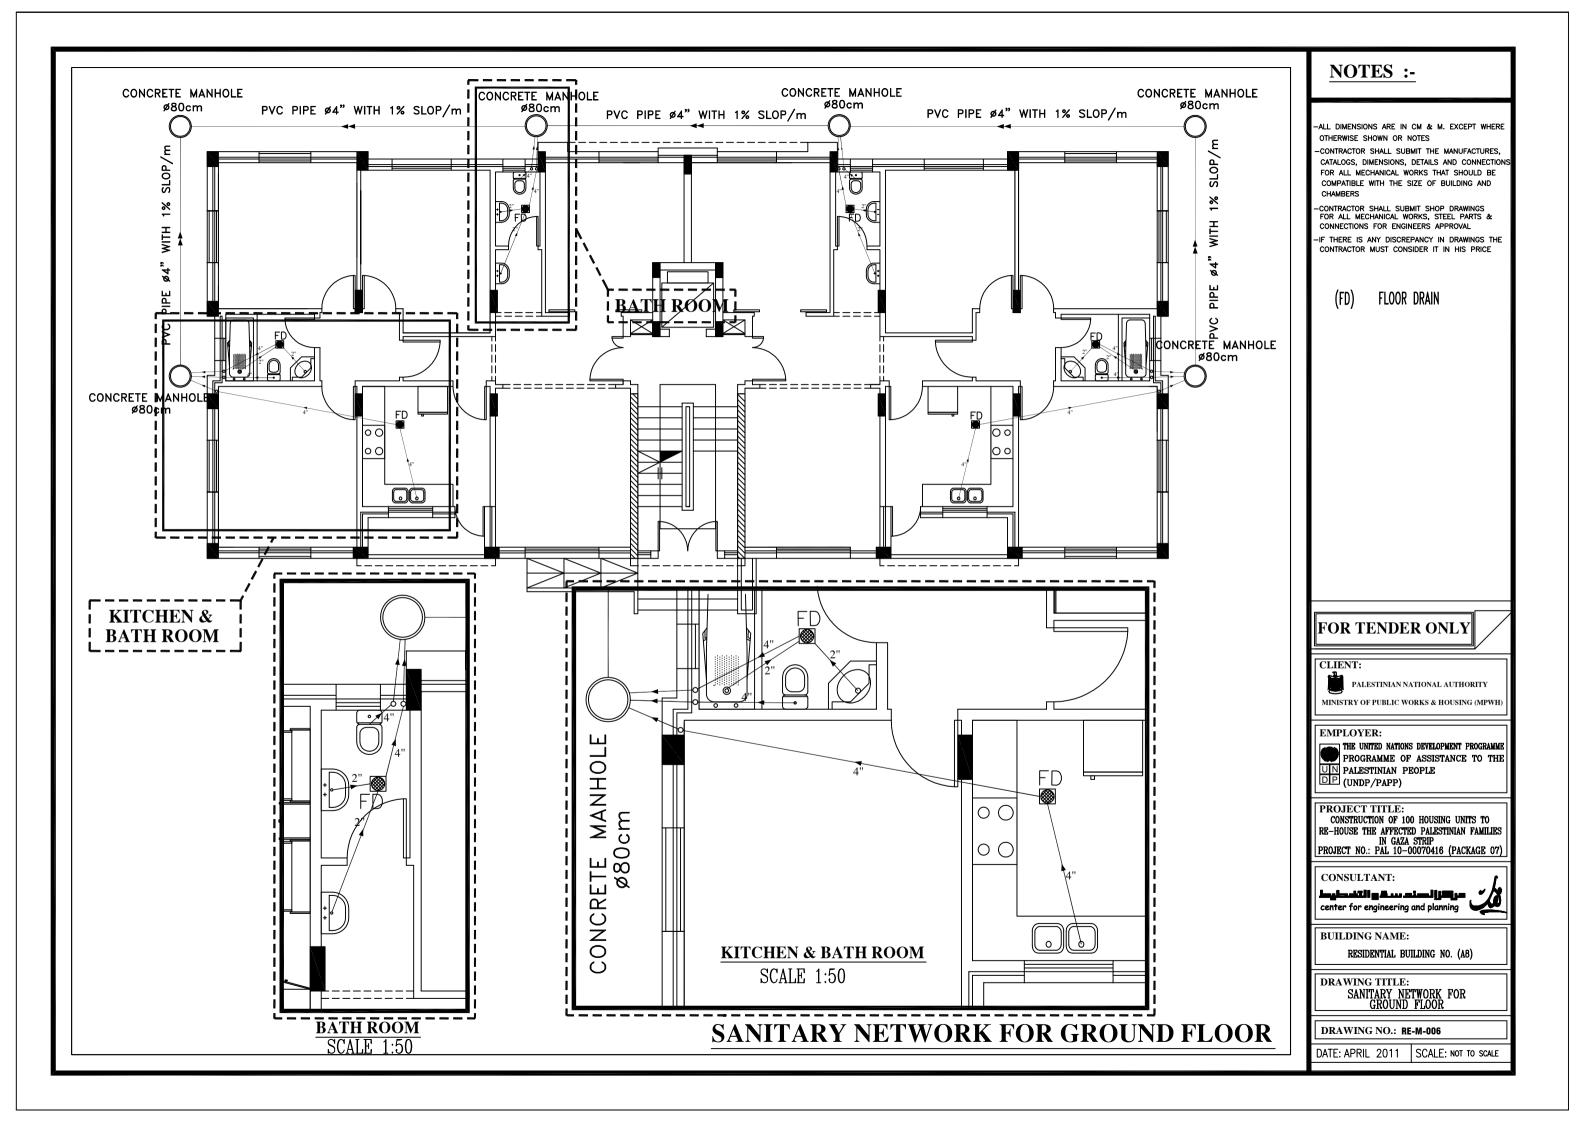


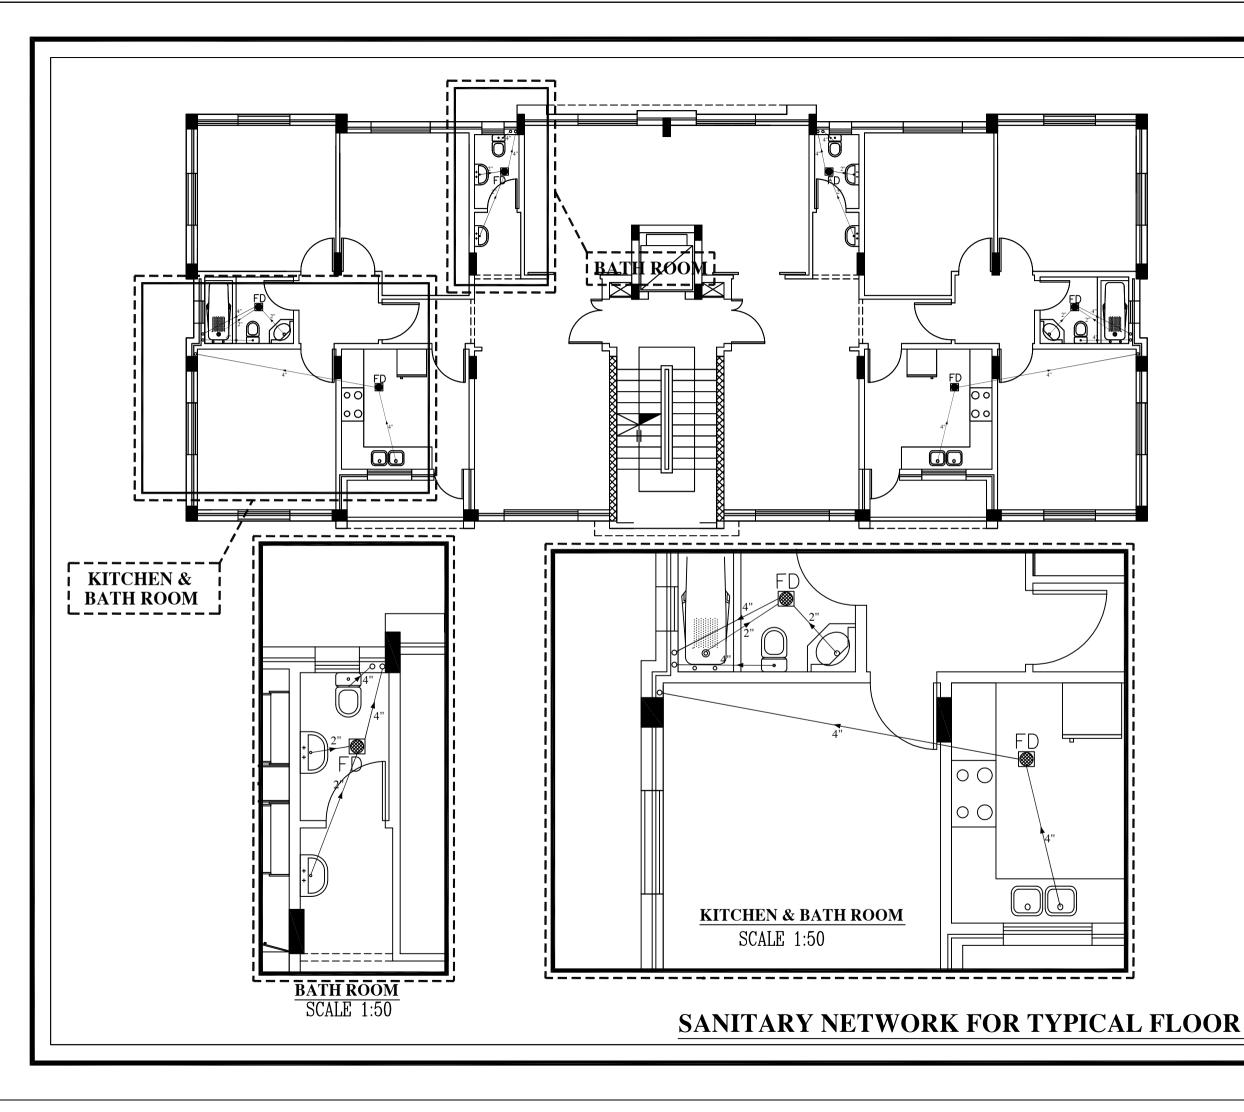


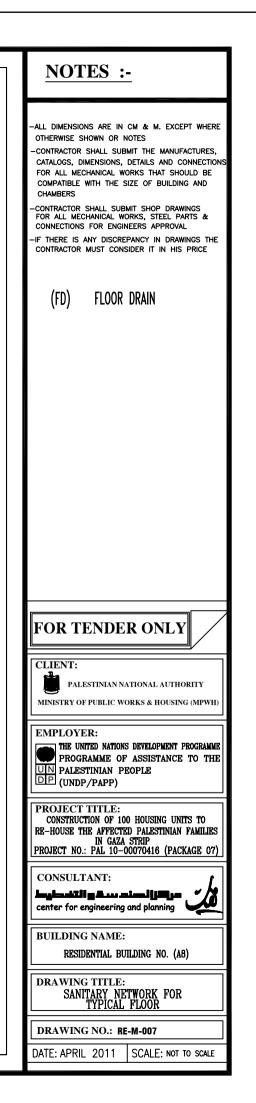

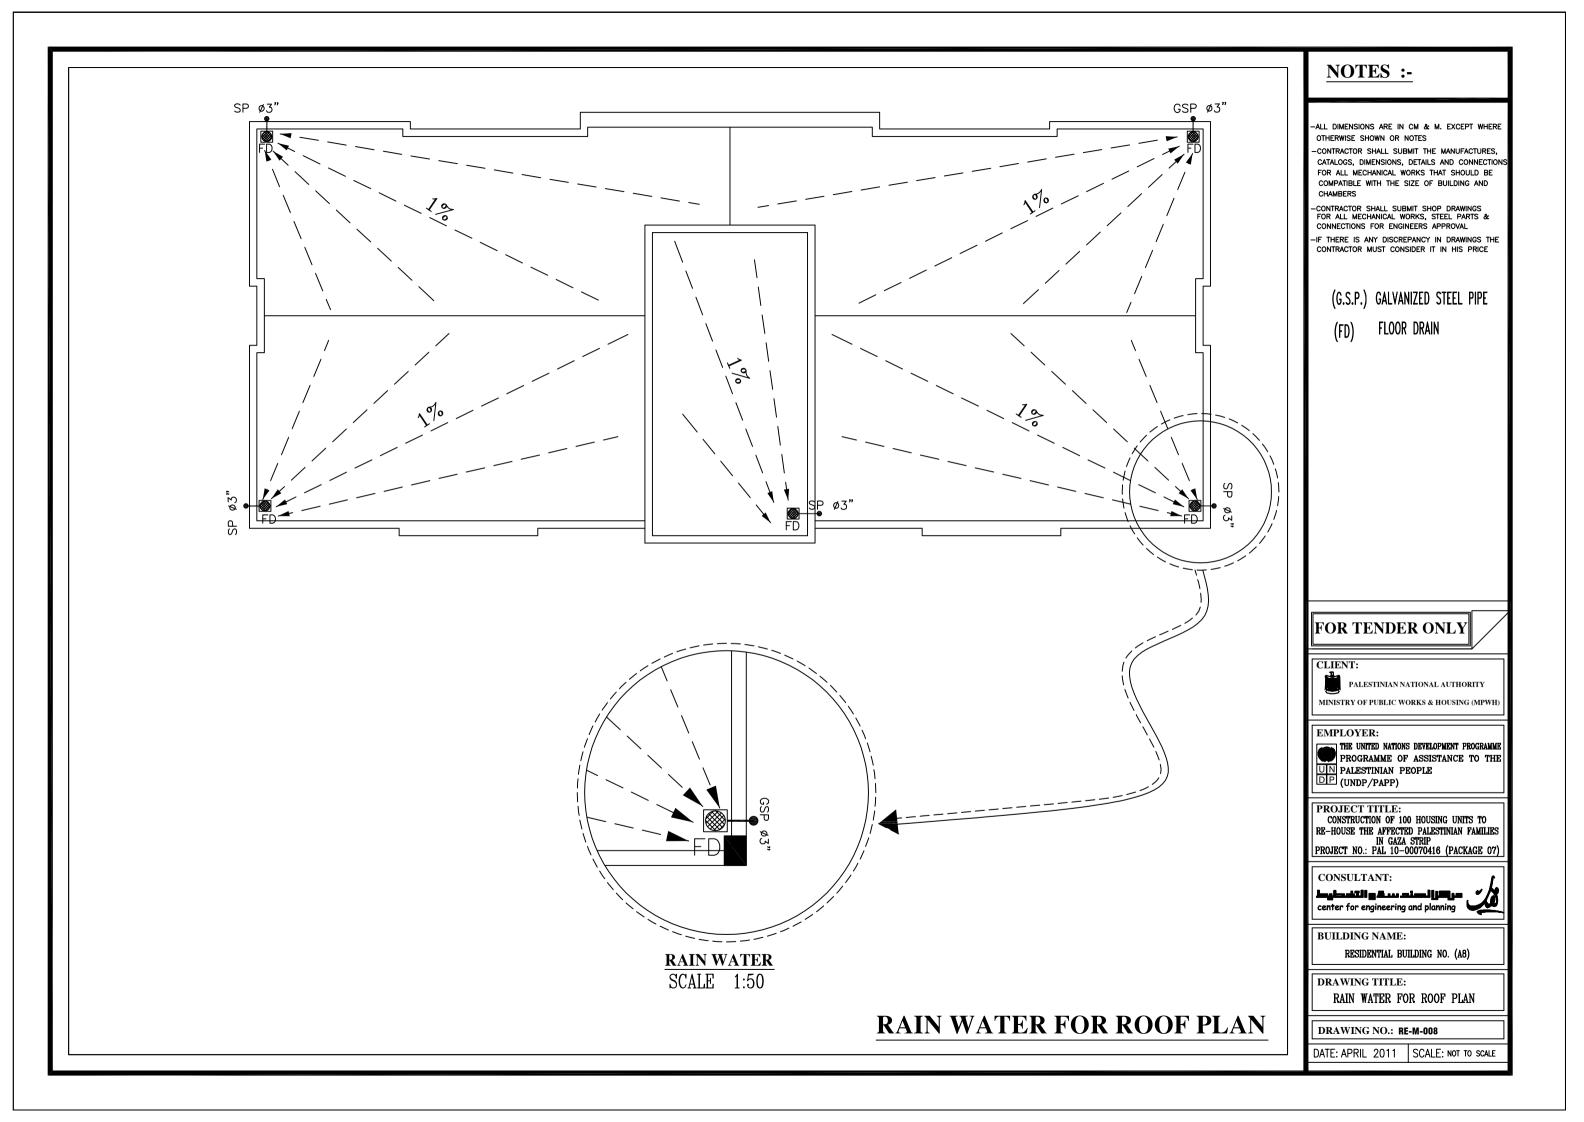


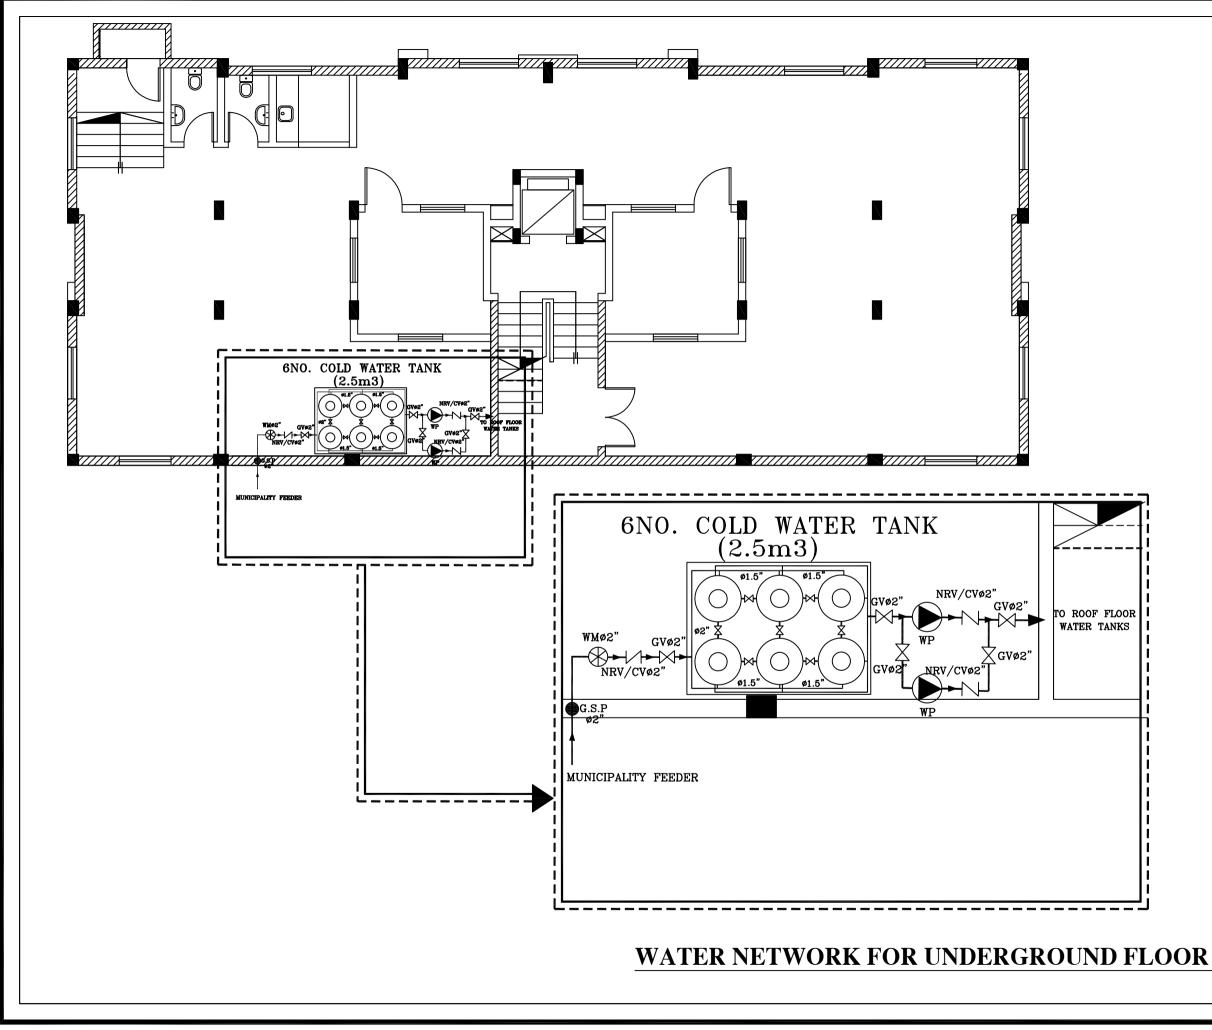

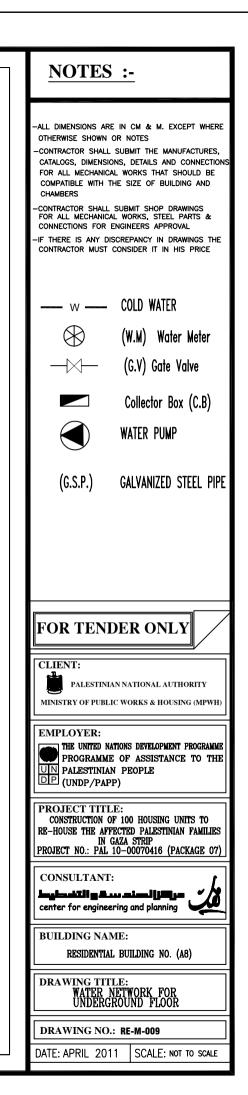


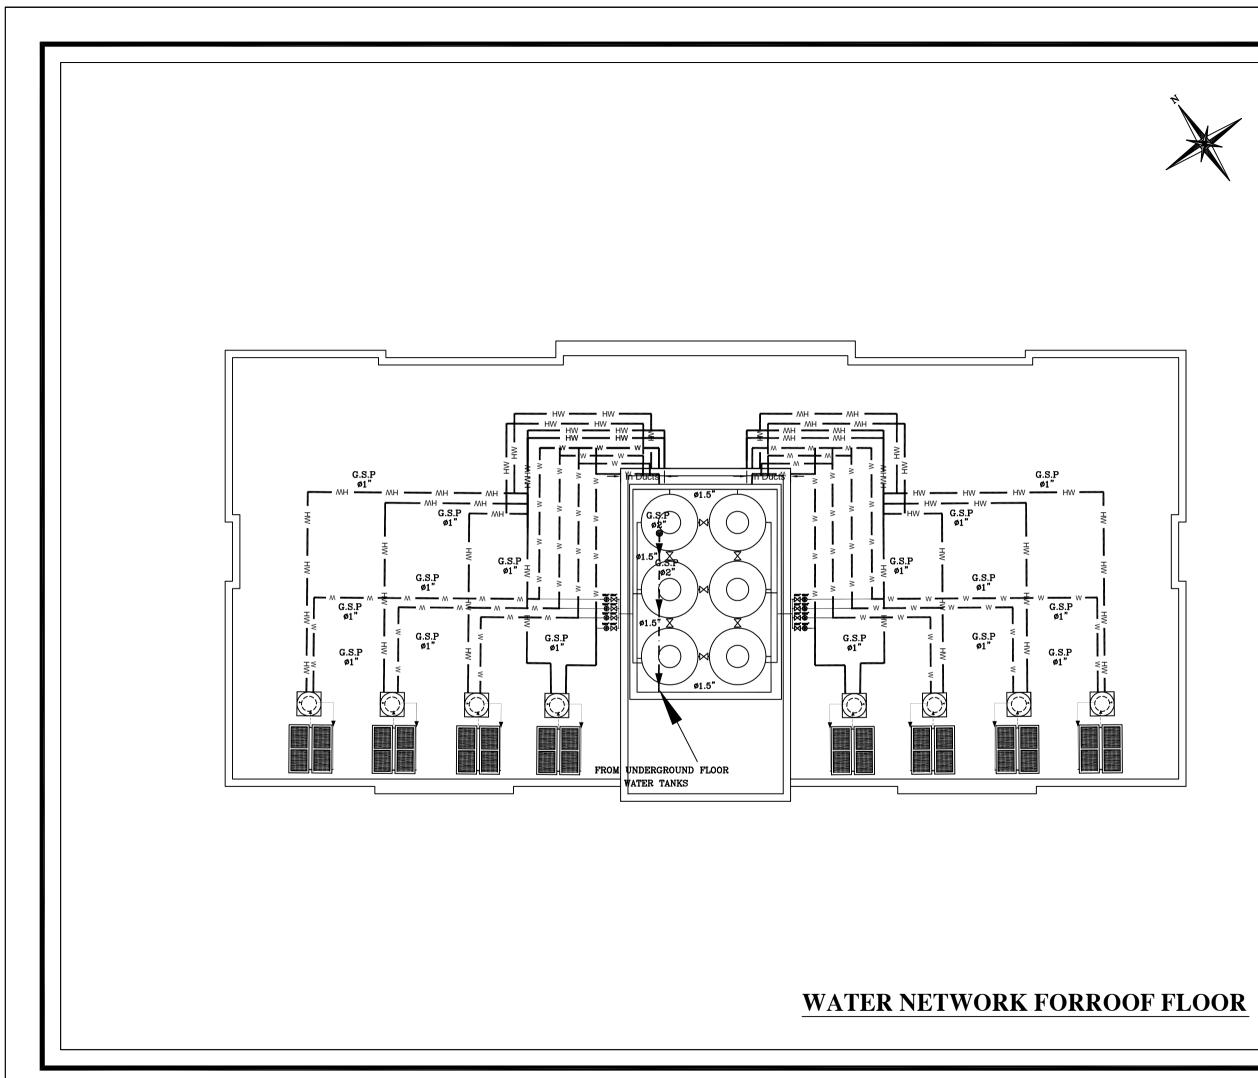



<u>NOTES :-</u>
 ALL DIMENSIONS ARE IN CM & M. EXCEPT WHERE OTHERWISE SHOWN OR NOTES CONTRACTOR SHALL SUBMIT THE MANUFACTURES, CATALOGS, DIMENSIONS, DETAILS AND CONNECTIONS FOR ALL MECHANICAL WORKS THAT SHOULD BE COMPATIBLE WITH THE SIZE OF BUILDING AND CHAMBERS CONTRACTOR SHALL SUBMIT SHOP DRAWINGS FOR ALL MECHANICAL WORKS, STEEL PARTS & CONNECTIONS FOR ENGINEERS APPROVAL IF THERE IS ANY DISCREPANCY IN DRAWINGS THE CONTRACTOR MUST CONSIDER IT IN HIS PRICE
(G.S.P.) GALVANIZED STEEL PIPE
(DB) WATER DISTRIBUTION BOARD
FOR TENDER ONLY
CLIENT: PALESTINIAN NATIONAL AUTHORITY MINISTRY OF PUBLIC WORKS & HOUSING (MPWH)
EMPLOYER: THE UNITED NATIONS DEVELOPMENT PROGRAMME PROGRAMME OF ASSISTANCE TO THE UN PALESTINIAN PEOPLE UP (UNDP/PAPP)
PROJECT TITLE: CONSTRUCTION OF 100 HOUSING UNITS TO RE-HOUSE THE AFFECTED PALESTINIAN FAMILIES IN GAZA STRIP PROJECT NO.: PAL 10-00070416 (PACKAGE 07)
CONSULTANT:
BUILDING NAME: RESIDENTIAL BUILDING NO. (A8)
DRAWING TITLE: WATER NETWORK FOR ROOF FLOOR
DRAWING NO.: RE-M-010
DATE: APRIL 2011 SCALE: NOT TO SCALE

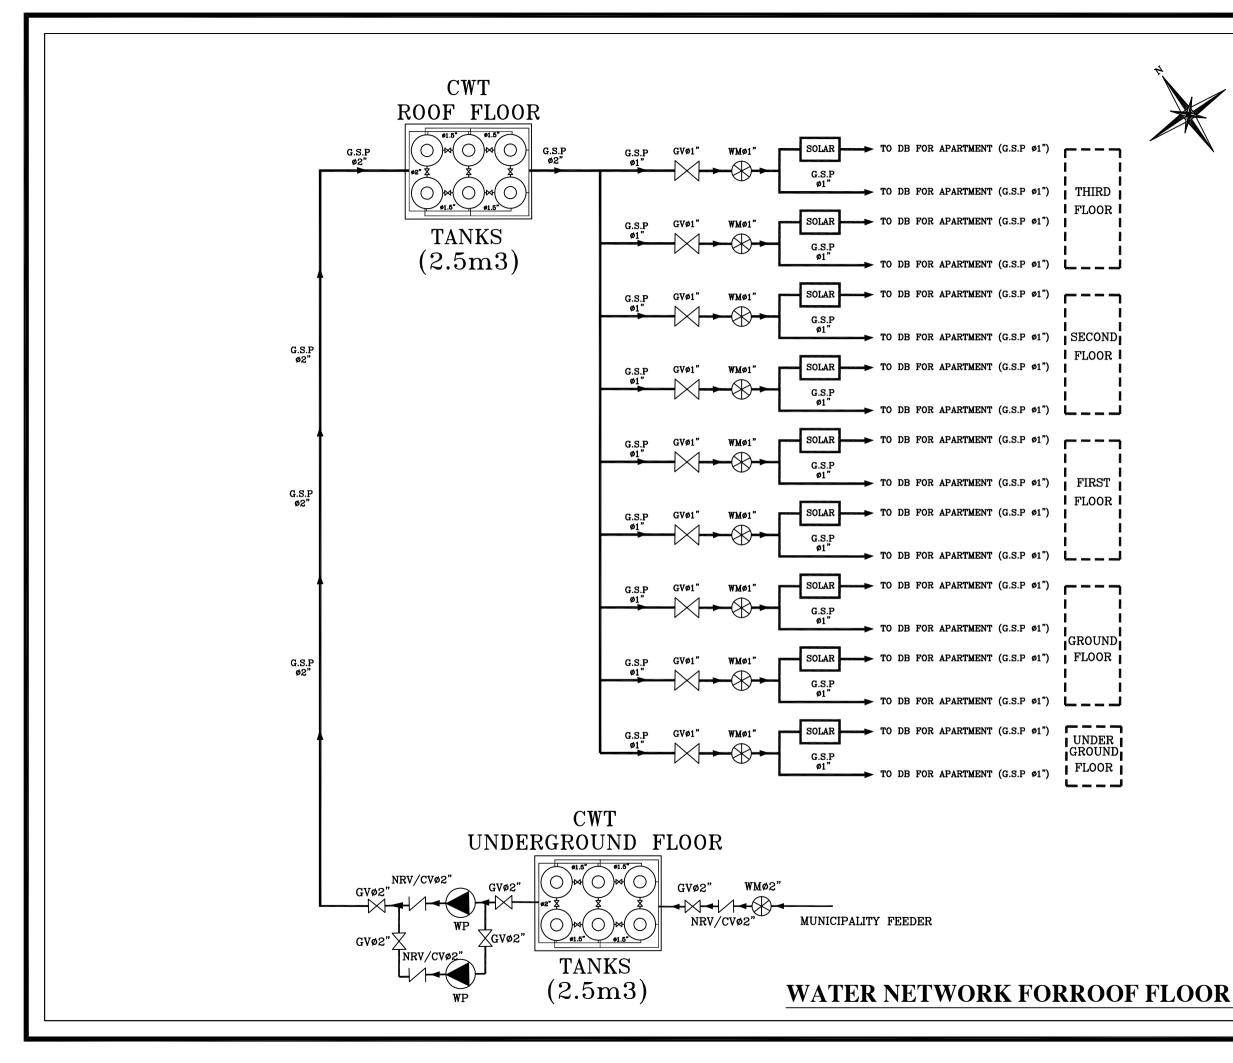





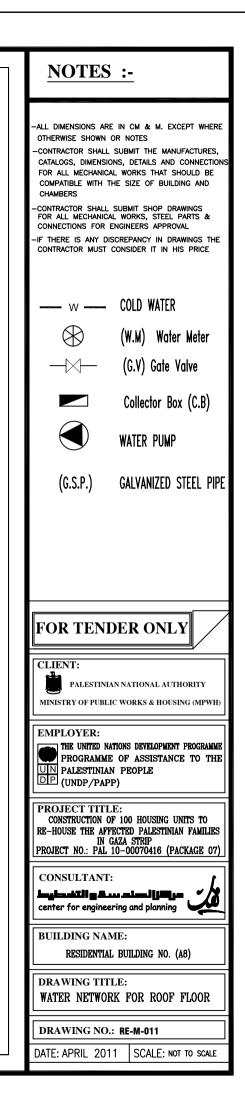

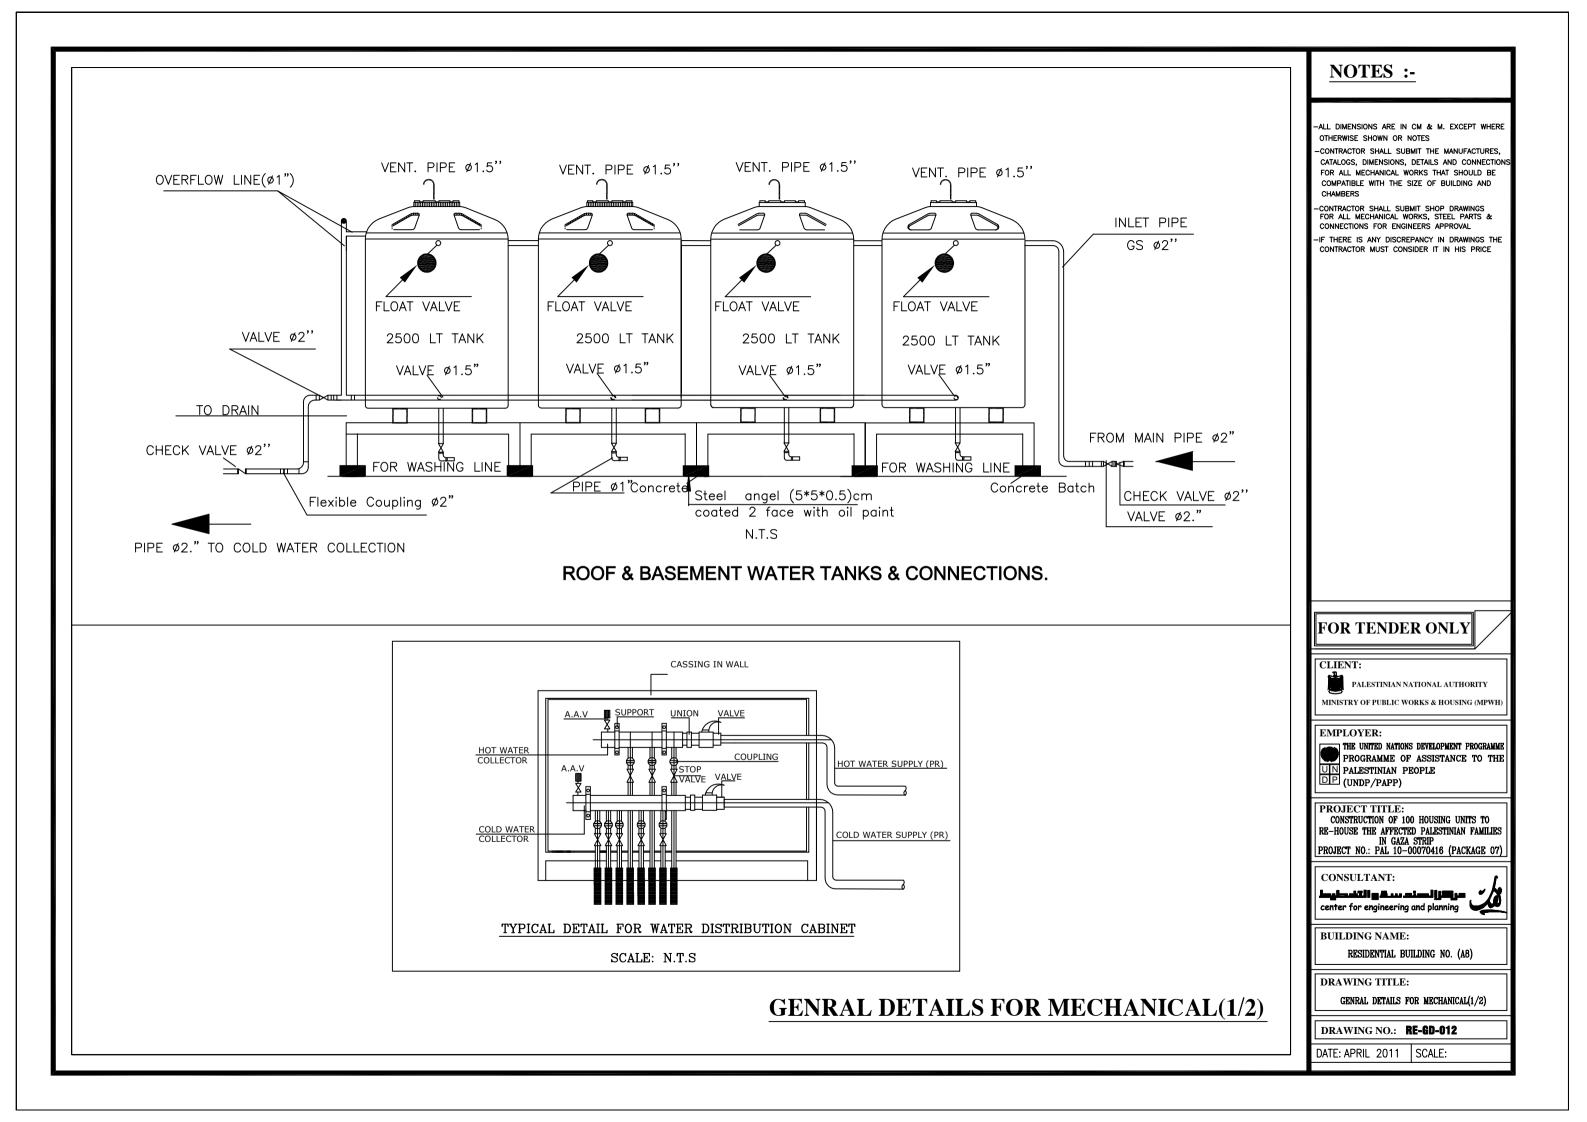

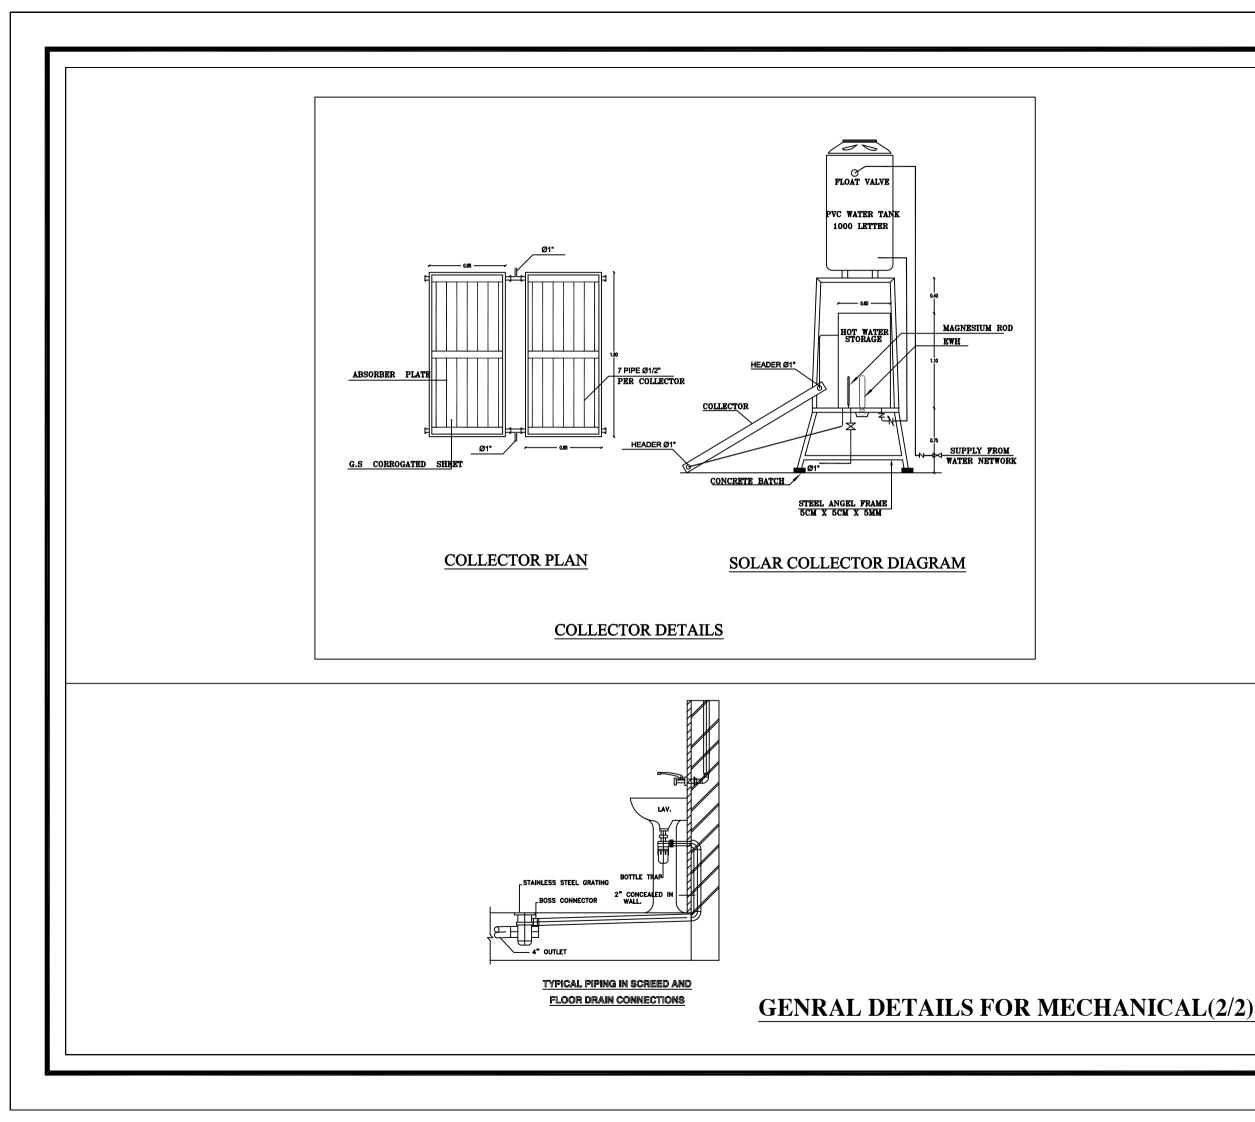

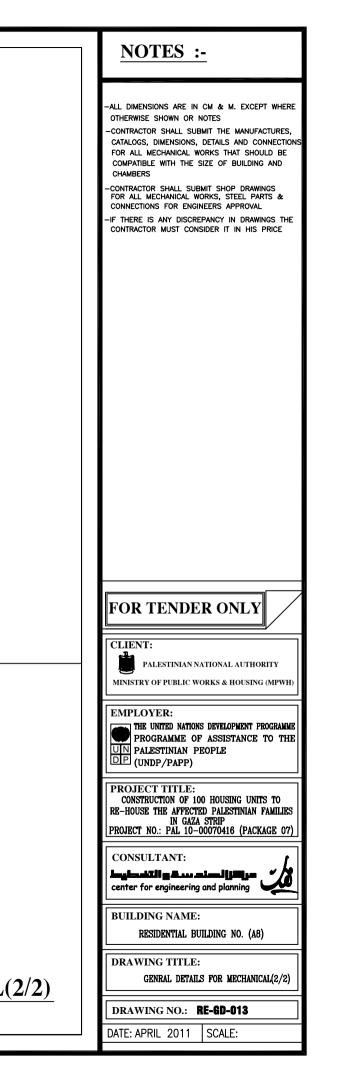

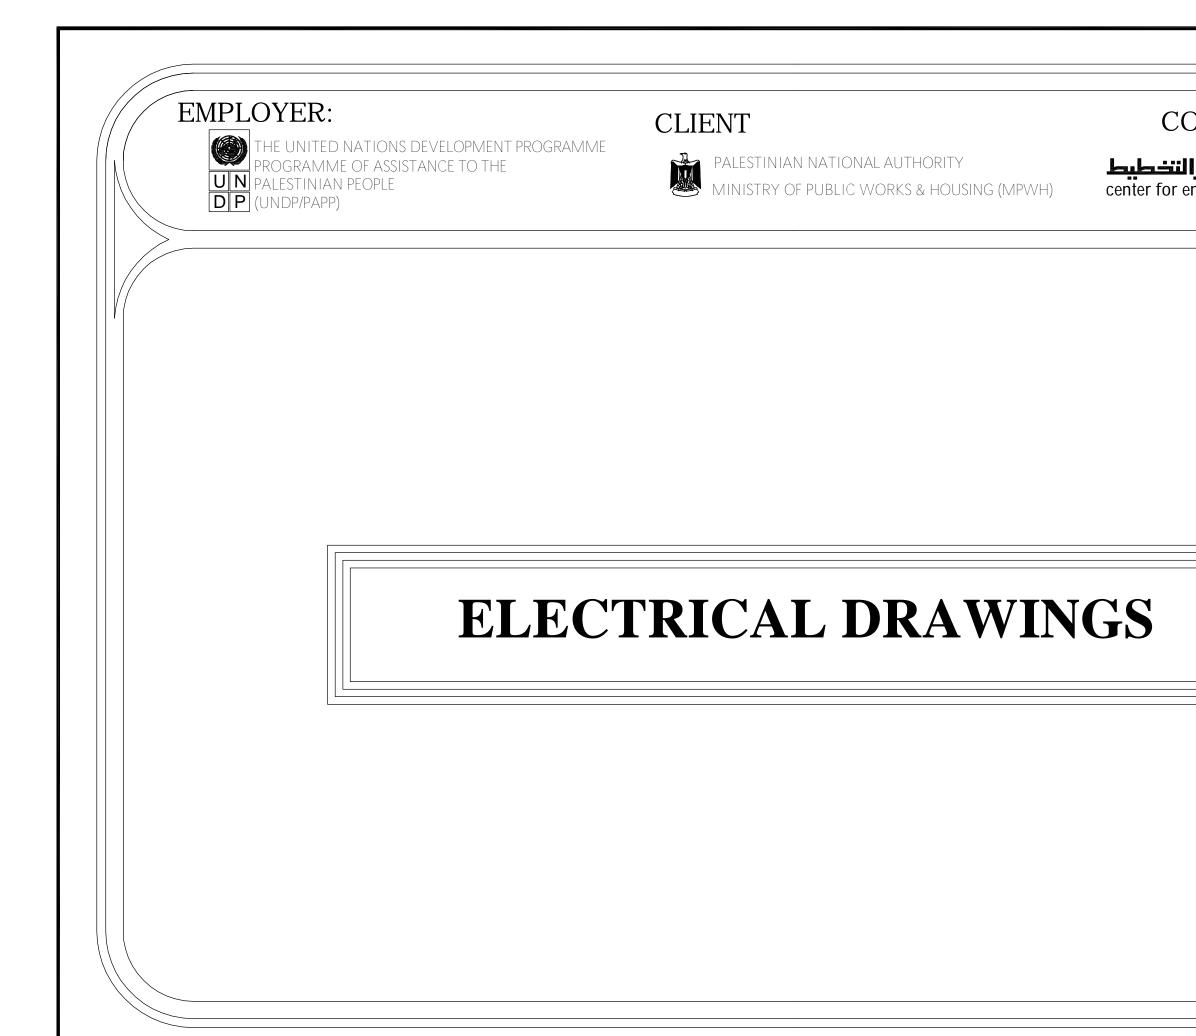






THE UNITED NATIONS DEVELOPMENT PROGRAMME PROGRAMME OF ASSISTANCE TO THE PALESTINIAN PEOPLE DP (UNDP/PAPP)

CLIENT



PALESTINIAN NATIONAL AUTHORITY MINISTRY OF PUBLIC WORKS & HOUSING (MPWH)

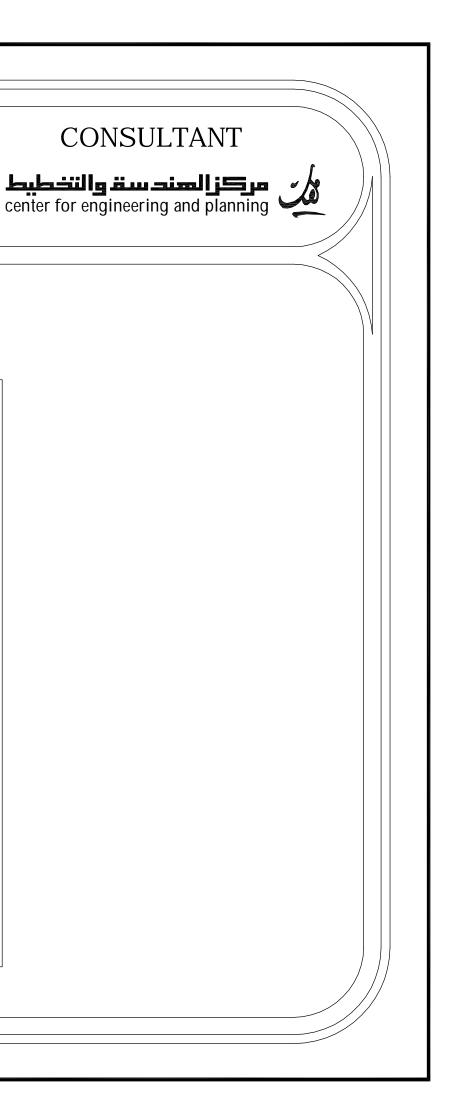



LIST OF DRAWINGS


S/NO.	DRAWING NAME	DRG. NO.
	ELECTRICAL DRAWING	
01/16	Legend	RE-E-001
02/16	Grounding System	RE-E-002
03/16	UNDERGROUND FLOOR-Electrical Arrangements	RE-E-003
04/16	UNDERGROUND FLOOR-Lighting Fittings Layout	RE-E-004
05/16	UNDERGROUND FLOOR-Power Fittings Layout	RE-E-005
06/16	GROUND FLOOR-Lighting Fittings Layout	RE-E-006
07/16	GROUND FLOOR-Power Fittings Layout	RE-E-007
08/16	GROUND FLOOR-Telephone & TV Fittings Layout	RE-E-008
09/16	TYPICAL FLOOR-Lighting Fittings Layout	RE-E-009
10/16	TYPICAL FLOOR-Power Fittings Layout	RE-E-010
11/16	TYPICAL FLOOR-Telephone & TV Fittings Layout	RE-E-011
12/16	TYPICAL FLAT PANEL-DB-G1 Single Line Power Diagram	RE-E-012
13/16	UNDERGROUND FLOOR-DB-B Single Line Power Diagram	RE-E-013
14/16	UNDERGROUND FLOOR-MDB Main Distribution Board	RE-E-014
15/16	Power Cables Riser Diagram	RE-E-015
16/16	Telephone Cables Riser Diagram	RE-E-016


SYMBOL	DESCRIPTION
-(16A SINGLE PHASE, 3-PIN SOCKET OUTLET H=45CM F.F.F.L
	16A SINGLE PHASE, 3-PIN SOCKET OUTLET, WATER PROOF.IP65 H=140CM F.F.F.L
<u>ک</u>	1×20A - 220V AIR CONDITIONING SOCKETOUTLET
\leftarrow	+CONTROL SWITCH WITH INDICATOR LAMP. H=160CM F.F.F.L
[THREE PHASE, SOCKET OUTLET H=140CM F.F.F.L
W.H.	ELECTRICAL WATER HEATER H=180CM F.F.F.L
	OUTDOOR A/C UNITS
	A/C SPLIT UNIT
	SUB-DISTRIBUTION BOARD H=160CM F.F.F.L
	MAIN DISTRIBUTION BOARD (MDB)
	WALL OR WINDOW MOUNTED EXHAUST FAN
\bigcirc	Electrical Bell
\bowtie	RJ11 TELEPHONE SOCKET OUTLET.
TEL	TELEPHONE JUNCTION BOX H=45CM F.F.F.L
	Intercom Indoor Handle H=160CM F.F.F.L
	Intercom Outdoor Panel H=160CM F.F.F.L
	TV SOCKET OUTLET H=45CM F.F.L
TV	TELEPHONE JUNCTION BOX H=45CM F.F.L
MTF	MAIN TELEPHONE FRAME H=45CM F.F.L


SYMBOL	DESCRIPTION
	2x36W SURFACE MOUNTED FLUORESCENT LIGHTING FIXT WITH OUT REFLECTOR IP20
EM	DITTO BUT WITH BACK UP POWER BUILT IN, FOR 1.5HR
	2x36W SURFACE MOUNTED FLUORESCENT LIGHTING FIXT
EM	2x36W SURFACE MOUNTED FLUORESCENT LIGHTING FIXT WATER PROOF IP65
	26W COMPACT FLUORESCENT SURFACE MOUNTED LIGHT
-	DITTO BUT WALL MOUNTED
-18	10W INCANDESCENT WALL MOUNTED DECORATIVE NIGHT
	CHNDELIER
6	1-GANG LIGHTING SWITCH, ONE WAY 16A H=140CM
5	DITTO BUT WATER PROOF IP 65 . H=140CM F.F.F.
6	2-GANG LIGHTING SWITCH, ONE WAY 16A H=140CM
6	DITTO BUT WATER PROOF IP 65 . H=140CM
J.	3-GANG LIGHTING SWITCH, ONE WAY 16A H=140CM
J. J	DITTO BUT WATER PROOF IP 65 . H=140CM
Ś	2-WAY LIGHTING SWITCH, 16A H=140CM
Ś	DITTO BUT WATER PROOF IP 65 . H=140CM
•	PUSHBUTTON LIGHTING SWITCH, ONE WAY 10A H=14

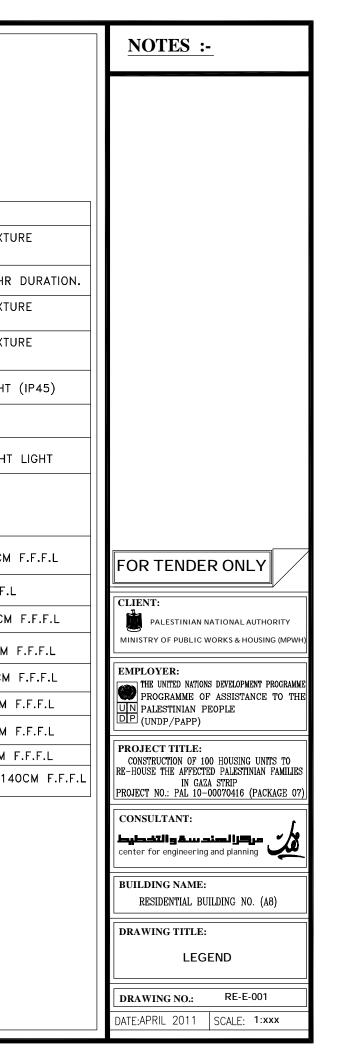


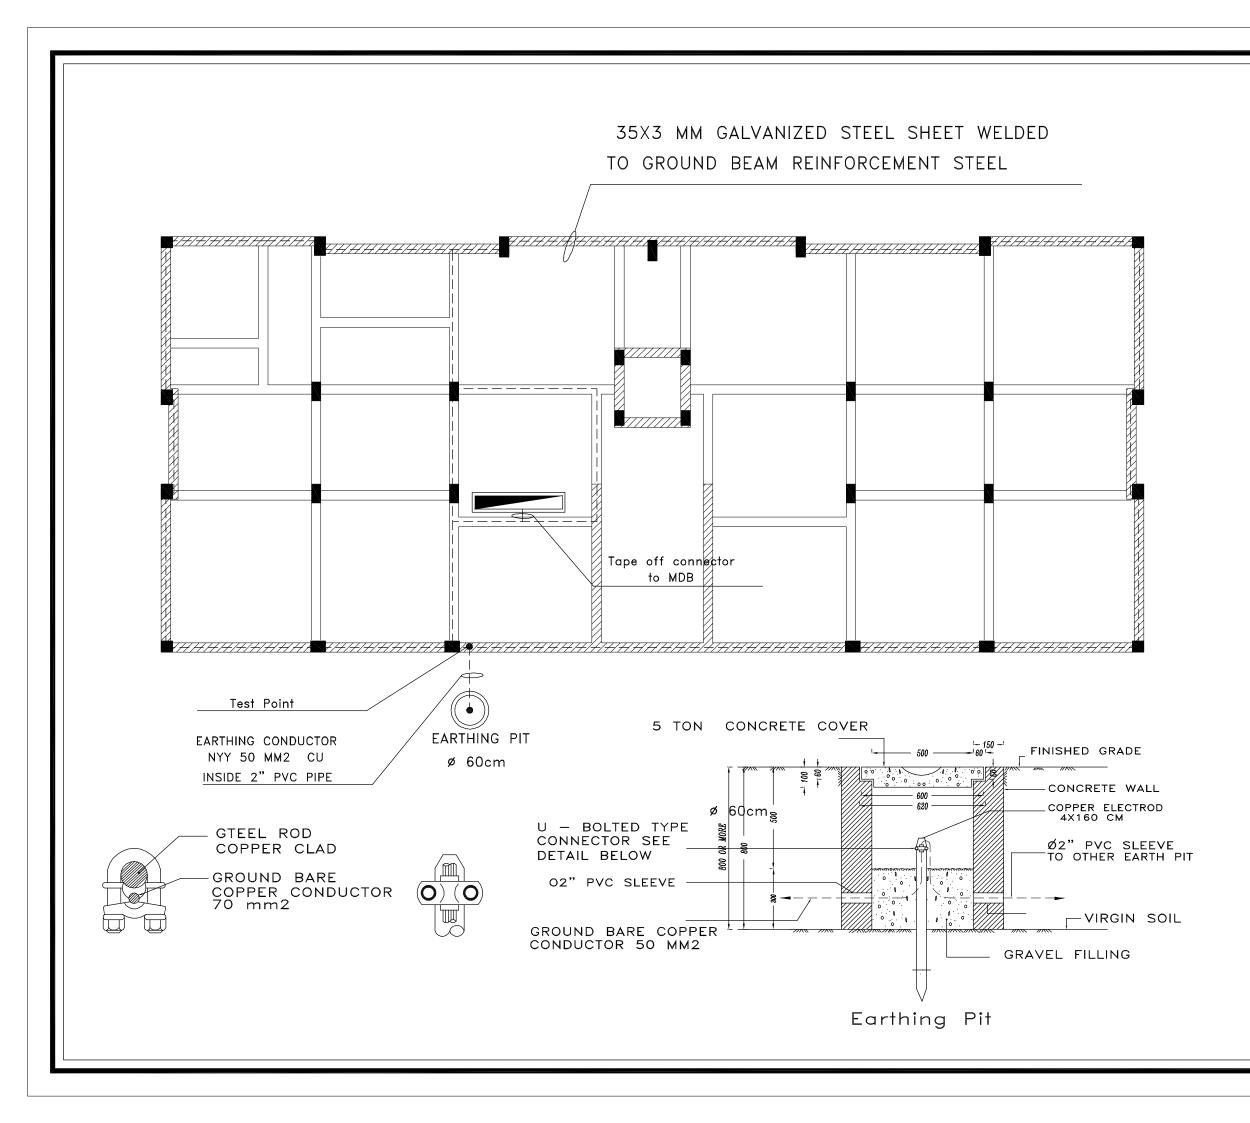


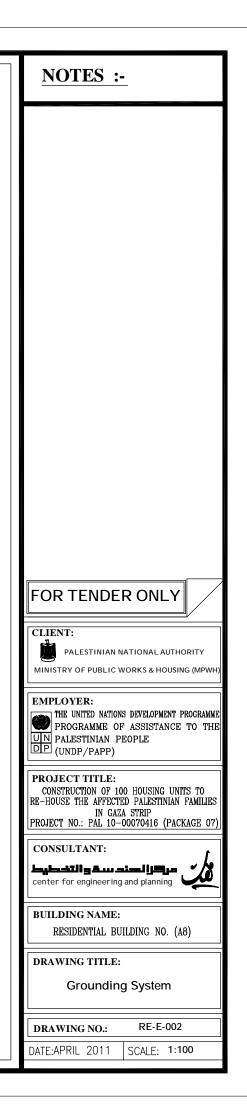


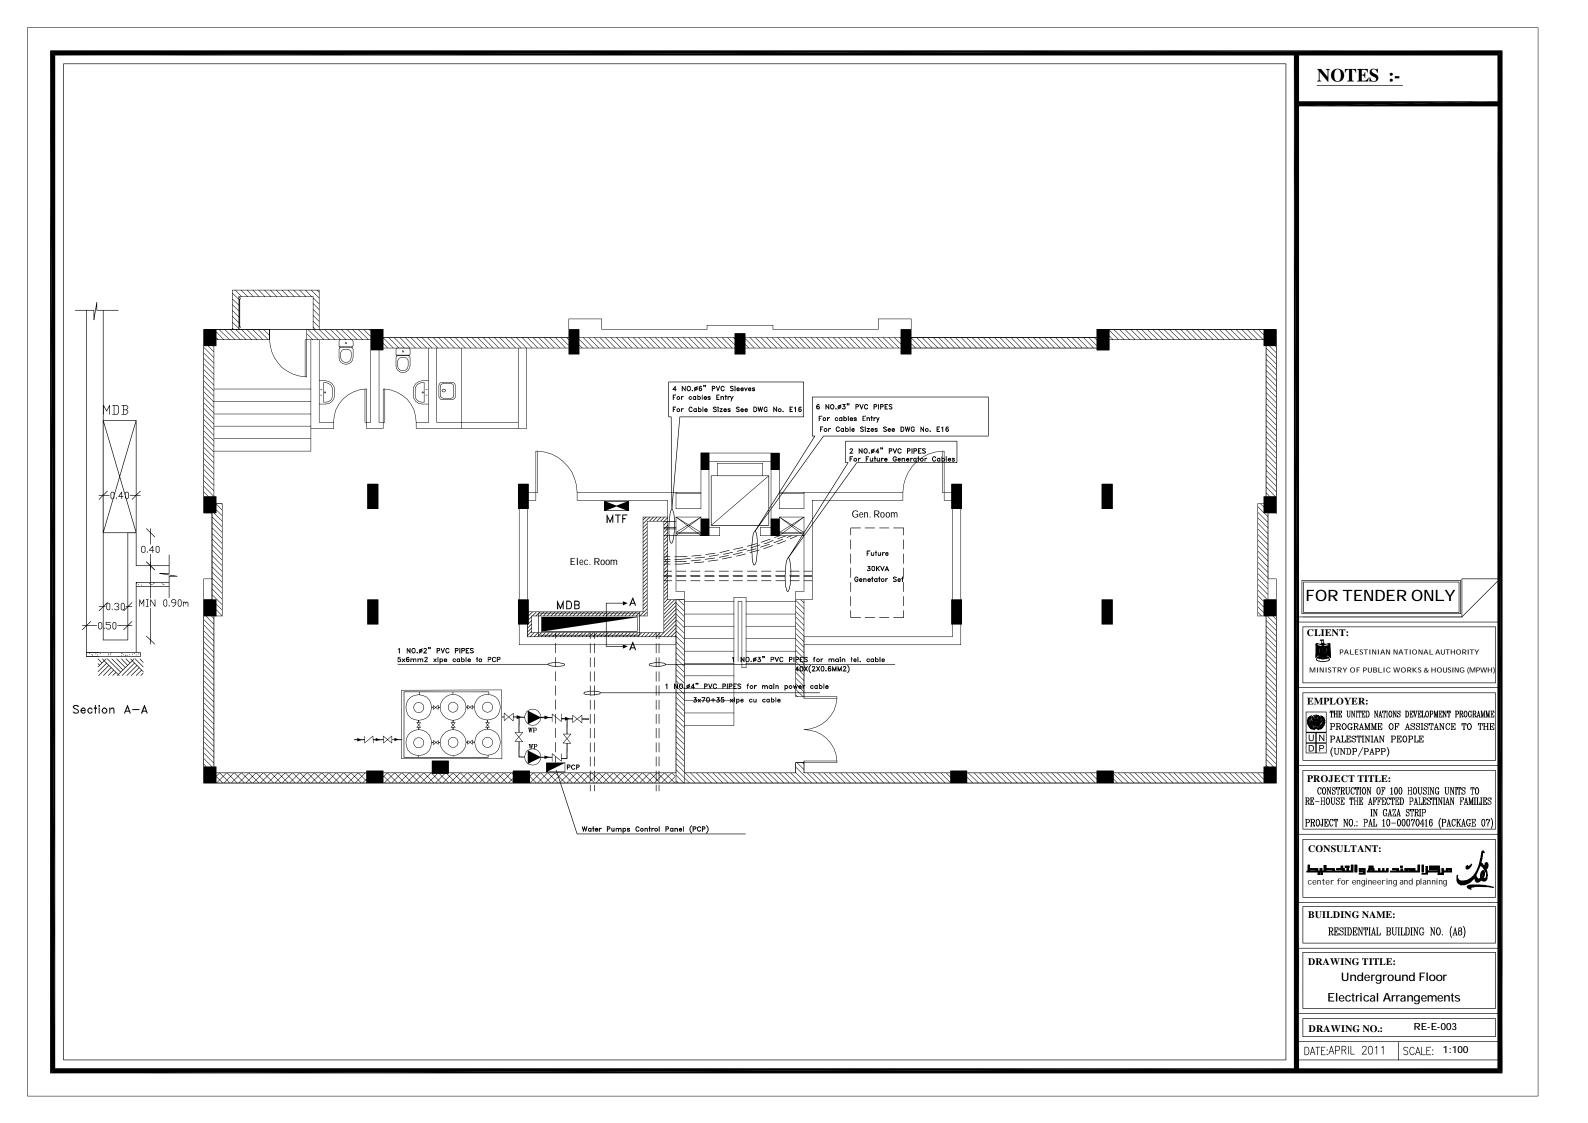


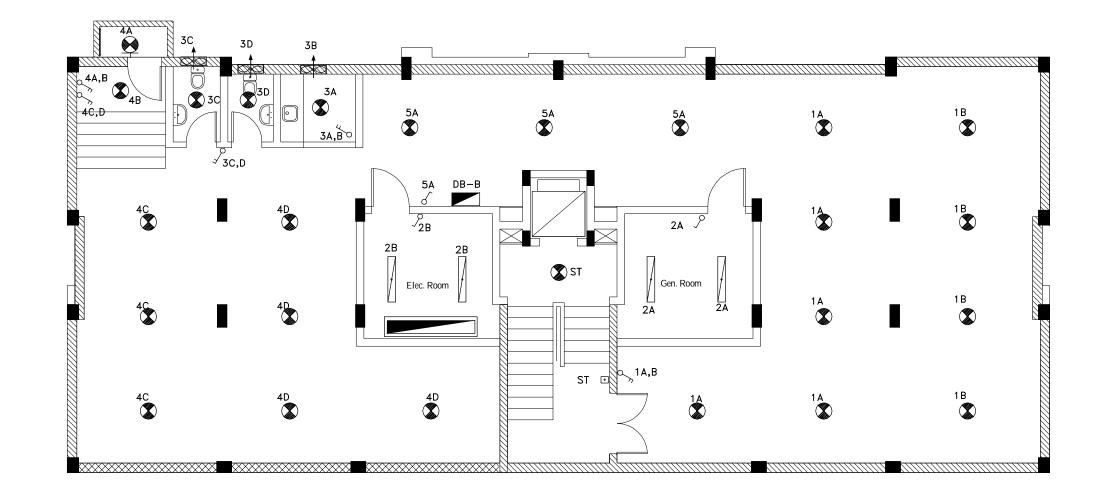


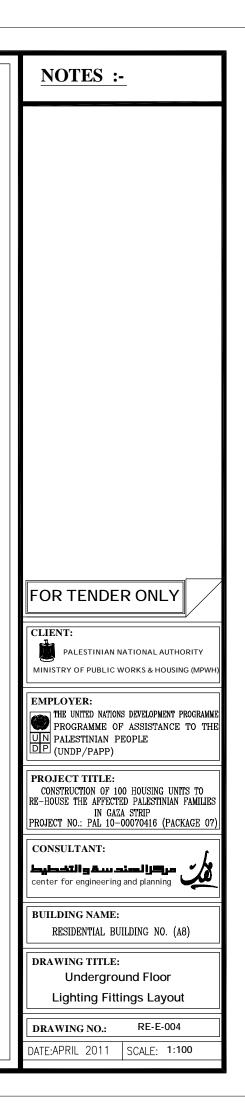


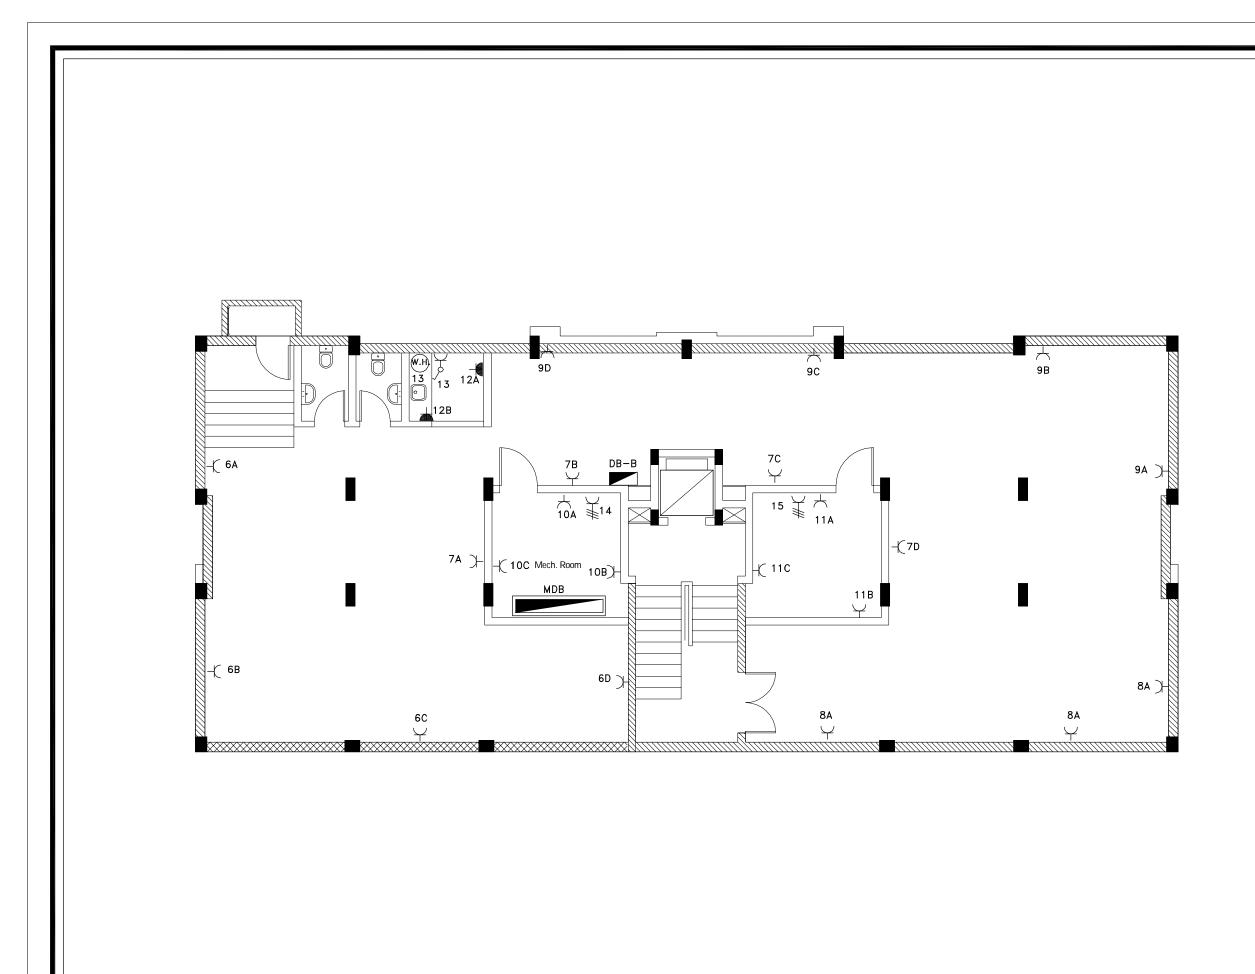


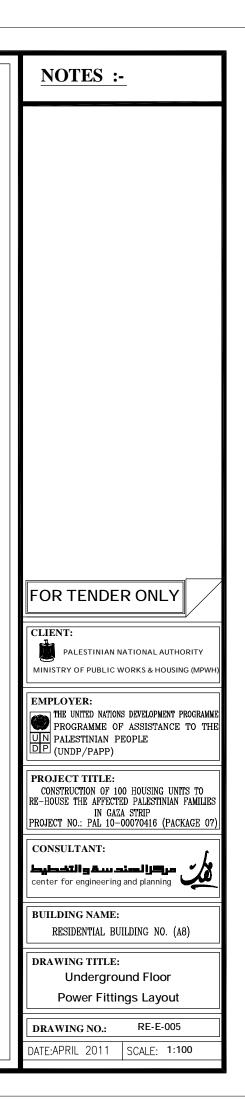


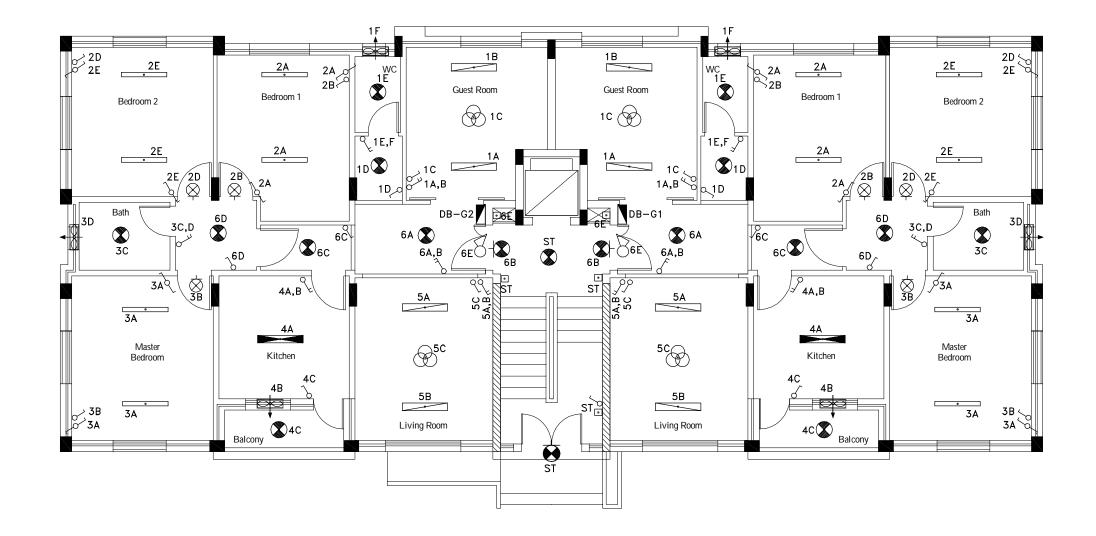


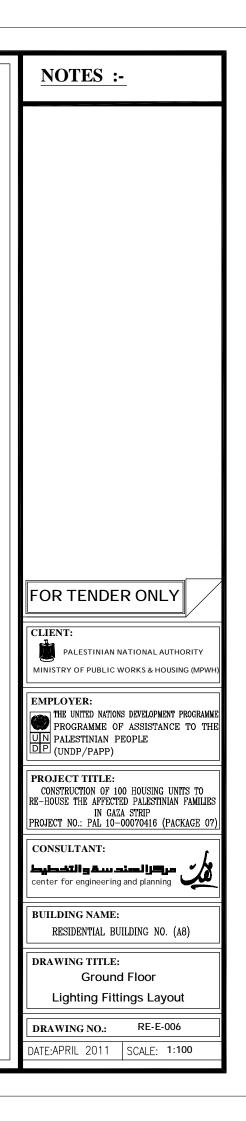


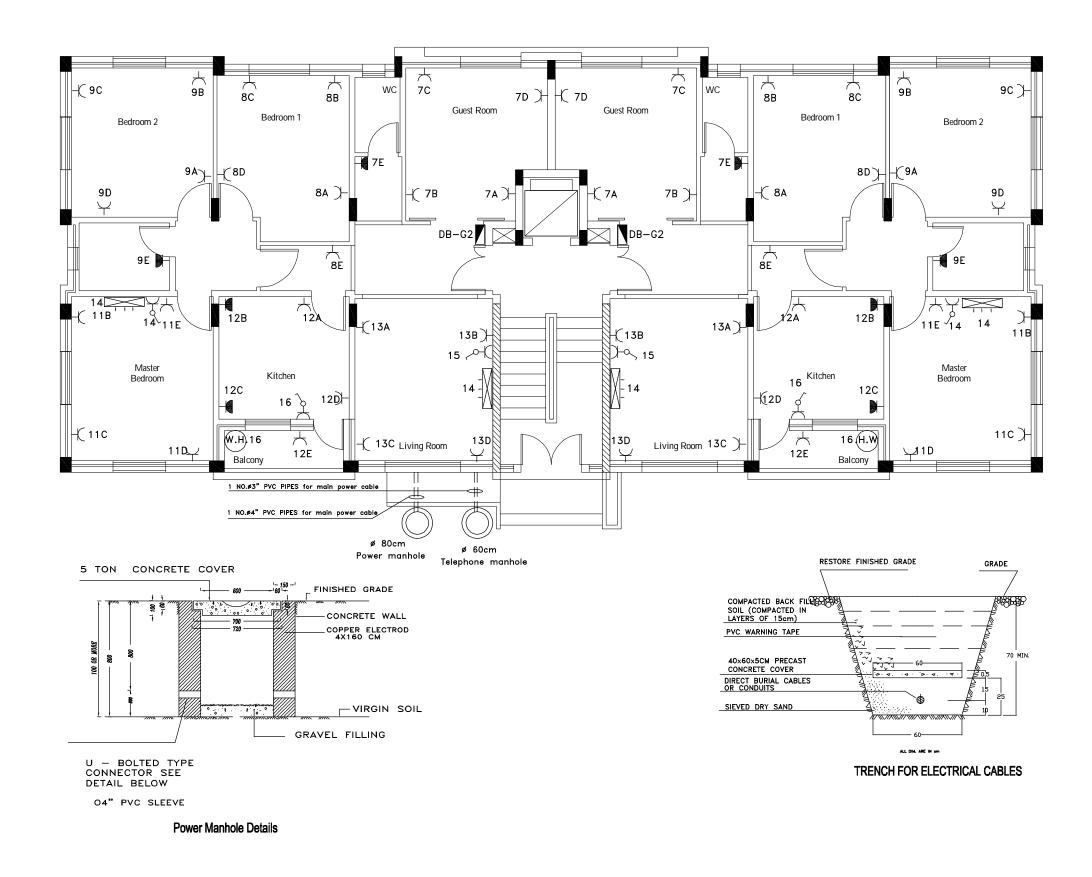


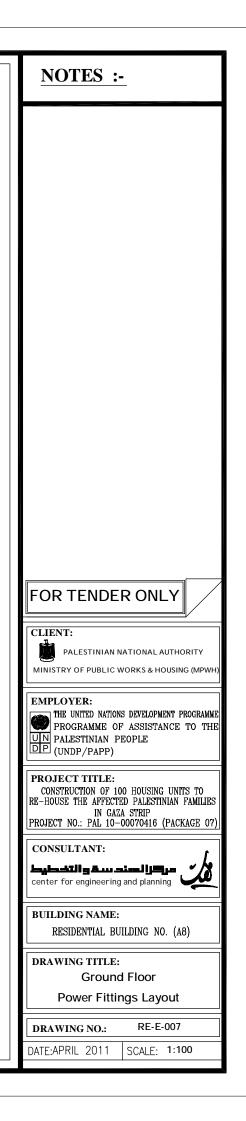


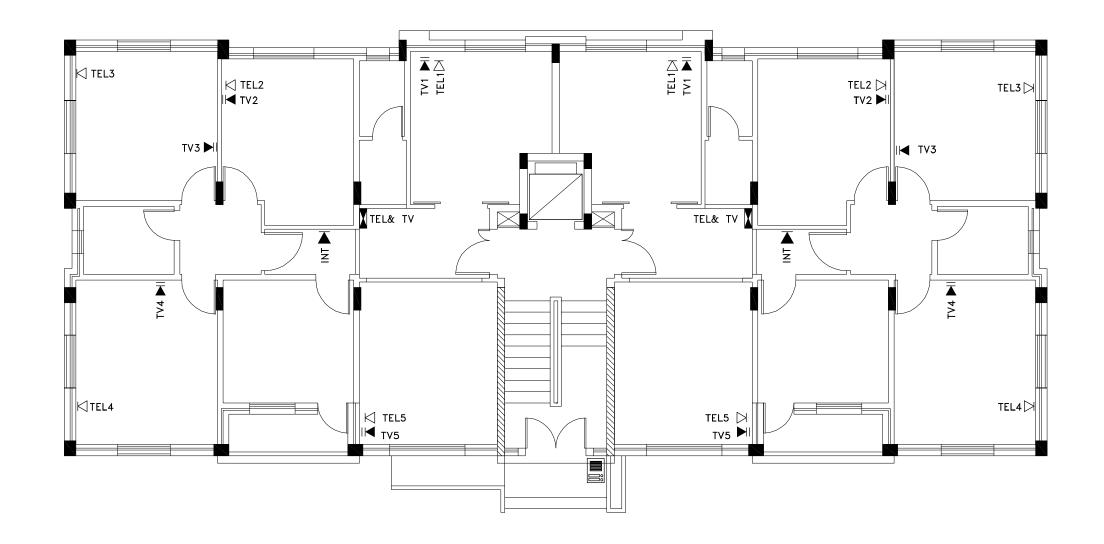


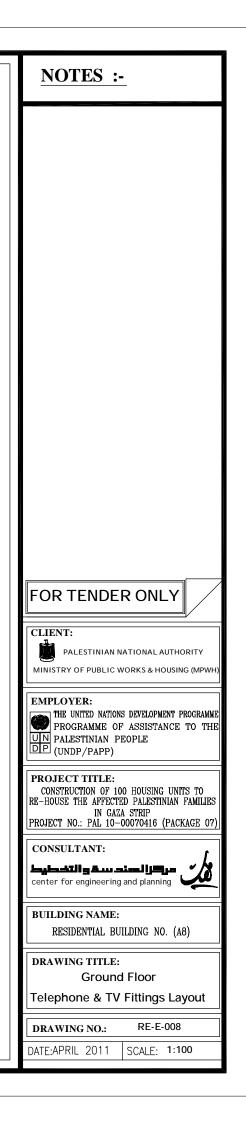


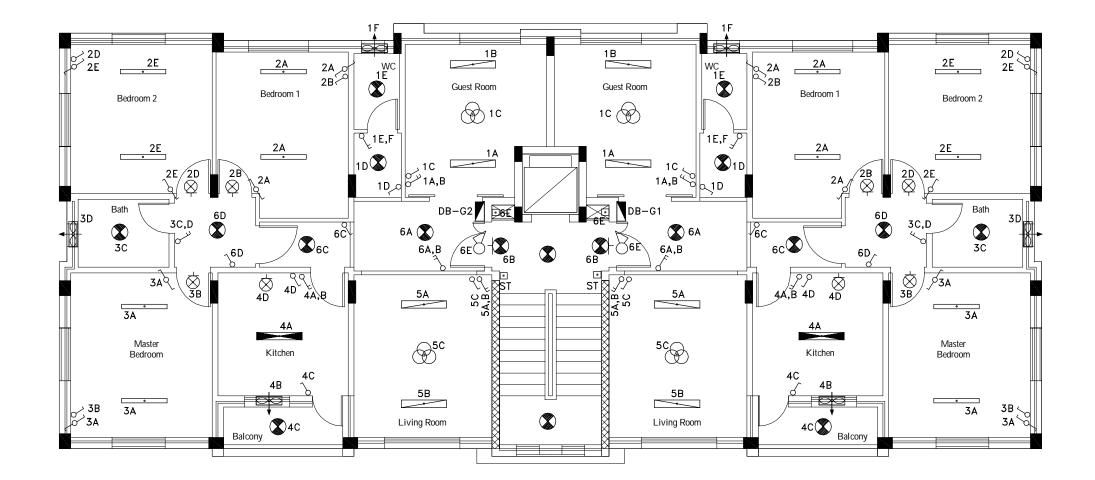


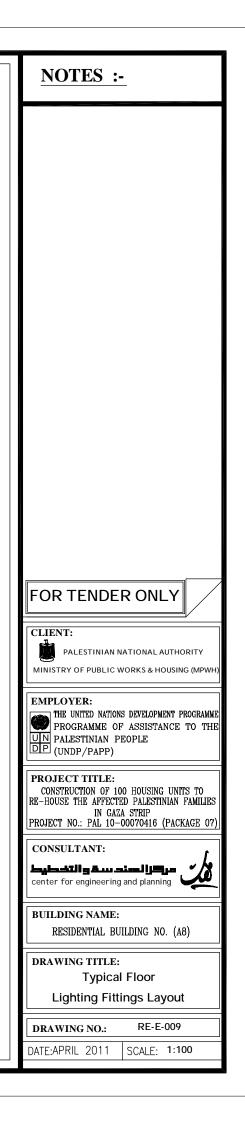


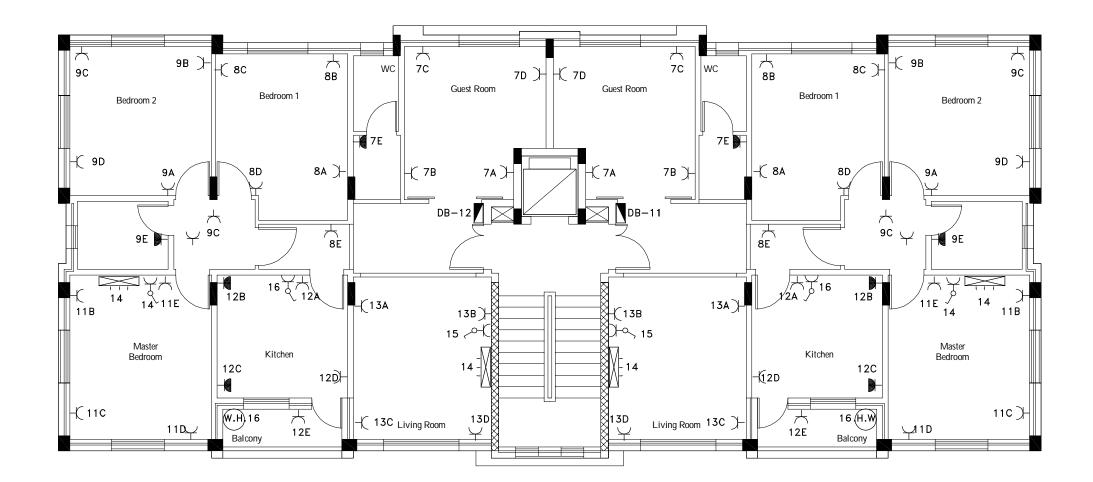


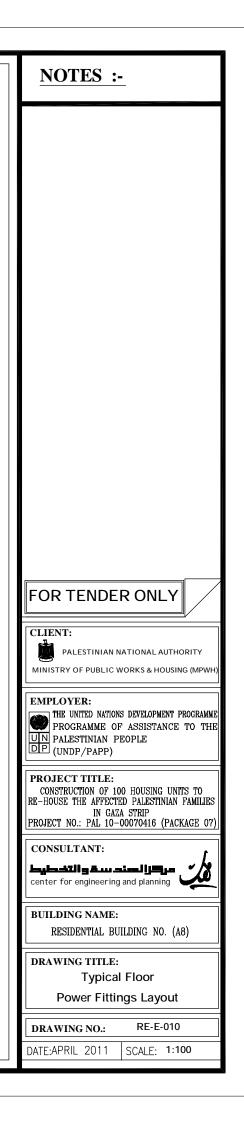


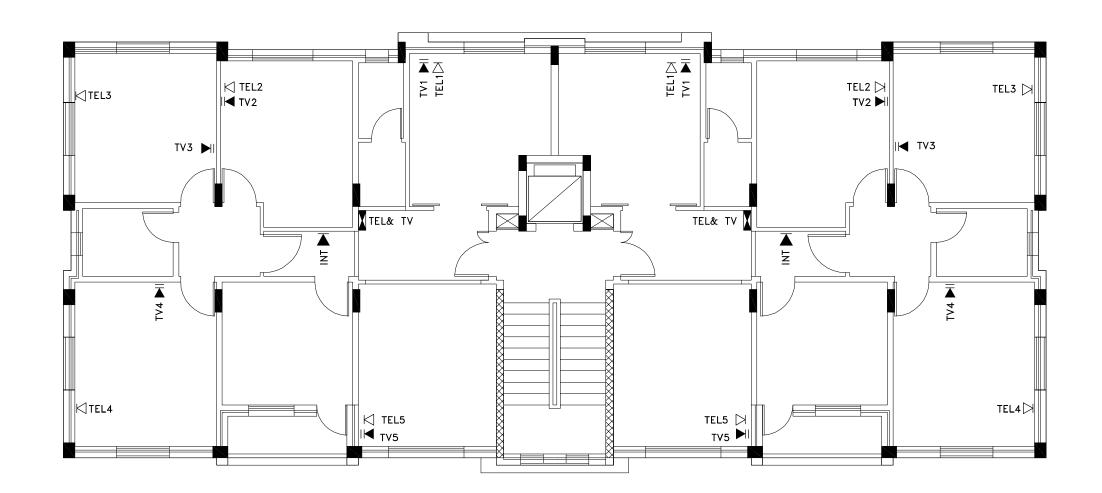


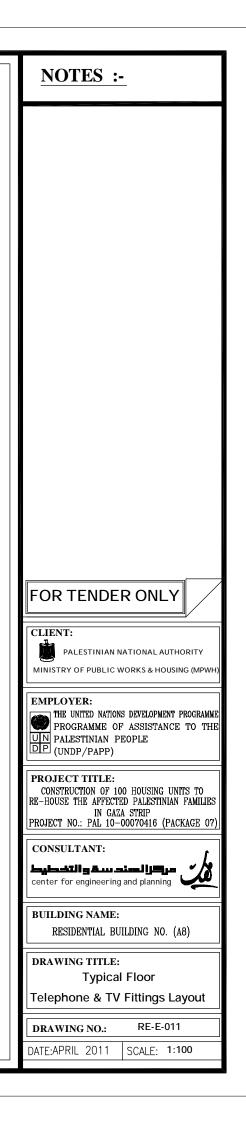


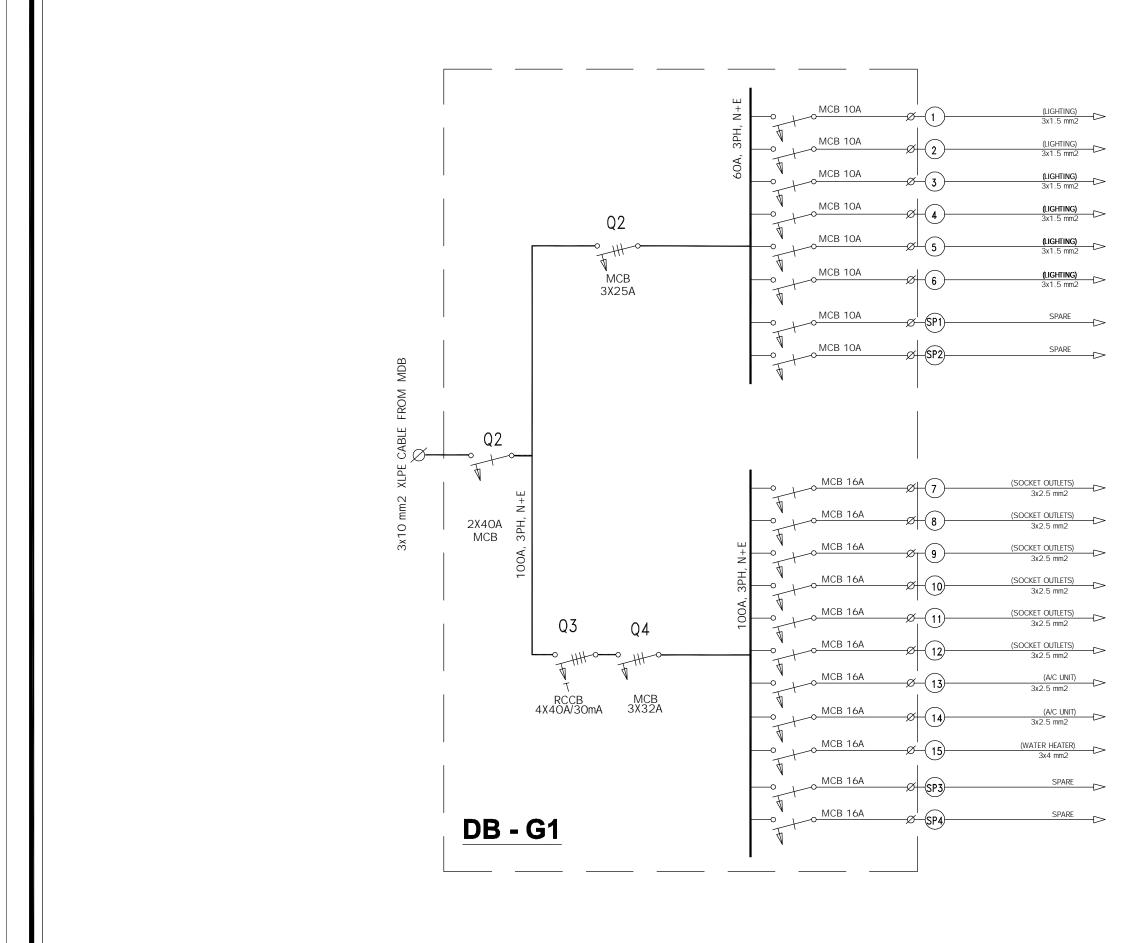


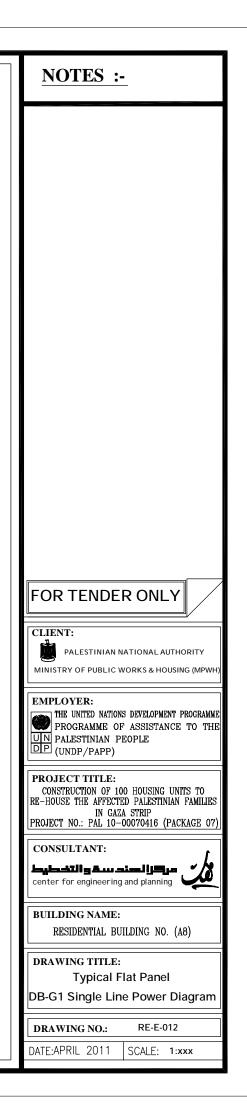


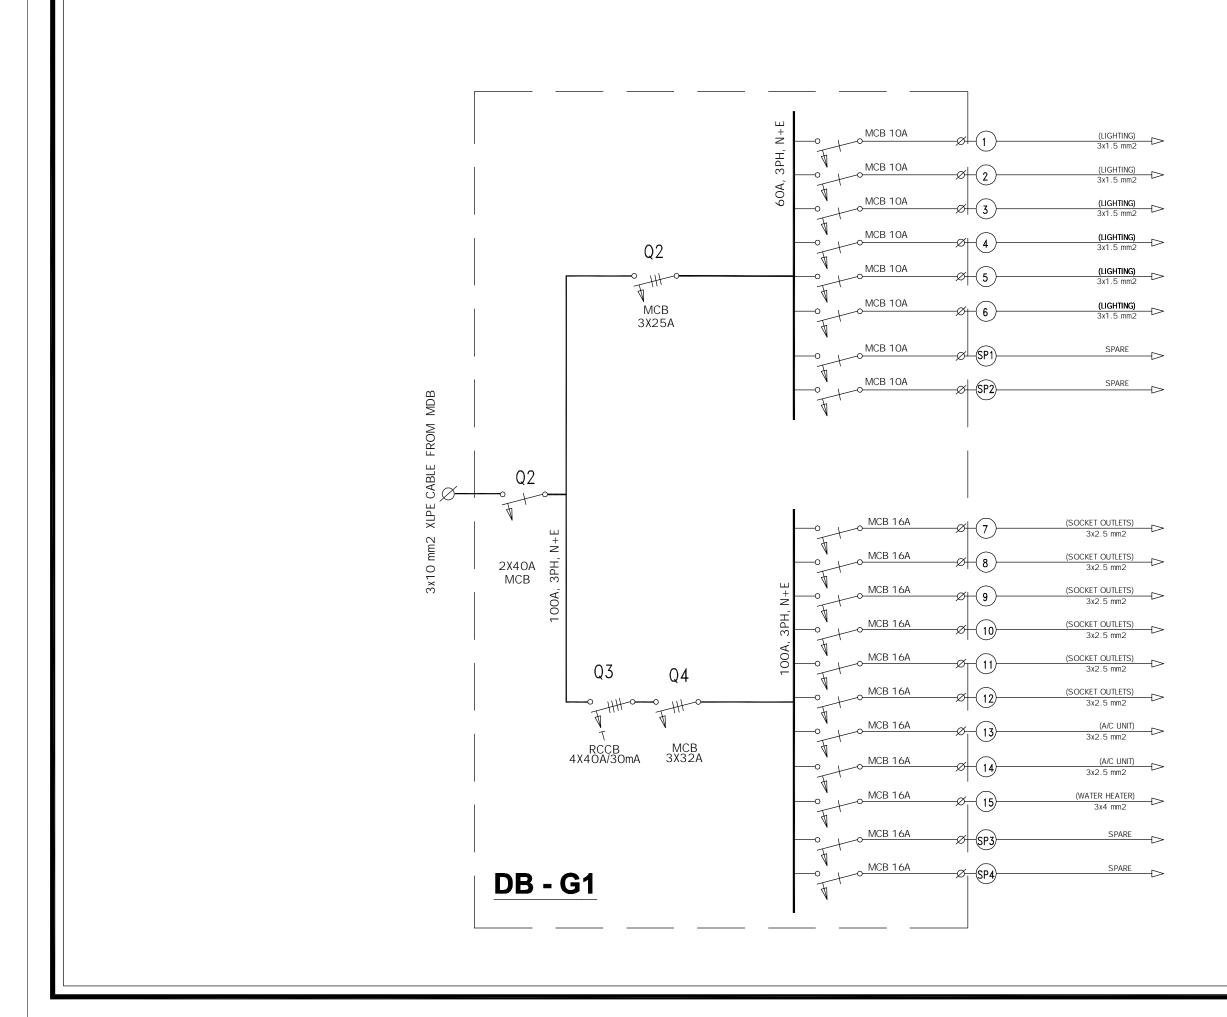


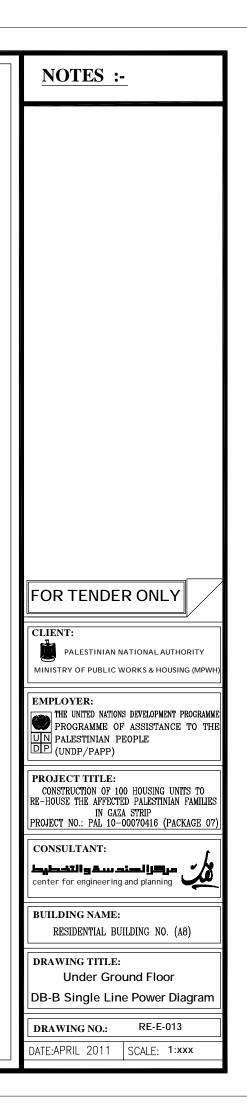


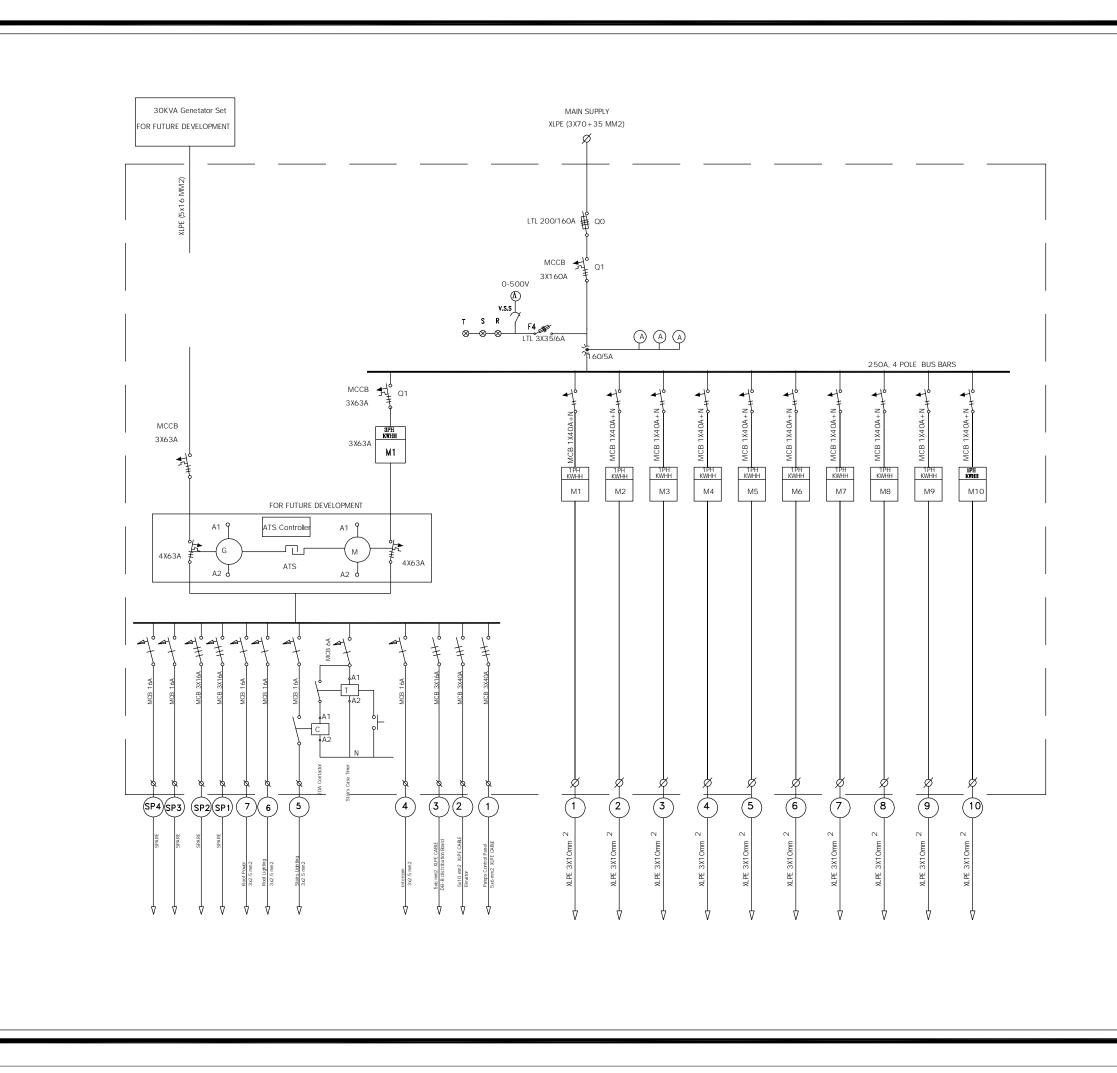


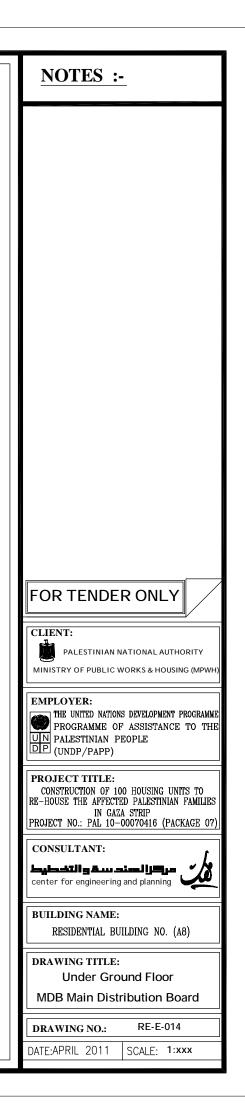


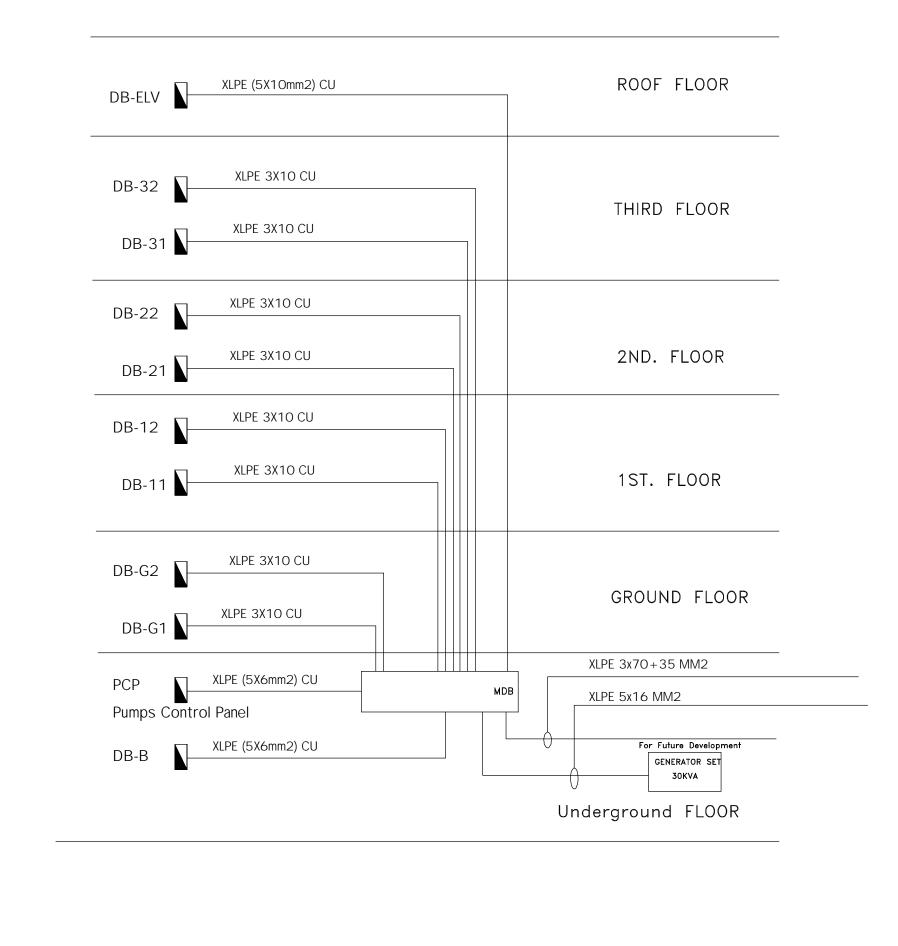

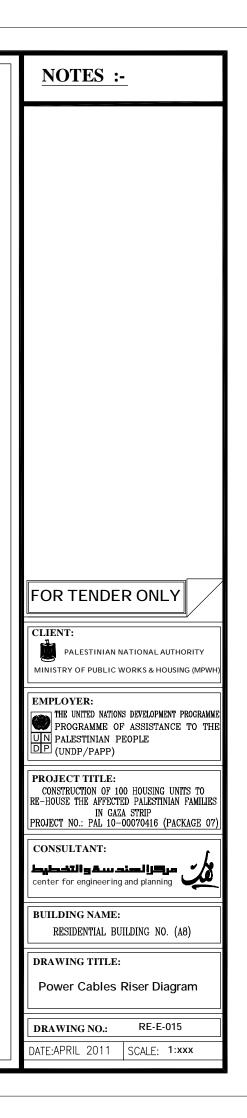

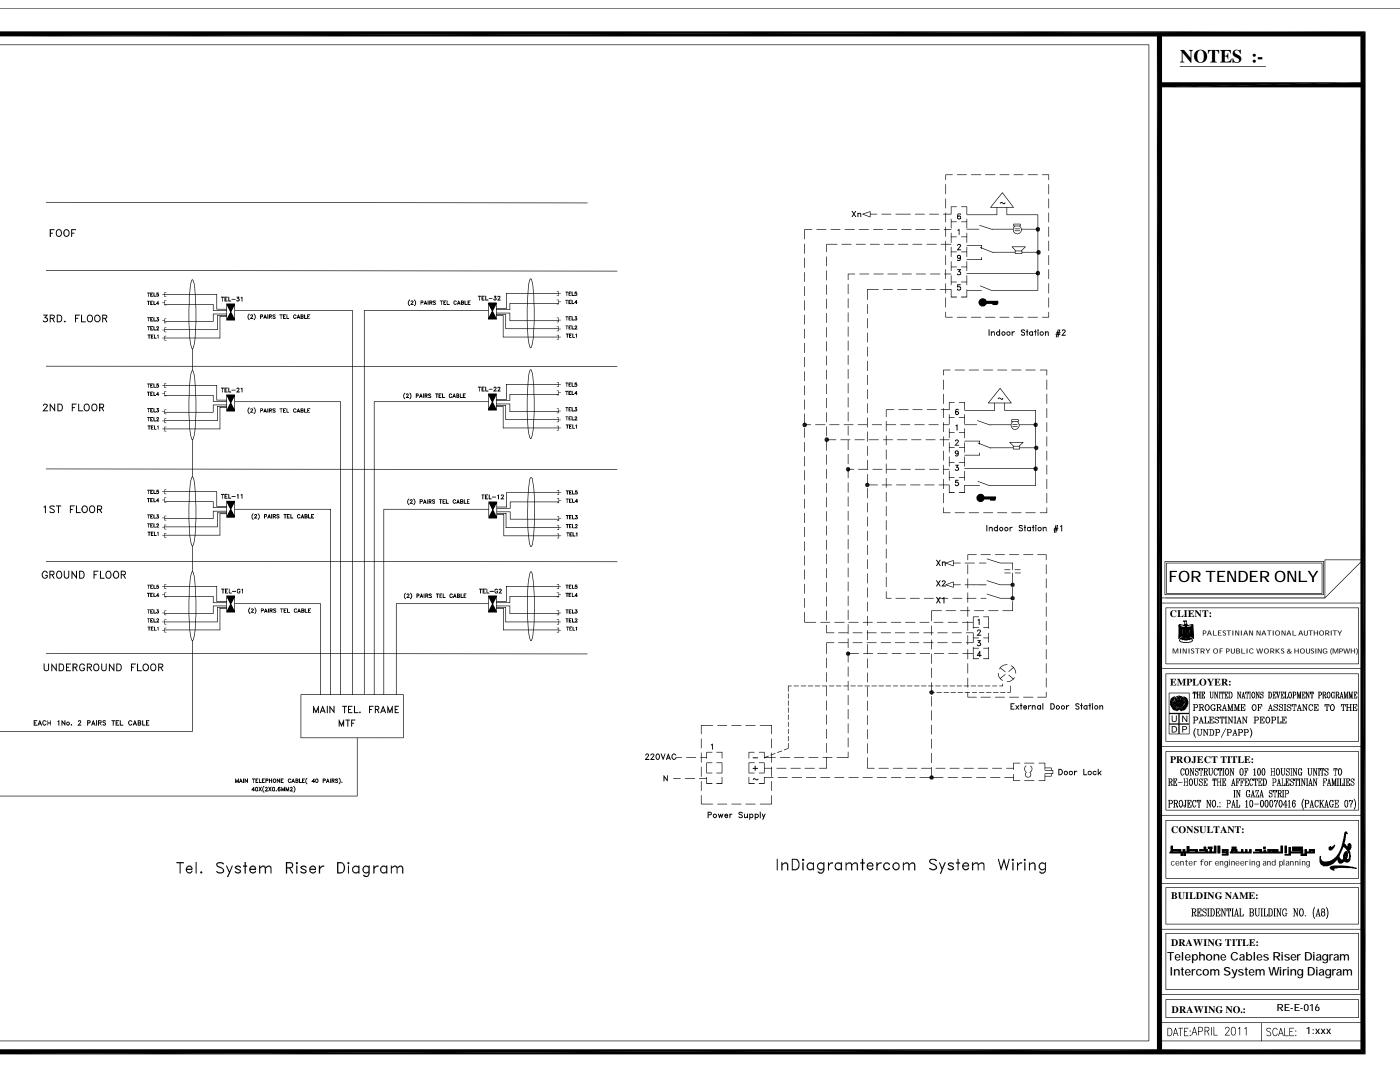

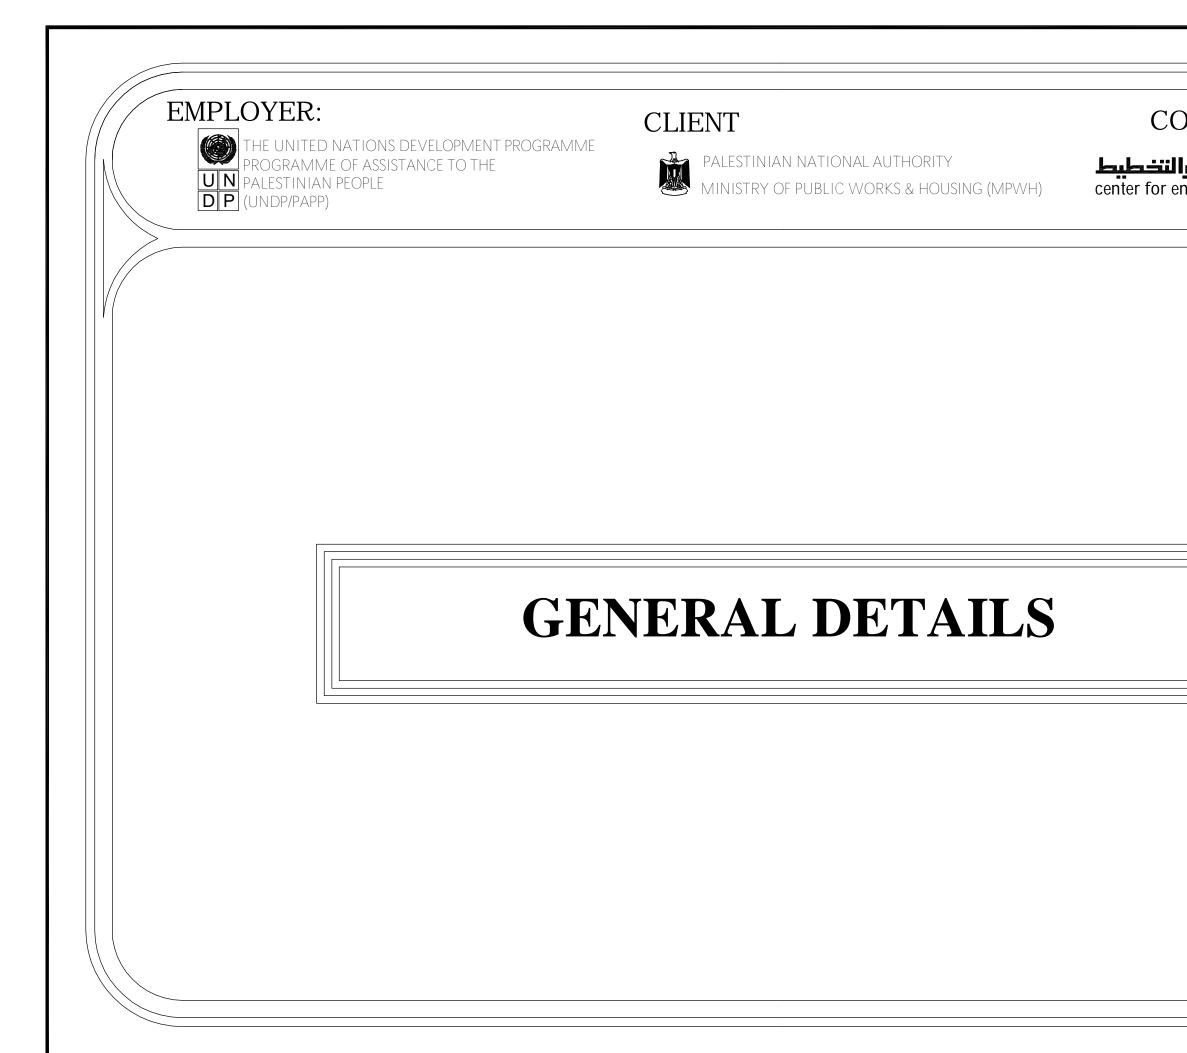

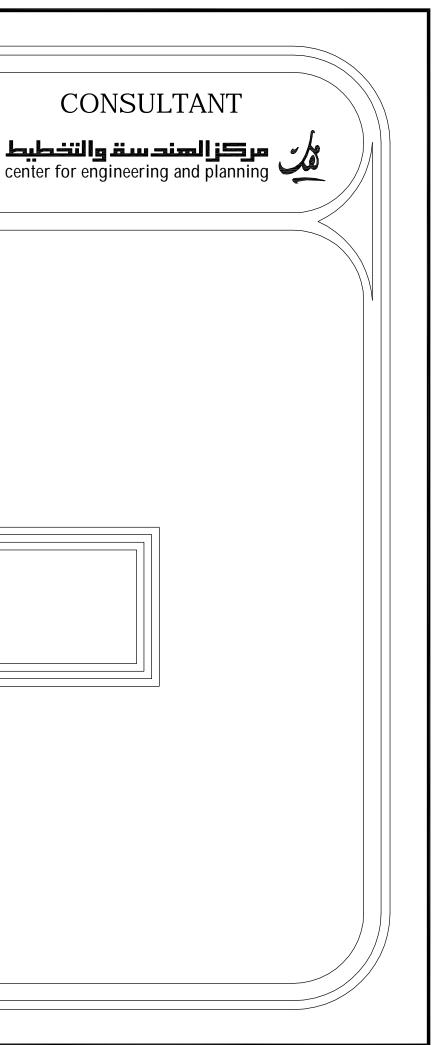




THE UNITED NATIONS DEVELOPMENT PROGRAMME PROGRAMME OF ASSISTANCE TO THE PALESTINIAN PEOPLE DP (UNDP/PAPP)

CLIENT





PALESTINIAN NATIONAL AUTHORITY MINISTRY OF PUBLIC WORKS & HOUSI MINISTRY OF PUBLIC WORKS & HOUSING (MPWH)

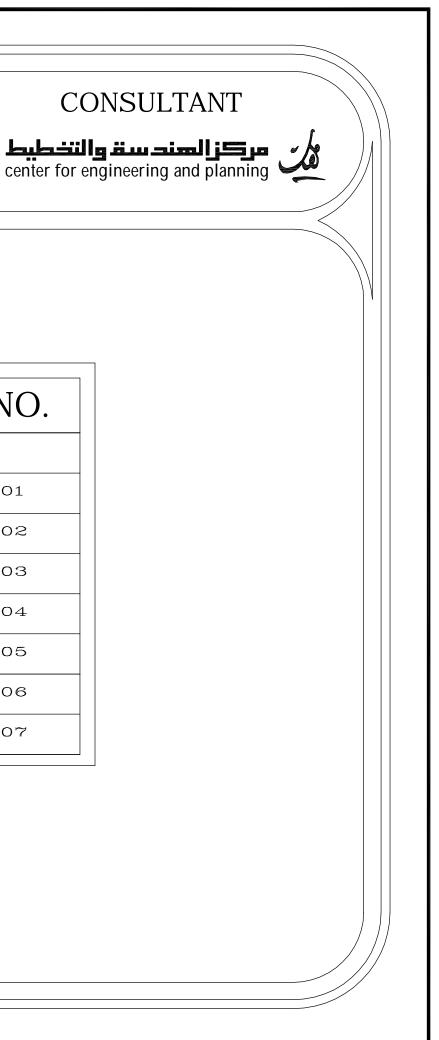



LIST OF DRAWINGS


S/NO.	DRAWING NAME	DRG. NO.		
	GENERAL DETAILS			
01/07	GENERAL DETAILS (1)	RE-GD-001		
02/07	GENERAL DETAILS (2)	RE-GD-002		
03/07	GENERAL DETAILS (3)	RE-GD-003		
04/07	GENERAL DETAILS (4)	RE-GD-004		
05/07	GENERAL DETAILS (5)	RE-GD-005		
06/07	GENERAL DETAILS (6)	RE-GD-006		
07/07	GENERAL DETAILS (7)	RE-GD-007		

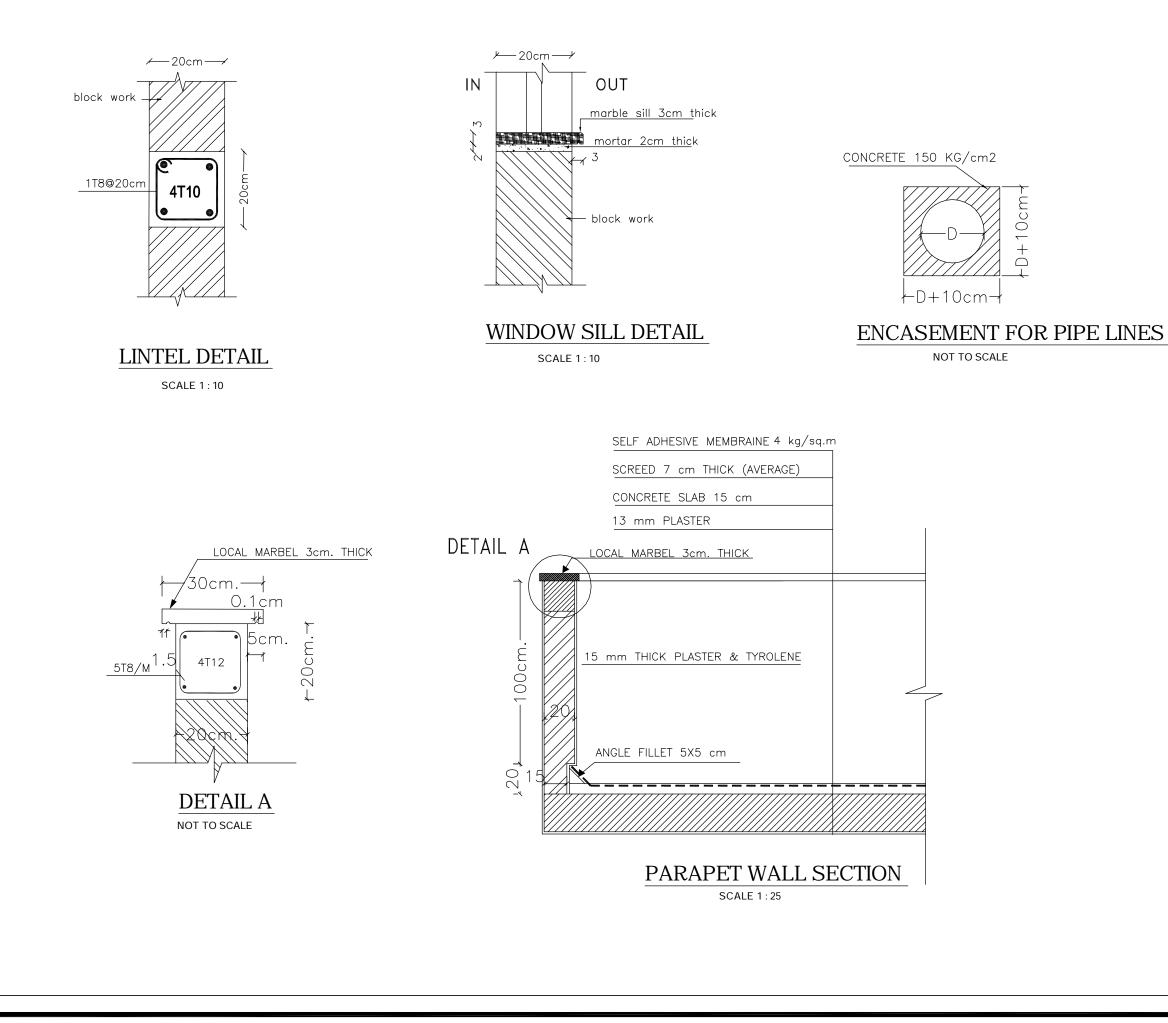


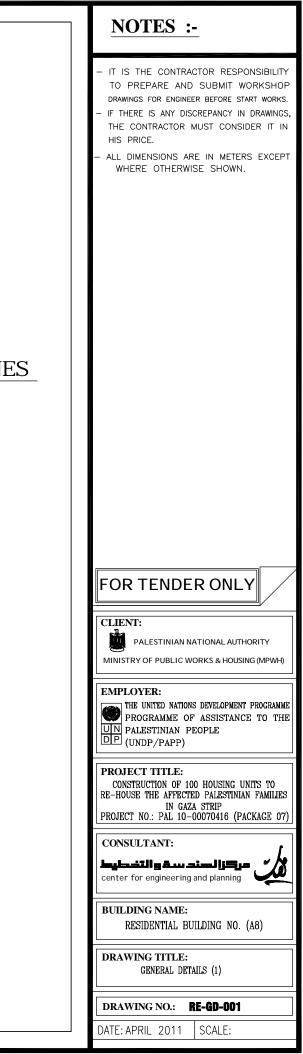


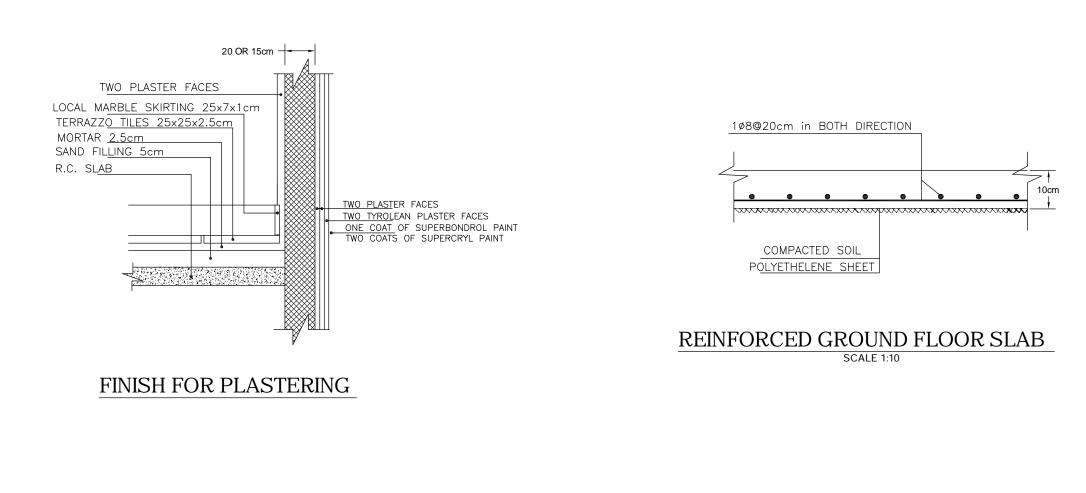


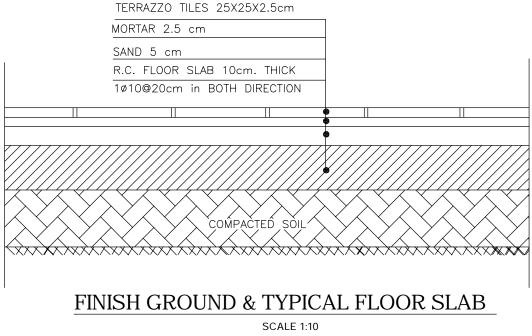


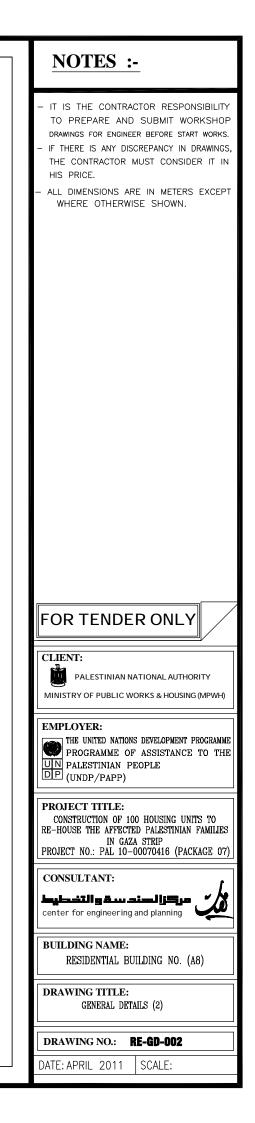


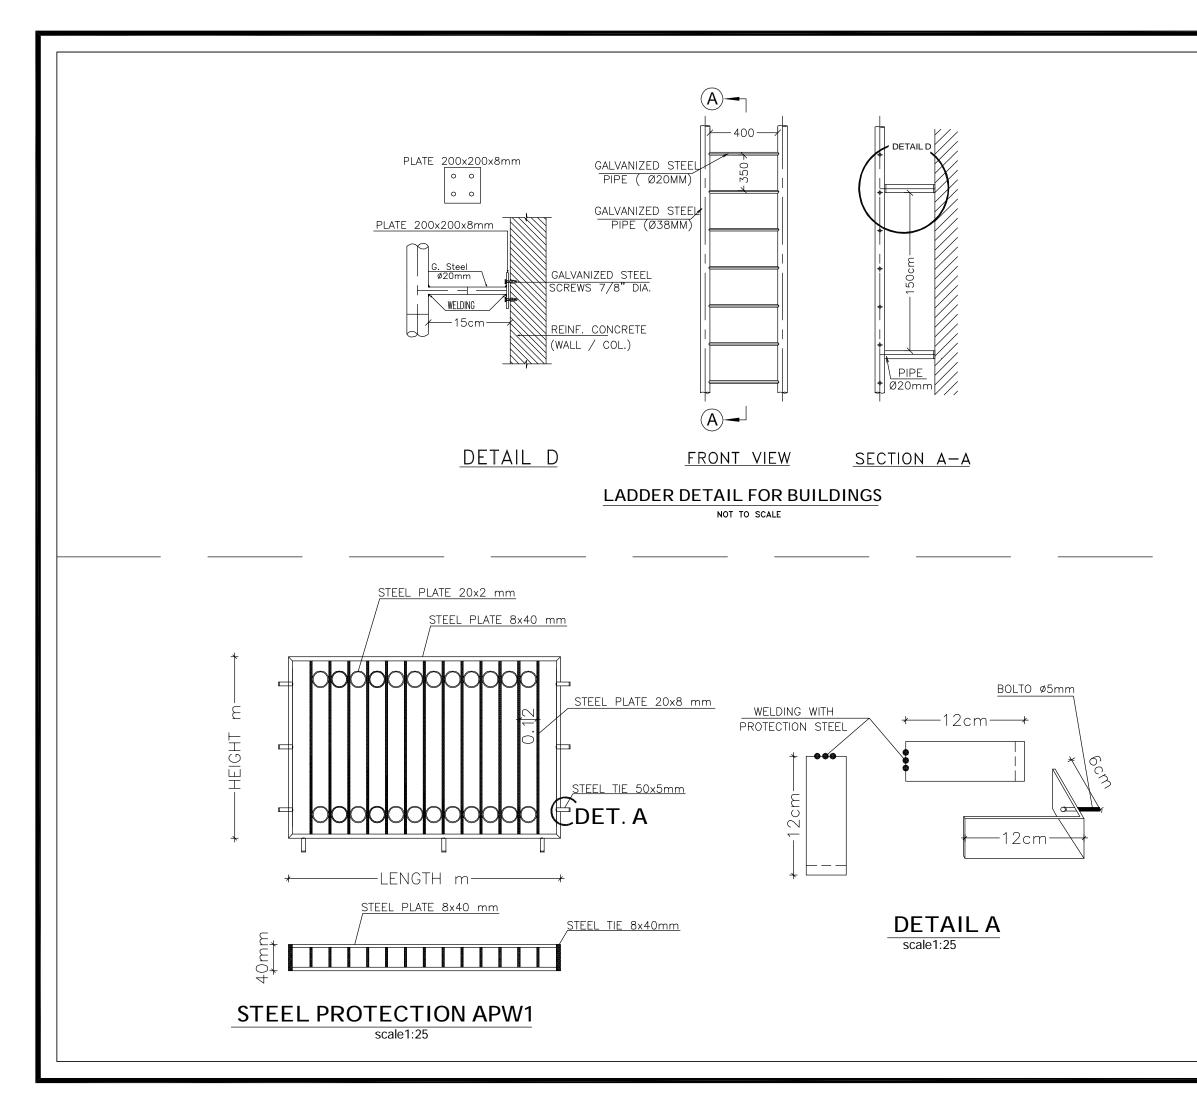


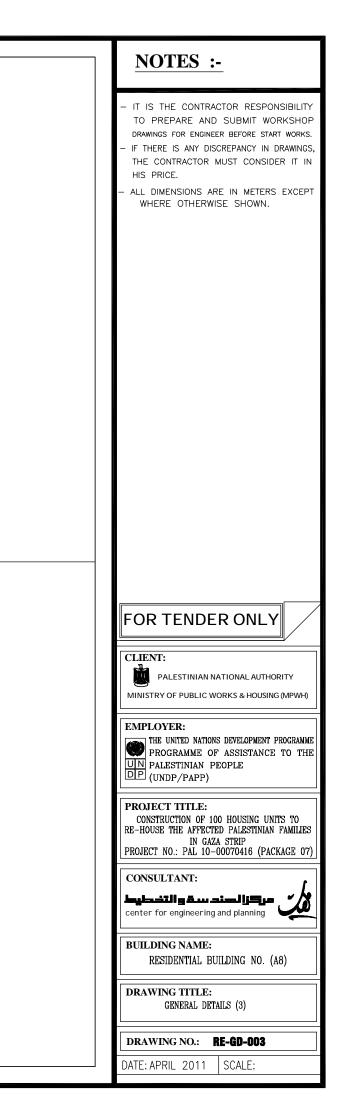

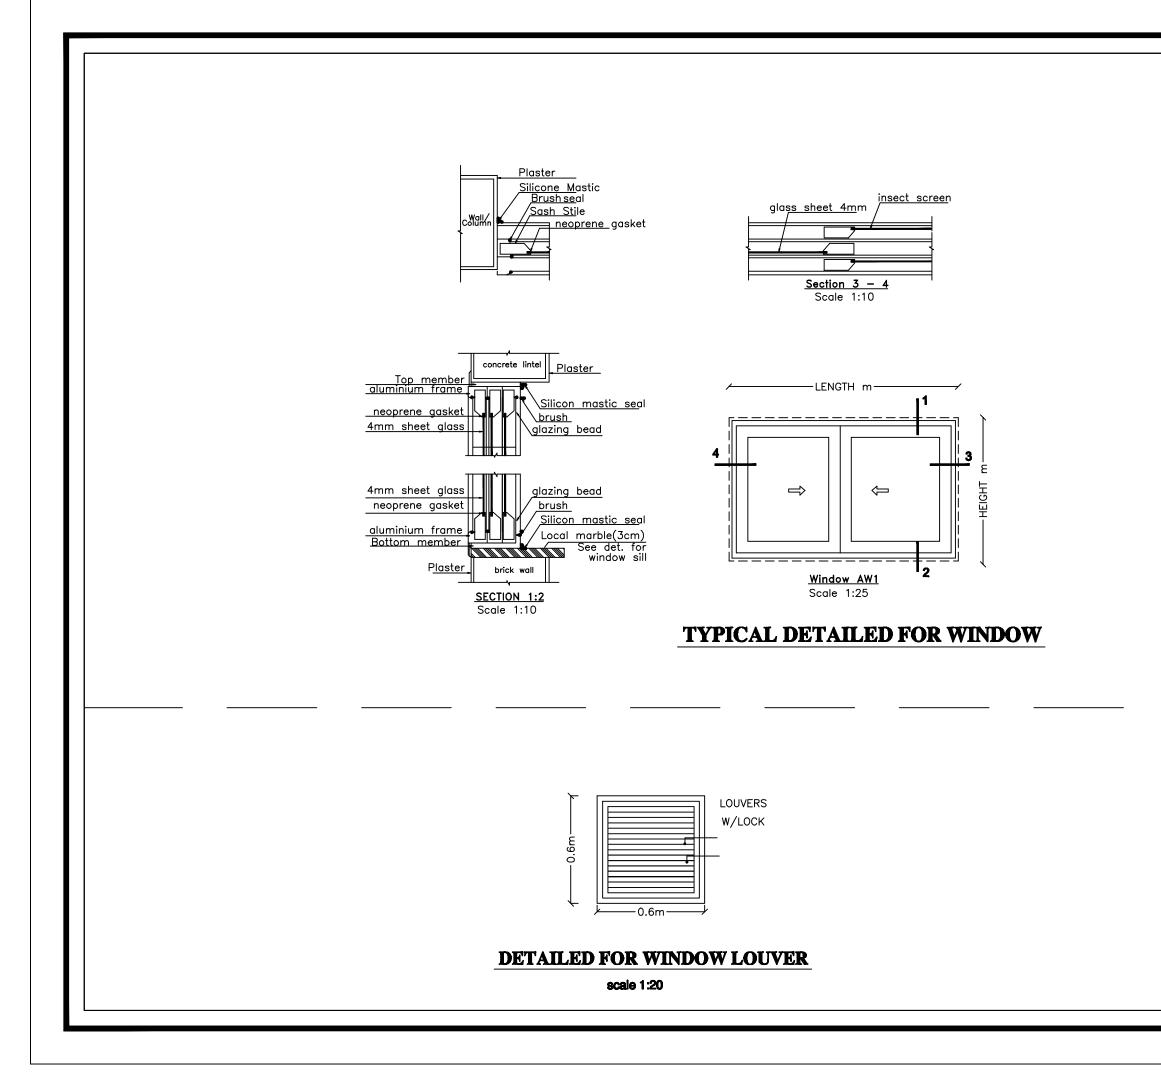

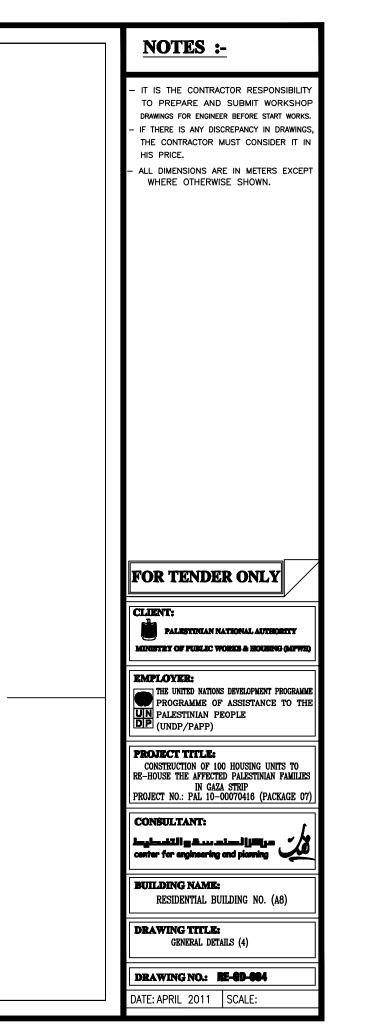

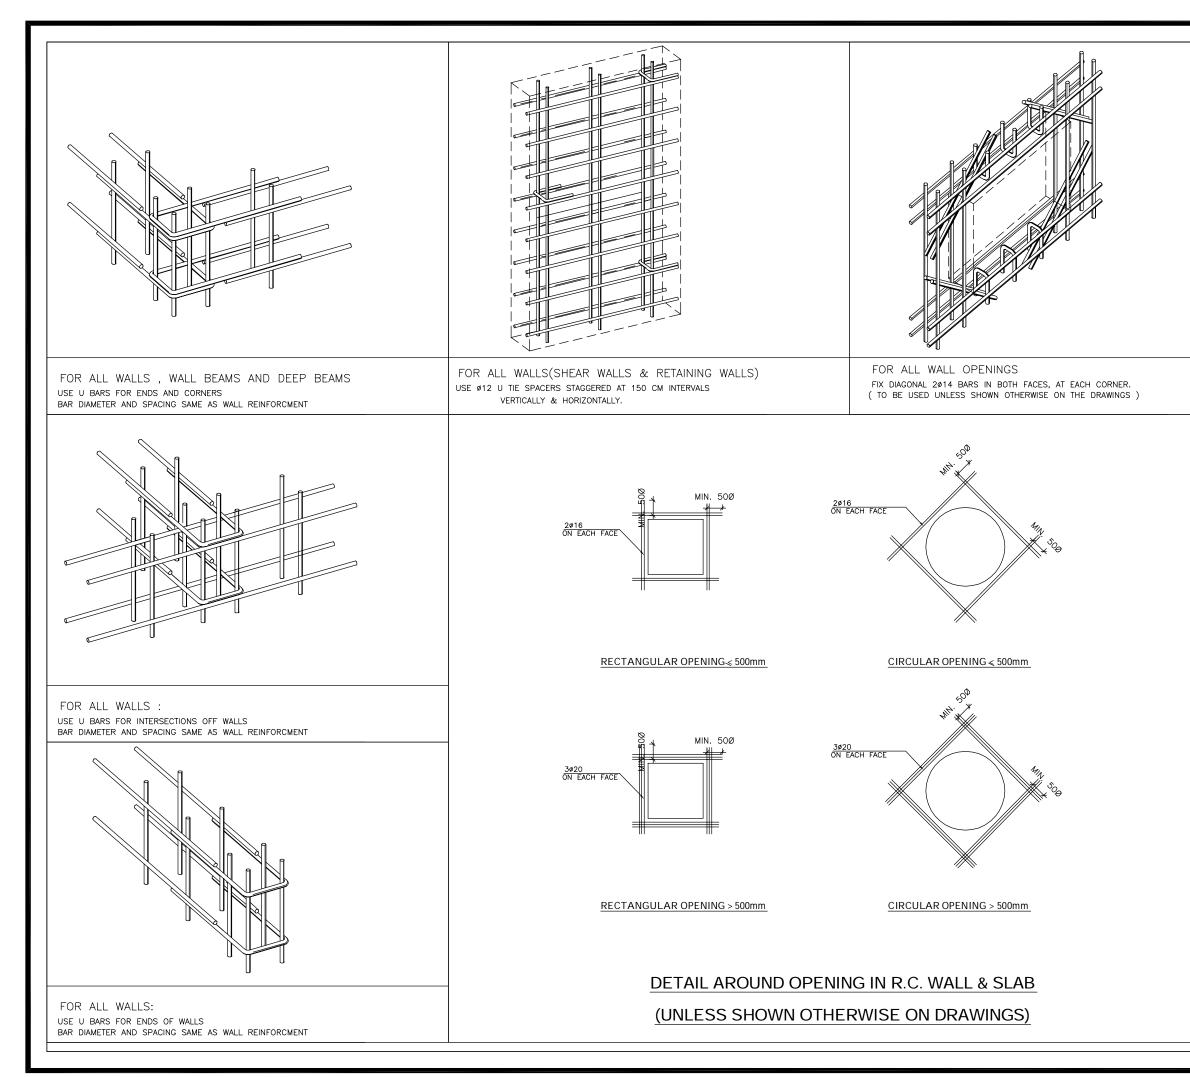

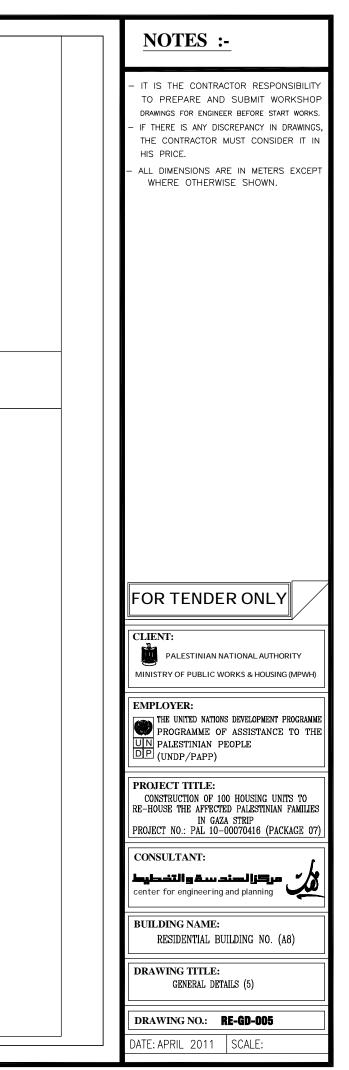

LINTELS DETAILS.

SCHEDULE OF LINTELS REINFORCEMENT										
LINTEL WIDTH	b=10cm.		b=15cm.		b=20cm./30cm.		DEPTH=			
CLEAR SPAN	TOP REINF.	BOTTOM REINF.	TOP REINF.	BOTTOM REINF.	TOP REINF.	BOTTOM REINF.	d	STIRRUPS		
< 200	1T12	1⊤14	2T12	2T12	2T12	2T14	20	1ø8@200mm		
200-300	1T12	1T14	2T12	2T14	2T12	2T16	25	1ø8@200mm		
301-400	1T12	1T16	2T12	2T14	2T12	2T16	30	1ø8@200mm		
401-500	1T12	1T16	2T14	2T16	2T14	2T20	35	1ø8@200mm		
501-600	1T14	1T20	2T14	2T16	2T14	2T20	40	1ø8@200mm		
601-700	1T14	1T20	2T14	2T20	2T14	2T20	50	1ø8@200mm		
701-800	1T14	1T20	2T16	2T20	2T16	3T20	55	1ø8@200mm		

