

United Nations Development Programme
Programme of Assisstance the Palestinian People





Project Name

RIGHT TO EDUCATION

LOT NO. 1-A - WBS 1150



United Nations Development Programme
Programme of Assisstance the Palestinian People





Project Name


RIGHT TO EDUCATION


School name


Khan Younis Secondary Girls School


March 2015


Architectural Drawings

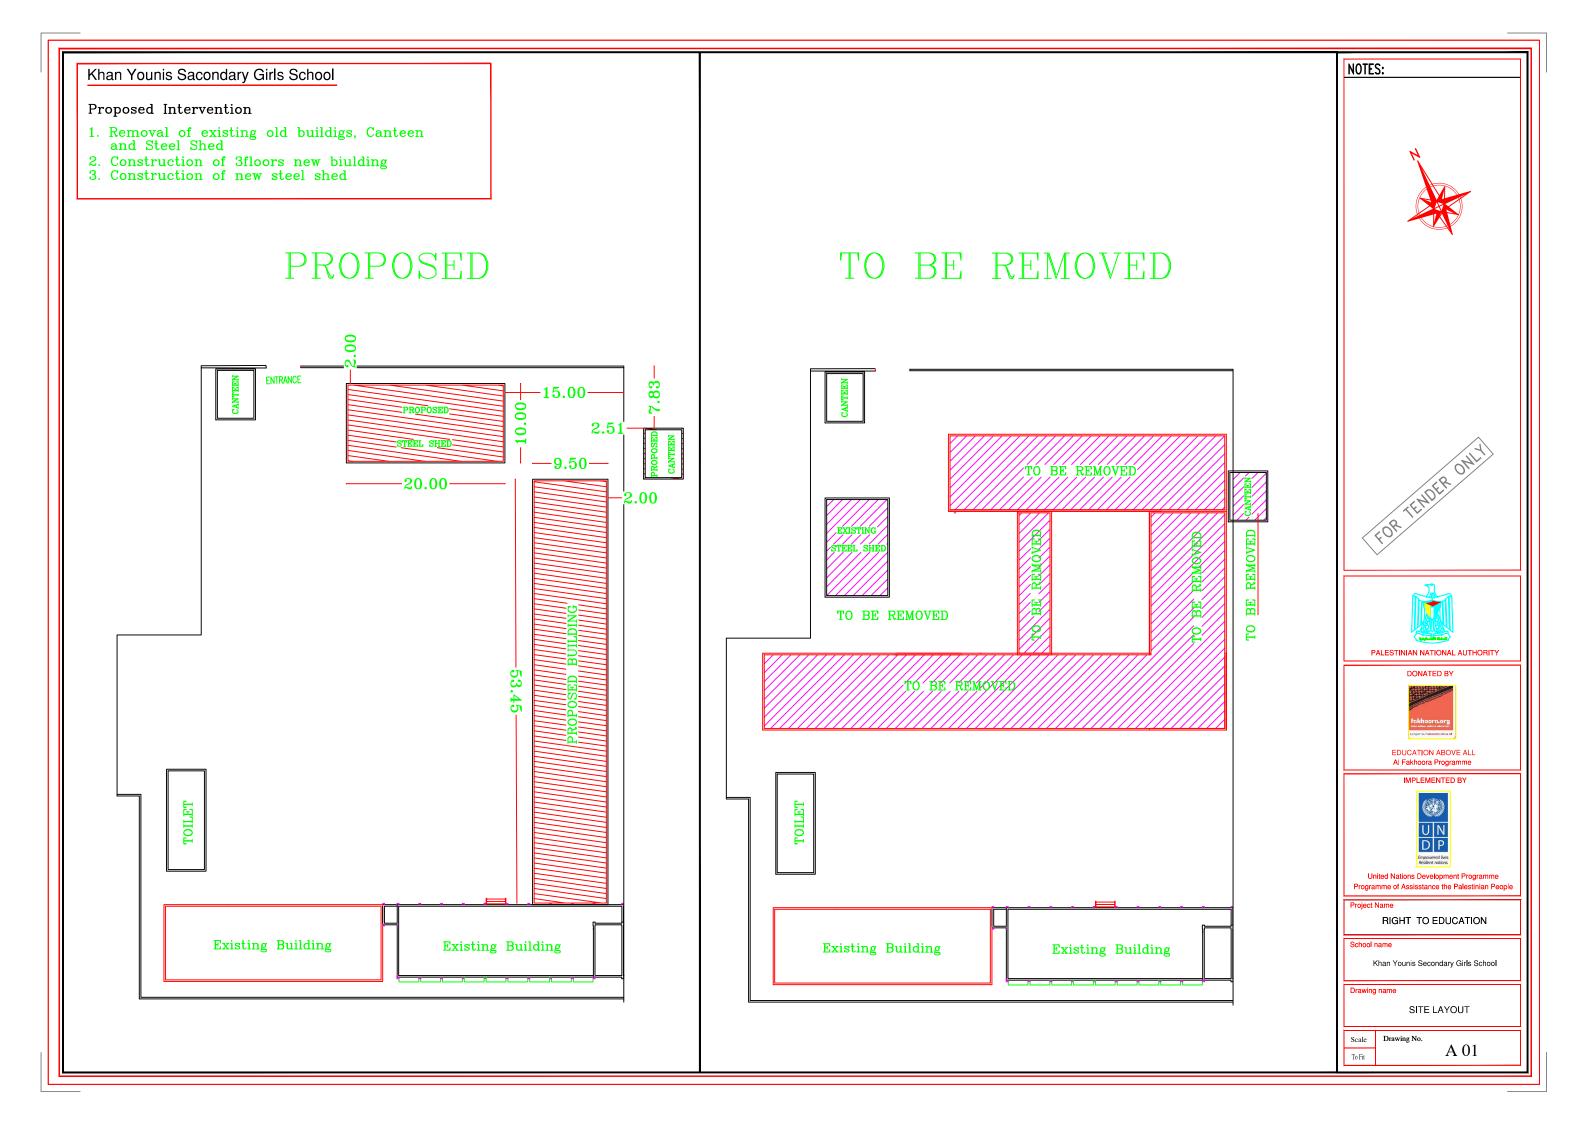

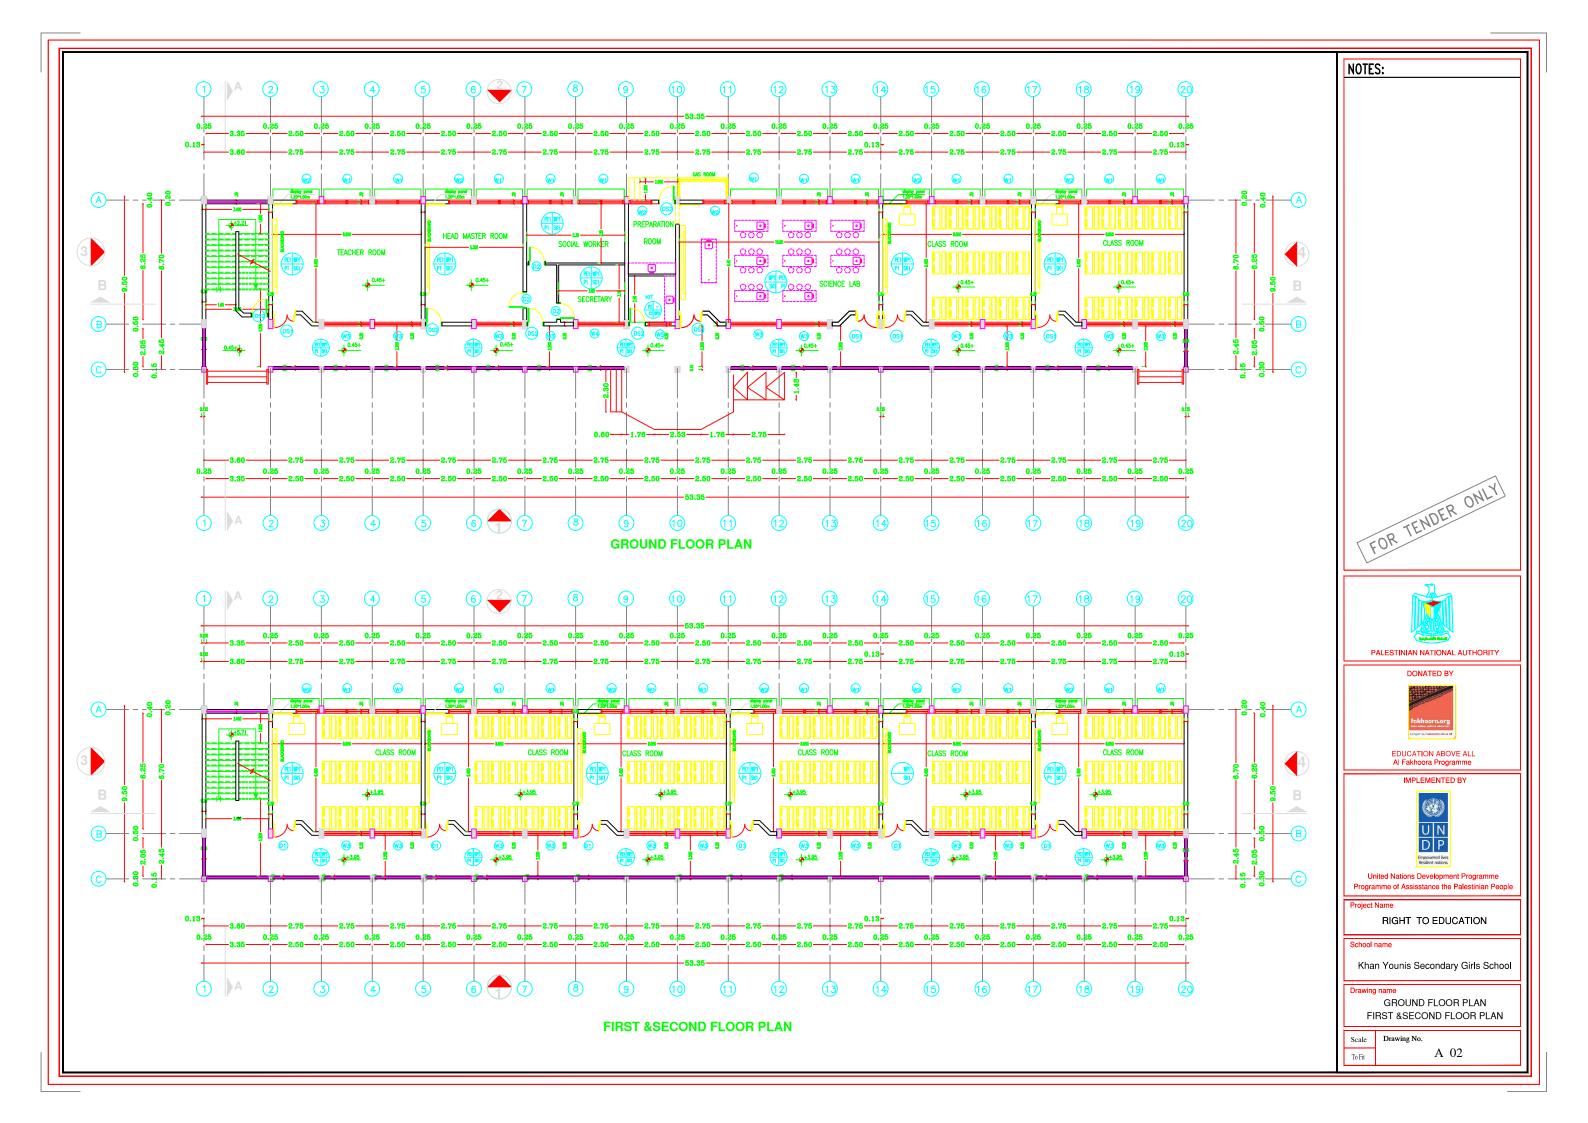

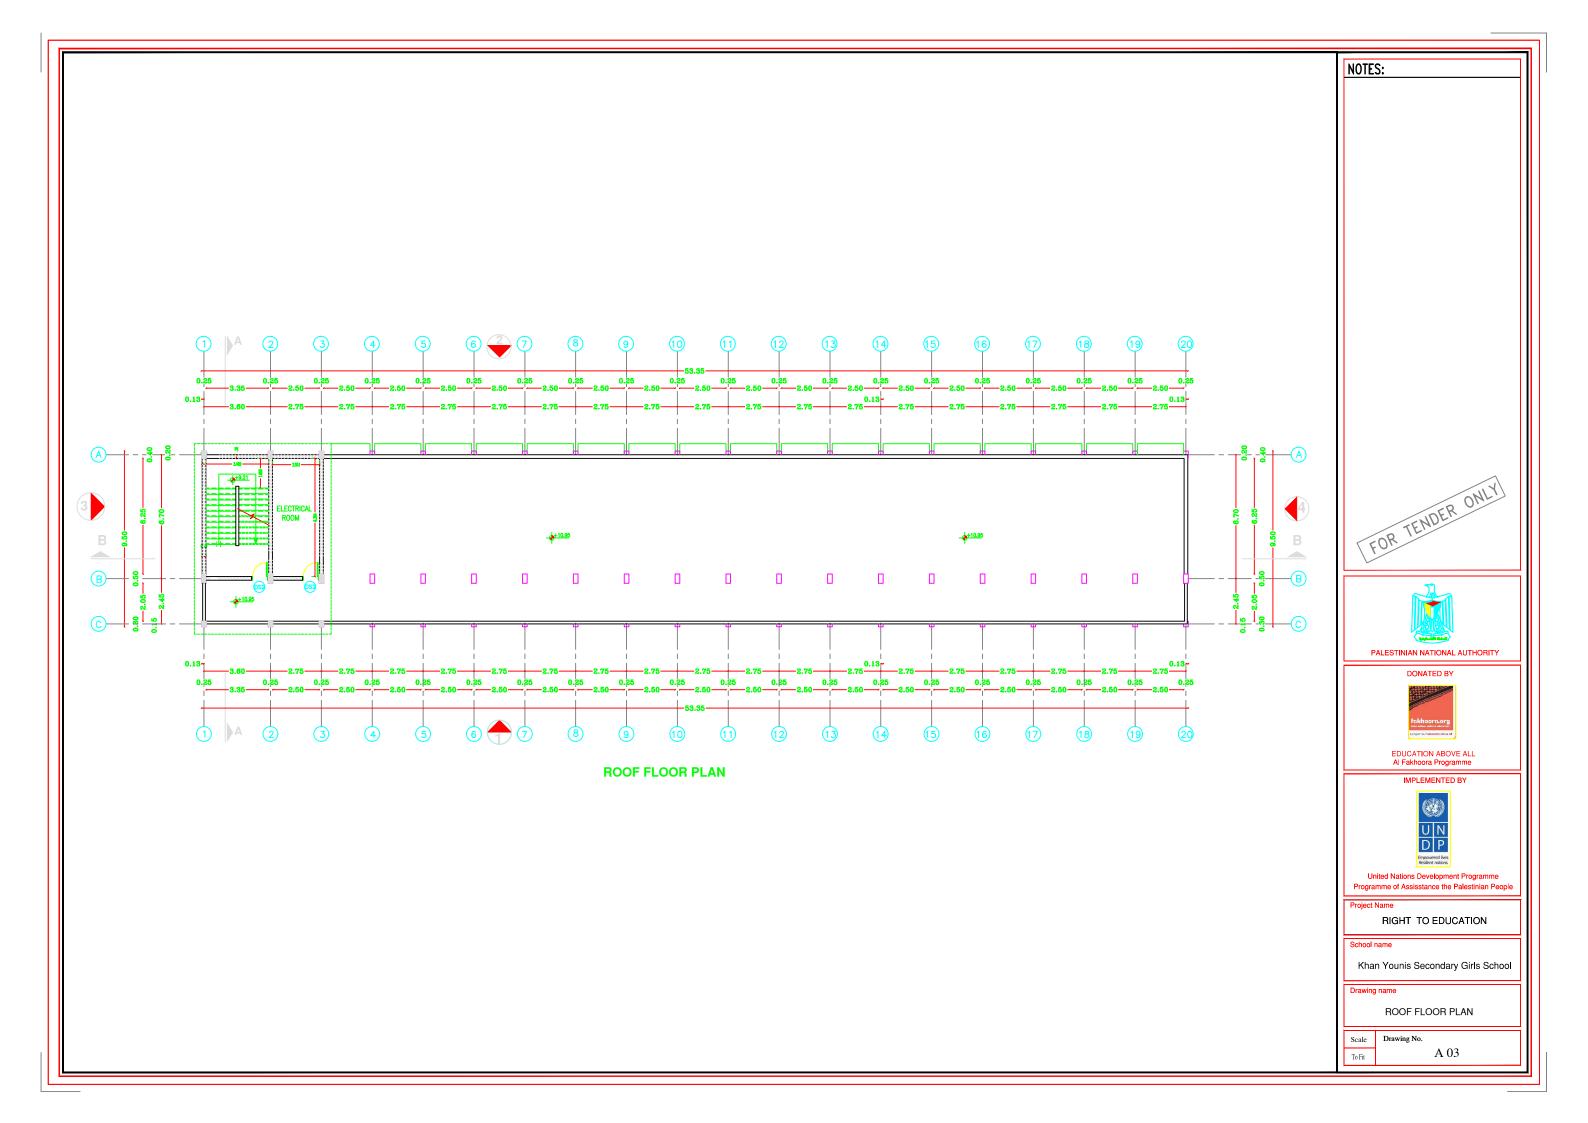


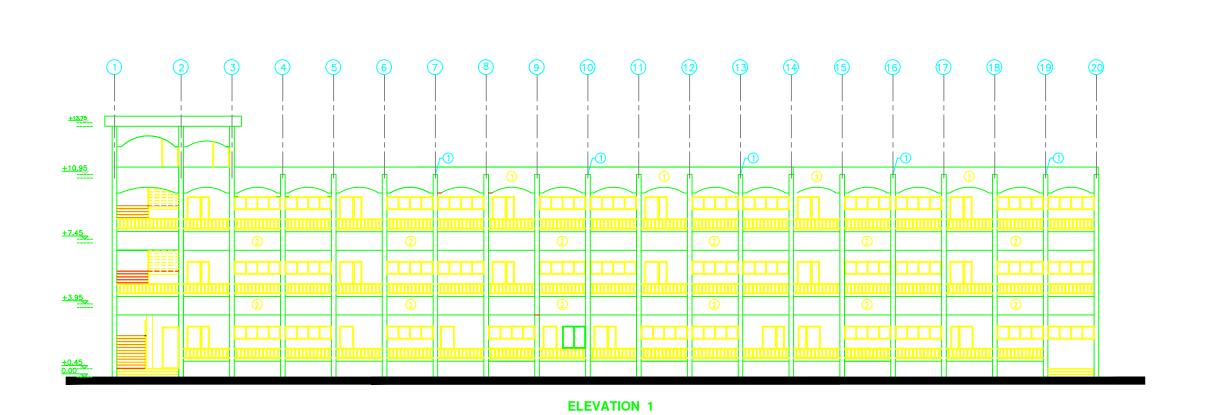

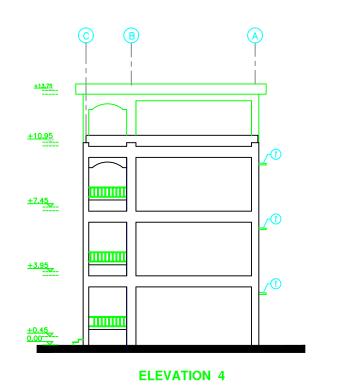






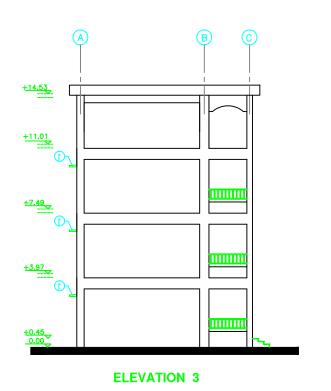






NOTES:

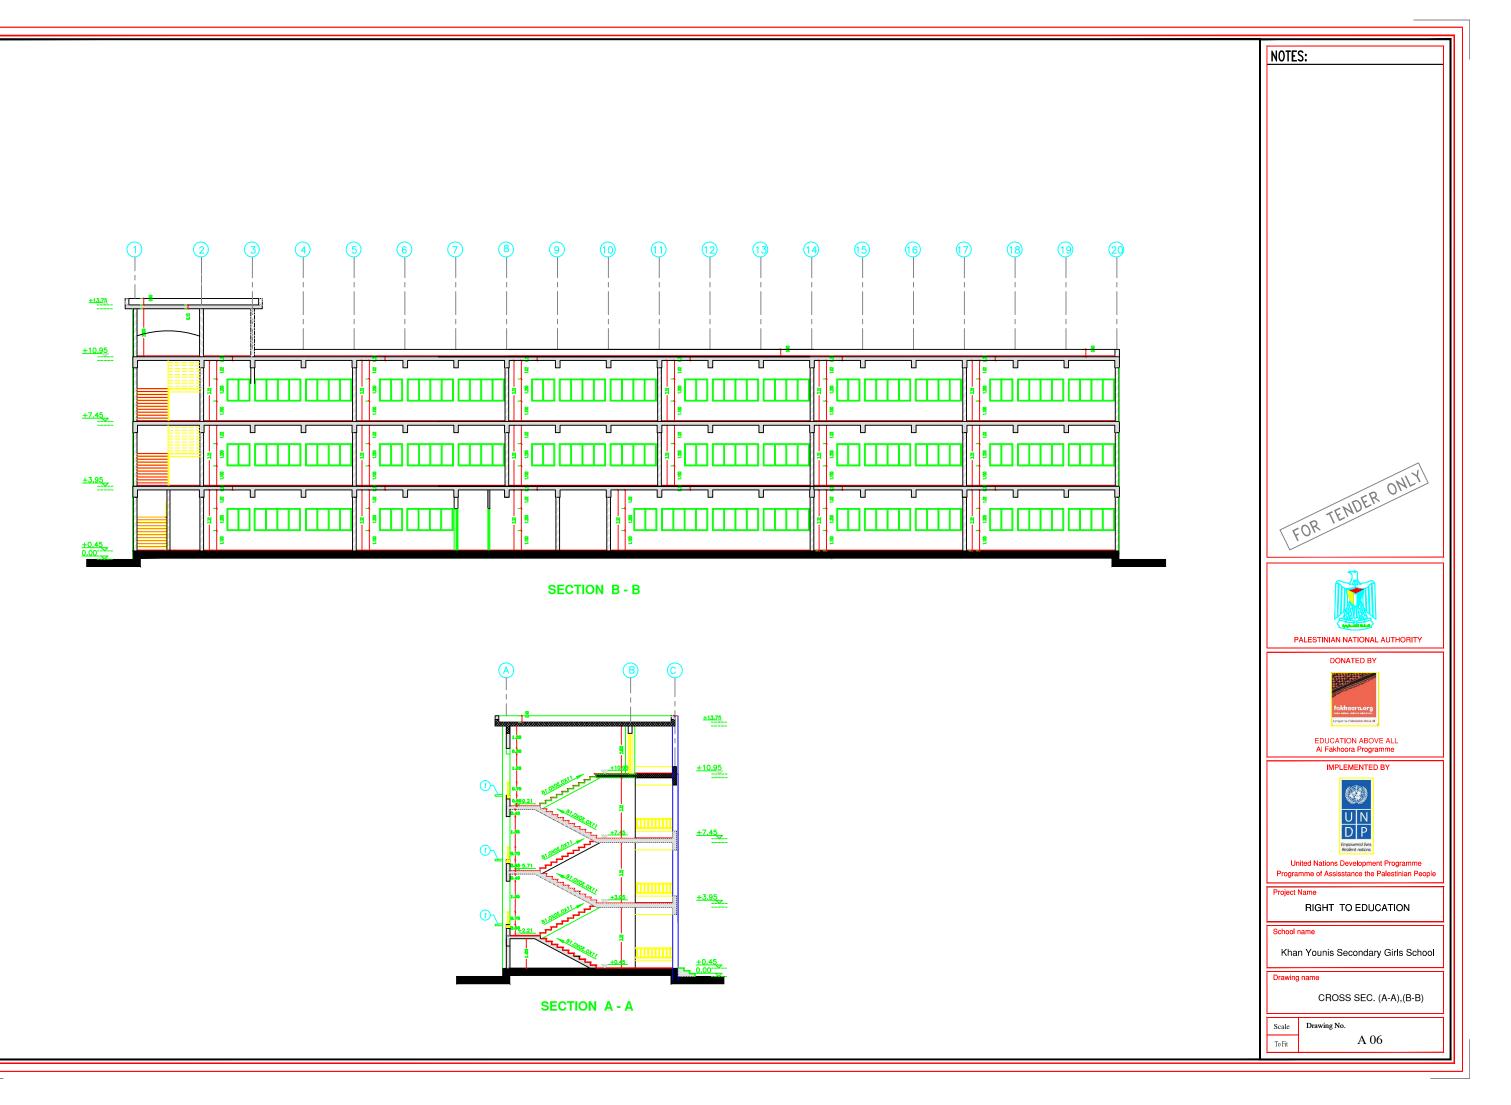


Structural Drawings

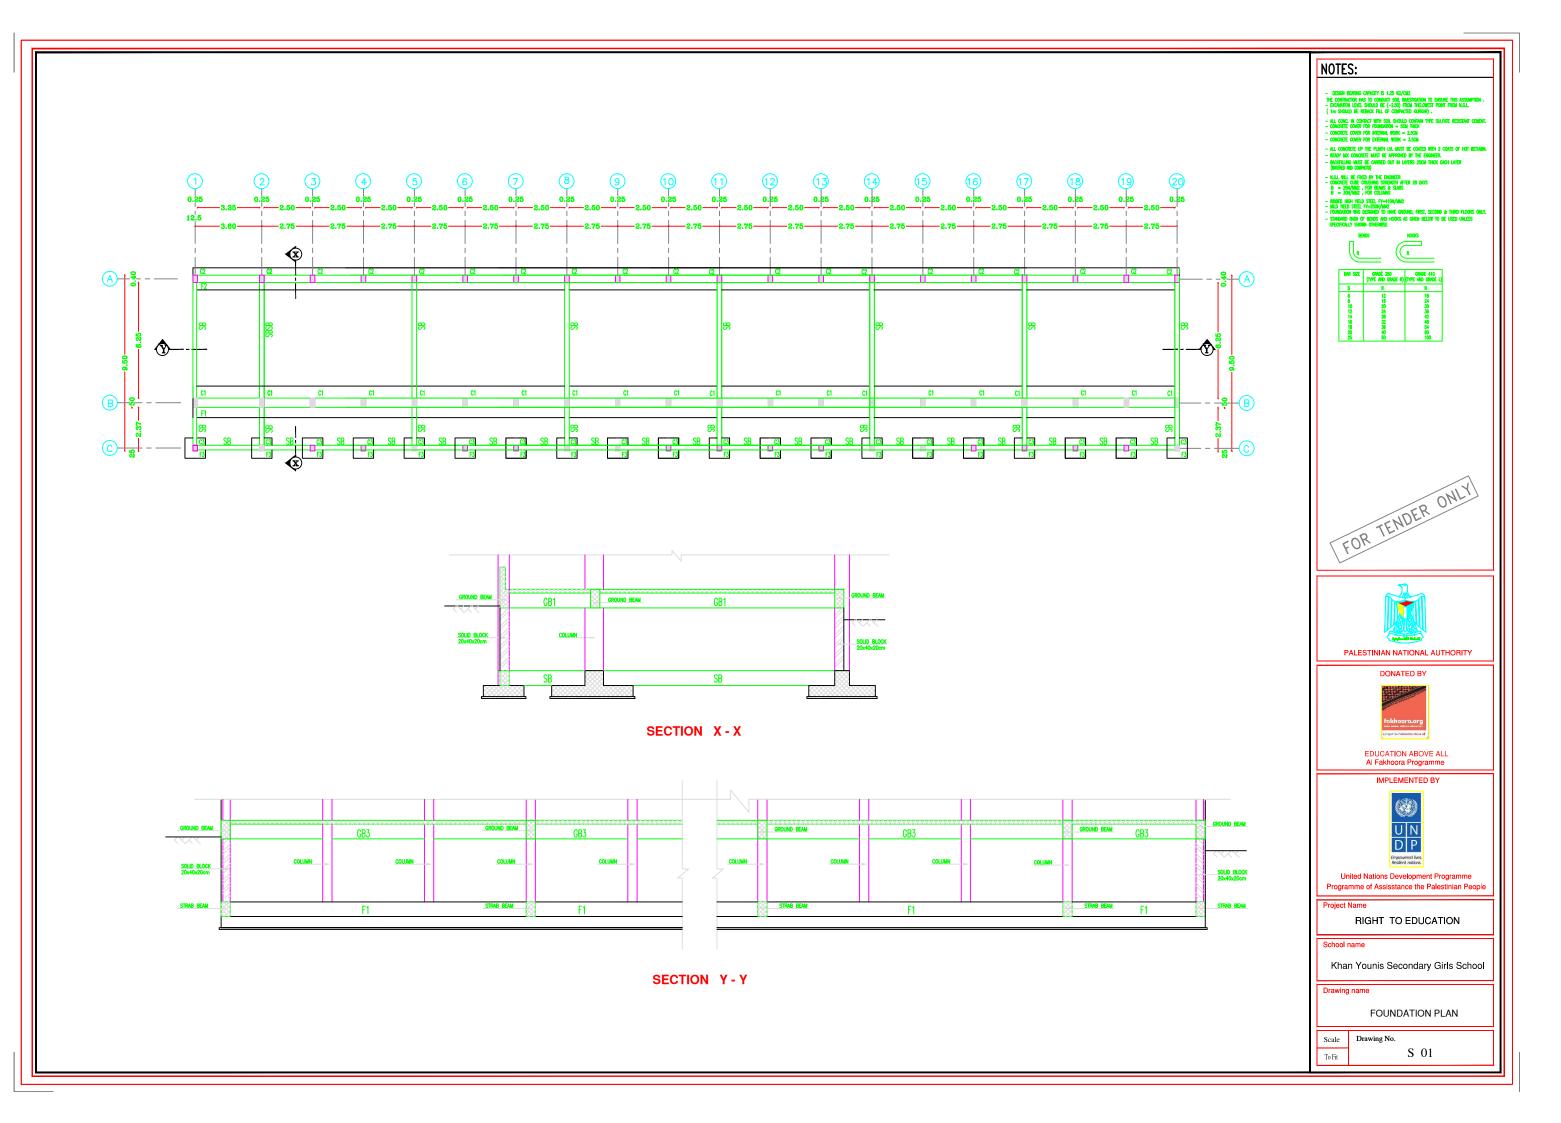


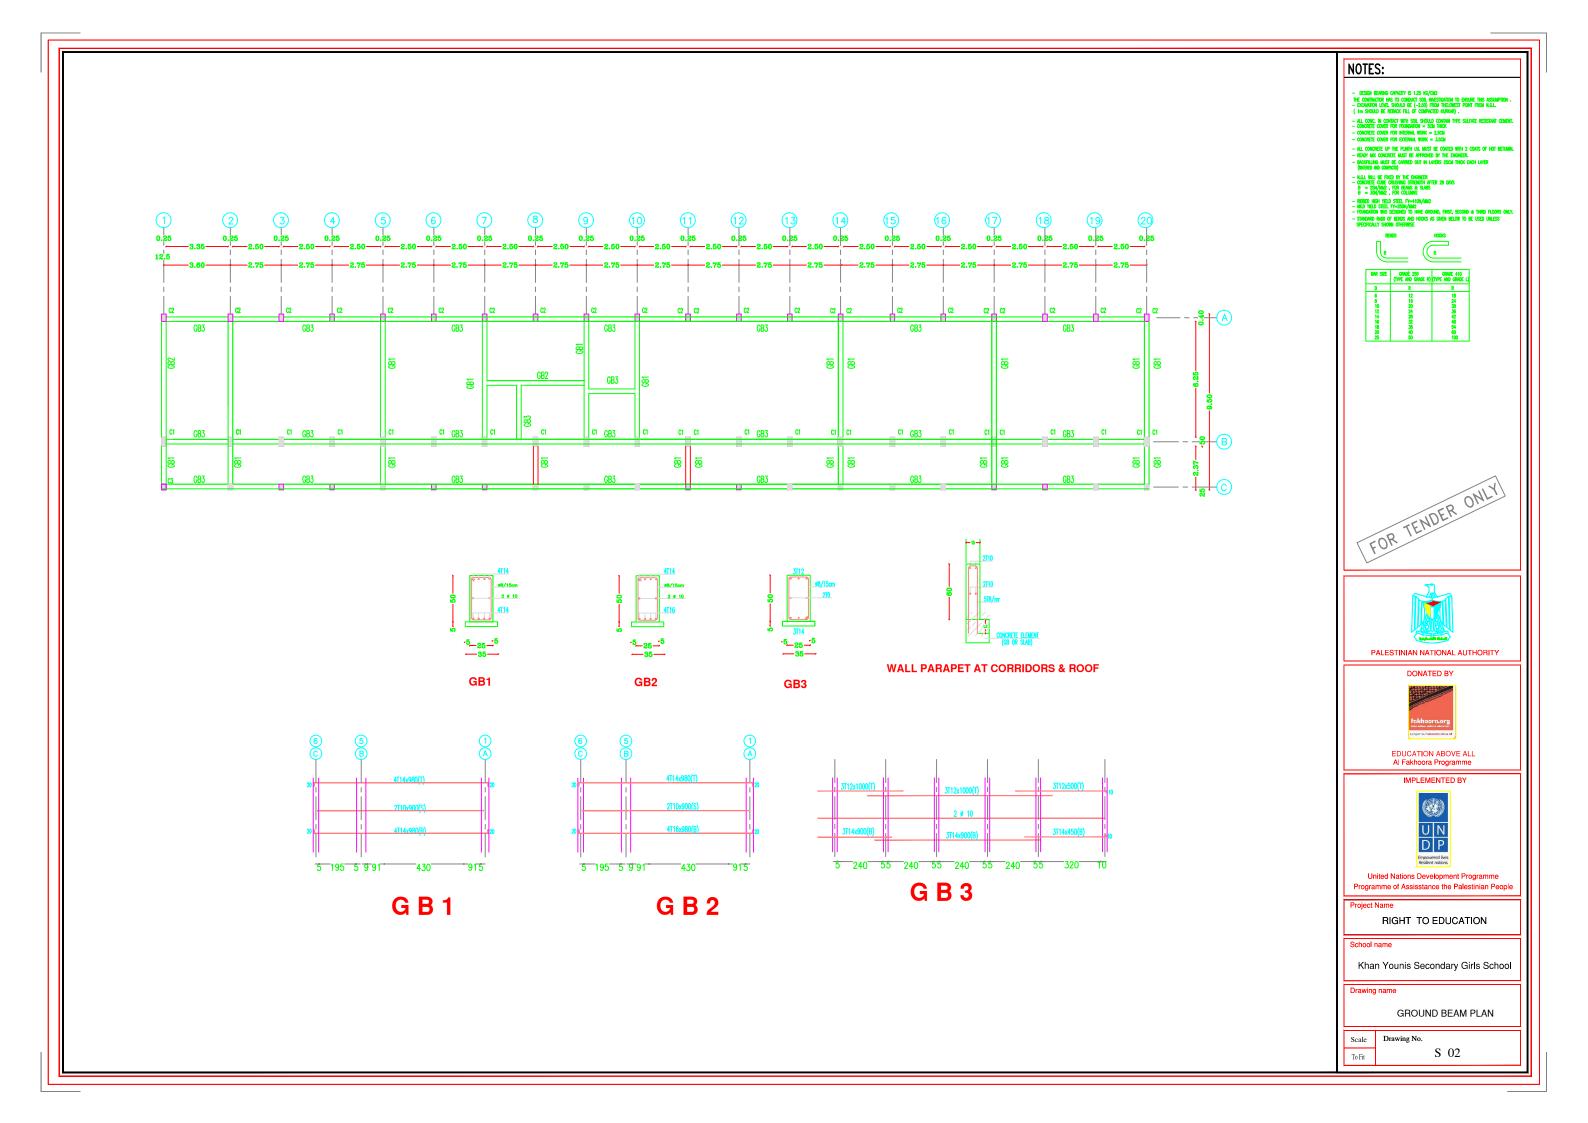


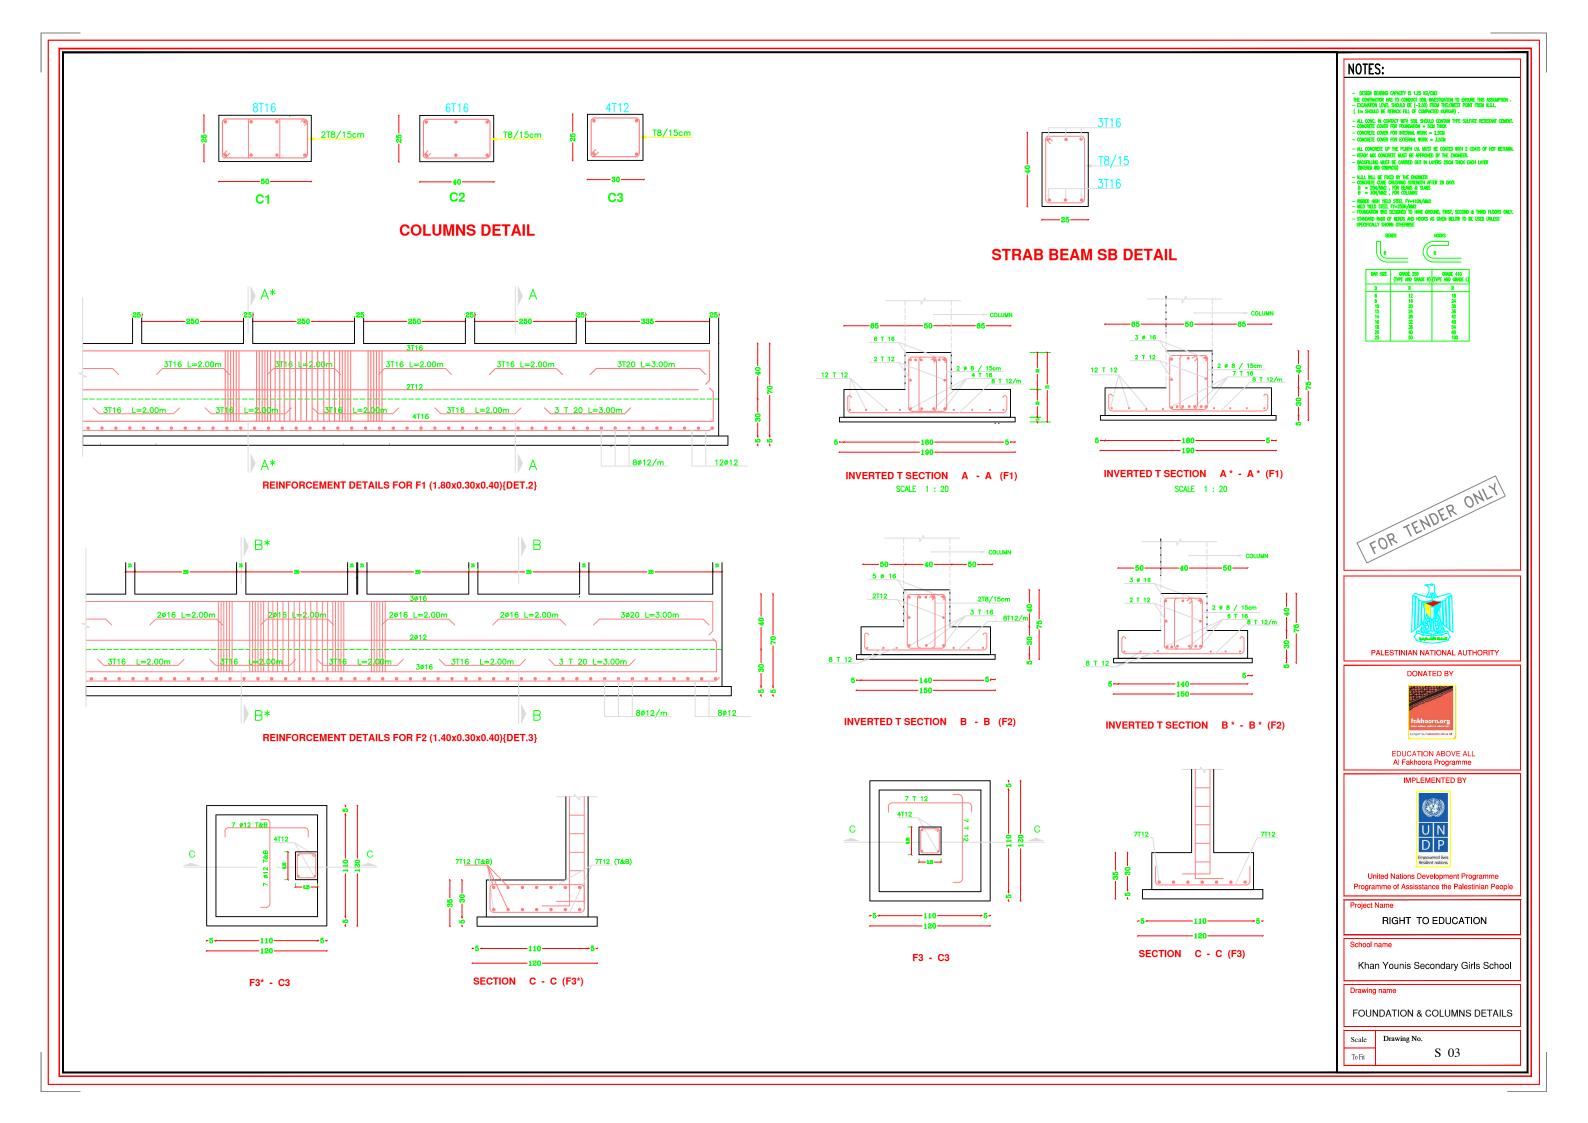


TYPE	NECK COLUMNS	GROUND FLOOR COLUMNS	FIRST FLOOR COLUMNS	SECOND FLOOR COLUMNS
C1	0.25 8 Ø 16 98/20cm	0.25 8 Ø 16 08/20cm	0.25 8 ø 16 98/20cm	0.25 8 Ø 16 Ø8/20cm
C2	0.25 0.25 0.88/20cm	0.25 Ø8/20cm	0.25 Ø8/20cm	0.25 Ø8/20cm
C3	0.25 4 Ø 12 Ø8/20cm	0.25 4 Ø 12 Ø8/20cm	0.25 4 Ø 12 Ø8/20cm	0.25 4 ø 12 ø8/20cm

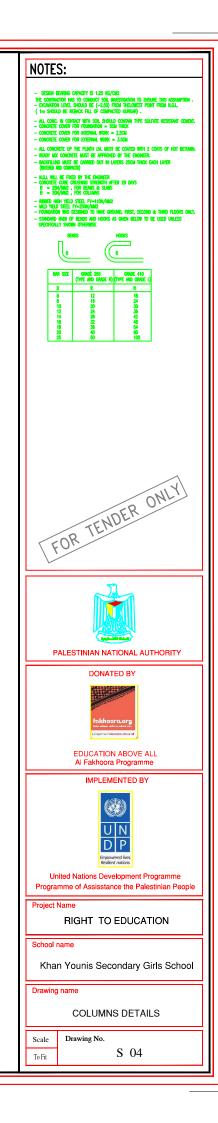


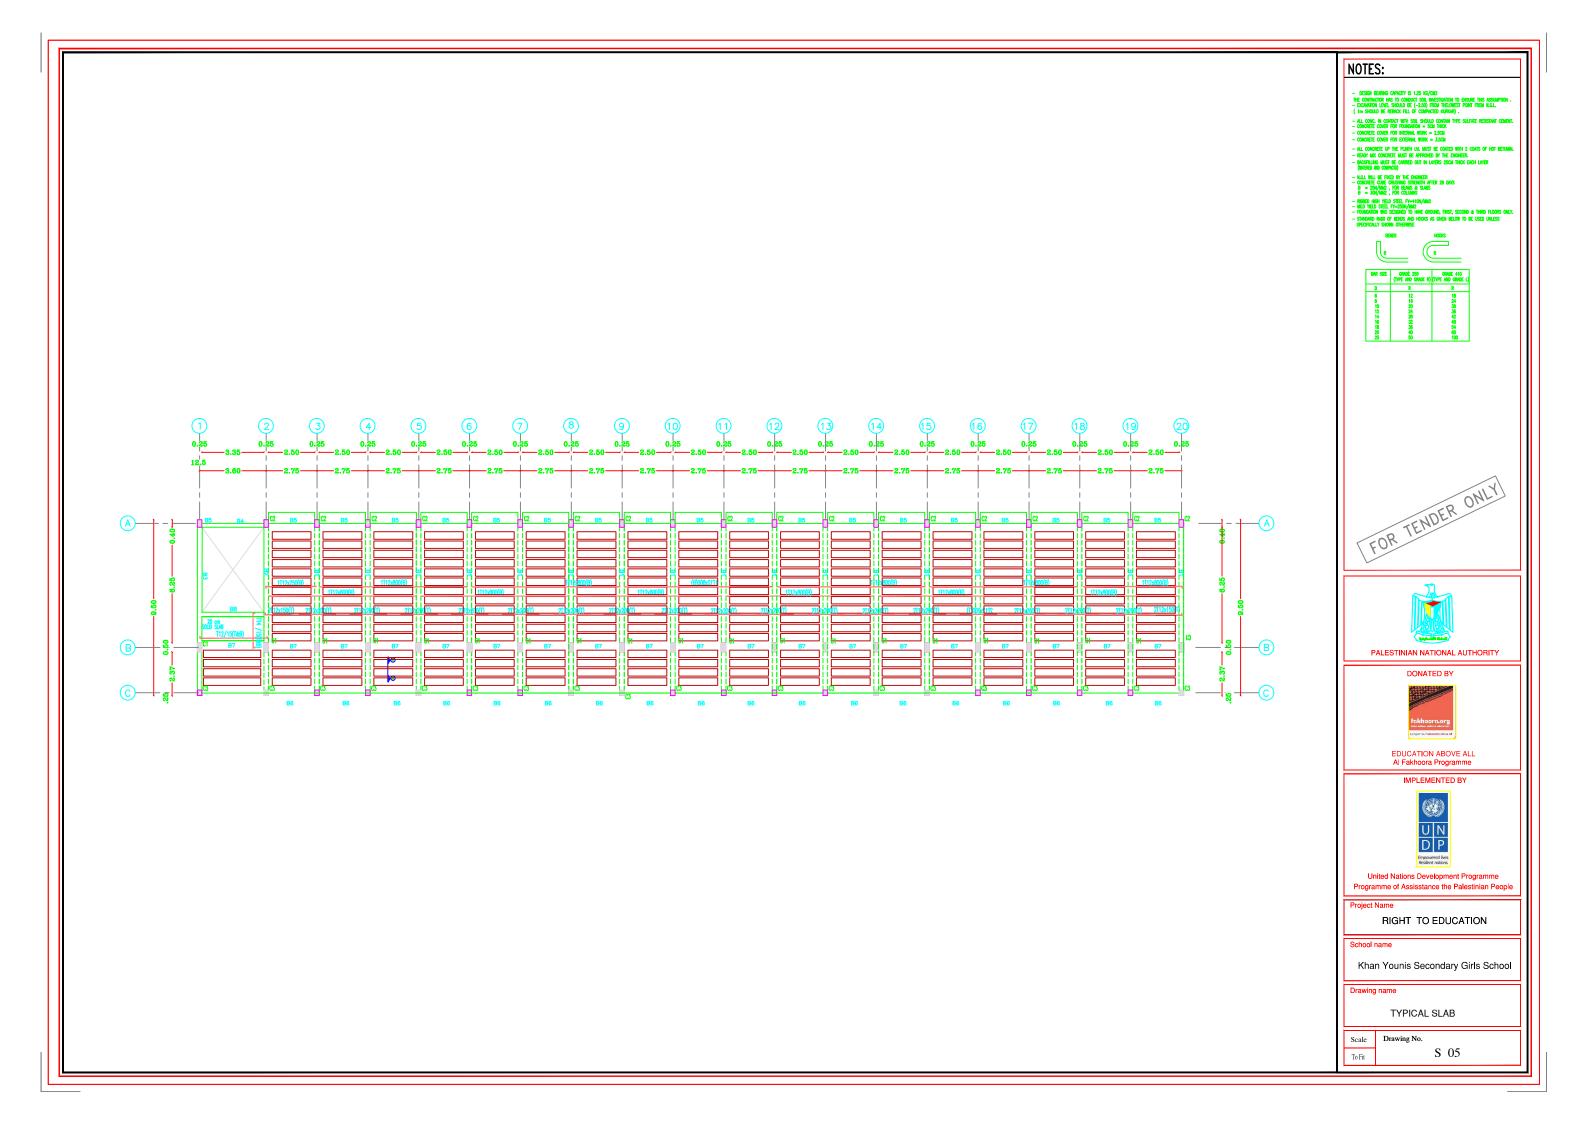

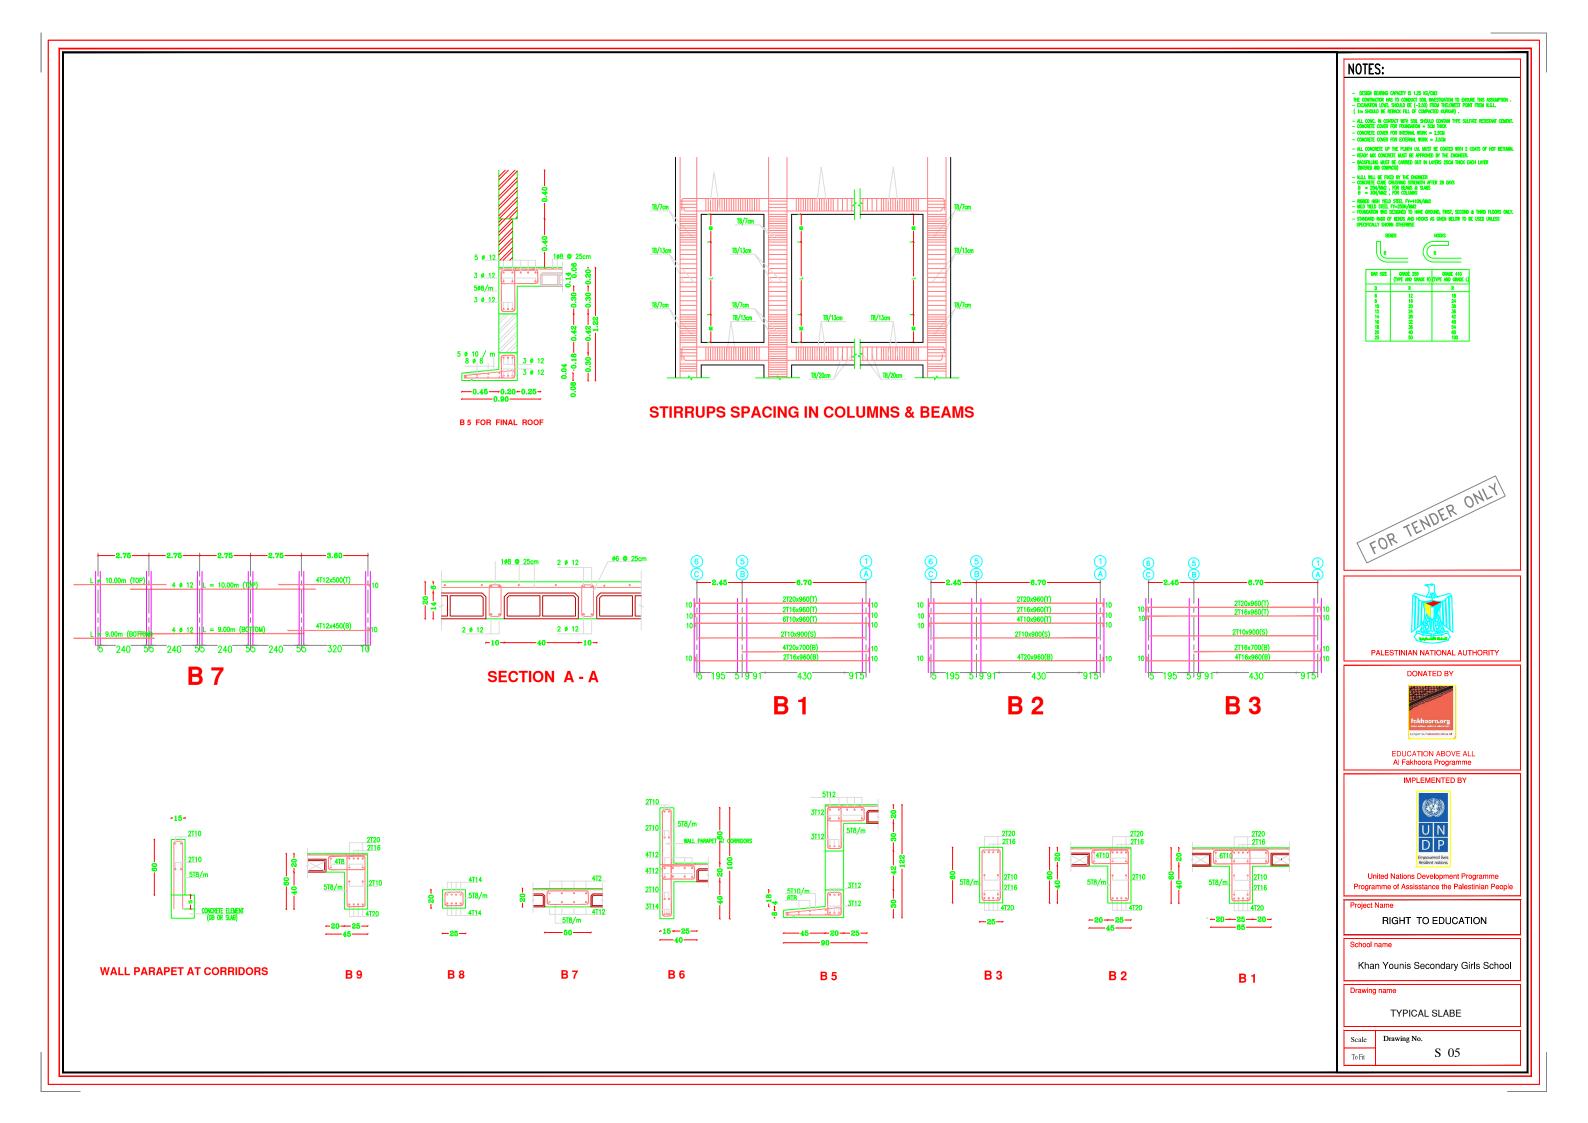


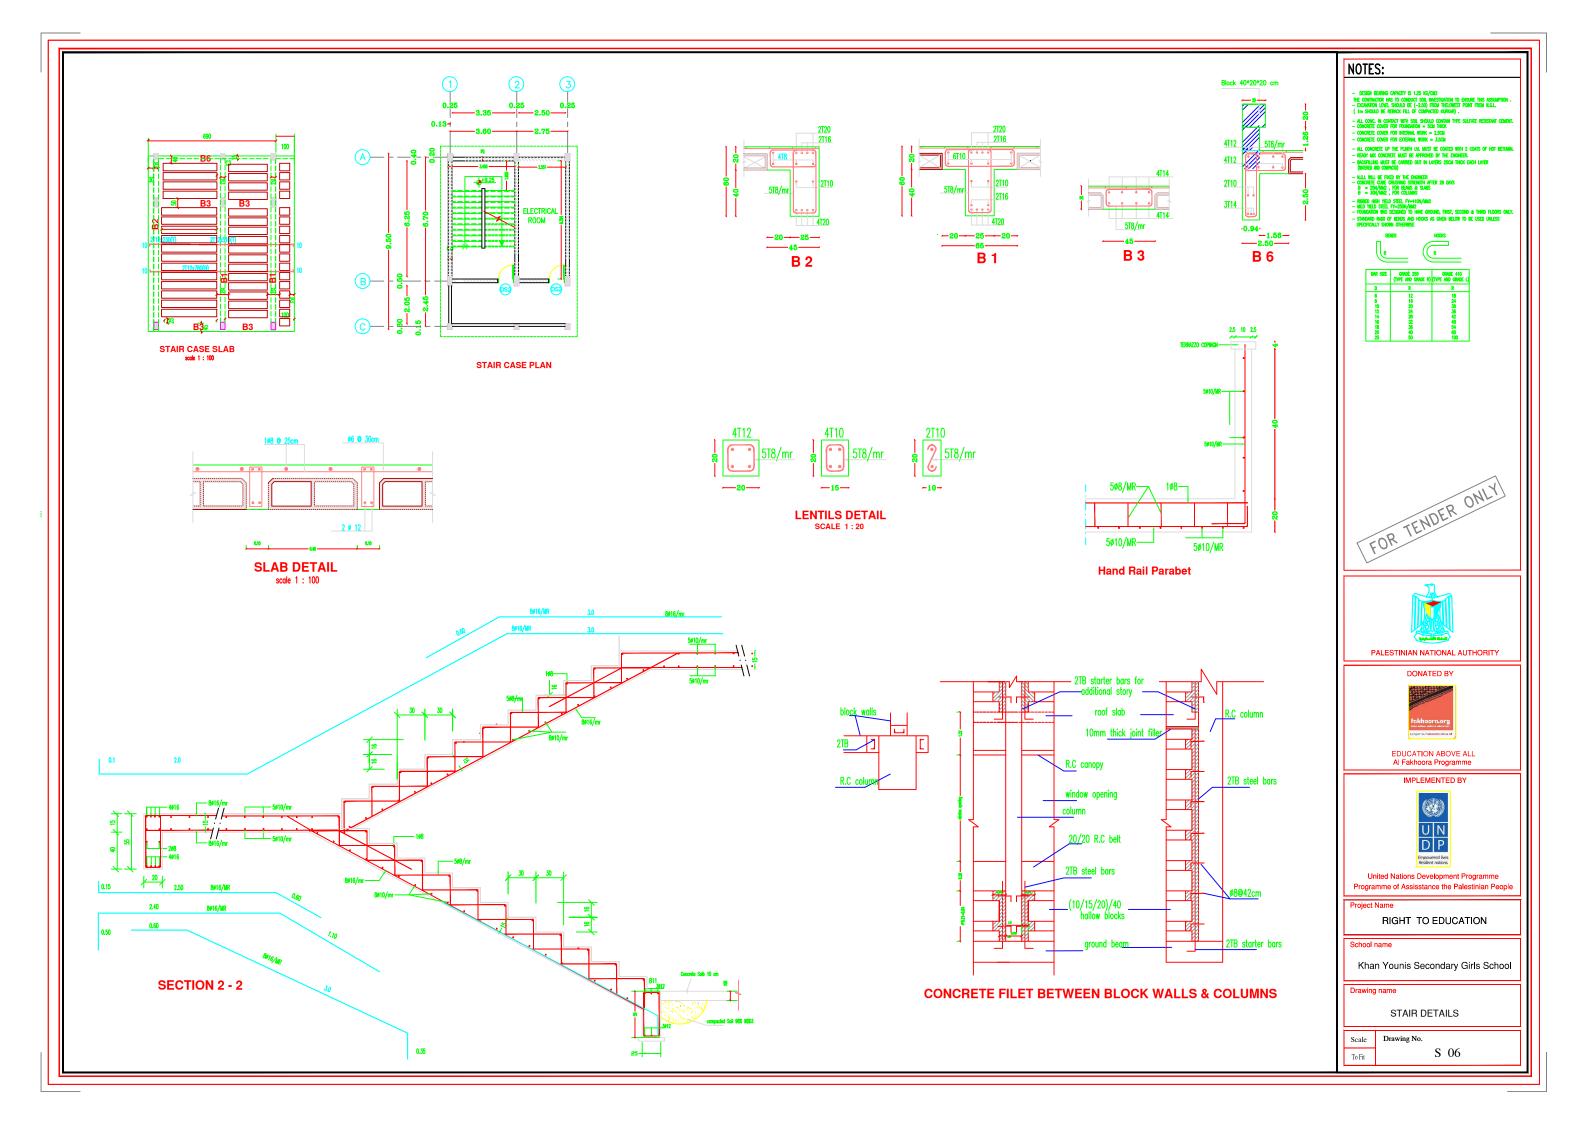


The Contractor has to submnit detailed Shop Drawings of all works for approval Of the supervisor Engineer

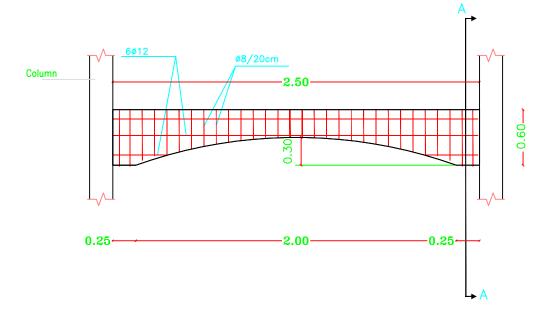


Details of Arches in Second Floor Back Elevations
SCALE 1:50

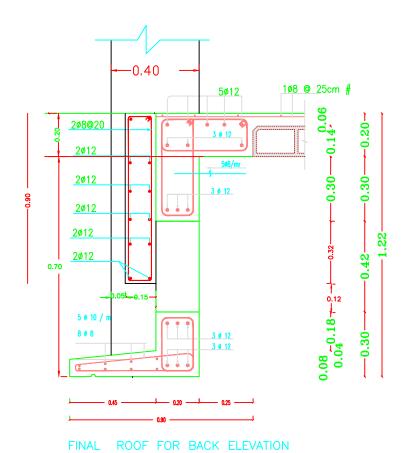

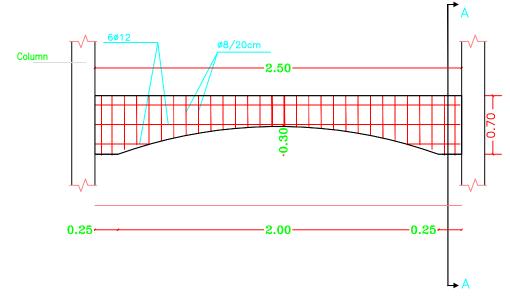

Details of Arches in Second Floor Front Elevations
SCALE 1:50

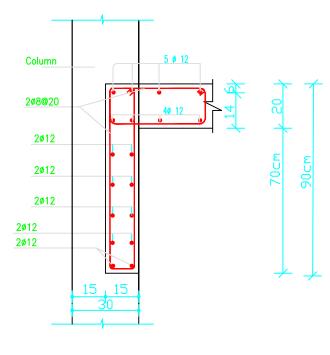



Section A-A

Details of Arches in Second Floor Front Elevations




Mechanical Drawings

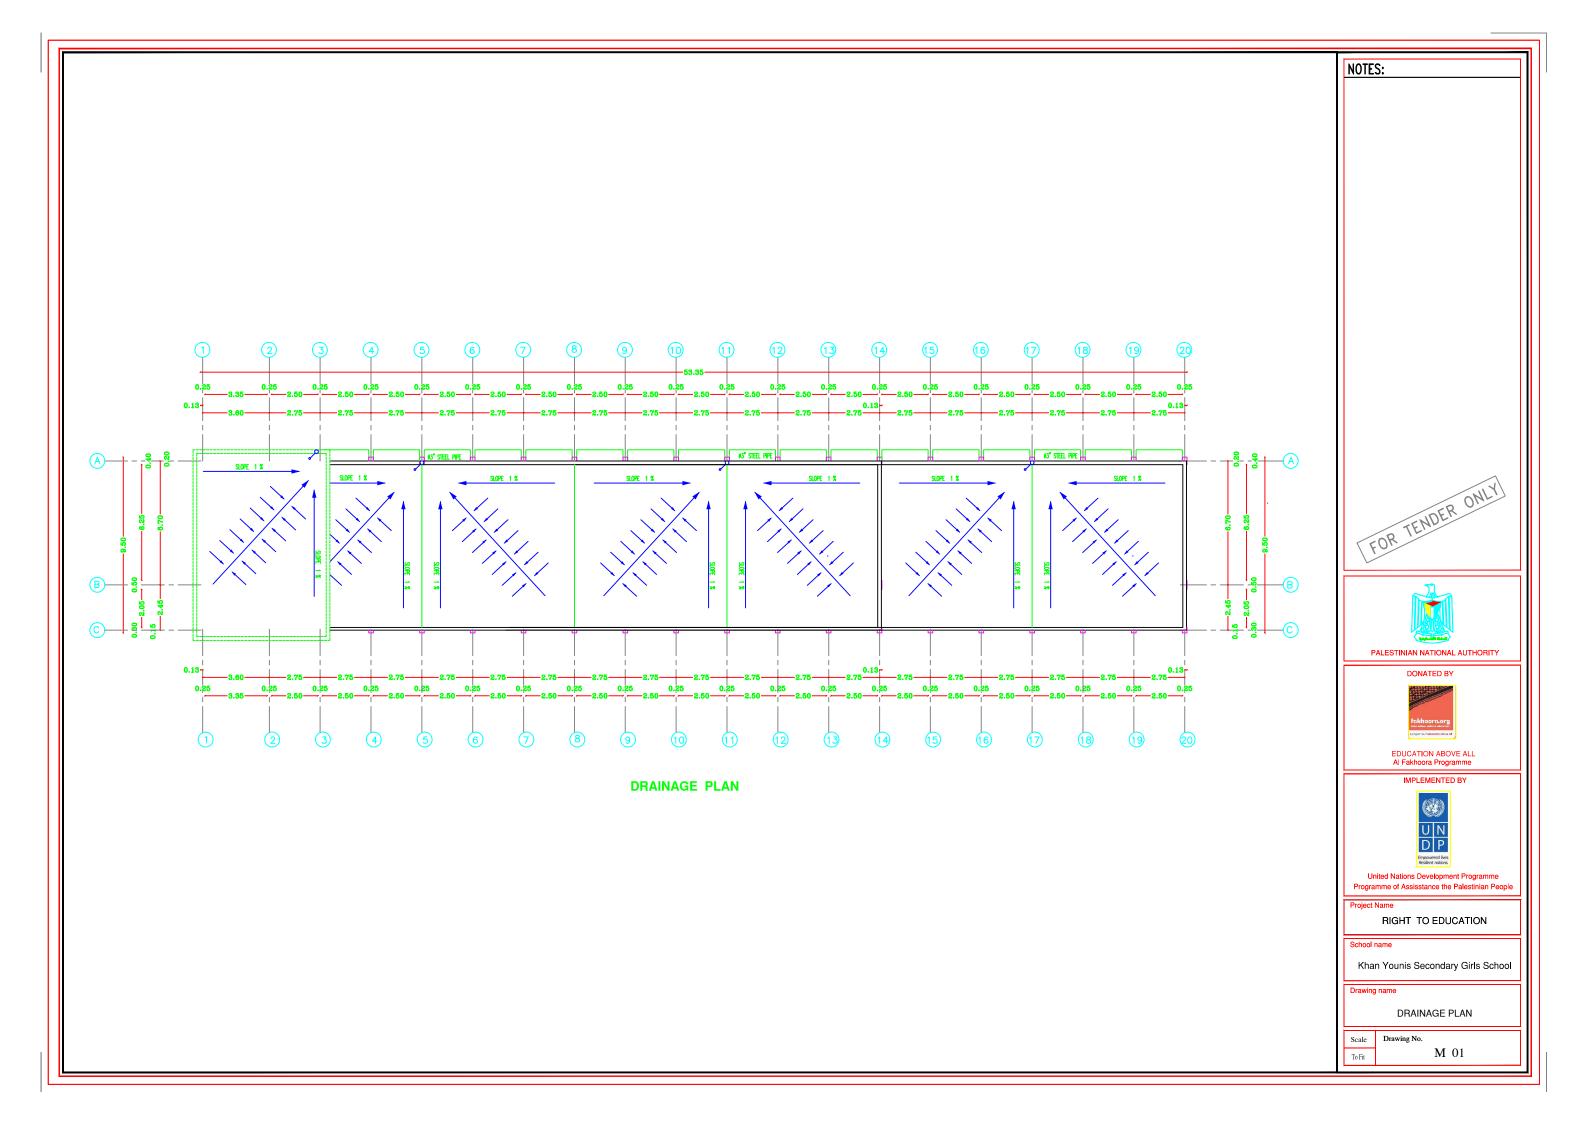

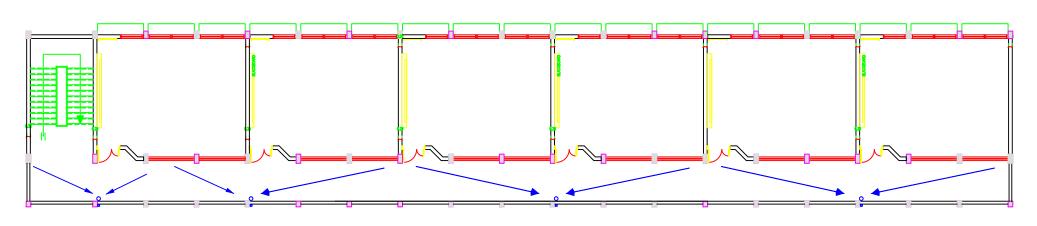


GROUND FIRST & SECOND FLOOR SANITARY PLAN




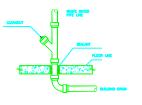



DRAINAGE PIPE CONNECTION DETAIL




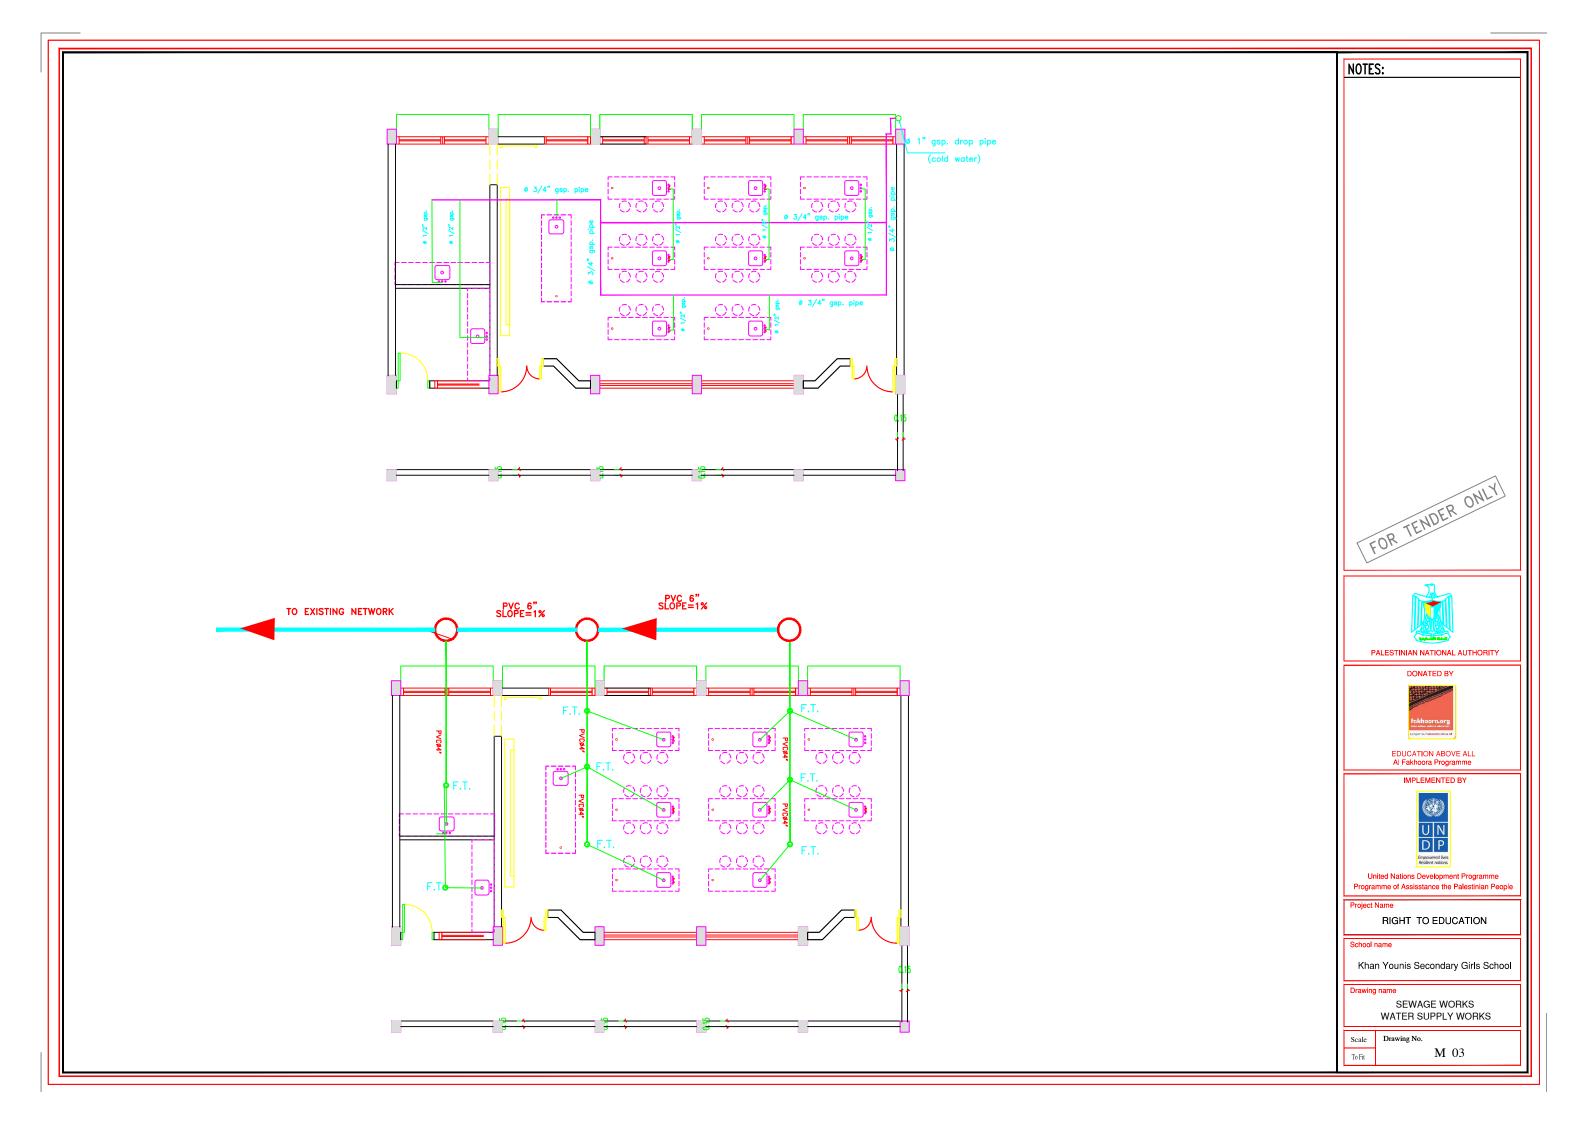

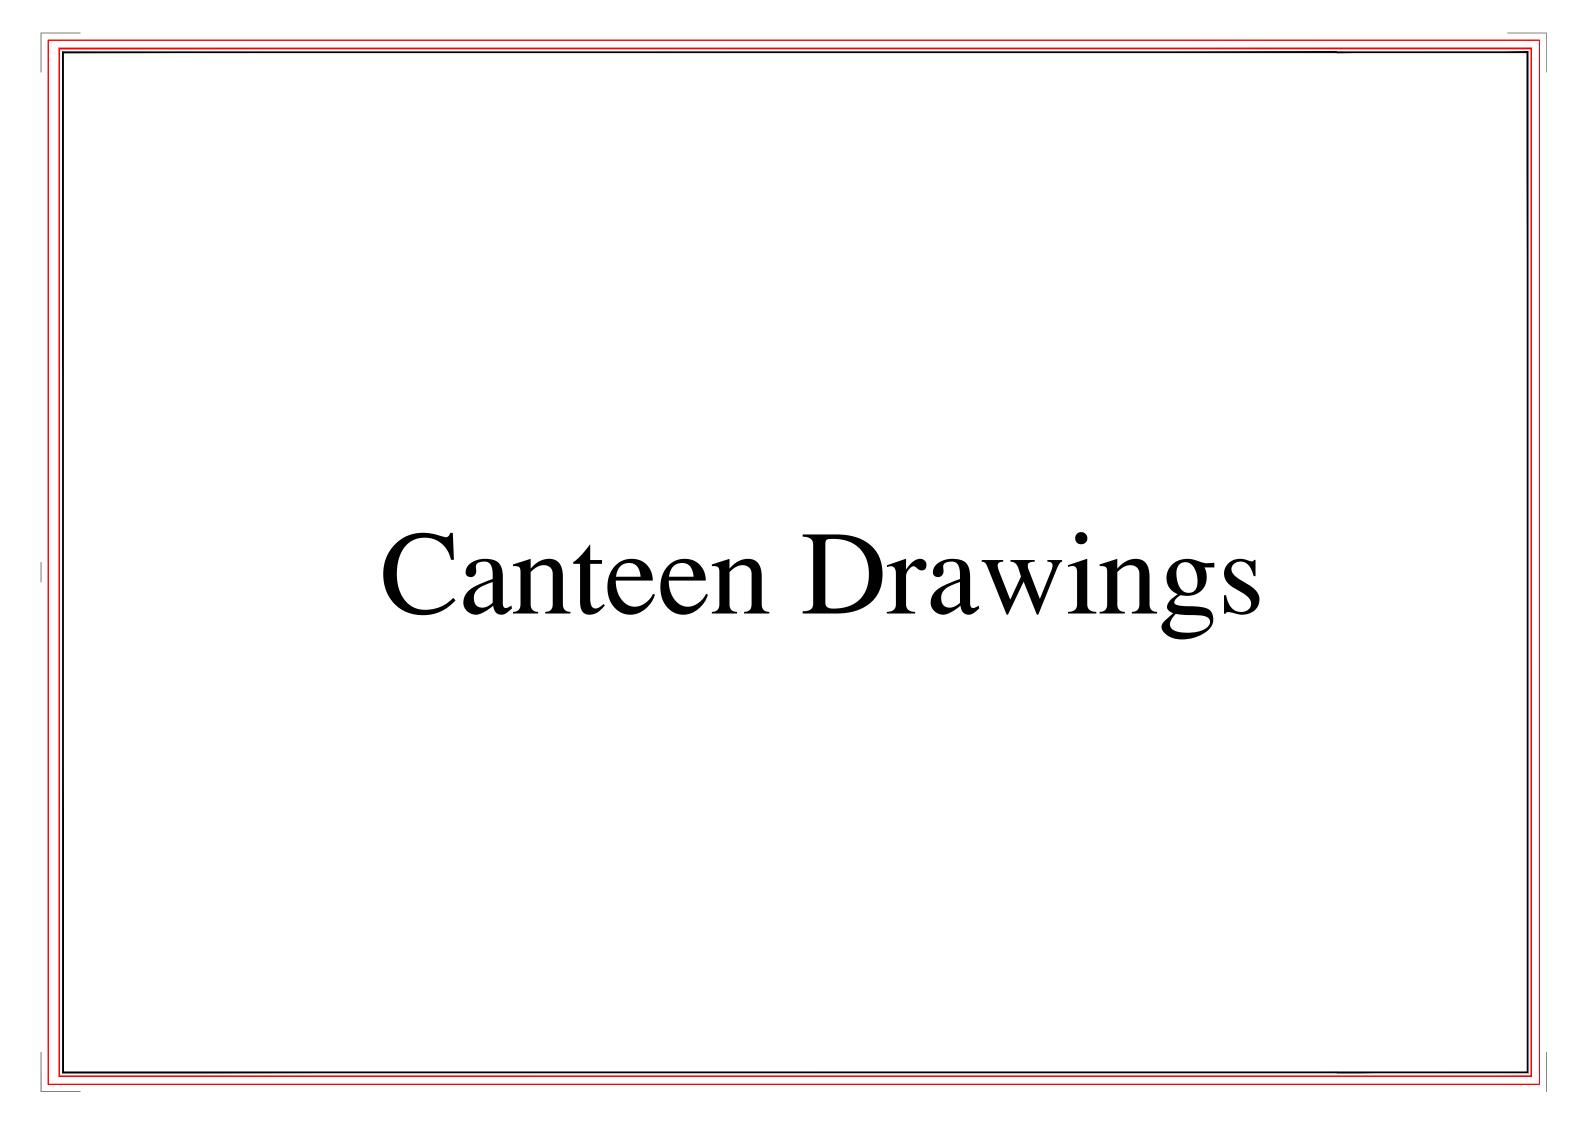


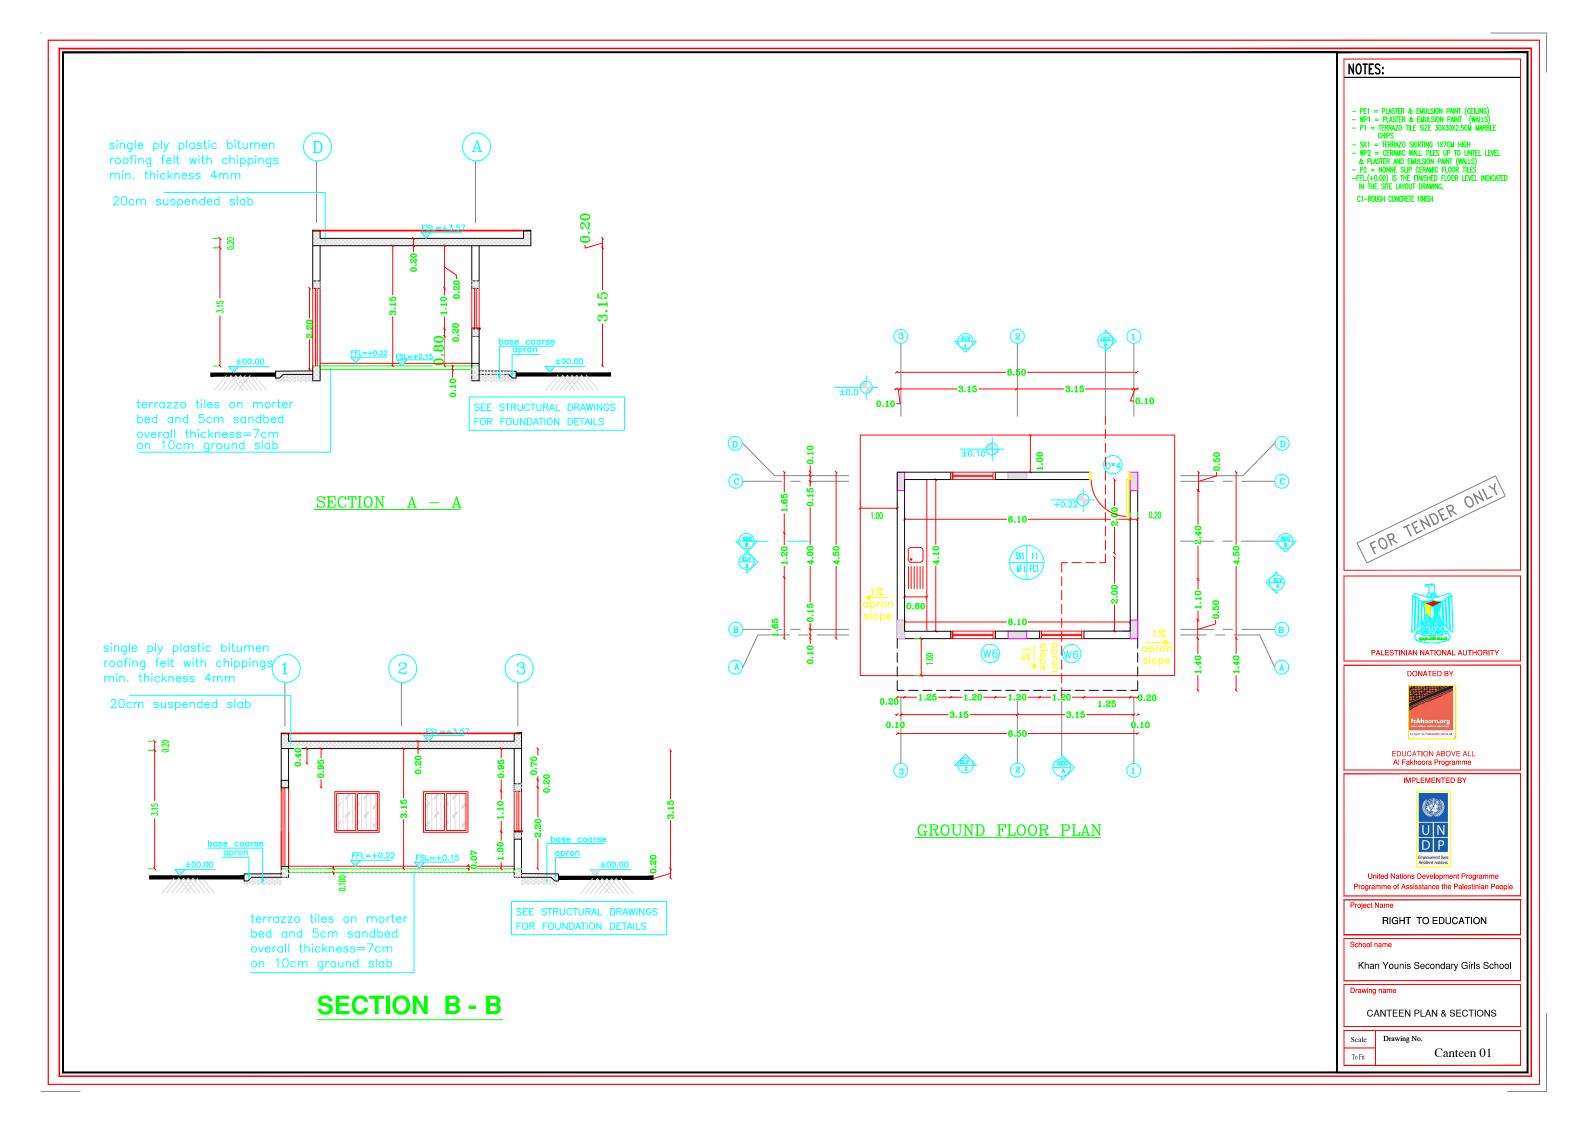

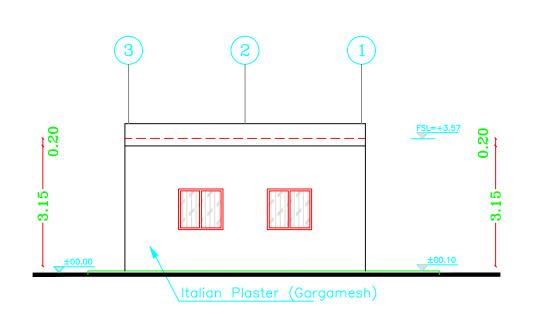


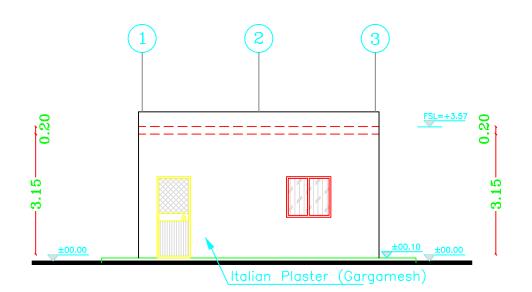

FRONT ELEVATION (1)

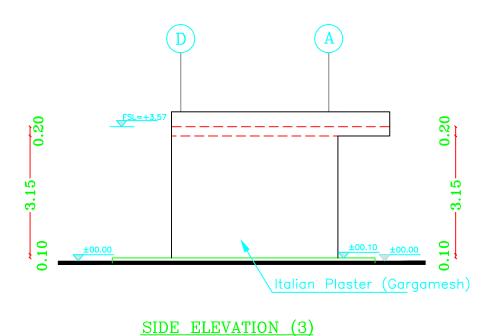



BACK ELEVATION (2)

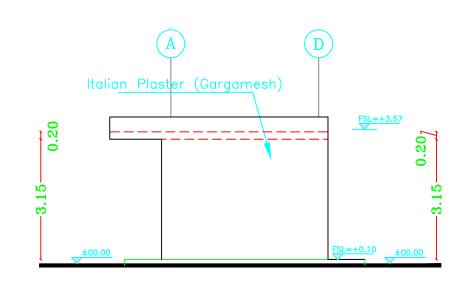

SCALE 1:100




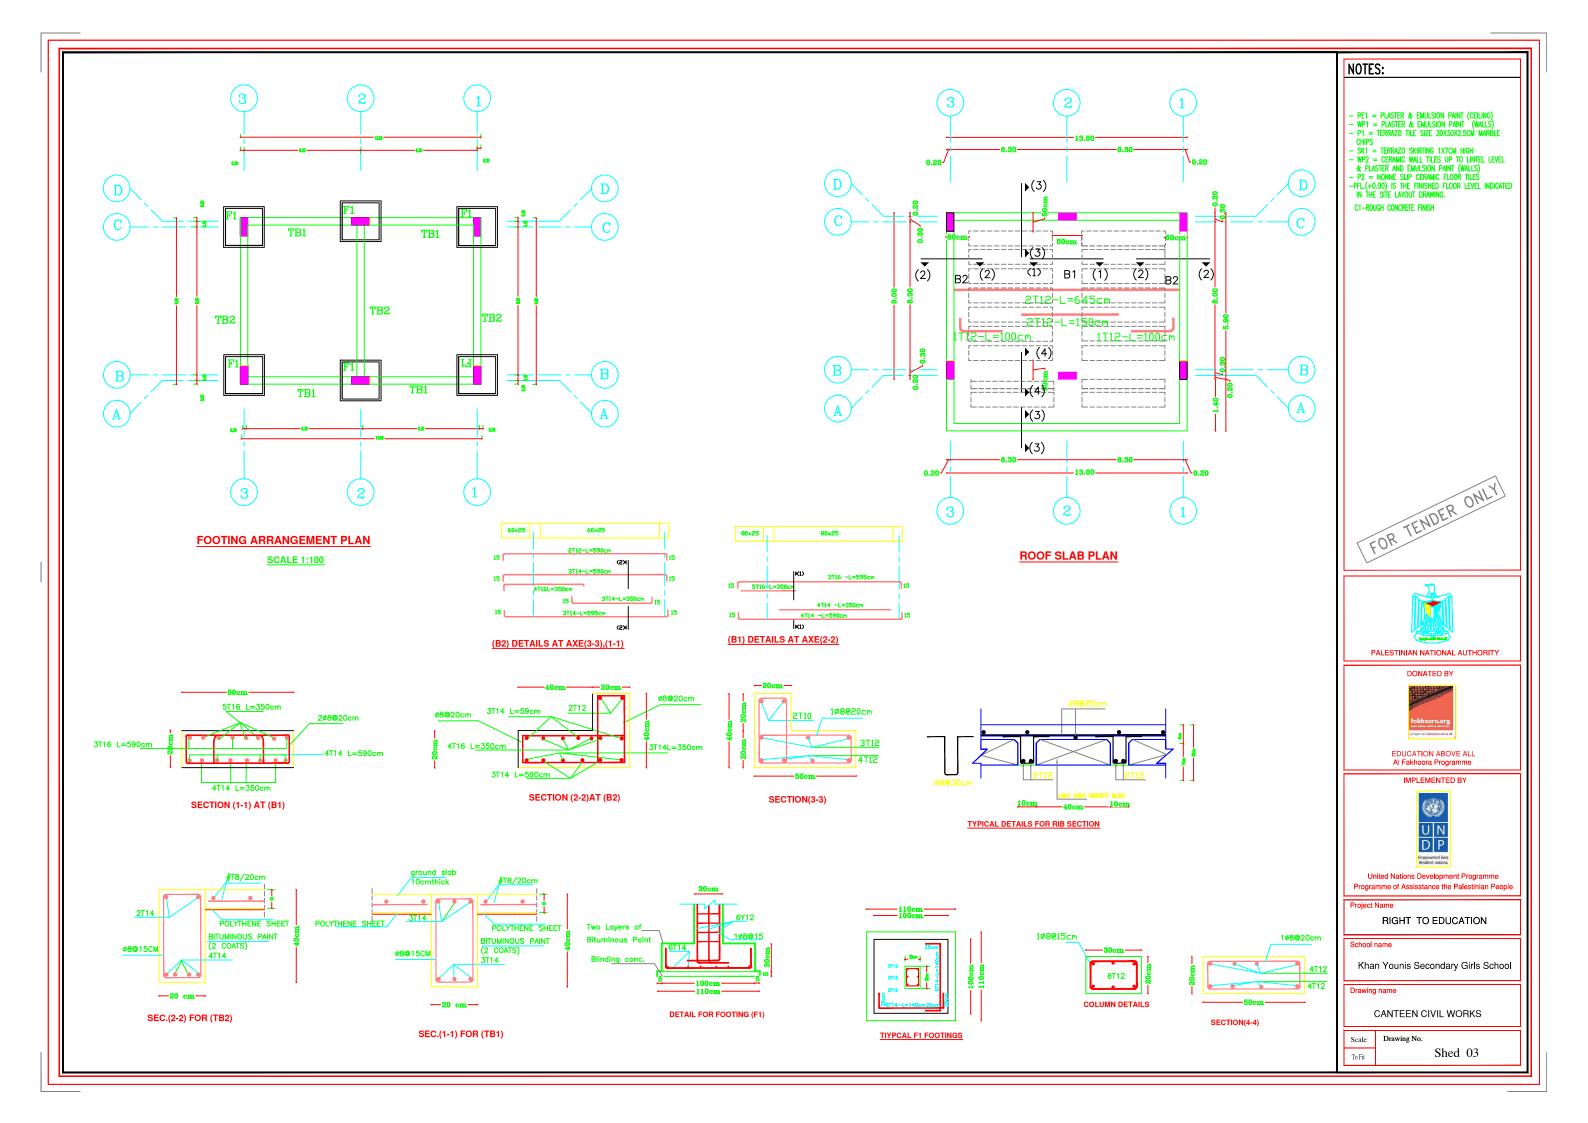

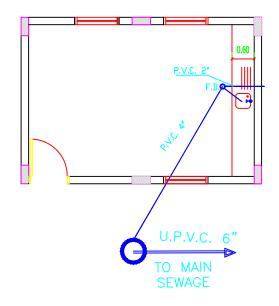


CANTEEN WATER & SANITARY PLAN

SCALE 1:100

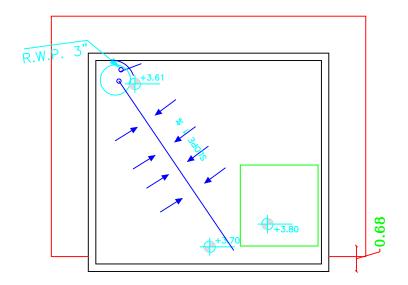

ROOFING SLOPE PLAN
SCALE 1:100

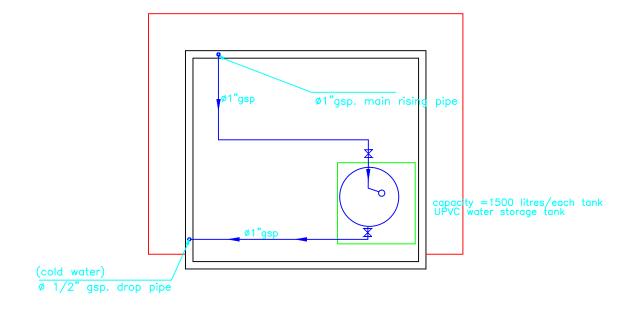


CANTEEN ROOF WATER TANK
SCALE 1:100





Electrical Drawings


كلوب مربع لرقم البيت	
نجفة مثبتة في السقف	
نجفة مثبتة <i>في</i> الحائط	
مصباح سقف عادی معلق	\oplus
مصباح حائط عادي	\bigoplus
مهباح حائط خافت	
معباح البقعة	
معباح مراة الحمام	
مروحة سقف	
مروحة شفط	
مدفاة حمام	[
مفتاح مروحة سقف	\bigcirc
مفتاح مدفاة الحمام	<u>(</u>
مفتاح سخان الحمام	⊕ W.H
وحدة الانتركوم الداخلية	T
وحدة الانتركوم الخارجية	I
لوحة توزيع كحرباء رئيسية	
لوحة توريع كهرباء فرعية	SDB
لوحة توريع اتصالات رئيسية	
- لوحة توريع اتصالات فرعية	
9	

جدول الرموز الكهربائية			
البيان	الرصر		
مفتاح کهرباء مفرد			
مفتاح كهرباء مردوج	F		
مفتاخ ثلاثي	F		
ضاغط جر س	<u></u>		
فاغط انارة الدرج	0		
جرس گھرباء			
مخرج کهرباء عادی ش	+		
مخرج كهرباء بغطاء			
مخرج کمرباء عادی ۳ فار	<u></u>		
مخرج کمرباء بغطاء ۳فار			
مخرج كمرباء بمفتاح لزوم مكيف	AC		
مخرج ساتالایت			
مخرج تليفون			
معباح فلورسنت مفرد			
مصباح فلورسنت مزدوج			
معباح فلورسنت مستطيل شاحن			
مصباح حائط دائري			
ڪلوب دائري	+		
كلوب كروي مائل			

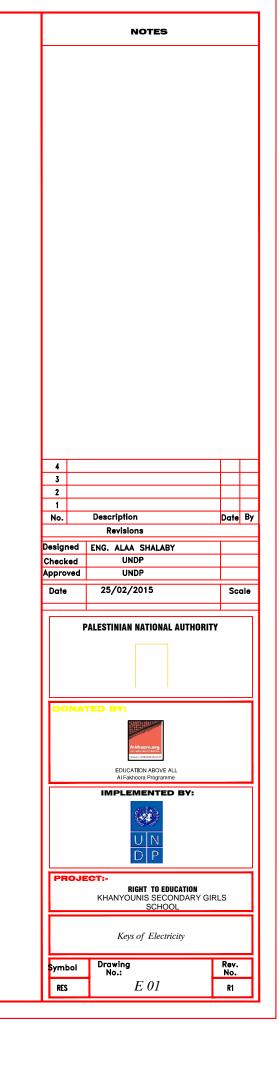


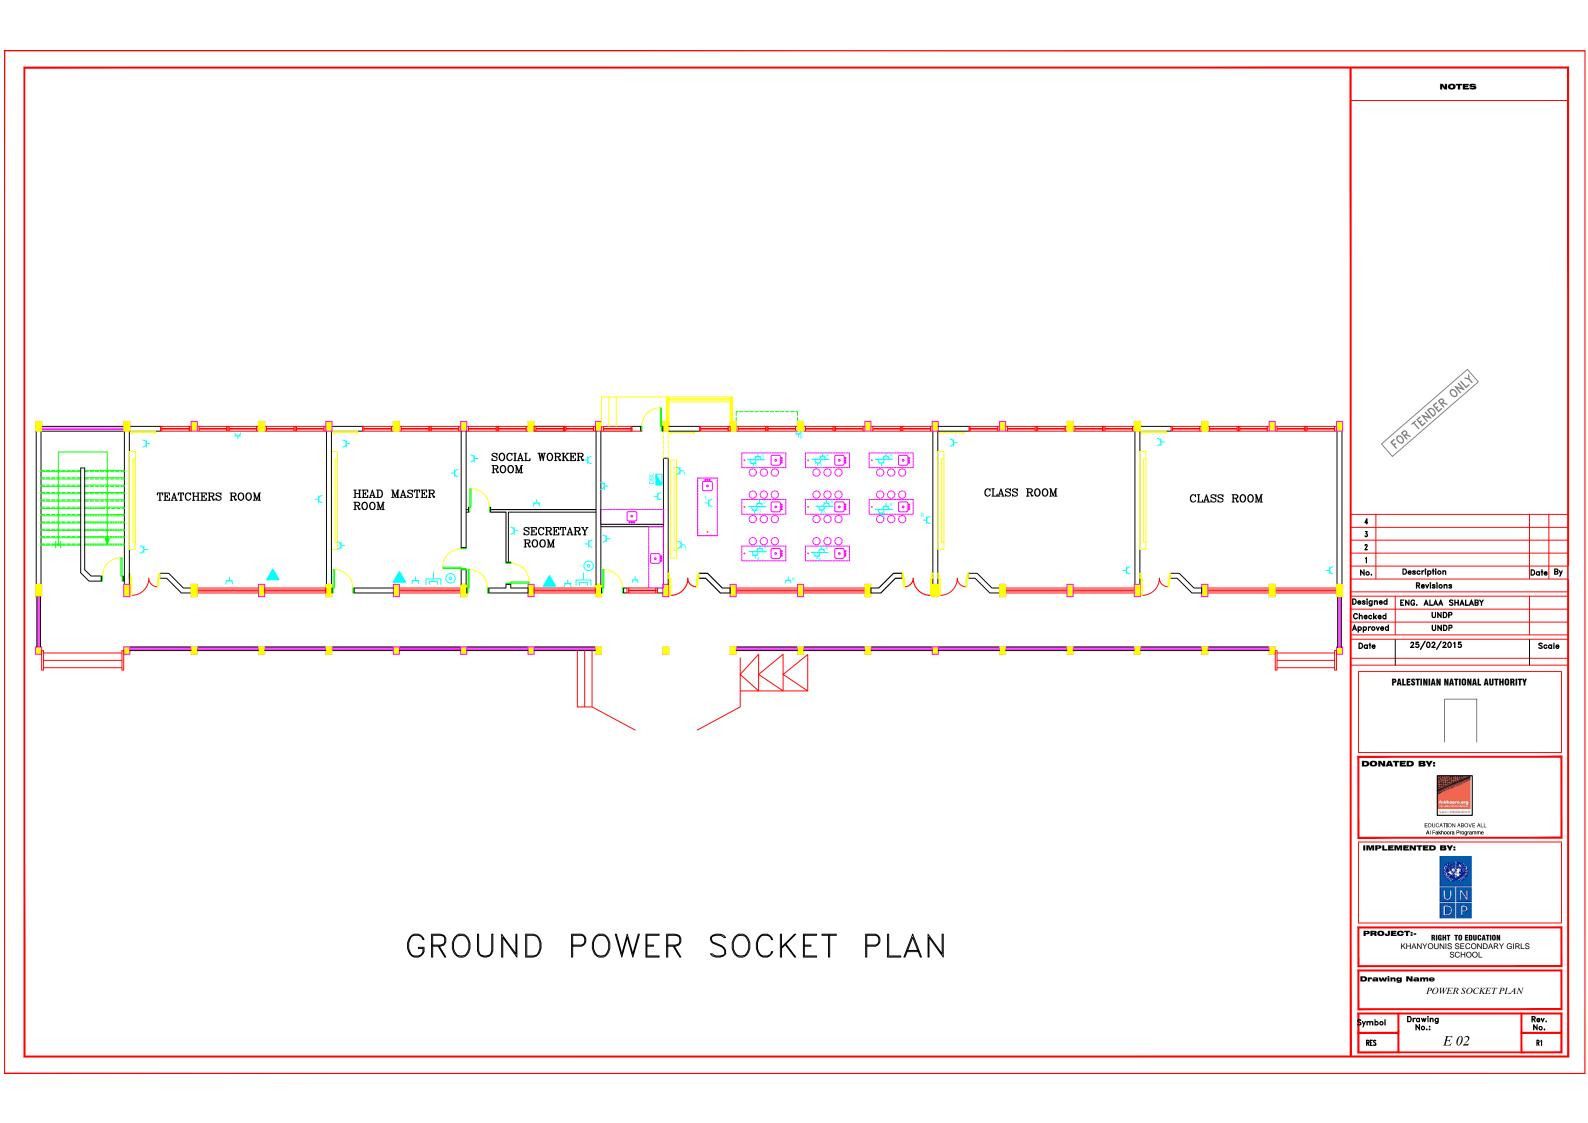


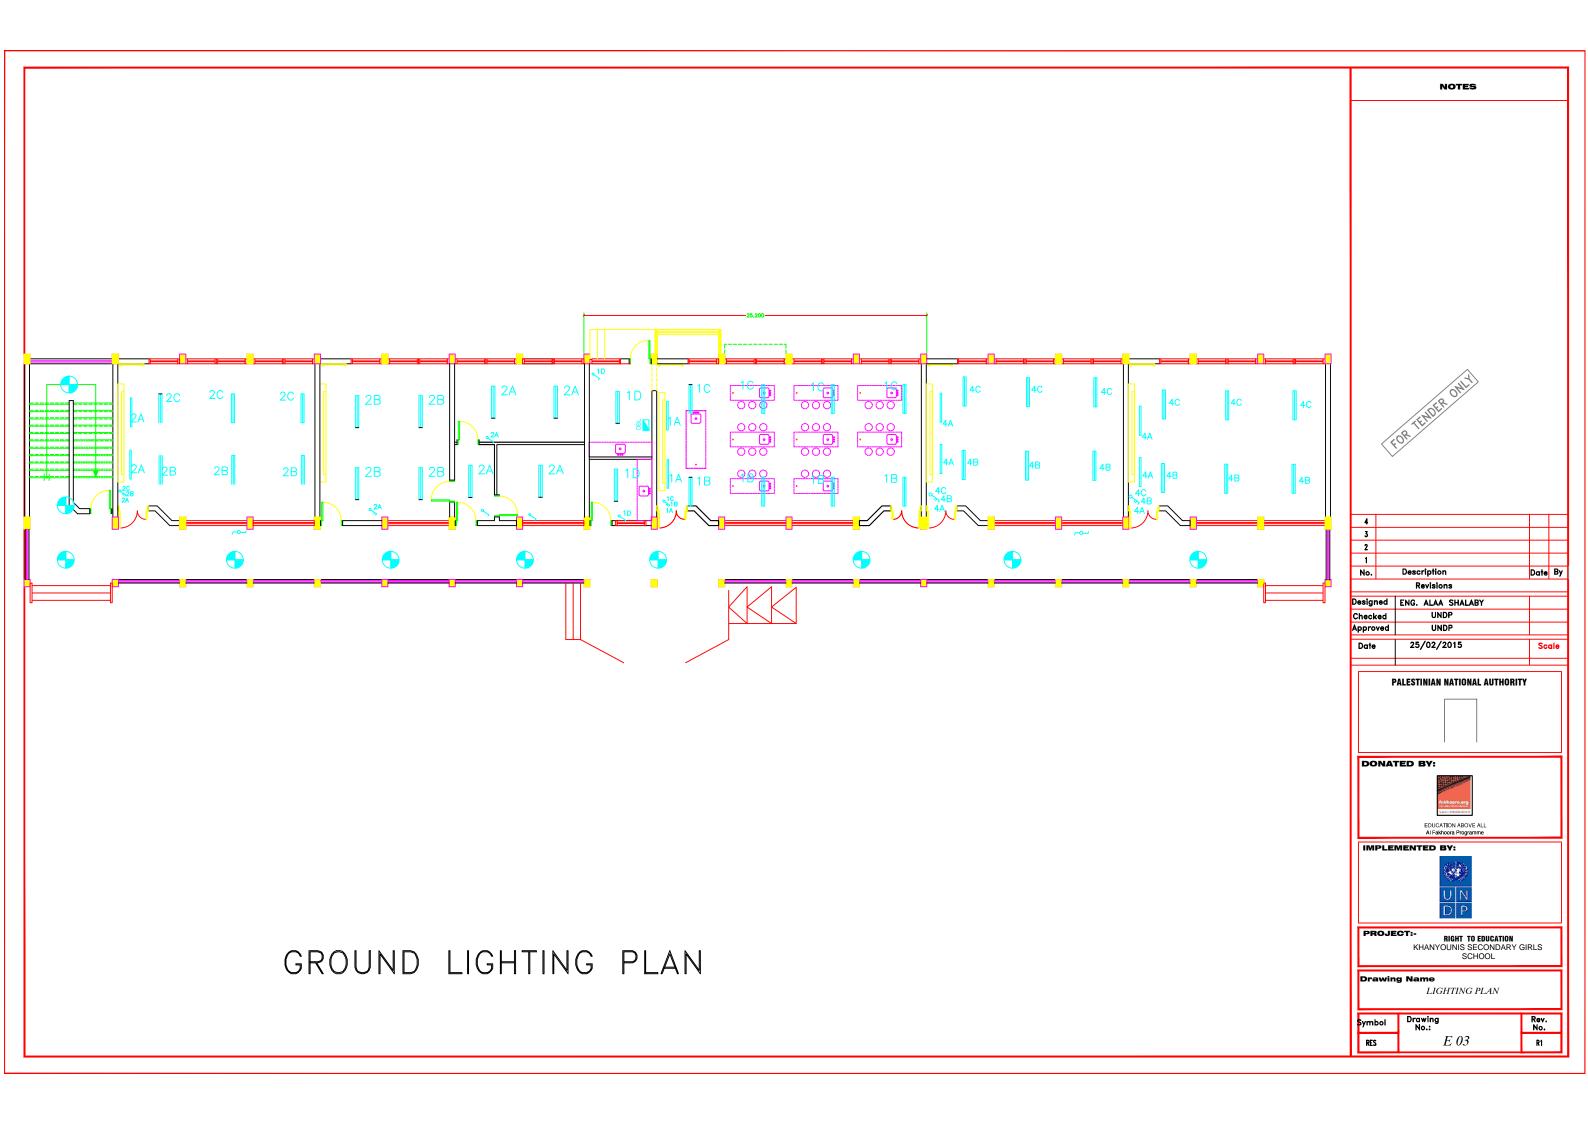


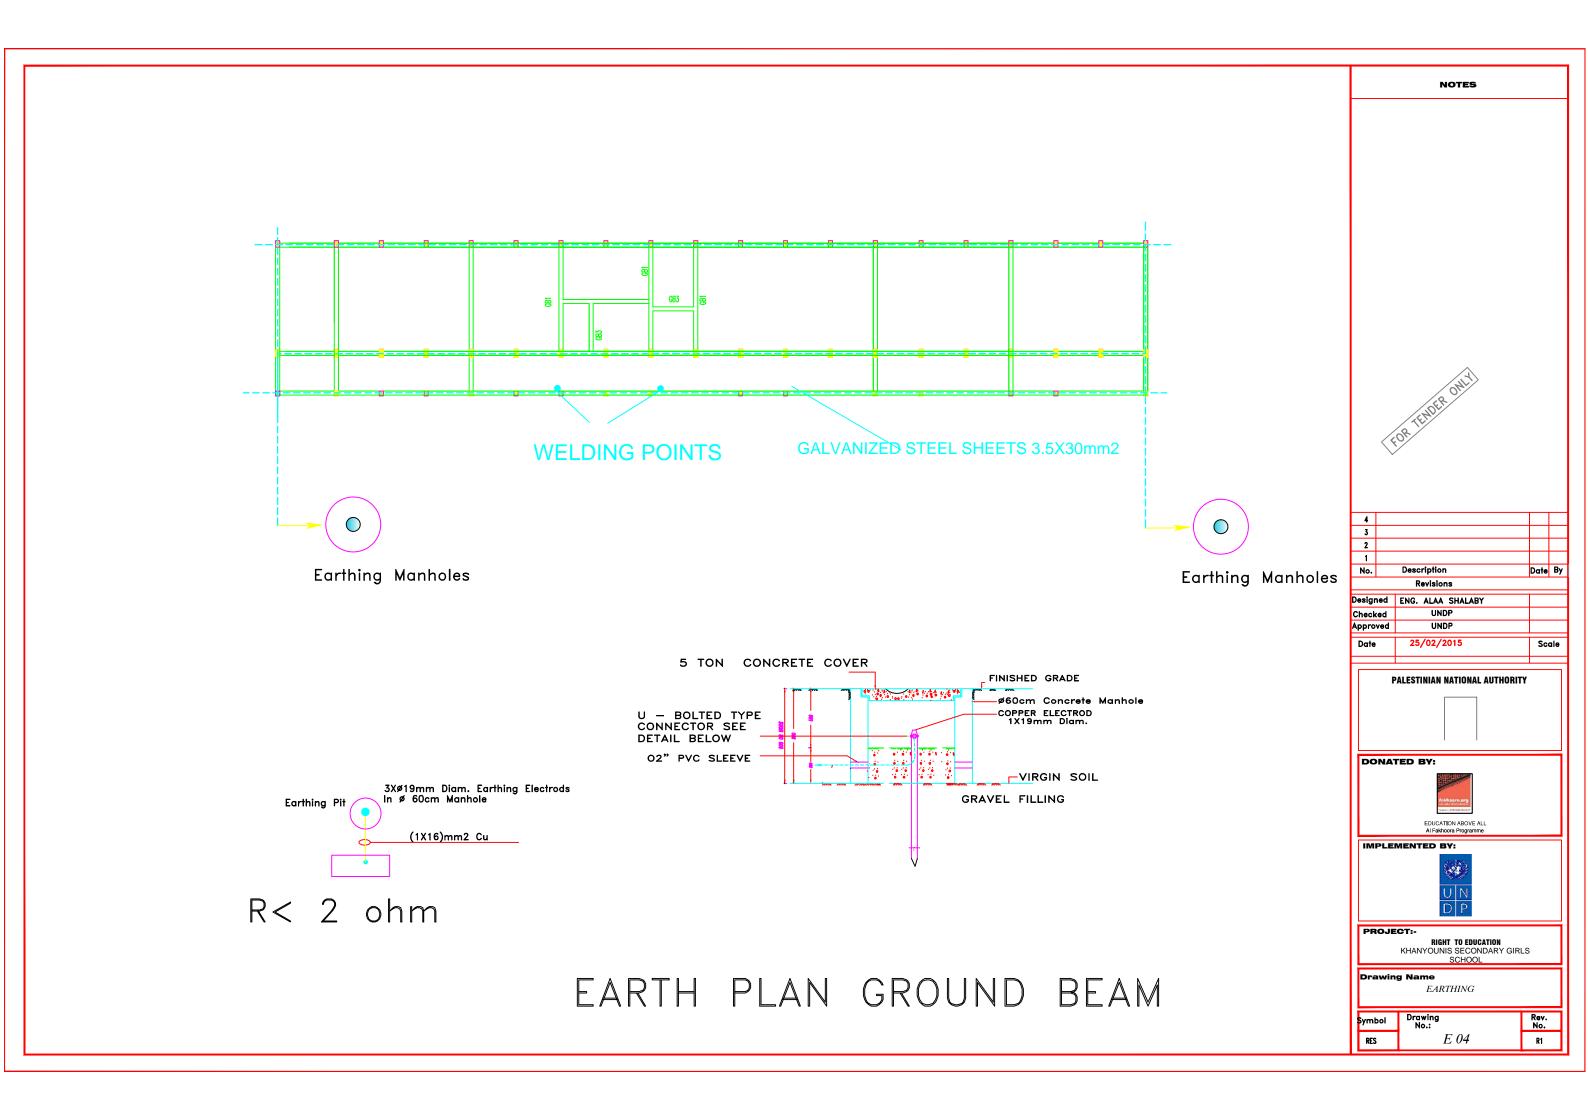


GENERAL LAYOUT 27 PROPOSED CABLE 4*25m STEEL SHED -12.70-Description Revisions Designed ENG. ALAA SHALABY Checked UNDP 25/02/2015 PALESTINIAN NATIONAL AUTHORITY TOILET IMPLEMENTED BY: RIGHT TO EDUCATION KHANYOUNIS SECONDARY GIRLS SCHOOL Existing Building Existing Building (4) GROUND FLOOR PLAN CABLE ROUTING Rev. No. E 05 R1

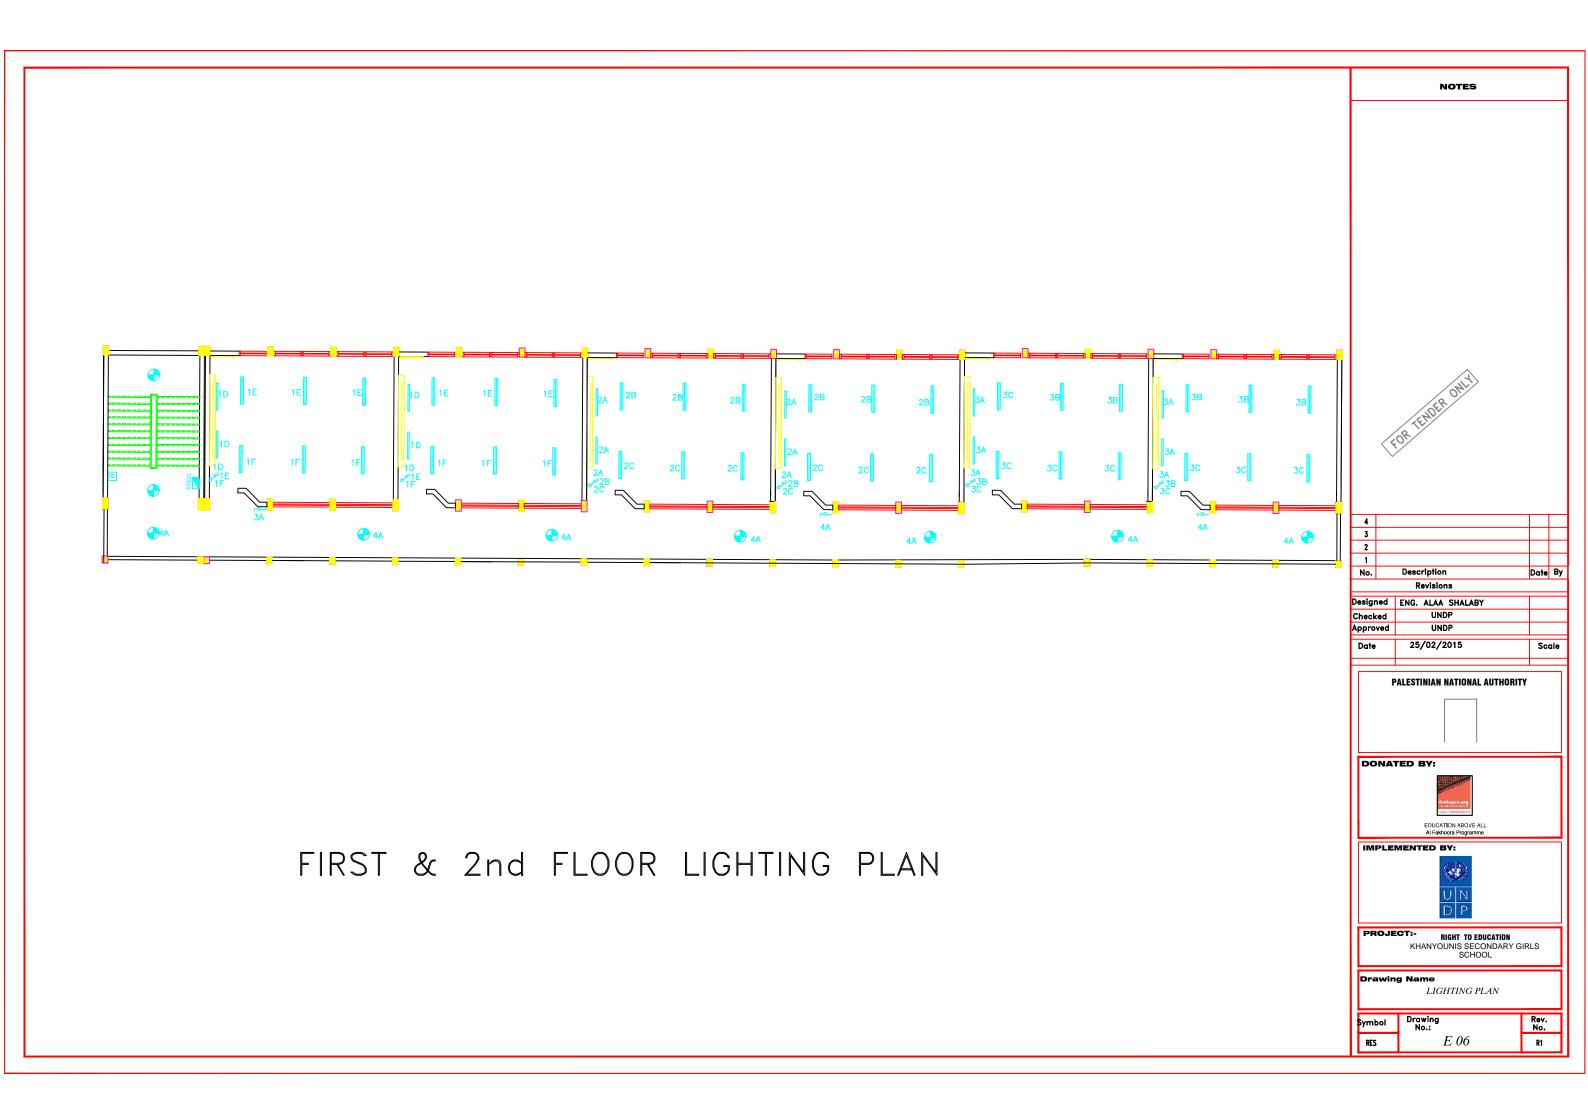


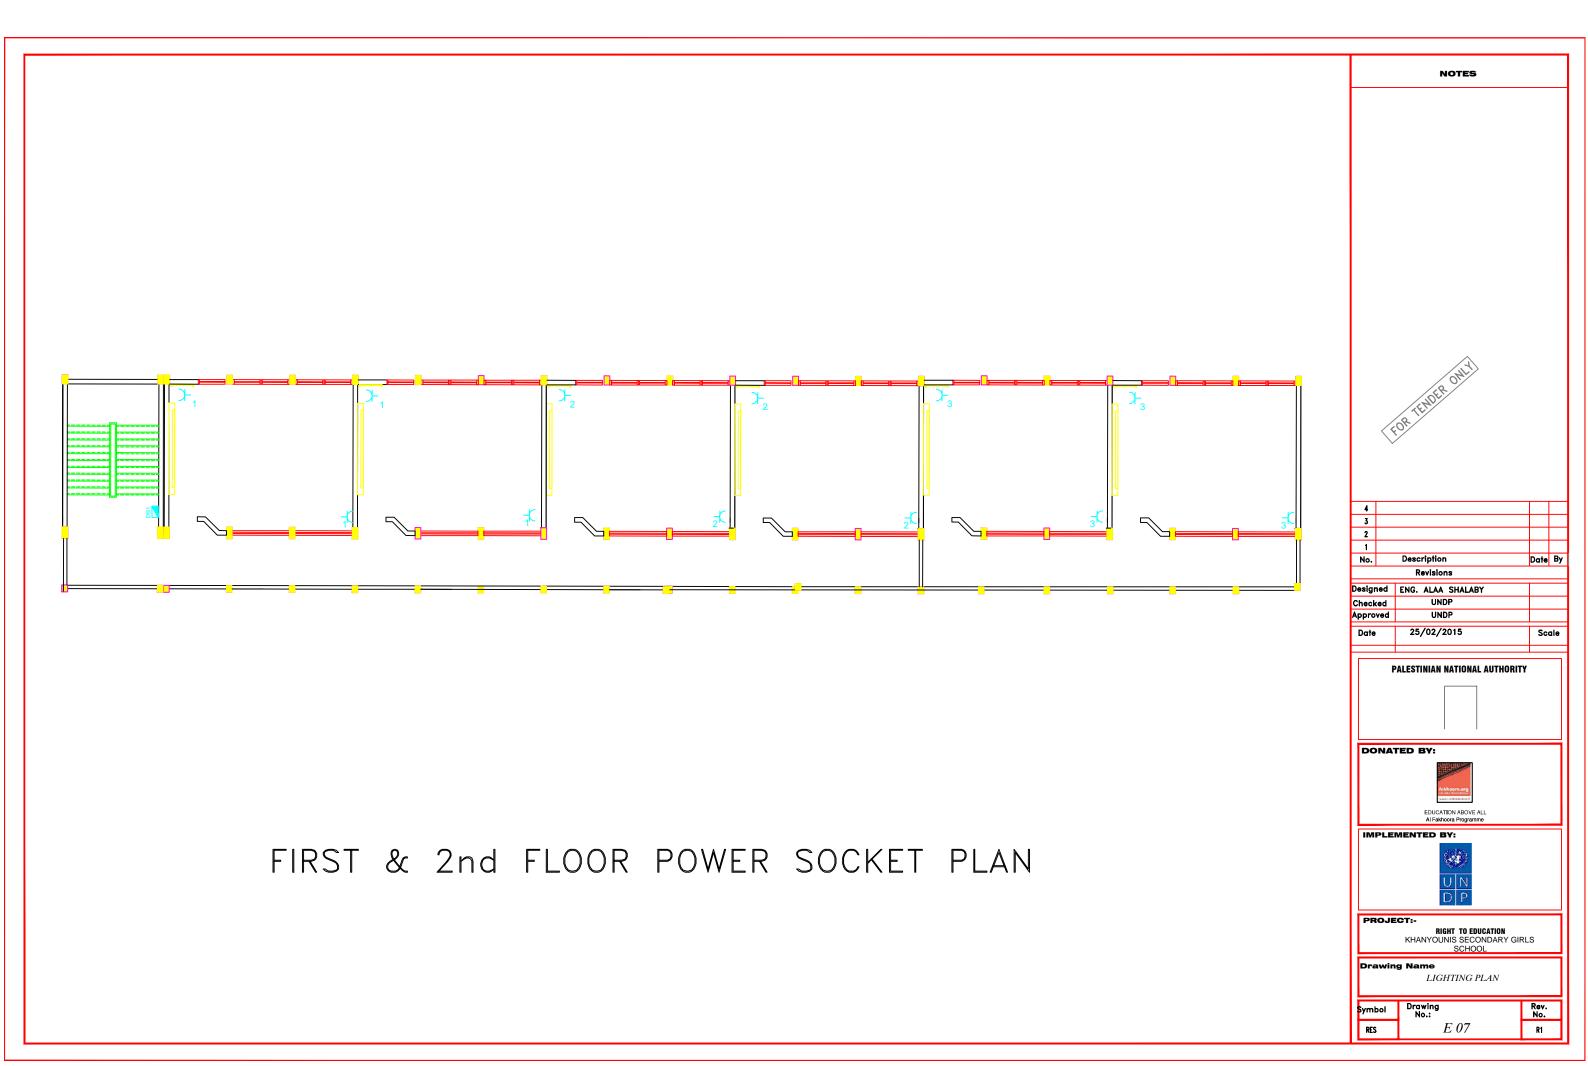


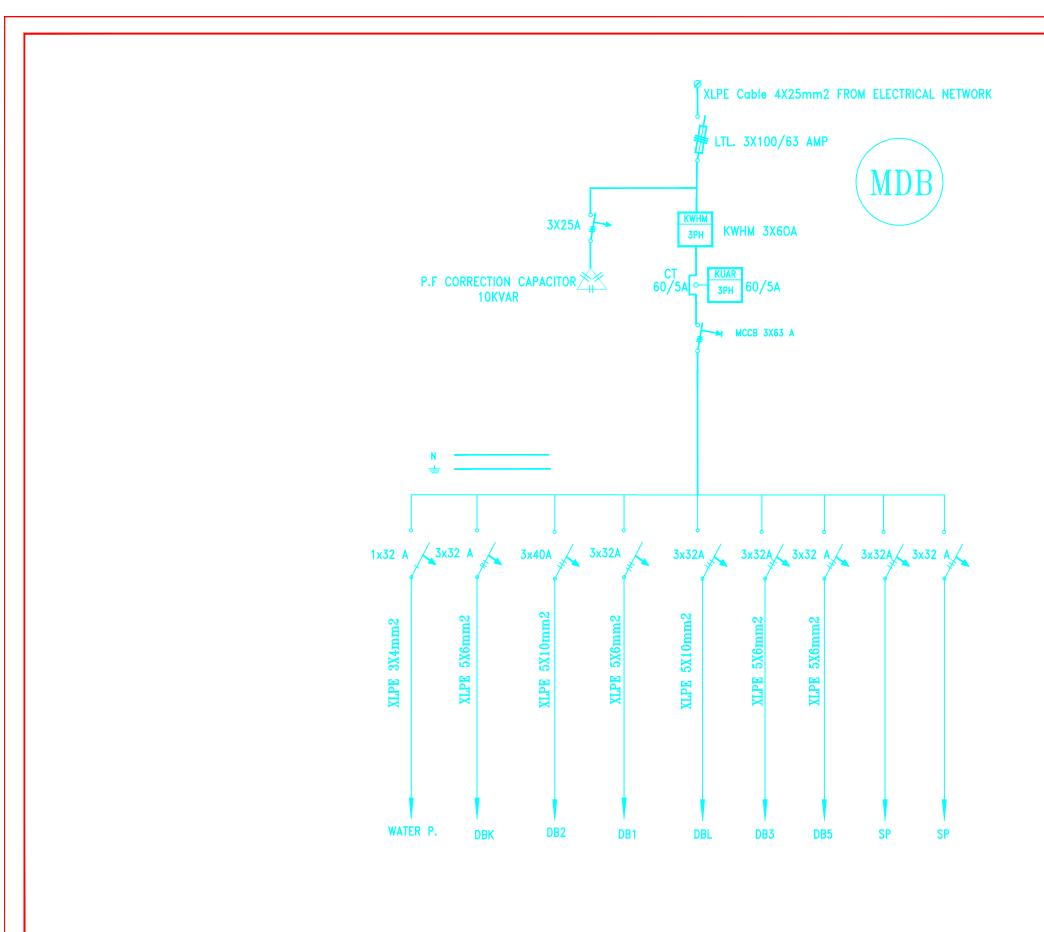


(MDB) SINGLE LINE DIAGRAM

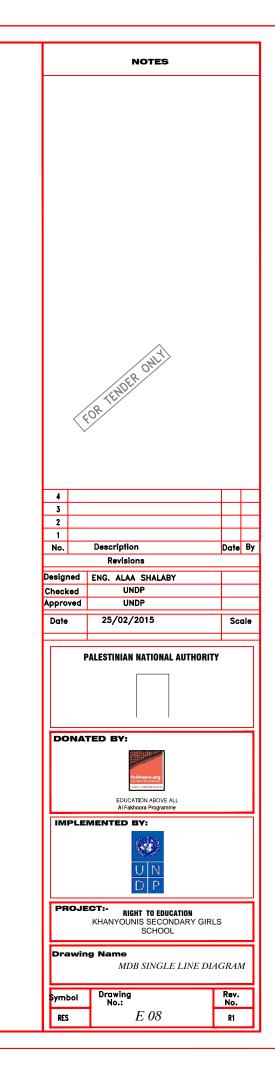

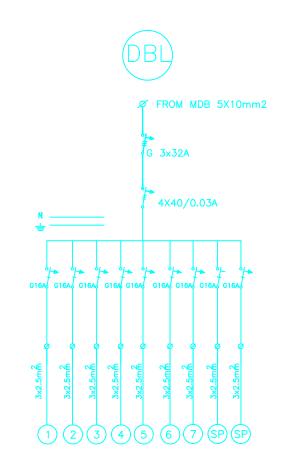

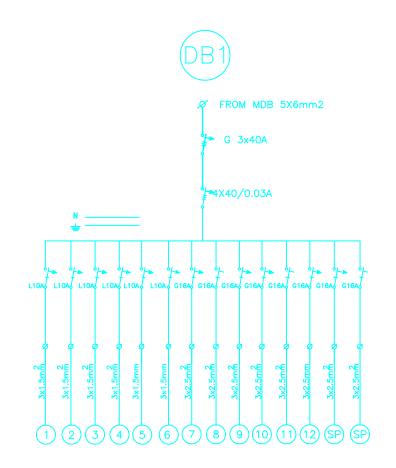

(SDB1, DBL) SINGLE LINE DIAGRAM

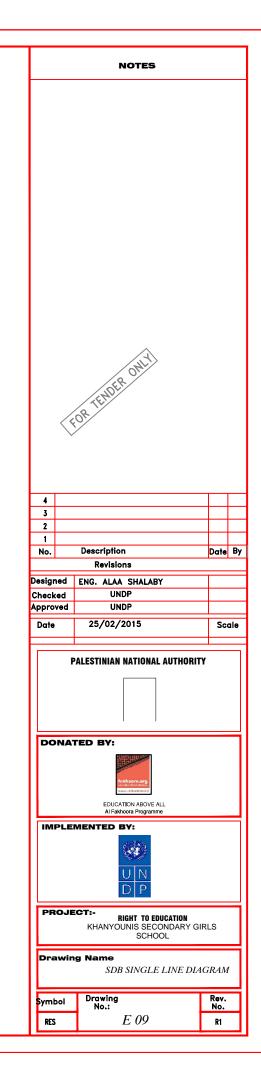



United Nations Development Programme
Programme of Assisstance the Palestinian People





Project Name


RIGHT TO EDUCATION

School name

SHOHADA' BANI SOHYLA SECONDARY GIRLS SCHOOL

March 2015

Architectural Drawings

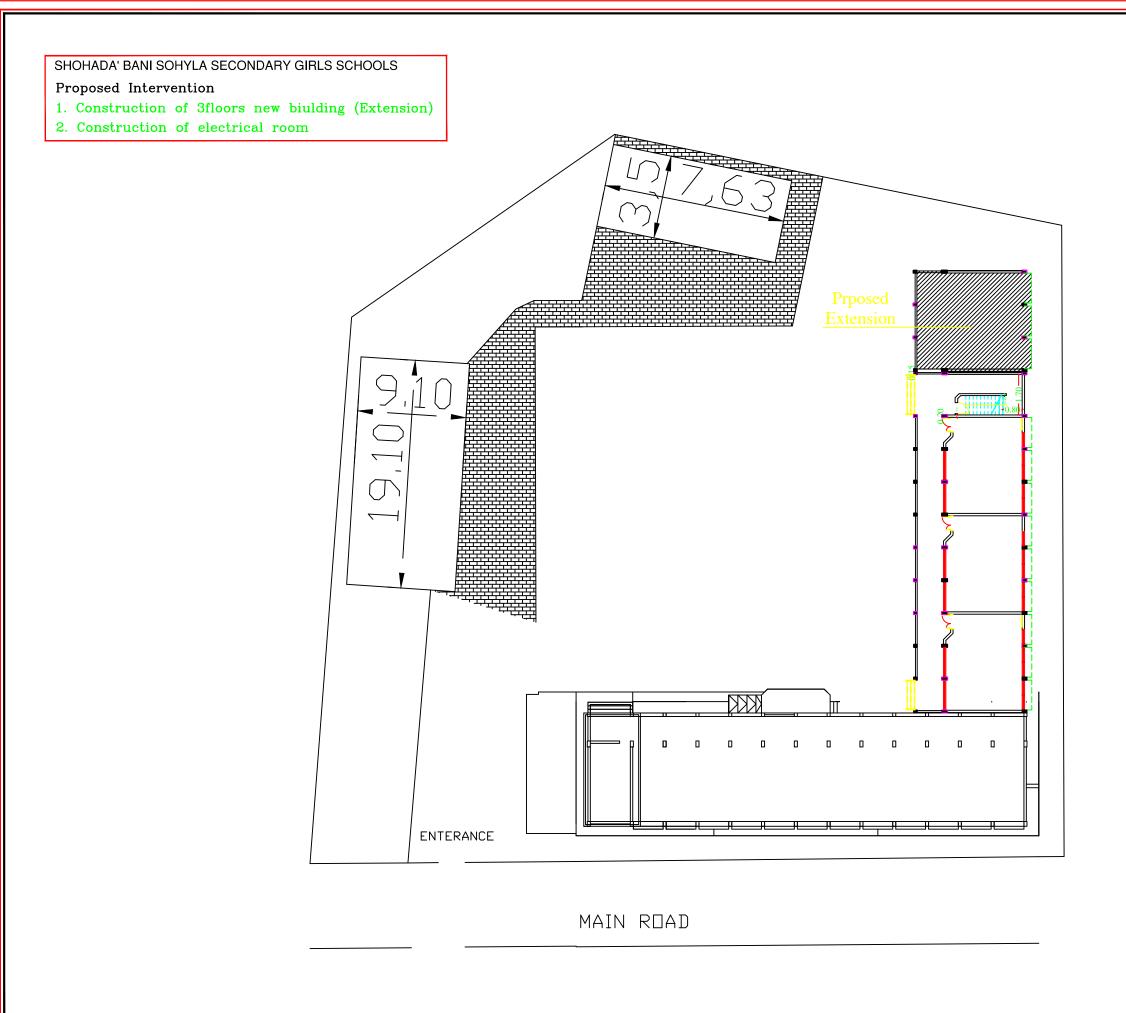

NOTES:

- PE1 = PLASTER & EMULSION PAINT (CEILING) WP1 = PLASTER & EMULSION PAINT (WALLS) P1 = TERRAZO TILE SIZE 30X30X2.5CM MARBLE

- PT = TERRAZO TILE SIZE 30A30AZ-S.CM MARBLE CHIPS

 SK1 = TERRAZO SKIRTING 1X7CM HIGH

 WP2 = CERAMIC WALL TILES UP TO LINTEL LEVEL
 & PLASTER AND EMULSION PAINT (WALLS)

 P2 = NONNE SLIP CERAMIC FLOOR TILES

 -FFL.(+0.00) IS THE FINISHED FLOOR LEVEL INDICATED
 IN THE SITE LAYOUT DRAWING.
- C1-ROUGH CONCRETE FINISH





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SHOHADA' BANI SOHYLA SECONDARY GIRLS SCHOOL


SITE LAY OUT

Symbol Drawing No.

ST 01

Rev. No.

R1

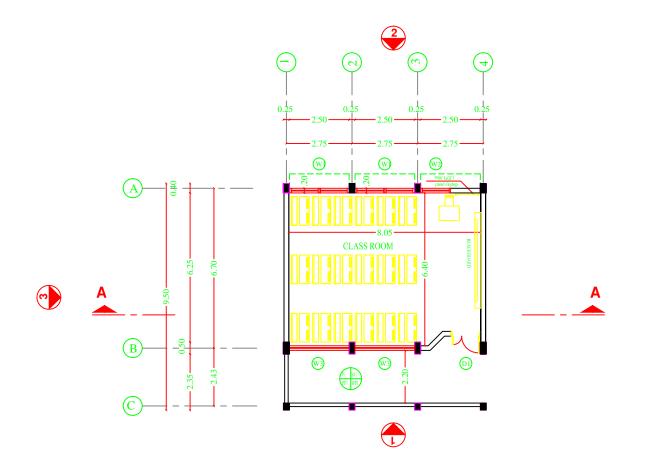

Ground, 1st & 2nd Floors


DOORS TABLE:


TYPE	DIM	NO.	NOTES
D1	1.25 x 2.20	2	
D2	0.90 x 2.20	-	
DS1	1.25 x 2.20	-	
DS2	0.90 x 2.10	-	
DS3	1.00 x 2.20	-	


WINDOWS TABLE:


TYPE	DIM	WINDOWS CELLS HIGH	NO.
W1	2.50 x 1.20	1.10	
W 2	1.25 x 1.20	1.10	
W3	2.50 x 0.80	1.60	



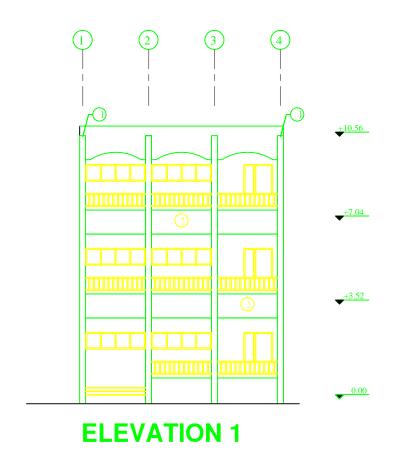

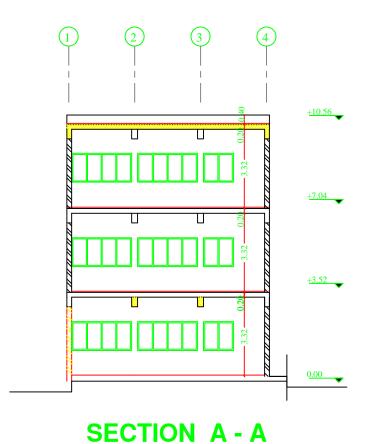


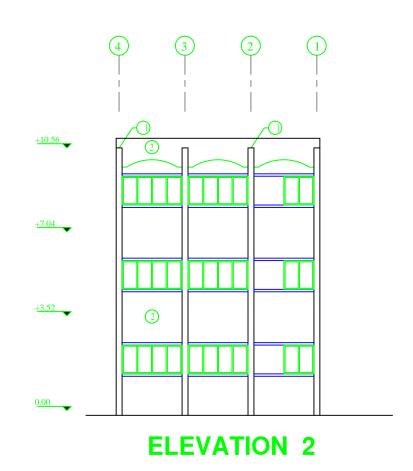

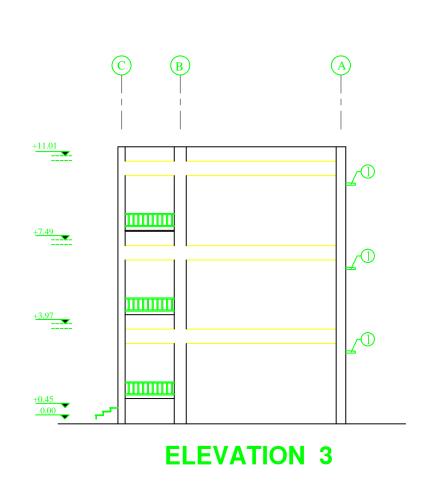




Structural Drawings

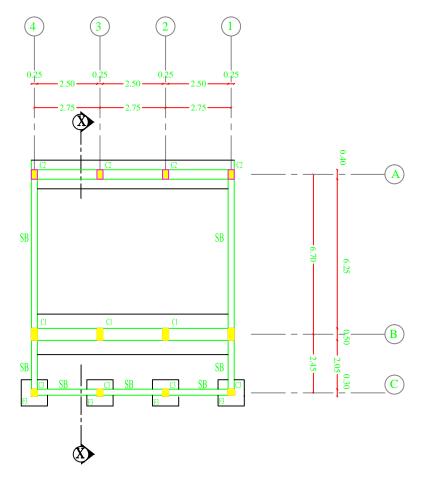

FOUNDATION PLAN

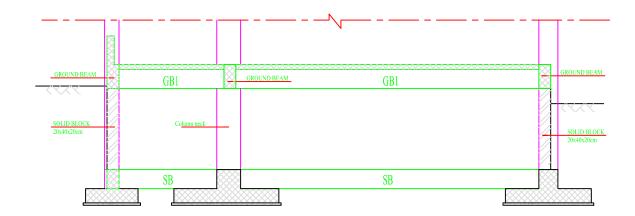

SECTION X-X

NOTES:

- DESIGN BEARING CAPACITY IS 1.25 KG/CM2
 THE CONTRACTOR HAS TO CONDUCT SOIL INVESTIGATION
 TO ENSURE THIS ASSUMPTION.
 EXCAVATION LEVEL SHOULD BE (-2.50) FROM THE
 LOWEST POINT FROM N.G.L. (Im. SHOULD BE REBACK
 FILL OF COMPACTED KURKAR.
 ALL CONOCRETE IN CONTACT WITH SOIL SHOULD
 CONTAIN TYPE SULFATE RESISTANT CEMENT.
 CONCRETE COVER FOR FOUNDATION SCM THICK
 CONCRETE COVER FOR INTERNAL WORK 3.5CM
 CONCRETE COVER FOR INTERNAL WORK 3.5CM
 CONCRETE COVER FOR EXTERNAL WORK 3.5CM
 ALL THE CONCRETE UP THE PLINTH LEVEL MUST BE
 COATED WITH TWO COATS OF HOT BETUNIA.
 READY MIX CONCRETE MUST BE APPROVED BY THE ENGINEER.
 BACKPELLING MUST BE CARRED OUT IN LAYPES 25CM
 THICK EACH LAYPE (WATERED AND COMPACTD)
 N.G.L WILL BE FIXED BY THE ENGINEER
 CONCRETE CUBE CRUSHINGS TERROTTH AFTER 28 DAYS
 B = 2SNMM2, FOR BEAMS & SLABS
 B = 30KMM2, FOR COLUMNS
 RIBBED HIGH YIELD STEEL FY=410N/MM2
 MILD YIELD STEEL FY=250N/MM2
 FOUNDATION WAS DESIGNED TO 10 HAVE GROUND FLOOR,
 FIRST, SECOND & THIRD FLOORS ONLY.
 STANDERN RADIO OF BENDS AND HOOKS AS GIVEN
 BELOW TO BE USED UNLESS SPECIFICALLY SHOWN OTHERWISE
 BENDS
 BENDS
 BENDS
 BONGS



BAR SIZE	GRADE 250 (TYPE AND GRADE R)	GRADE 410 (TYPE AND GRADE L)
D	R	R
6	12	18
8	16	24
10	20	30
12	24	36
14	28	42
16	32	48
18	36	54
20	40	60
25	50	100





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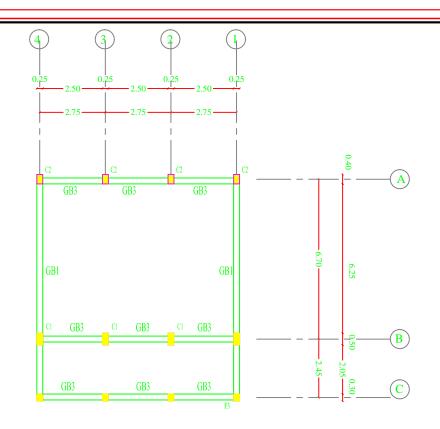
RIGHT TO EDUCATION

SHOHADA' BANI SOHYLA SECONDARY GIRLS SCHOOL


Drawing name

FOUNDATION PLAN


mbol	Drawing No.	Rev.
RES	S 01	R1




GROUND BEAM PLAN

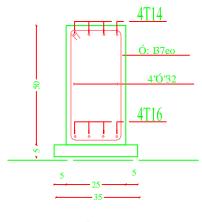


GB₁ SCALE 1:10

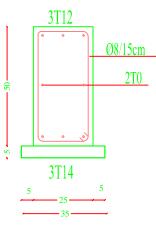


GB₃ SCALE 1:10

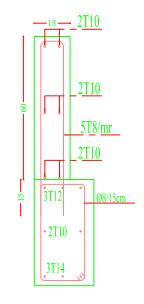

WALL PARAPET AT GROUND FLOOR CORRIDORS

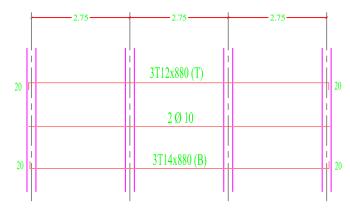

GB3

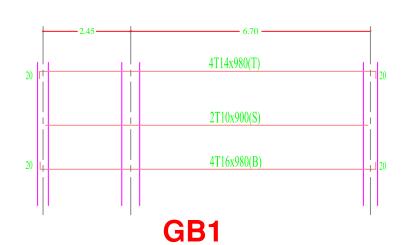

NOTES:

- DESIGN BEARING CAPACITY IS 1.25 KG/CM2
 THE CONTRACTOR HAS TO CONDUCT SOIL INVESTIGATION
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 EXCAVATION LEVEL SHOULD BE (2.25) FROM THE
 LOWEST POINT FROM NG.L. (Im SHOULD BE REBACK
 FILL OP COMPACTED KURKAR.
 ALL CONOCRETE IN CONTACT WITH SOIL SHOULD
 CONTAIN TYPE SULFATE RESISTANT CEMENT.
 CONCRETE COVER FOR FOUNDATION 5CM THICK
 CONCRETE COVER FOR FOUNDATION 5CM THICK
 CONCRETE COVER FOR FOUNDATION 5CM THICK
 CONCRETE COVER FOR ENTERNAL WORK 2.5CM
 CONCRETE COVER FOR ENTERNAL WORK 3.5CM
 ALL THE CONCRETE UP THE PLINTH LEVEL MUST BE
 COATED WITH TWO COATS OF HOT BETUMIN
 READY MIX CONCRETE MUST BE APPROVED BY THE ENGINEER
 BACKFILLING MUST BE CARRIED OUT IN LAYERS 25CM
 THICK EACH LAYER (WATERD AND COMPACTD)
 N.G. WILL BE FIXED BY THE ENGINEER
 CONCRETE CUBE CRUSHING STRENGTH AFTER 28 DAYS
 B = 30K/MMZ, FOR BEAMS & SLABS
 B = 30K/MMZ, FOR BEAMS & SLABS
 B = 30K/MMZ, FOR SOUNMS
 RIBBED HIGH YIELD STEEL FY-410K/MMZ
 MILD YIELD STEEL FY-250K/MMZ
 FOUNDATION WAS DESIGNED TO HAVE GROUND FLOOR,
 FIRST, SECOND & THIRD FLOORS ONLY.
 STANDERD RADIO OF BENDS AND HOOKS AS GIVEN







BAR SIZE	GRADE 250 (TYPE AND GRADE R)	GRADE 410 (TYPE AND GRADE L)
D	R	R
6	12	18
8	16	24
10	20	30
12	24	36
14	28	42
16	32	48
18	36	54
20	40	60
25	50	100





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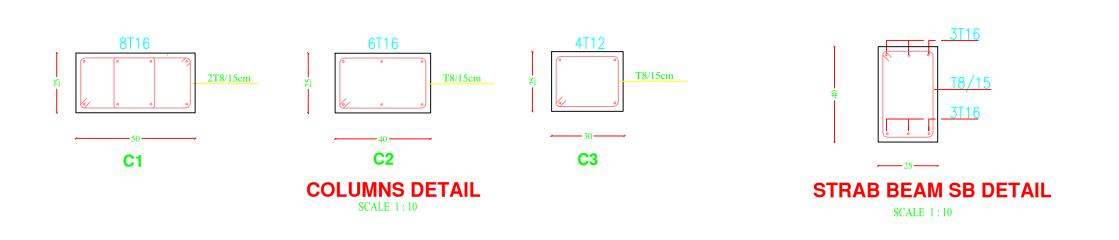
RIGHT TO EDUCATION


SHOHADA' BANI SOHYLA SECONDARY GIRLS SCHOOL

Drawing name


GROUND BEAMS


Symbol	Drawing No.	Rev. N
RES	S 02	R1



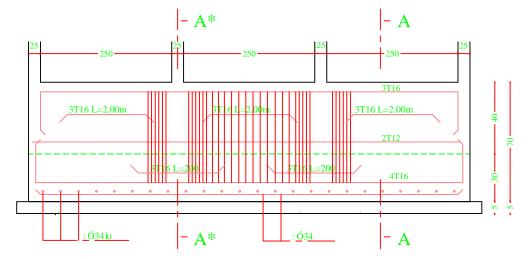

REINFORCEMENT DETAILS FOR F1 (1.80x0.30x0.40){DET.2}

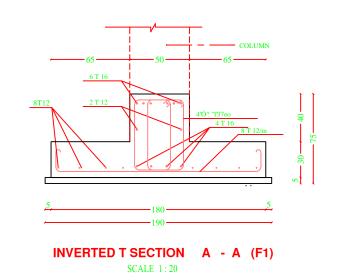

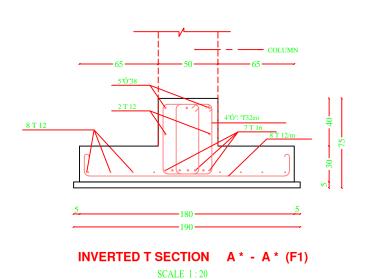

NOTES: - DESIGN BEARING CAPACITY IS 1.25 KG/CM2 THE CONTRACTOR HAS TO CONDUCT SOIL INVESTIGATION TO ENSURE THIS ASSUMPTION . THE CONTRACTOR HAS TO CONDUCT SOIL INVESTIGATION TO ENSURE THIS ASSUMPTION. - EXCAVATION LEVEL SHOULD BE (-2.50) FROM THE LOWEST POINT FROM N.G.L. (In SHOULD BE REBACK FILL OF COMPACTED KURKAR! - ALL CONOCRETE IN CONTACT WITH SOIL SHOULD CONTAIN TYPE SULFATE RESISTANT CEMENT. - CONCRETE COVER FOR FOUNDATION - 5CM THICK - CONCRETE COVER FOR ENTERNAL WORK - 2.5CM - CONCRETE COVER FOR ENTERNAL WORK - 3.5CM - ALL THE CONCRETE UP THE PLINTH LEVEL MUST BE - COATED WITH TWO COATS OF HOT BETUMIN. - READY MIX CONCRETE MUST BE APPROVED BY THE ENGINEER. - BACKFILLING MUST BE CARRIED OUT IN LAYERS 32CM - THICK EACH LAYER (WATERD AND COMPACTD) - N.G.L. WILL BE FIXED BY THE ENGINEER - CONCRETE CUBE CRUSHING STRENGTH AFTER 28 DAYS - B = 30%MMZ, FOR SEAMS & SLABS - B = 30%MMZ, FOR COLUMNS - RIBBED HIGH VIELD STEEL FY-410%MMZ - MILD YIELD STEEL FY-410%MMZ - FOUNDATION WAS DESIGNED TO HAVE GROUND FLOOR, FIRST, SECOND & THIRD FLOORS ONLY. - STANDERD RADIO OF BENDS AND HOOKS AS GIVEN - STANDERD RADII OF BENDS AND HOOKS AS GIVEN BELOW TO BE USED UNLESS SPECIFICALLY SHOWN OTHERWISE GRADE 250 (TYPE AND GRADE R) GRADE 410 PE AND GRADE L PALESTINIAN NATIONAL AUTHORITY DONATED BY EDUCATION ABOVE ALL AI Fakhoora Programme IMPLEMENTED BY United Nations Development Programme Programme of Assisstance the Palestinian People RIGHT TO EDUCATION SHOHADA' BANI SOHYLA SECONDARY GIRLS SCHOOL

FOUNDATIONS AND COLUMN DETAILS


S 03

Rev. No.


R1

Symbol Drawing No.


RES

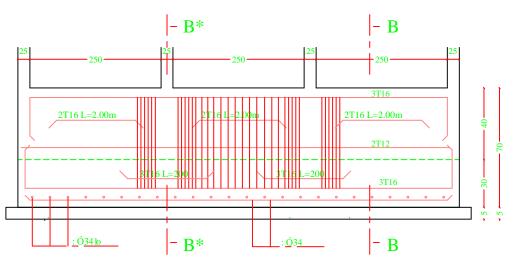


REINFORCEMENT DETAILS FOR F2 (1.40x0.30x0.40){DET.3}

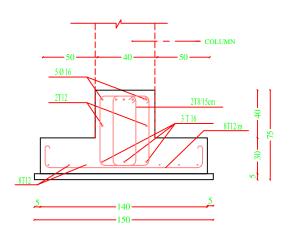


INVERTED T SECTION B - B (F2) SCALE 1:20

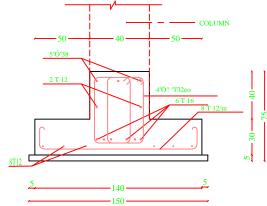


INVERTED T SECTION B * - B * (F2)

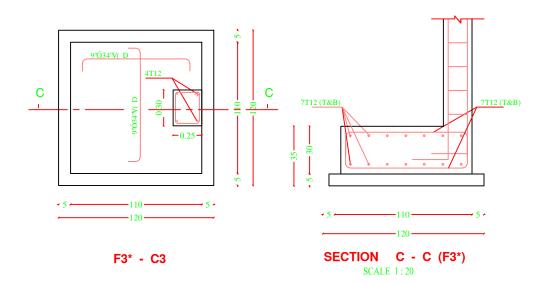

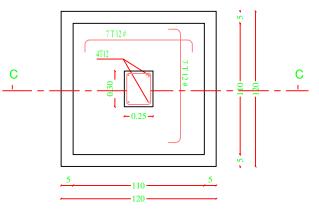



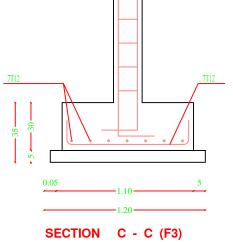

SCALE 1:20

NOTES:

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THE CONTRACTOR HAS TO CONDUCT SOIL INVESTIGATION
TO ENSURE THIS ASSUMPTION.
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LOWEST POINT FROM N.G.L. (I IM SHOULD BE REBACK
FILL OF COMPACTED KURKAR.
- ALL CONOCRETE IN CONTACT WITH SOIL SHOULD
CONTAIN TYPE SULFATE RESISTANT CEMENT.
- CONCRETE COVER FOR FOUNDATION - 5CM THICK
- CONCRETE COVER FOR INTERNAL WORK - 2.5CM
- CONCRETE COVER FOR INTERNAL WORK - 3.5CM
- ALL THE CONCRETE UP THE PLINTH LEVEL MUST BE
COATED WITH TWO COATS OF HOT BETWINN.
READY MIX CONCRETE MUST BE APPROVED BY THE ENGINEER.
- BACKFILLING MUST BE CARRIED OUT IN LAYERS 35CM
- THICK EACH LAYER (WATERED AND COMPACTIT)
- N.G.L WILL BE FIXED BY THE ENGINEER
- CONCRETE CUBE CRUSHING STRENGTH AFTER 28 DAYS
- B = 30KMMZ, FOR BEAMS & SLABS
- B = 30KMMZ, FOR BEAMS & SLABS
- RIBBED HIGH YIELD STEEL FY-410KMMZ
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BELOW TO BE USED UNLESS SPECIFICALLY SHOWN OTHERWISE

PALESTINIAN NATIONAL AUTHORITY

DONATED BY

EDUCATION ABOVE ALL AI Fakhoora Programme IMPLEMENTED BY

United Nations Development Programme Programme of Assisstance the Palestinian People

RIGHT TO EDUCATION

SHOHADA' BANI SOHYLA SECONDARY GIRLS SCHOOL


GRADE 410 PE AND GRADE L


GRADE 250 (TYPE AND GRADE R)

FOUNDATIONS AND COLUMN DETAILS

Symbol	Drawing No.	Rev. No
RES	S 04	R1


SCALE 1:20

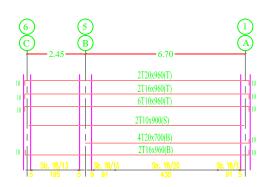

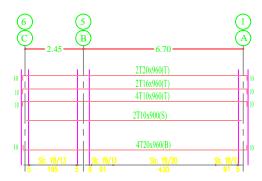


B1


B2

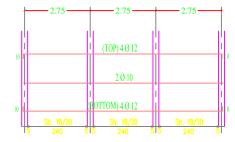


B7

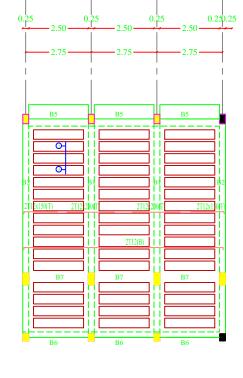

TYPICAL SLAB

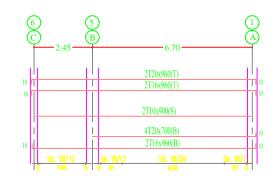



B3

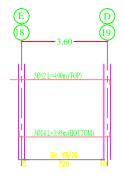


B4



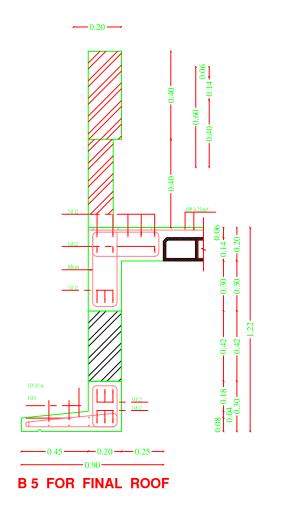


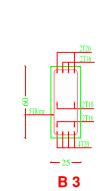


B 1

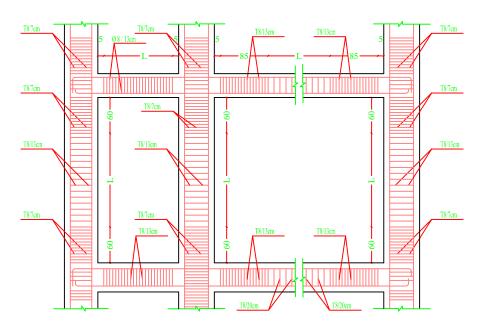



STIRRUPS SPACING IN COLUMNS & BEAMS

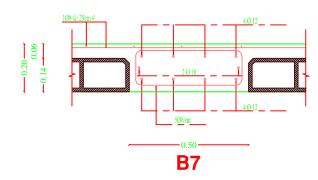

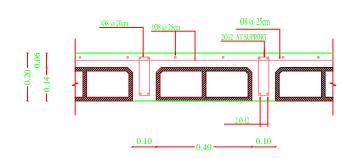



SECTION A-A

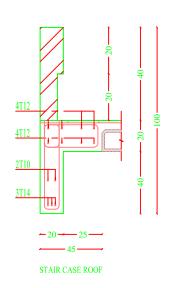

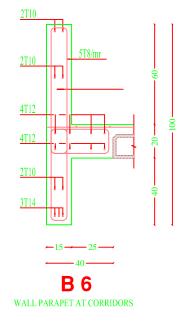

B 2

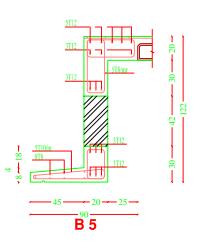

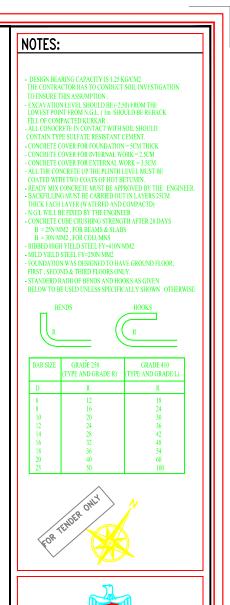



DONATED BY



EDUCATION ABOVE ALL AI Fakhoora Programme

IMDI EMENTED B



United Nations Development Programme
Programme of Assisstance the Palestinian People

Project Name

RIGHT TO EDUCATION

School name


SHOHADA' BANI SOHYLA SECONDARY GIRLS SCHOOL

Drawing name


SLAB DETAILS

Symbol	Drawing No.	Rev. N
RES	S 06	R1


The Contractor has to submnit detailed Shop Drawings of all works for approval Of the supervisor Engineer

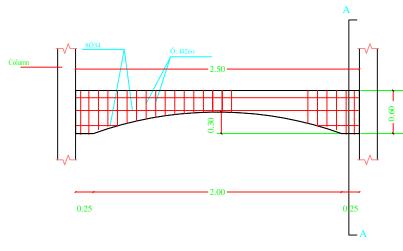


Details of Arches in Second Floor Back Elevations SCALE 1:50

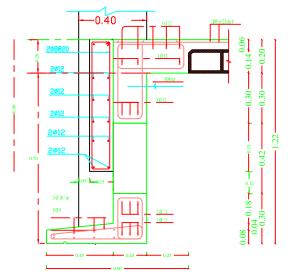

FINAL ROOF FOR BACK ELEVATION

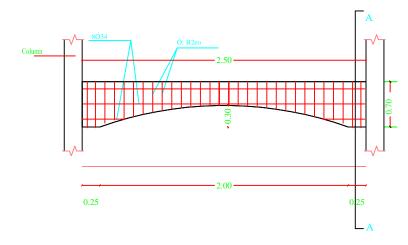

Details of Arches in Second Floor Front Elevations **SCALE** 1:50

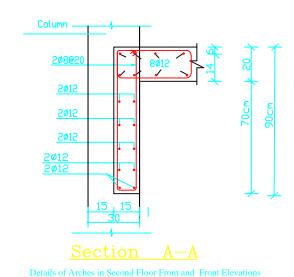

NOTES:

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 STANDERD RADIO OF BENDS AND HOOKS AS GIVEN.

- STANDERD RADII OF BENDS AND HOOKS AS GIVEN
 BELOW TO BE USED UNLESS SPECIFICALLY SHOWN OTHERWISE





BAR SIZE	GRADE 250 (TYPE AND GRADE R)	GRADE 410 (TYPE AND GRADE L)
D	R	R
6	12	18
8	16	24
10	20	30
12	24	36
14	28	42
16	32	48
18	36	54
20	40	60
25	50	100





PALESTINIAN NATIONAL AUTHORITY

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EDUCATION ABOVE ALL AI Fakhoora Programme

IMPLEMENTED BY



United Nations Development Programme Programme of Assisstance the Palestinian People


RIGHT TO EDUCATION


SHOHADA' BANI SOHYLA SECONDARY GIRLS SCHOOL

Drawing name


ARCH DETAILS

Symbol Drawing No. Rev. No. S 07 R1 RES

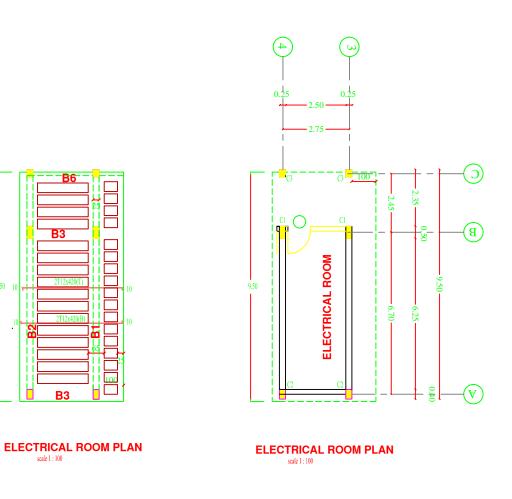


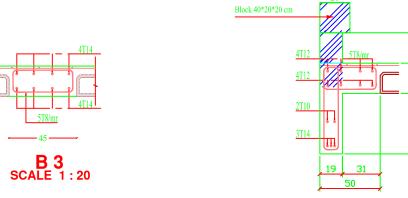




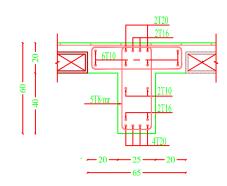

B 1 SCALE 1:20

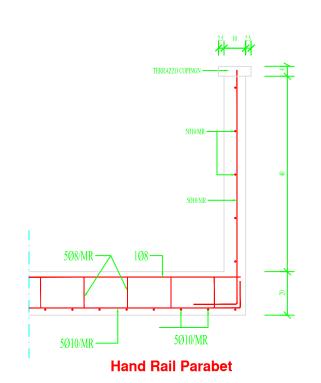

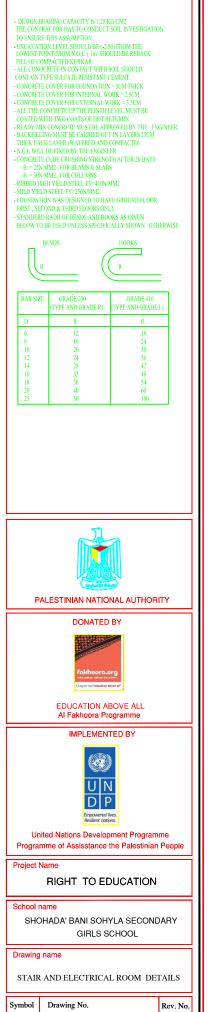


S08


RES

R1

NOTES:

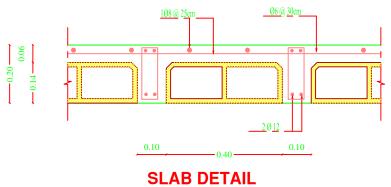


scale 1:100

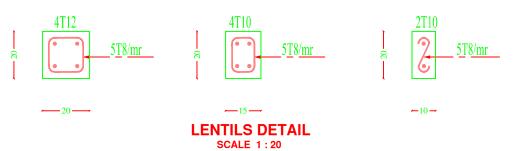



B 2 SCALE 1:20

Mechanical Drawings

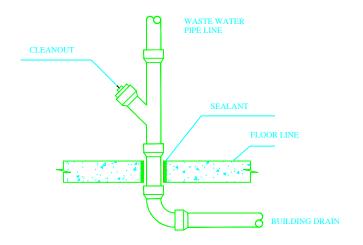


DRAINAGE PIPE CONNECTION DETAIL

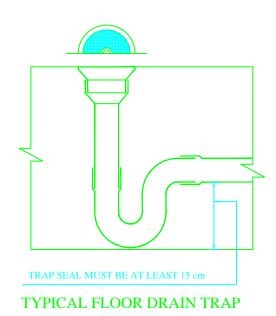


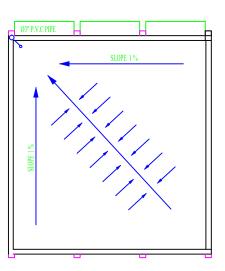

DRAINAGE PLAN

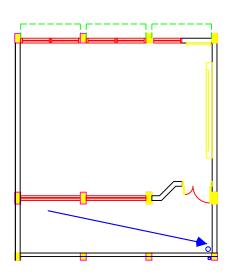

GROUND FIRST & SECOND FLOOR SANITARY PLAN

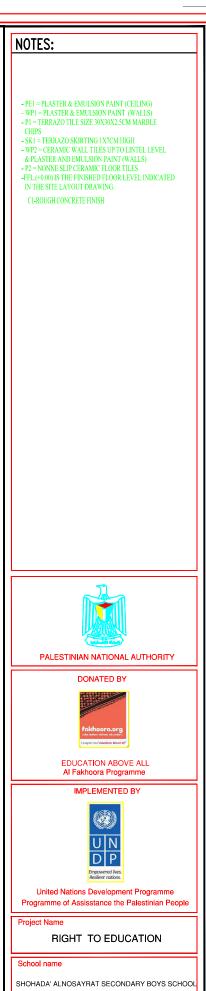



MECHANICAL WORKS

M 01


R1


Symbol Drawing No.


Electrical Drawings


كلوب مربع لرقم البيت	
نجفة مثبتة في السقف	
نجفة مثبتة <i>في</i> الحائط	
مصباح سقف عادی معلق	\oplus
مصباح حائط عادی	\bigoplus
معباح حائط خانت	
مصباح البقعة	
معباح مراة الحمام	
مروحة سقف	
مروحة شفط	
مدفاة حمام	
مفتاح مروحة سقف	\bigcirc
مفتاح مدفاة الحمام	<u>(</u>
مفتاح سخان الحمام	⊕ W.H
وحدة الانتركوم الداخلية	T
وحدة الانتركوم الخارجية	I
لوحة توزيع كمرباء رئيسية	
لوحة توريع كهرباء فرعية	SDB
لوحة توريع اتصالات رئيسية	
لوحة توريع اتصالات فرعية	
1	


دول الرموز الكمربائية	<u>ې</u>
البيان	الرصر
مفتاح کهرباء مفرد	
مفتاح كهرباء مردوج	F
مفتاخ ثلاثي	F
ضاغط جر س	<u></u>
فاغط انارة الدرج	0
جرس گھرباء	
مخرج کهرباء عادی ش	+
مخرج کهرباء بغطاء بس	
مخرج کمرباء عادی ۳ فار	<u></u>
مخرج کمرباء بغطاء ۳فاز	
مخرج كمرباء بمفتاح لزوم مكيف	AC
مخرج ساتالایت	
مخرج تليفون	
مصباح فلورسنت مفرد	
مصباح فلورسنت مردوج	
مهباح فلورسنت مستطيل شاحن	
مصباح حائط دائري	
ڪلوب دائري	+
ڪلوب ڪروي م ائ ل	

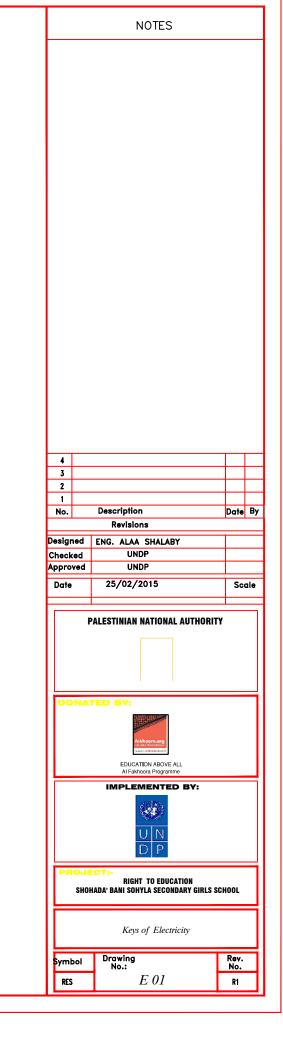


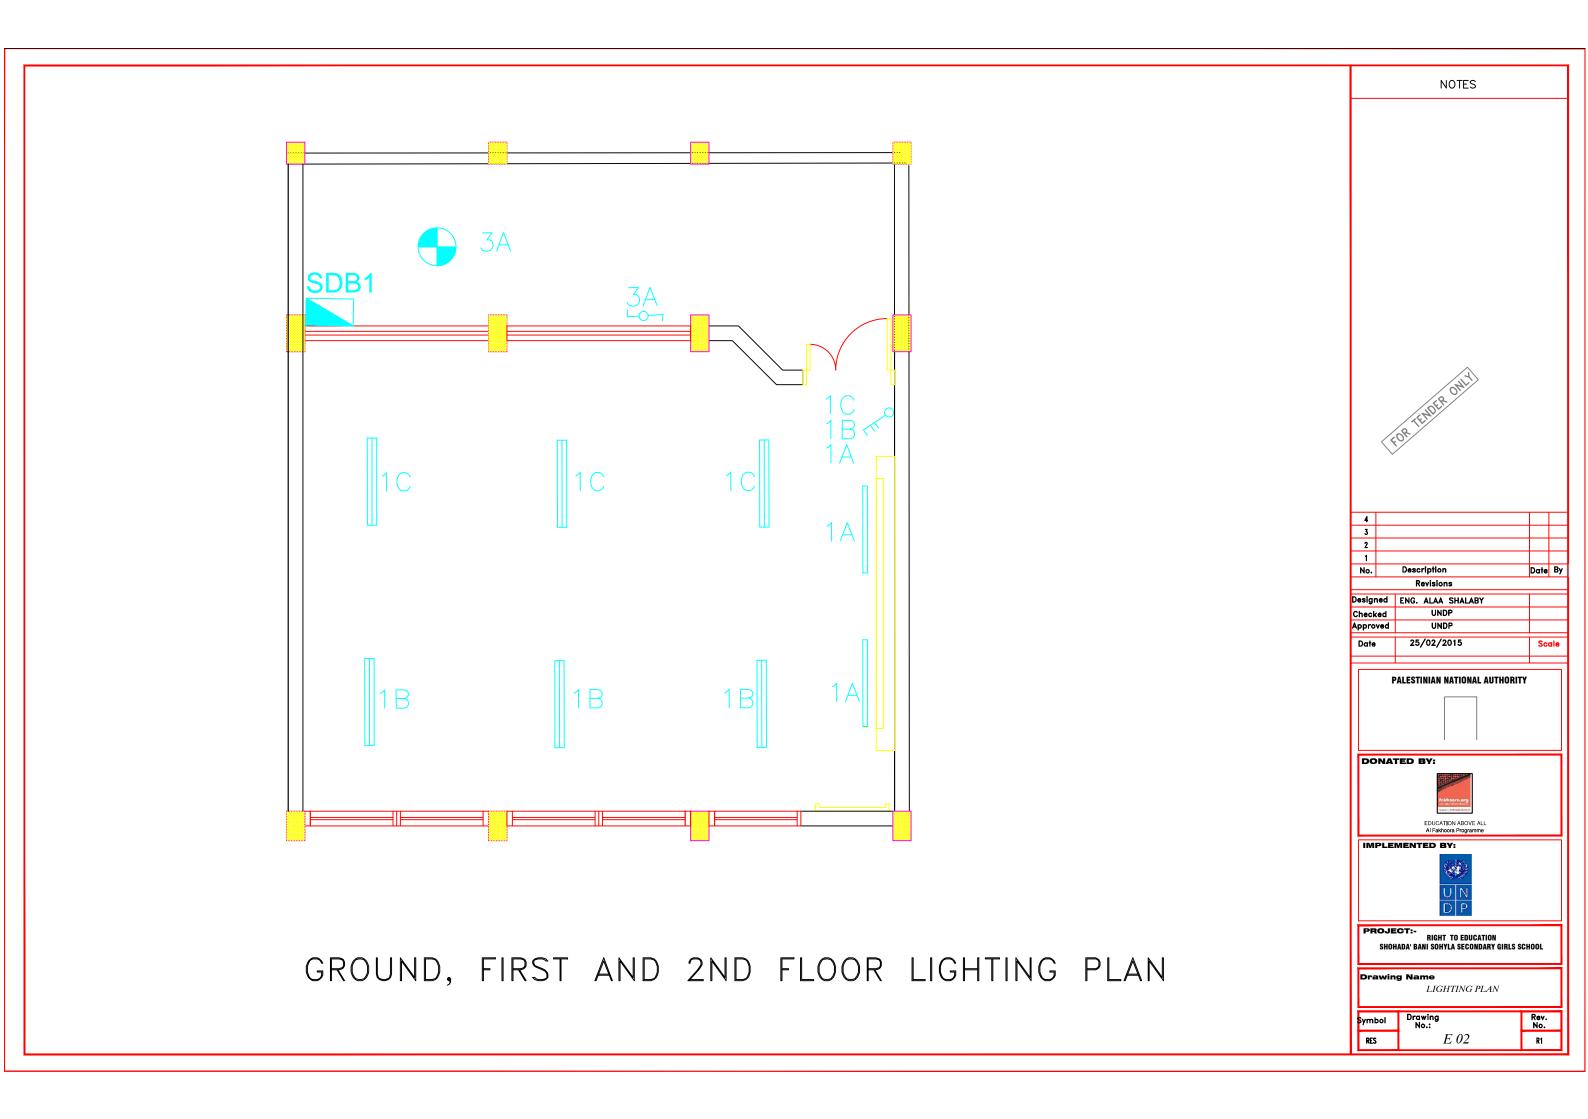

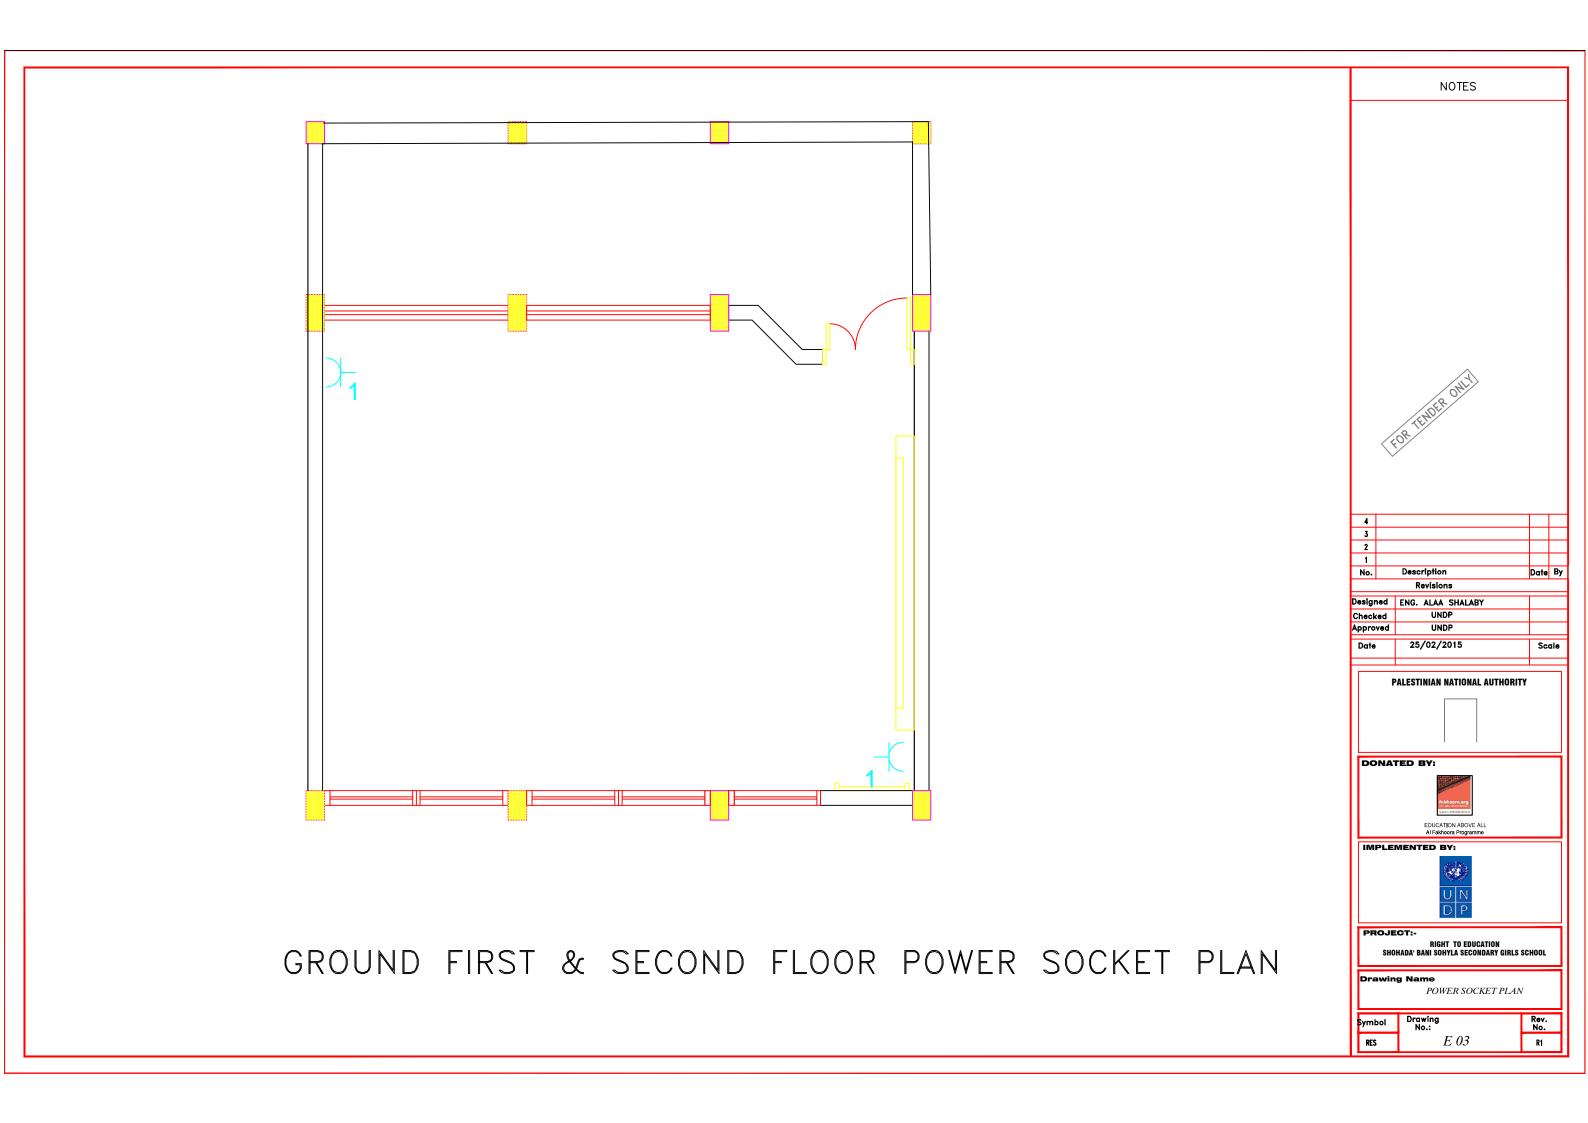

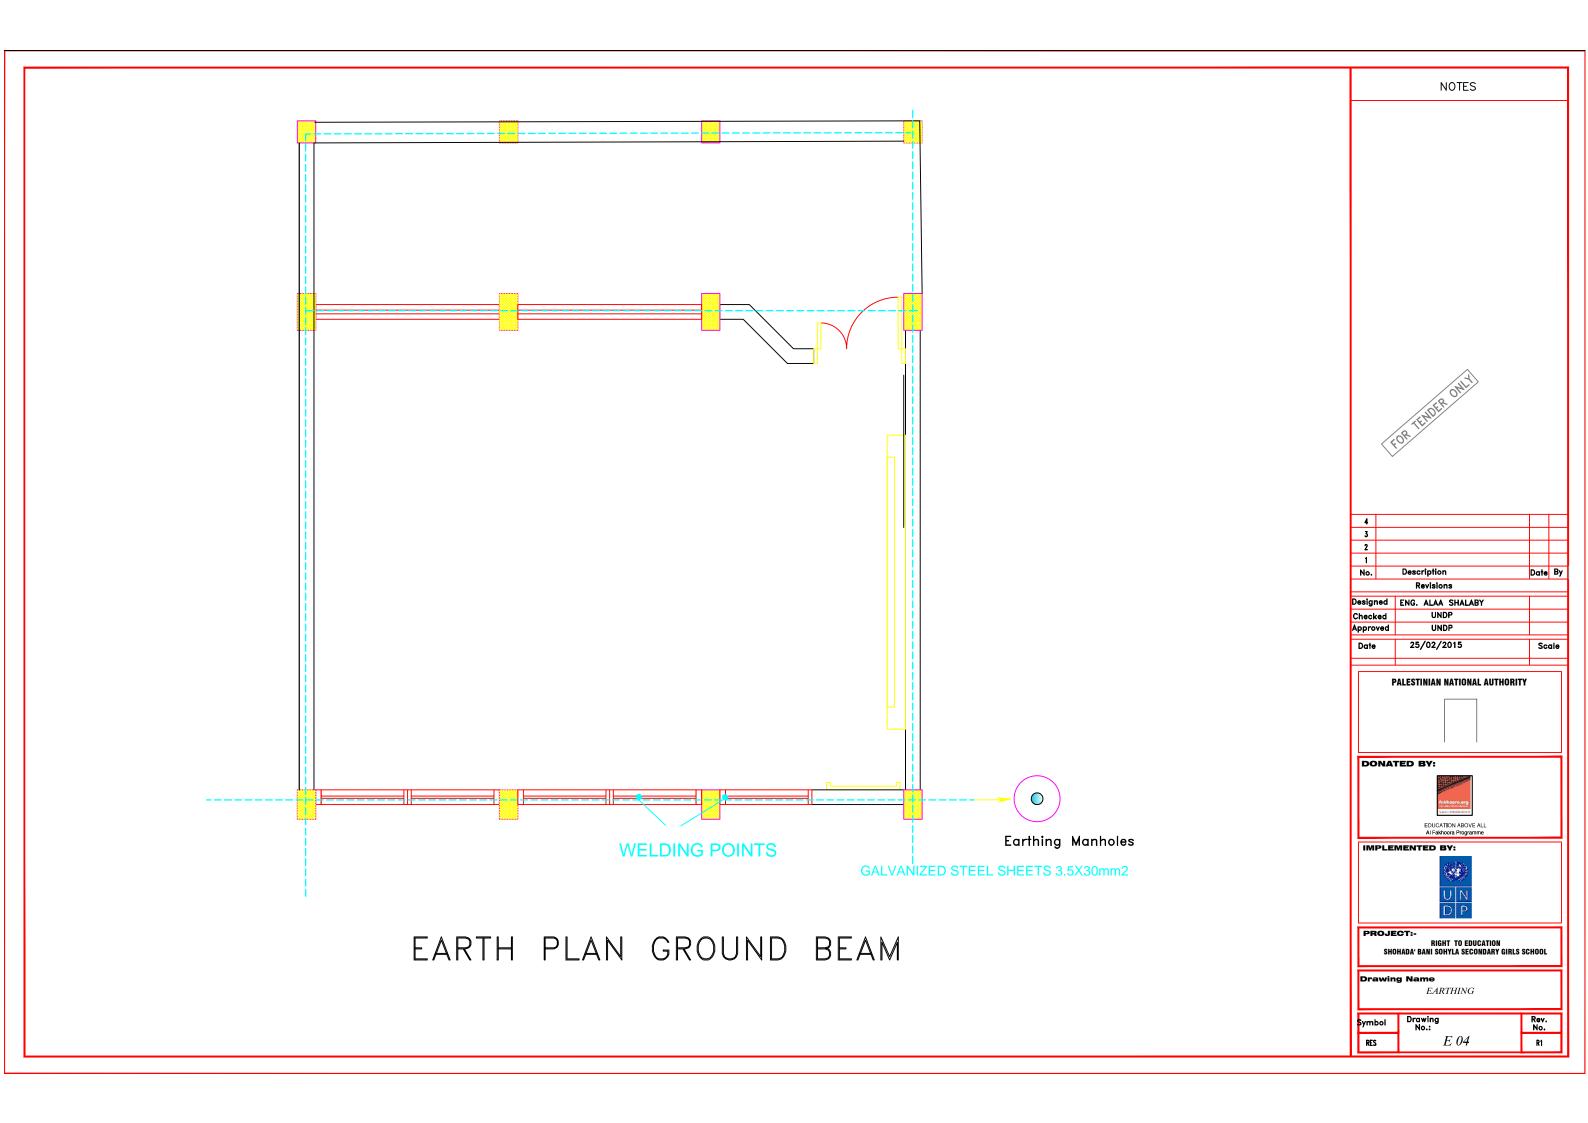


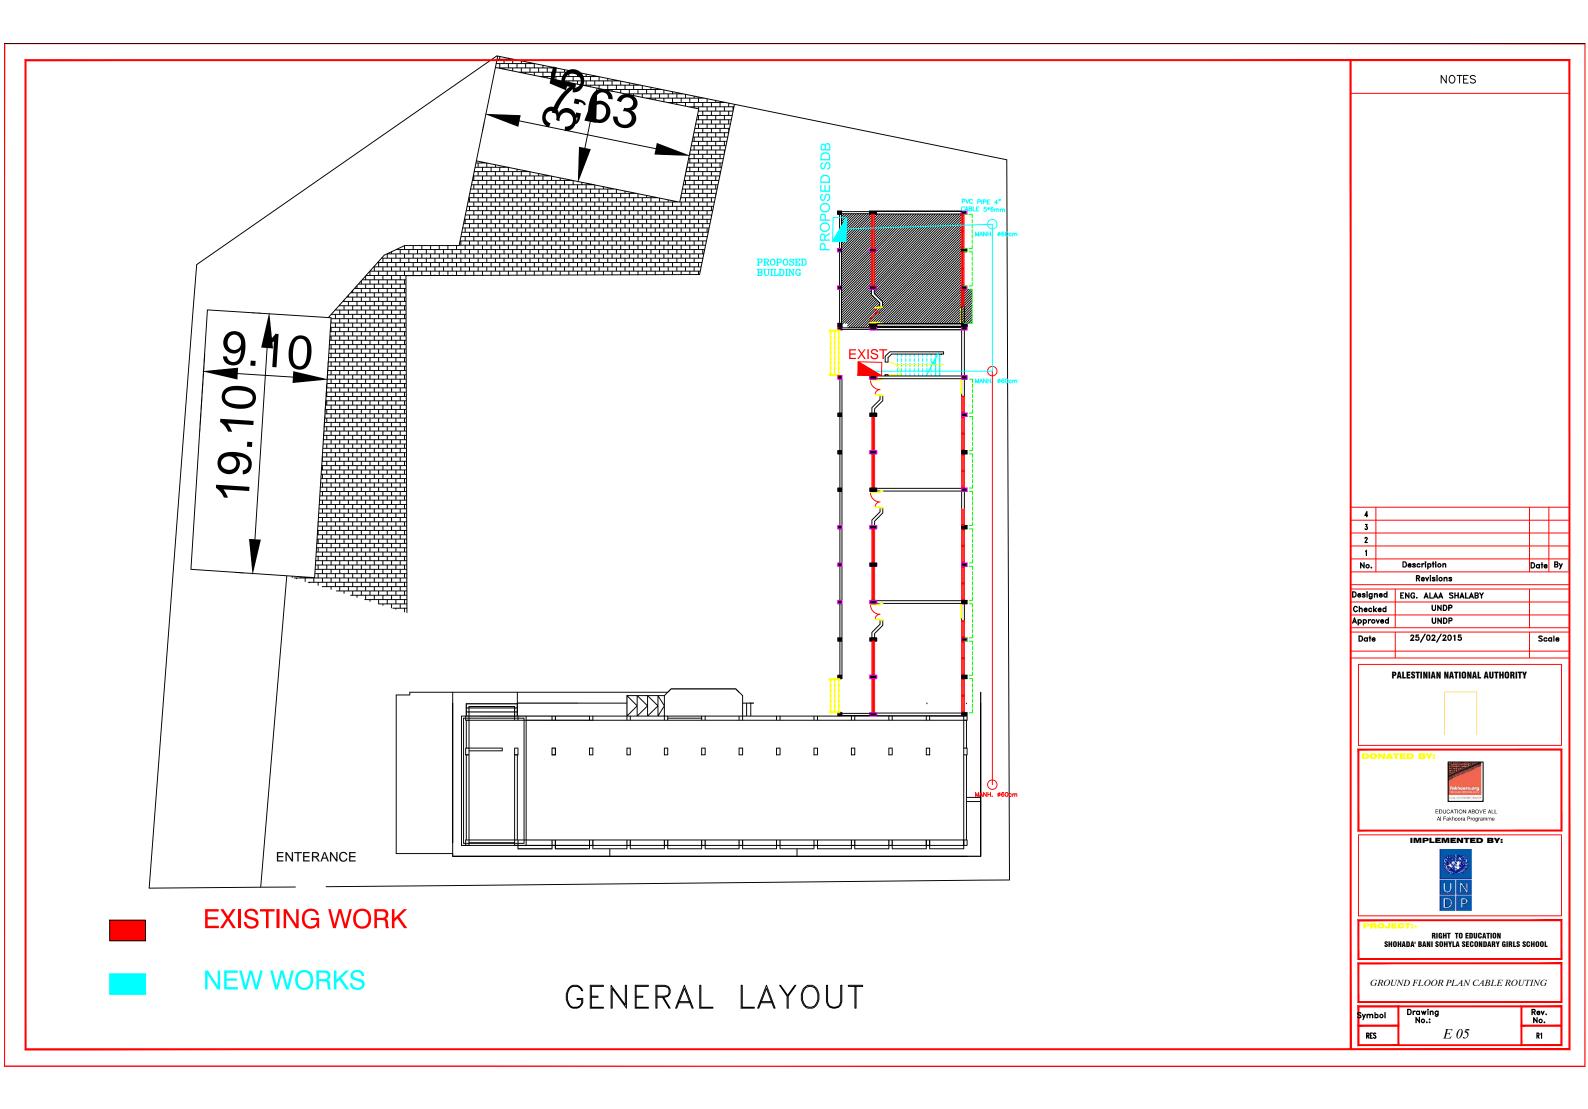


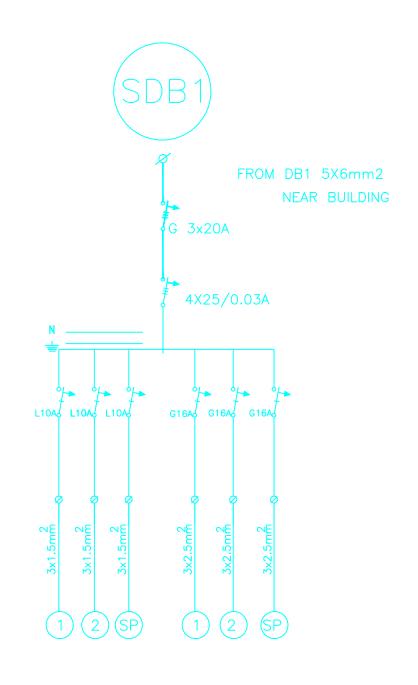

(SDB1) SINGLE LINE DIAGRAM



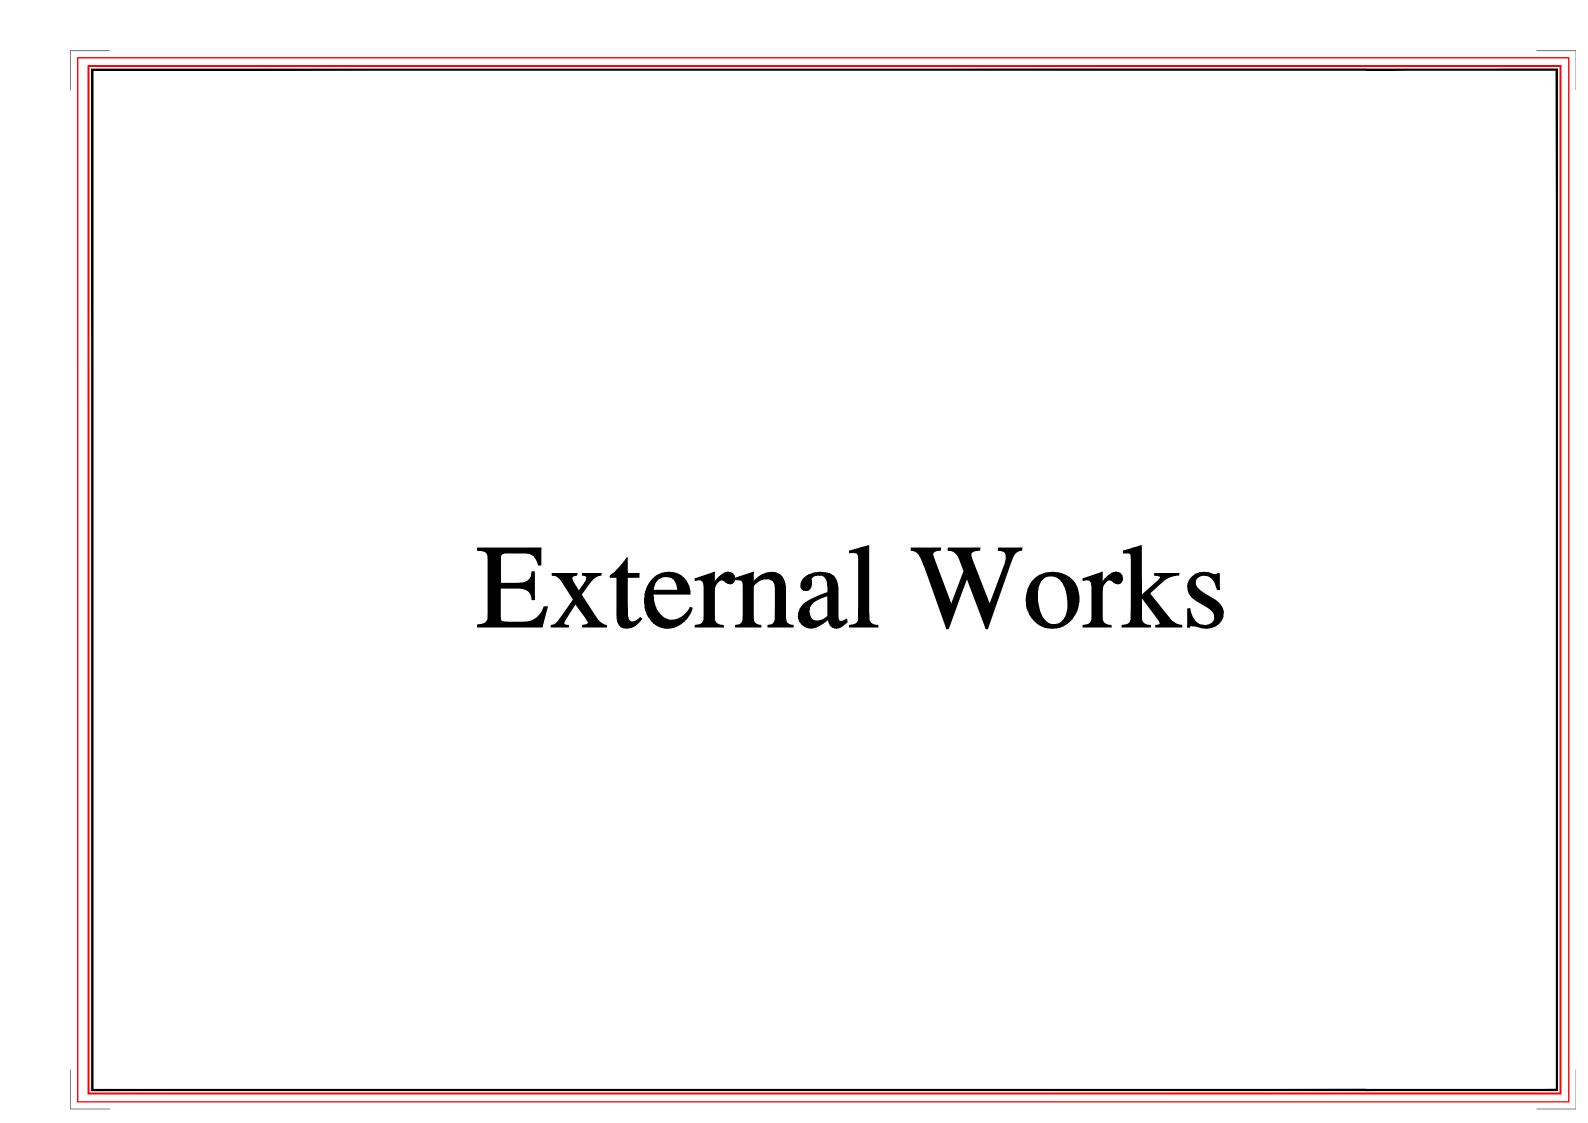

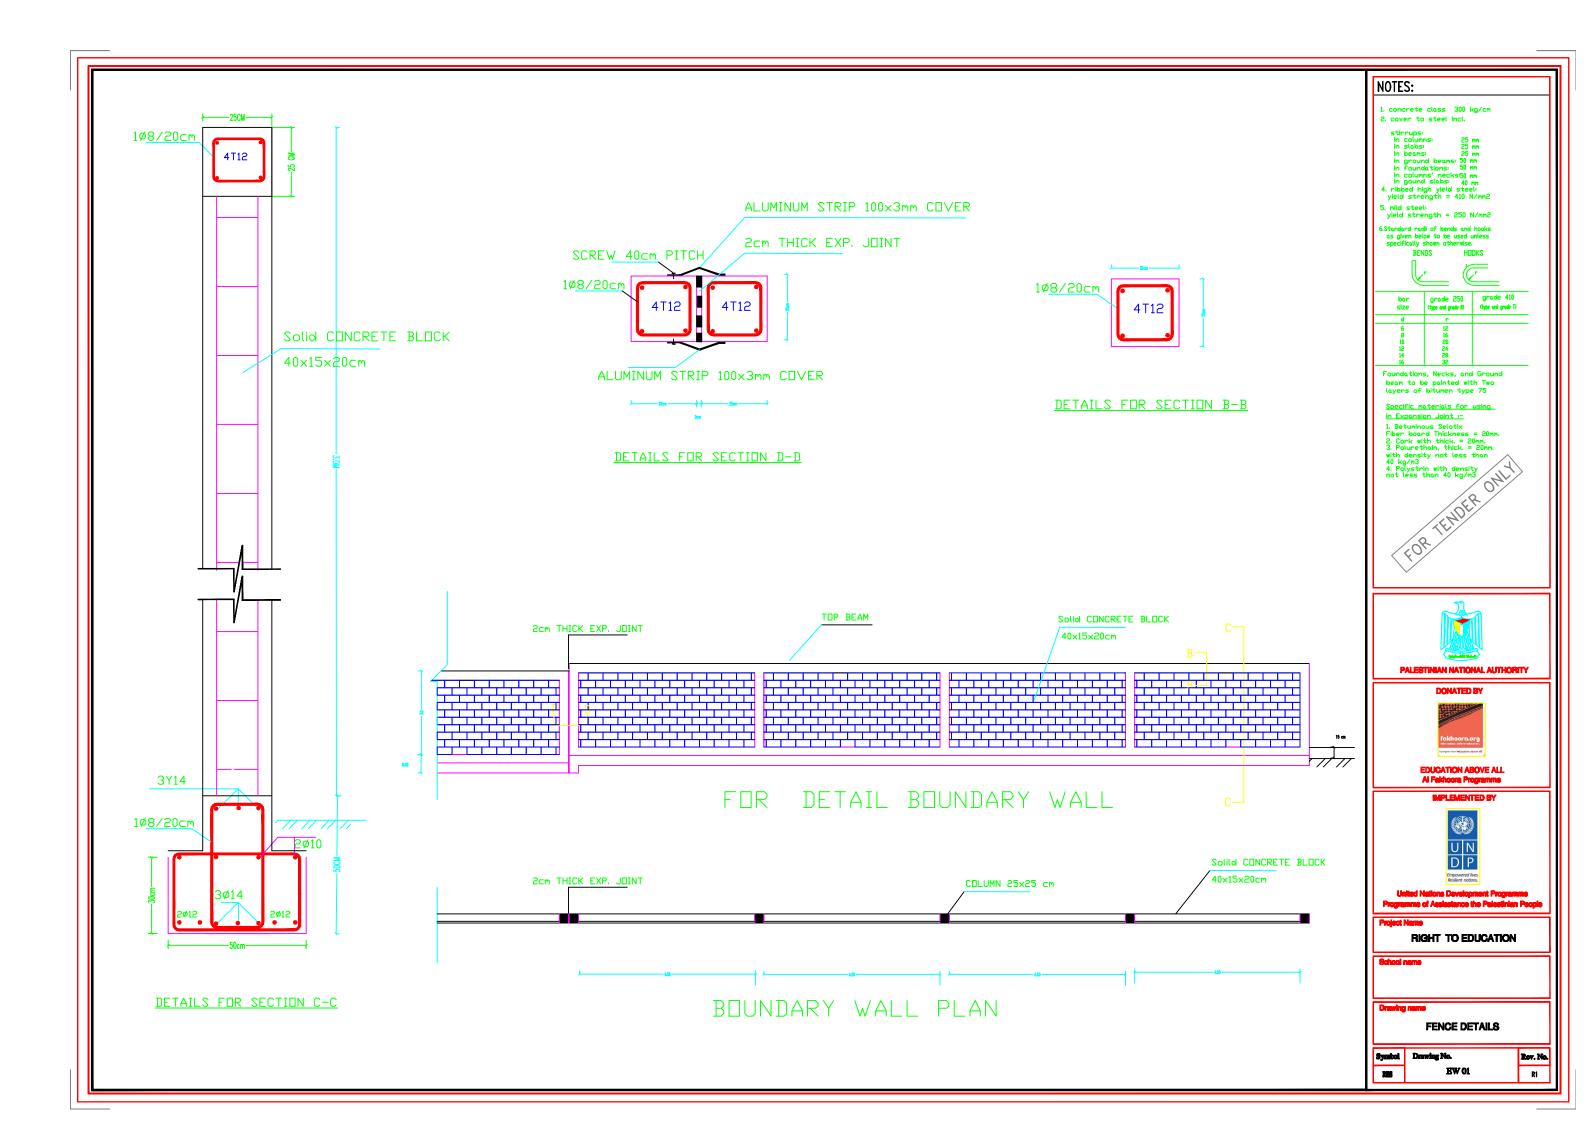



NOTES: STEEL REINFORCEMENT Steel type: deformed steel bars. Yield strength: fy = 4200 The Contractor has to submnit detailed CONCRETE COMPRESSIVE STRENGTH Shop Drawings of all works for approval For main building: Of the supervisor Engineer For other buildings: Foundation = 300 kg/cm2 Columns Ground beams
Slabs
Other items
CONCRETE COVERS
Foundation
Column Necks
Columns
Reams (Mesh) Ø8/15cm = 5 cm = 2.5 cm = 2.5 cm = 5.0 cm Top & side cover = 2.5 cm 10 OTHER NOTES — In main building, foundation & Col's are designed to carry three floors only - Minimum excavation depth is 1.5 m - Backfilling should be made by using Retaining Beam B250 selected soil on layers, max. 25cm thick each according to specification. 15cm Compacted Base Course Layer CONCRETE AROUND MANHOLE LAYING PATTERNS FOR BLOCKS 100cm Section In Aprons Interlock Concrete Blocks 8cm Sand Layer 3-5cm 40 cm KURKAR **EDUCATION ABOVE ALL Entrance Stair Cross Section** Compacted Soil (98%) 2ø10 Ø8/15cm in 1ø6@20cm 2ø10 RIGHT TO EDUCATION Retaining Beam B250 Section A - A Interlock Tiles Pavement for School Yard Aprone detail, handrall concrete wall stair case & Interlock details Section C-C Handrail Concrete Wall at Staircase Rov. No. EW 02


The Contractor has to submnit detailed Shop Drawings of all works for approval Of the supervisor Engineer




PLATFORM PLAN

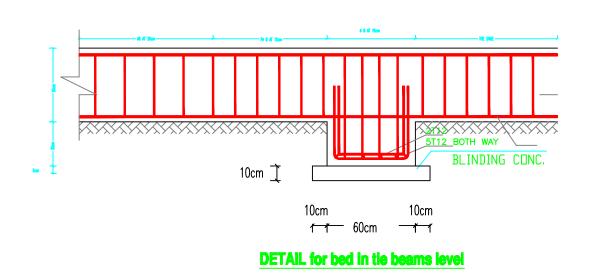

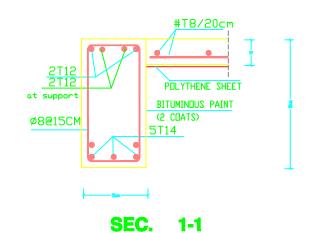

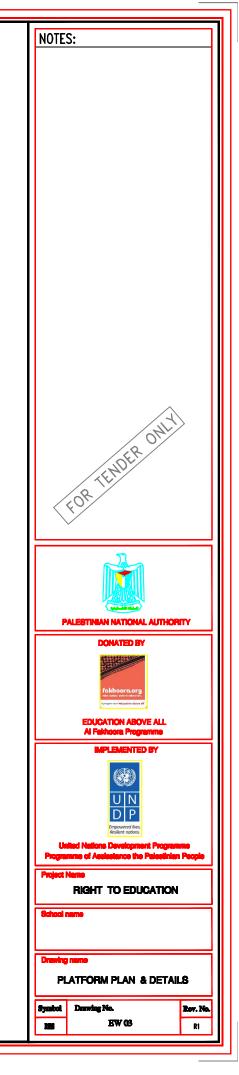



The Contractor has to submnit detailed Shop Drawings of all works for approval Of the supervisor Engineer

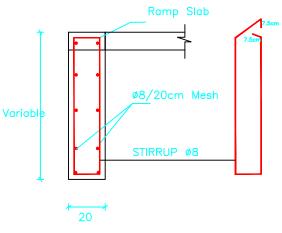

Section In Detail D

Detailes of Ramps Reinft. Concrete beams

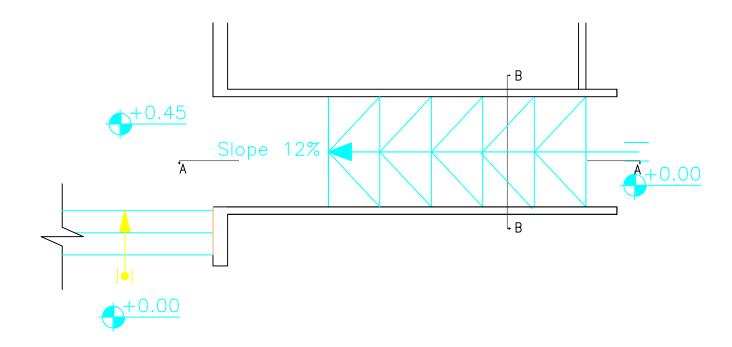

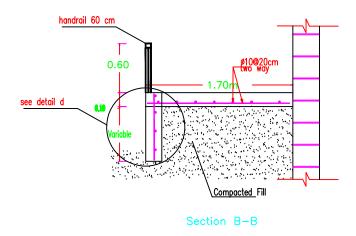

Section in Ramp


Dtail D + 0.45

Compacted Fill #10/20cm Mesh

1.50m 5.50

Section A-A


Ramp details

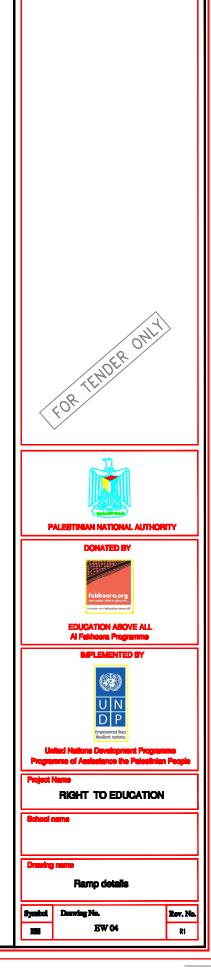



NOTES:

NOTES: ENTRANCE SCHOOL DOOR 3. catalis should be handed where necessary. 4. hinges where necessary 3 but hinges per door leaf. all hinges to be approved. 5. wooden framestreames abutting blookwork to be built in with mild steel cramps as per specification. 6. frames abutting concrete to be drilled, countersuals and fined with expansion bolts, 3 per jumb. 7. doorstops: projecting wall mounted typet0cm long, fixed 190cm above PFI. 8. Woodden doors white wood and 4-mm thick blowood. DOUPLE SHEET STEEL(2mm THIC.) CLOUMN(30X30) STEEL BAR(12x12)mm STEEL PLATE(50X50X5)mm NOTS FOR METAL DOORS -SAMPLES OF ALL PROFILES MUST BE APPROVED BY THE ENGINEER BEFORE STARTING THE WORK. E-THE PRICE INCLUDE: SUPPLYING ,ERECTING FOOTING(70x70x40) PAINTING AND SWITCH UNION KEY. STEEL GATE ELEVATION SCALE 1:50 DETAILS. THE ENGINEER APPROVAL OF THE SHOP MUST BE BEFOR STARTING WITH ANY W DETAIL(A) DETAIL(B) SECTION c-c SCALE 1 : 2 STE.PLATE(100x100x6)mm CORRUGATED GALV.STEEL SHEETS thick. 2.0mm. **EDUCATION ABOVE ALL** DETAIL(A) SCALE 1:10 G. Sheets Thick 2mm Profile 100x60x3mm Ø6/15 RIGHT TO EDUCATION 4ø12 5ø12 BOTH WAY Main Gate Details **DETAIL(B)** Rev. No. R1


General Drawings

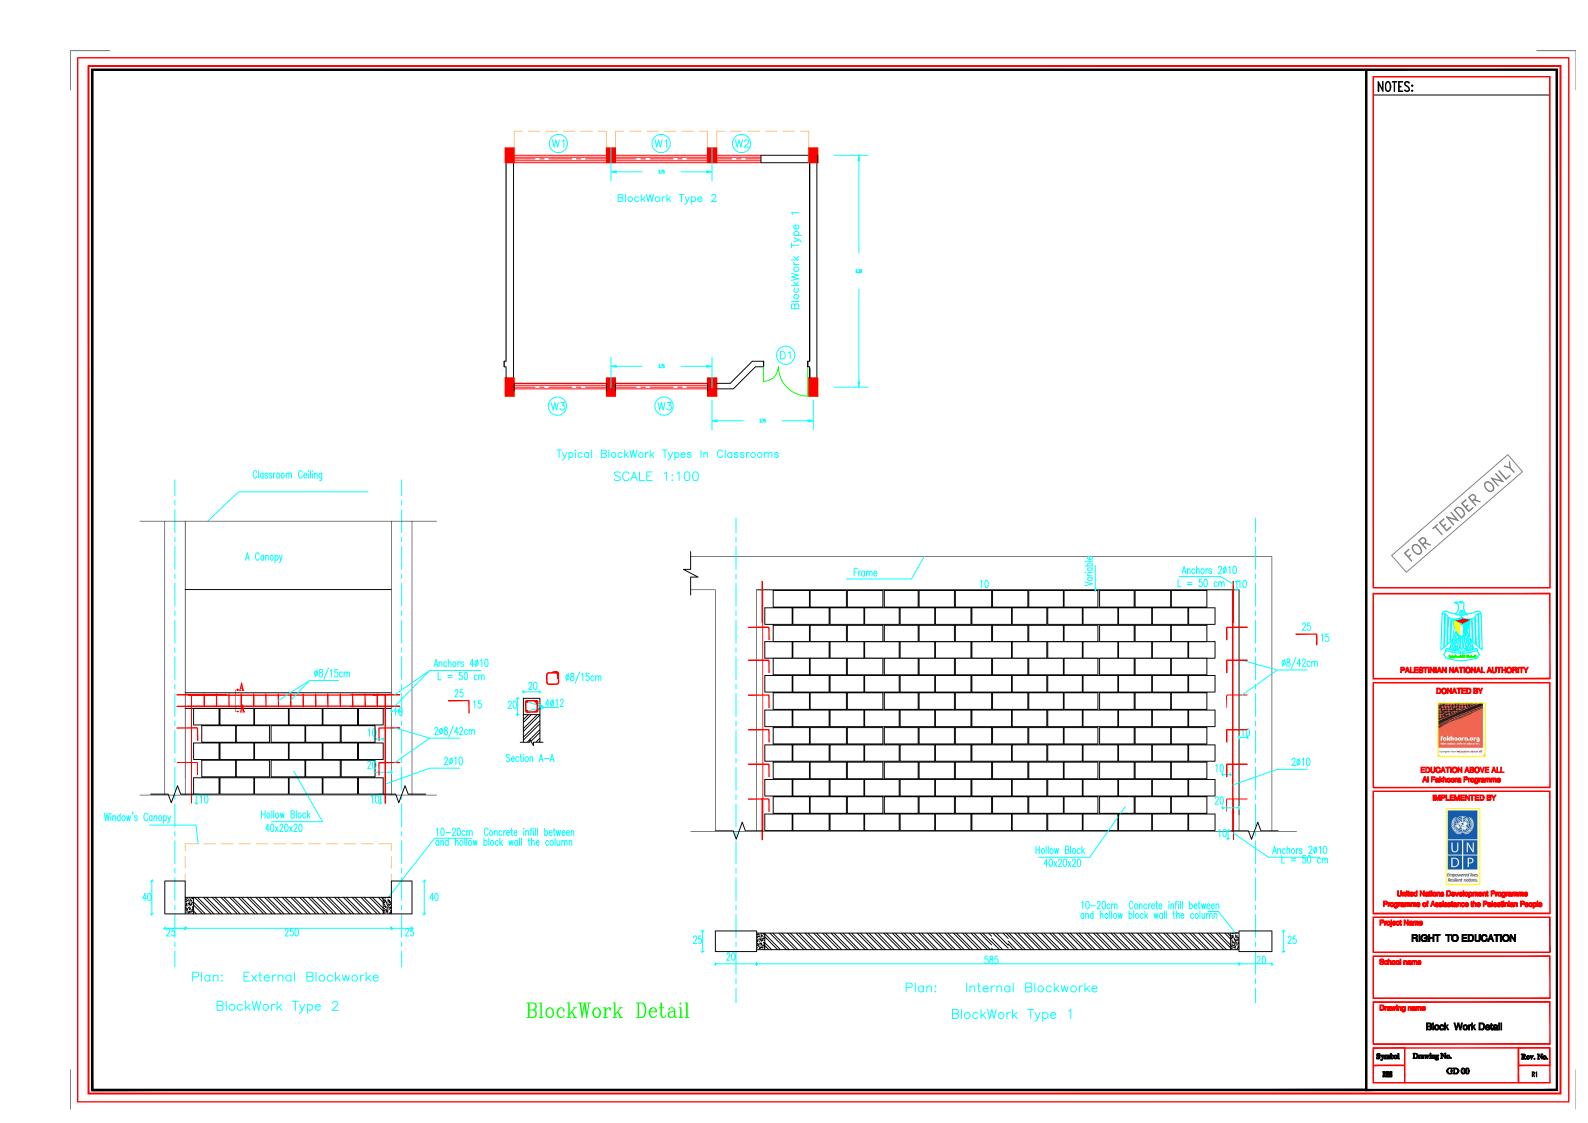


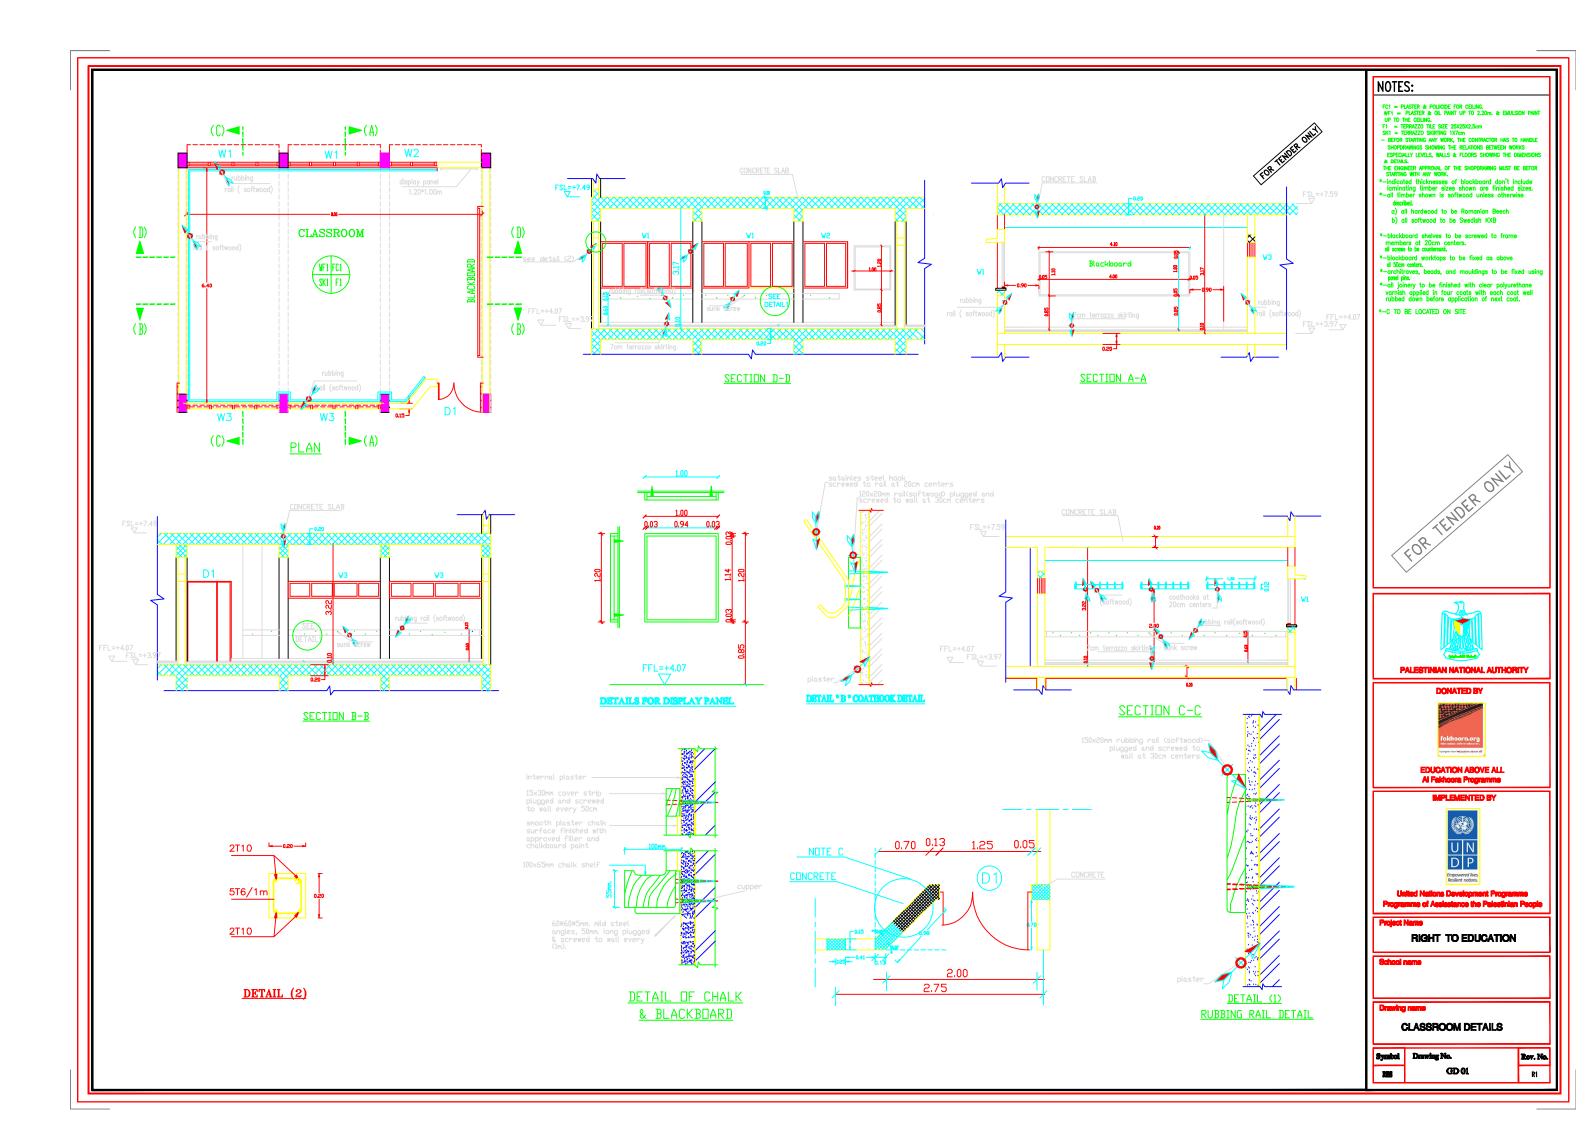


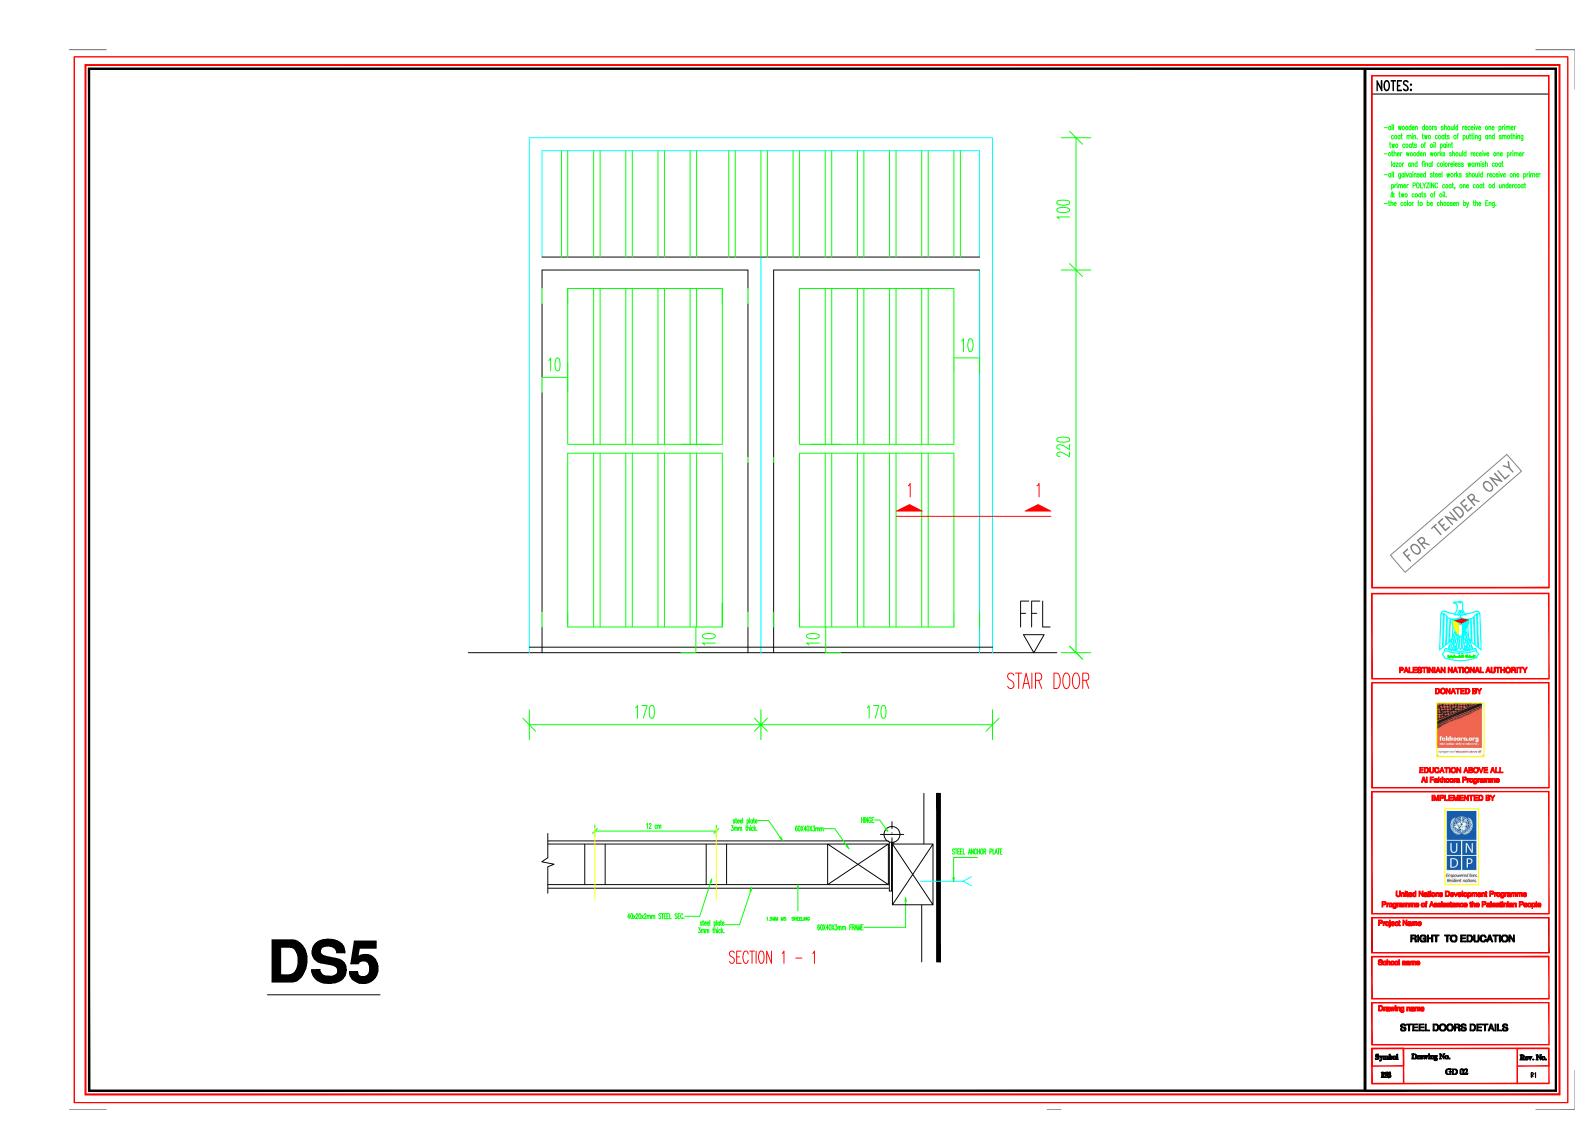


The Contractor has to submnit detailed
Shop Drawings of all works for approval
Of the supervisor Engineer

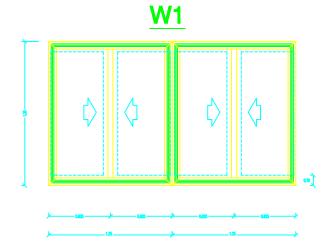


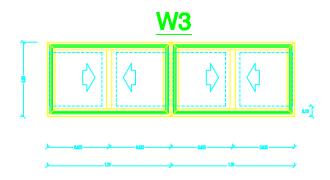

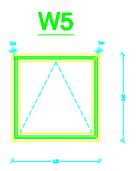

TOILET WINDOWS

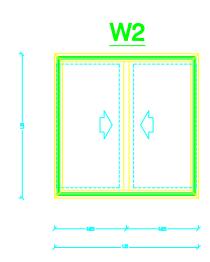

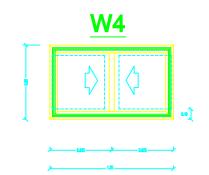

NOTES:

- Aluminum windows are white anodized aluminium with 4mm thick clear glass with color gray of crose section Section 7000 or 4500.
- All the accessories of windows are aluminium.
- 3-Marbel subframe 3cm thick must be provided at windows sills for all windows 27cm width.
- 4— Aluminium section shown are indicative only-contractor shall submit shopdrawing to director of work to be approved

-BEFORE STARTING ANY WORK, THE CONTRACTOR HAS TO HANDLE SHOPDRAWINGS SHOWING THE RELATIONS BETWEEN WORKS ESPECIALLY LEVELS, CROSSING, HALLS REQUIRED IN THE CIELLINGSS WALLS & FLOORS SHOWING THE DIMENSIONS & DETAILS.

MUST BE BEFORE STARTING WITH ANY WORK.





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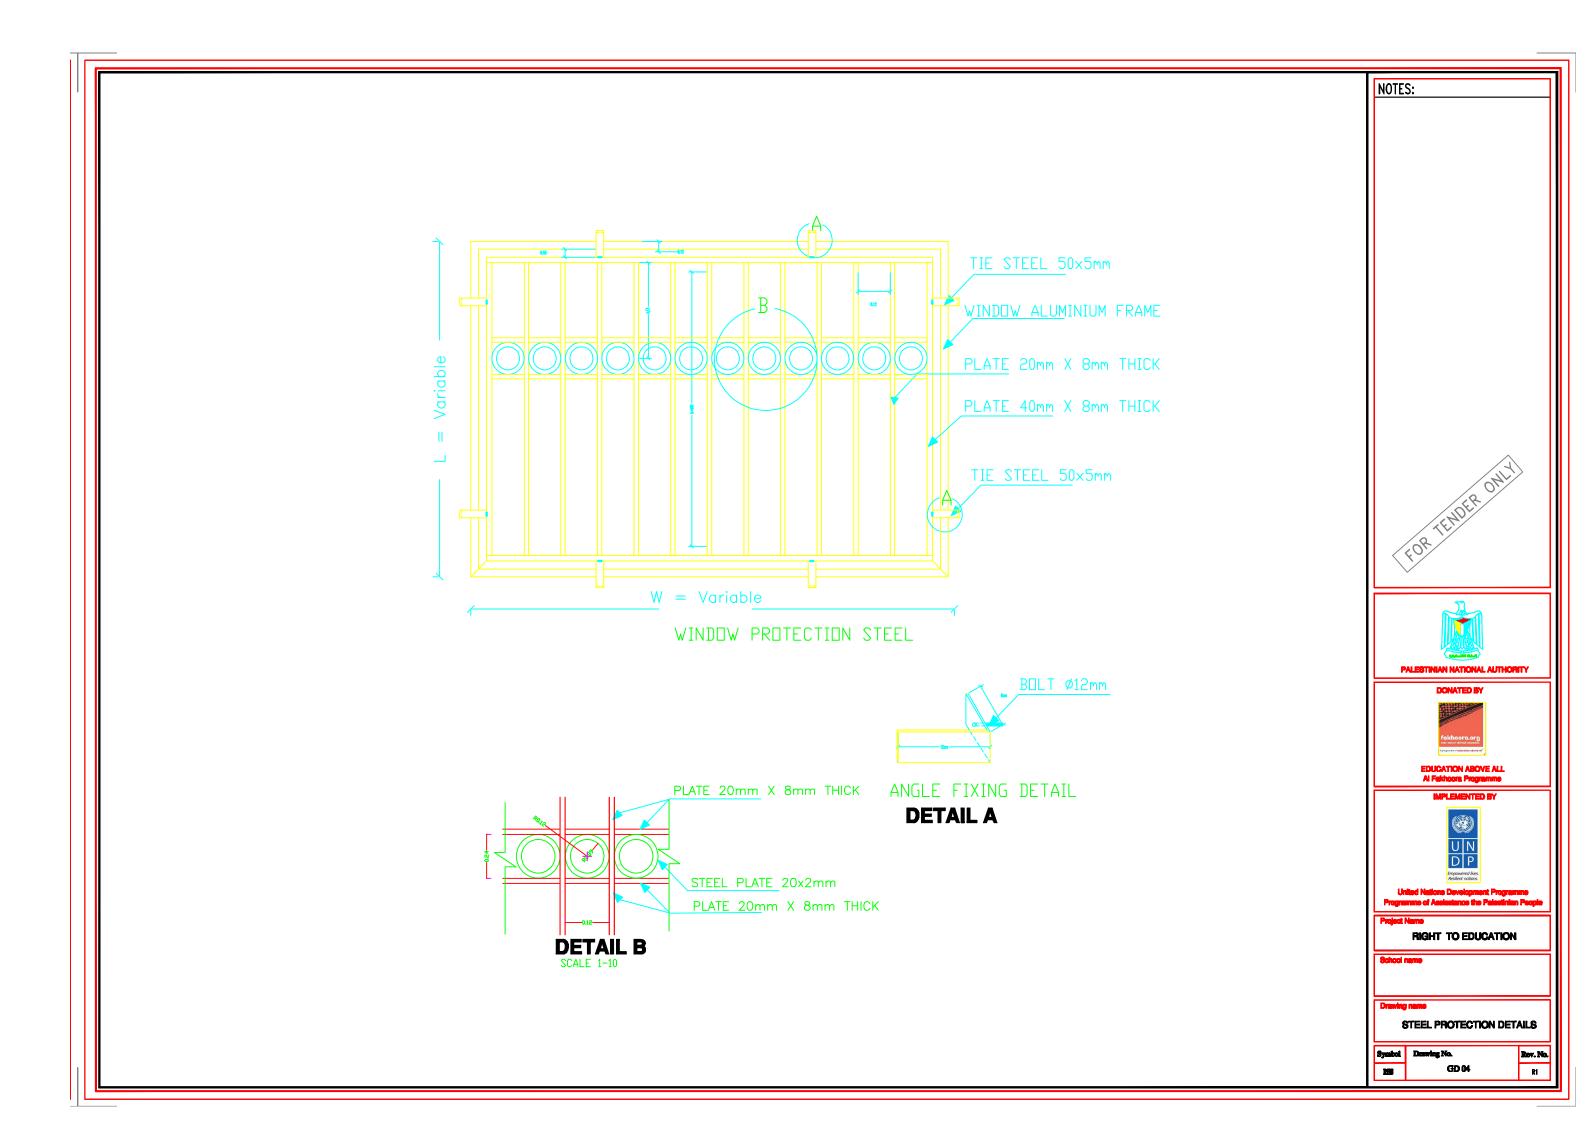
RIGHT TO EDUCATION


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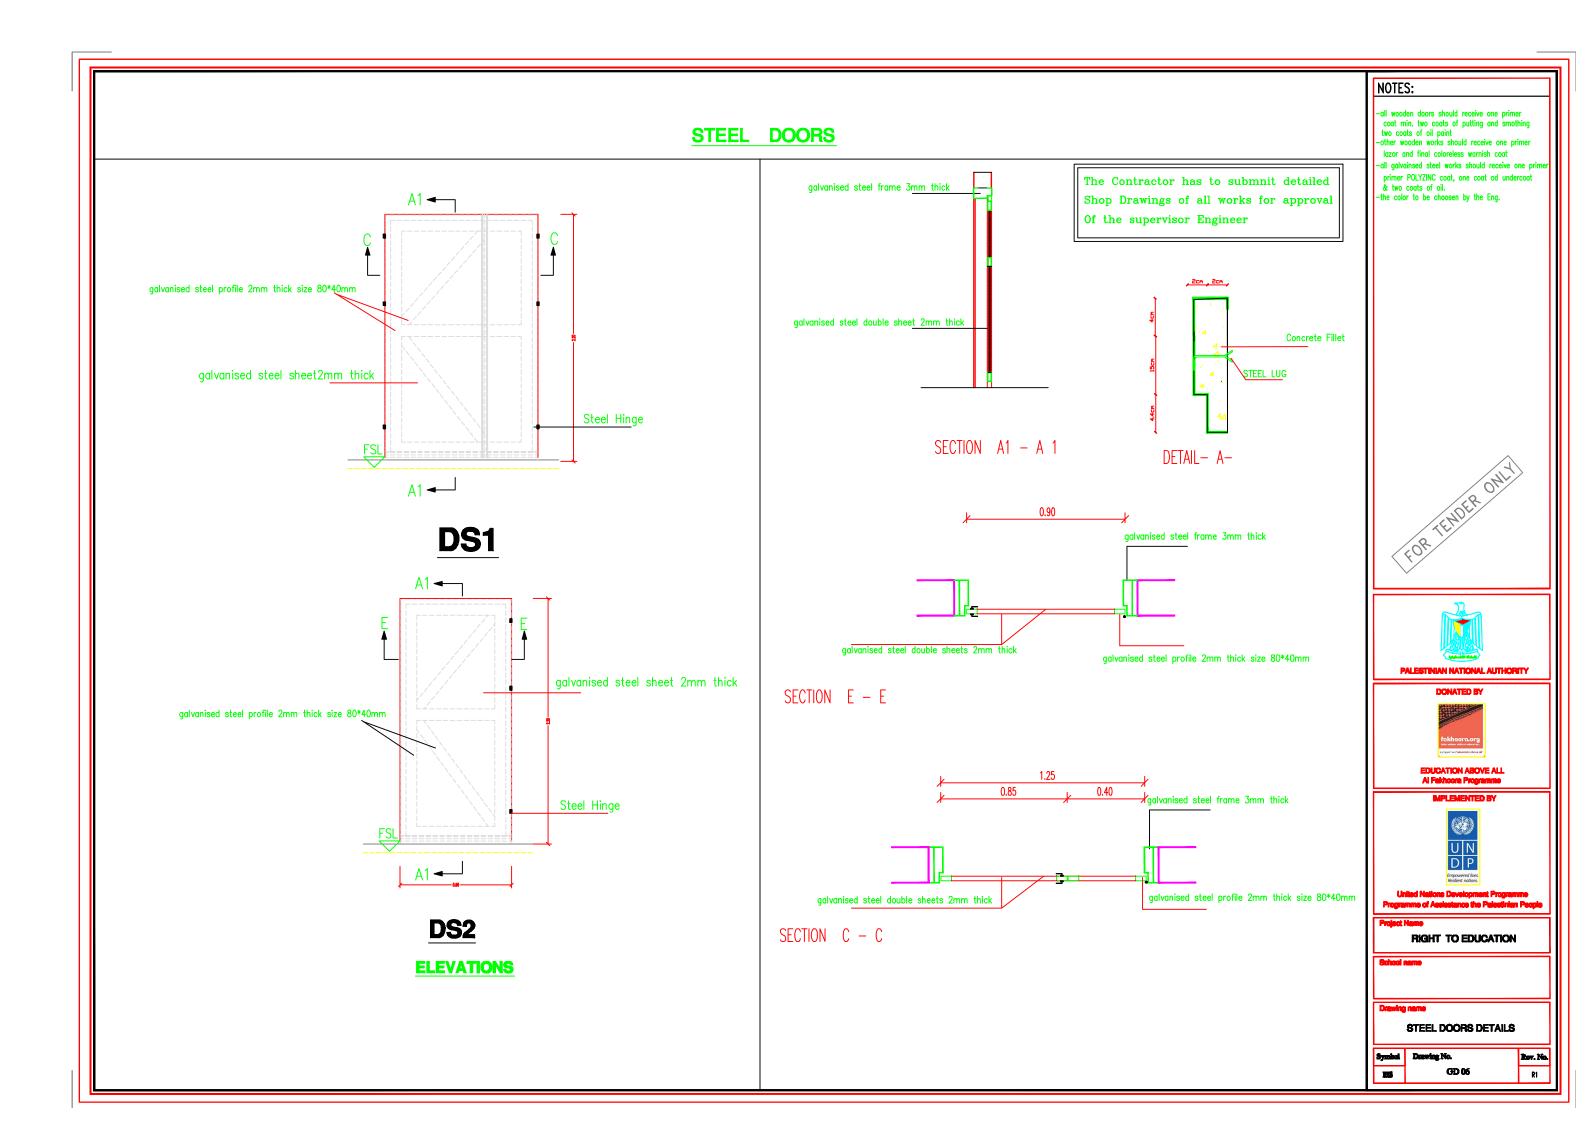
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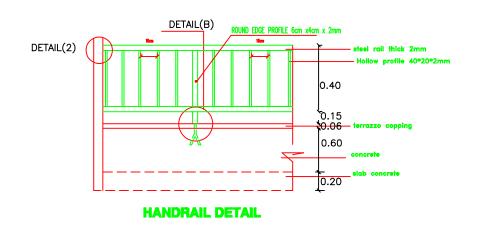
WINDOW DETAILS


Symbol	Drawing No.	Rov. No.
115	GD 03	R1










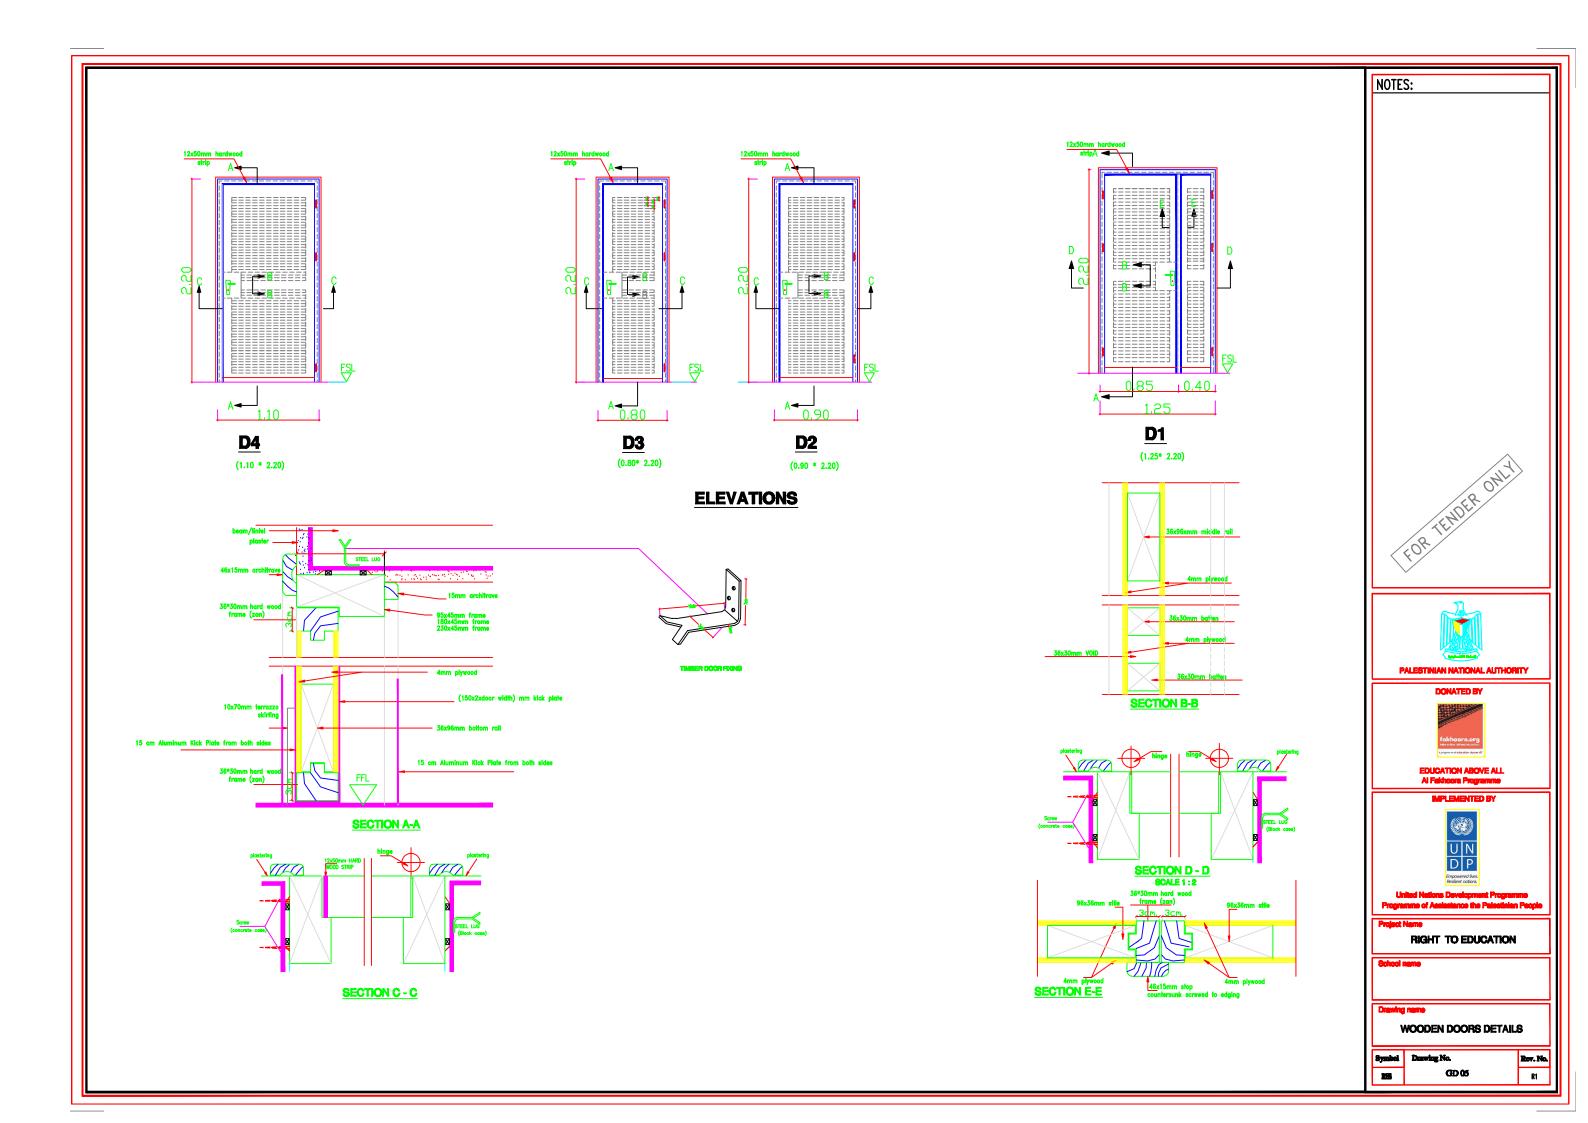

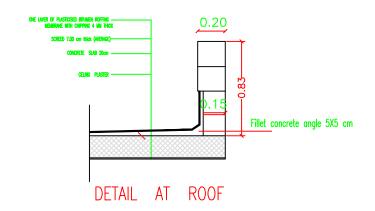


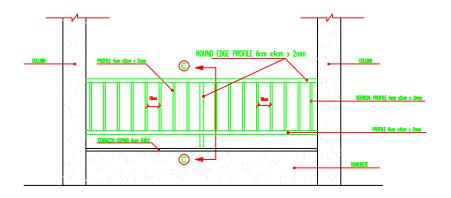


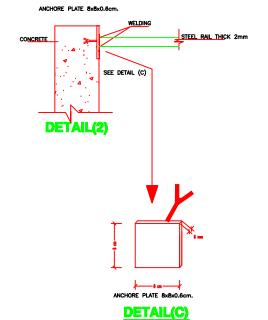

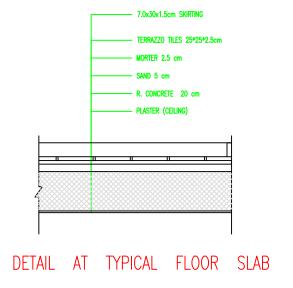



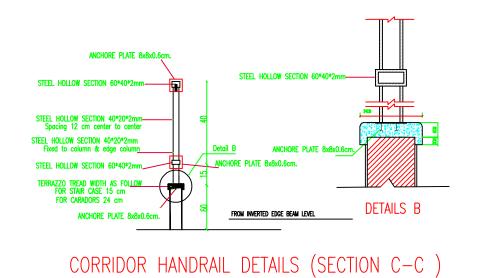


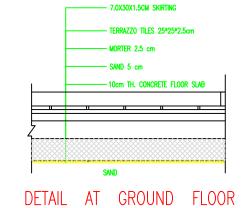



STAIR ROOFS DETAILS

RIGHT TO EDUCATION STAIR & CORRIDOR HANDRAIL DETAILS Rov. No. GD 07 R1

NOTES:

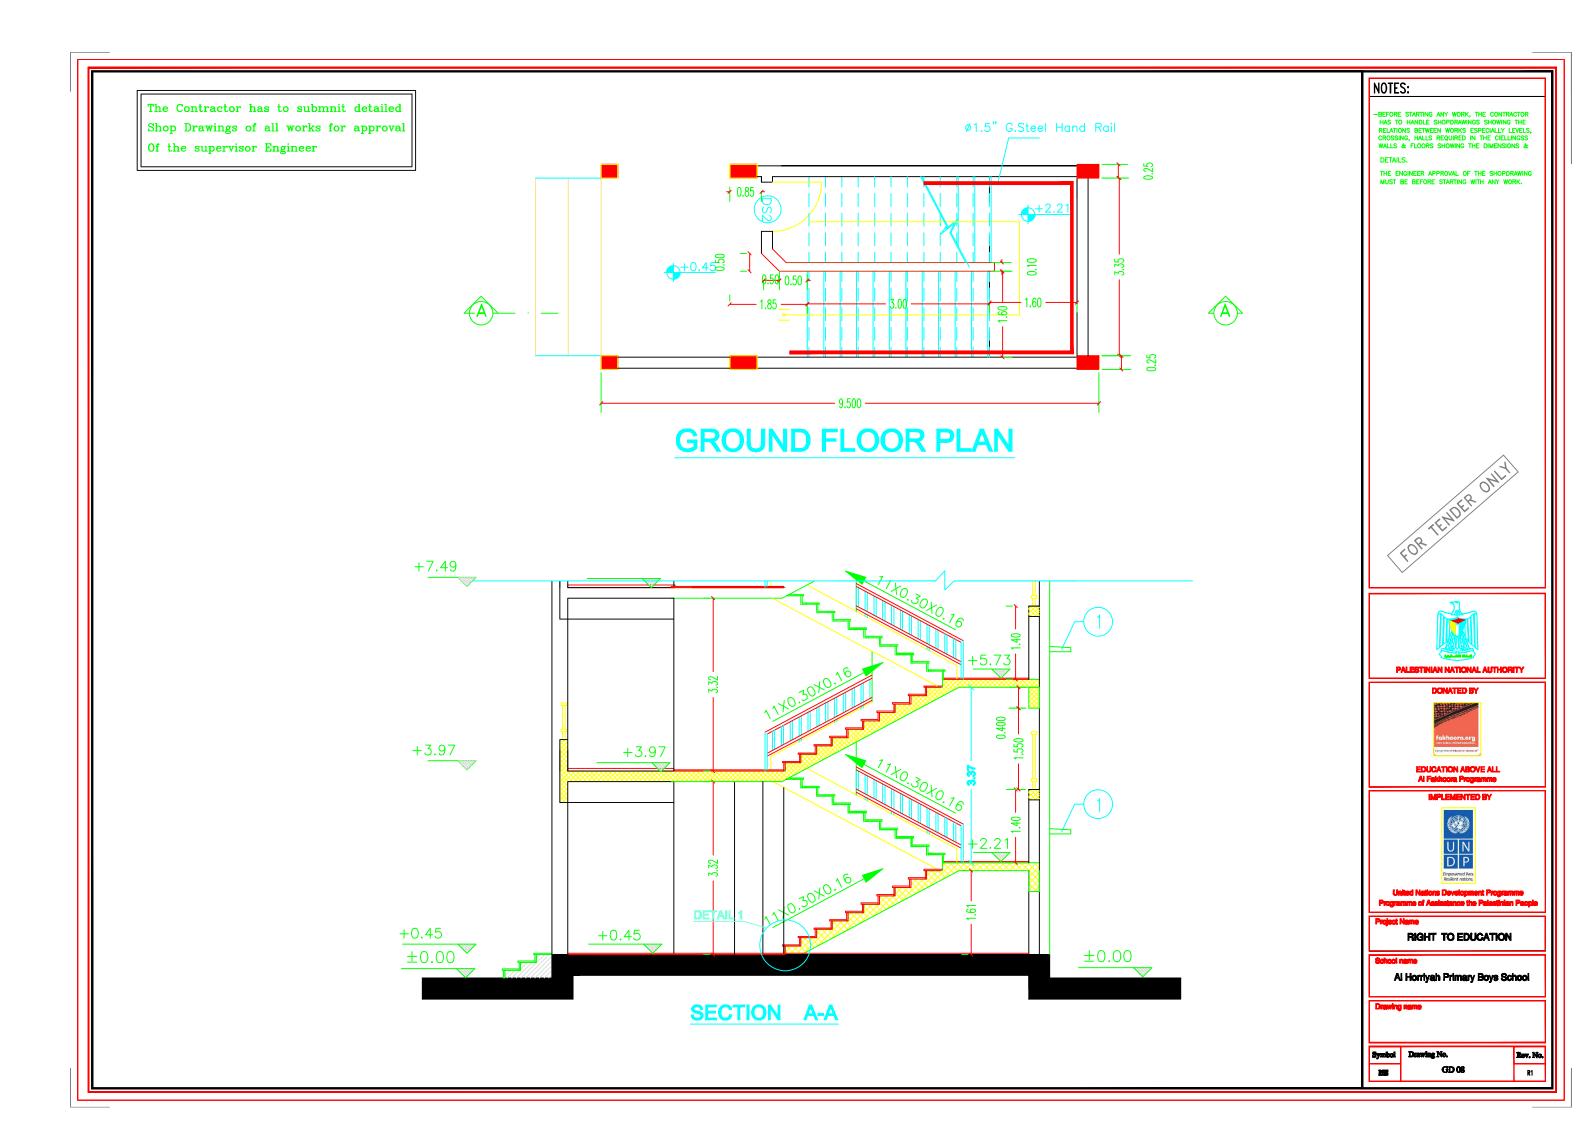

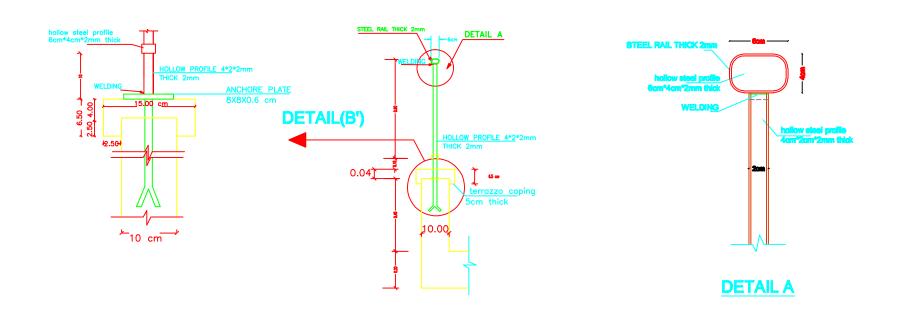

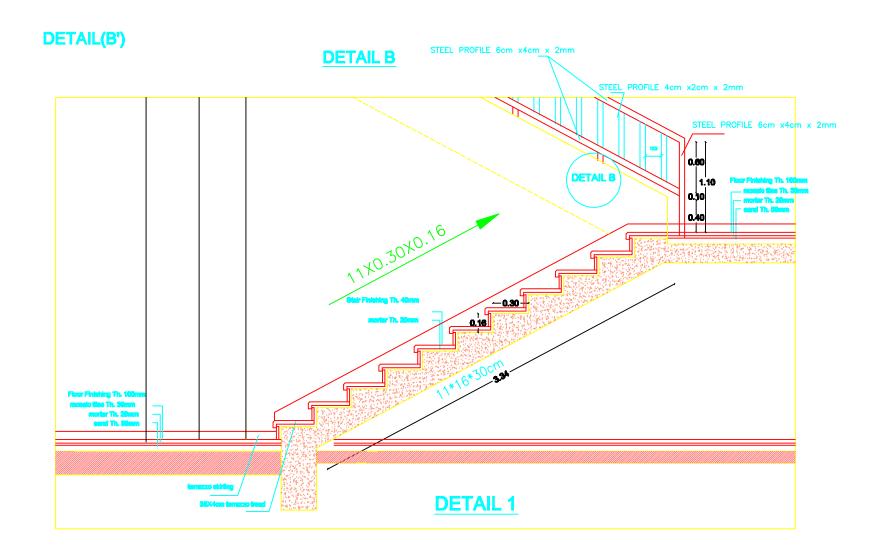

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BEFORE STARTING ANY WORK, THE CONTRACTOR HAS TO HANDLE SHOPDRAWINGS SHOWING THE RELATIONS BETWEEN WORKS ESPECIALLY LEVELS, CROSSING, HALLS REQUIRED IN THE CIELLINGS WALLS & FLOORS SHOWING THE DIMENSIONS & THE ENGINEER APPROVAL OF THE SHOPDRAWING MUST BE BEFORE STARTING WITH ANY WORK. DETAILS.





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Programme of Assissance the Palestinian People

Project Name

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School no

Drawing no

STAIR DETAILS

Symbol Dowing No.

EM GD 09

Rov. No.

The Contractor has to submnit detailed Shop Drawings of all works for approval Of the supervisor Engineer



