



# STEEL DOOR

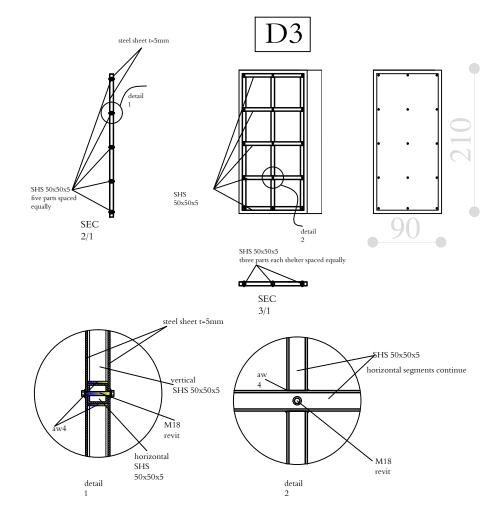

# STEEL DOOR

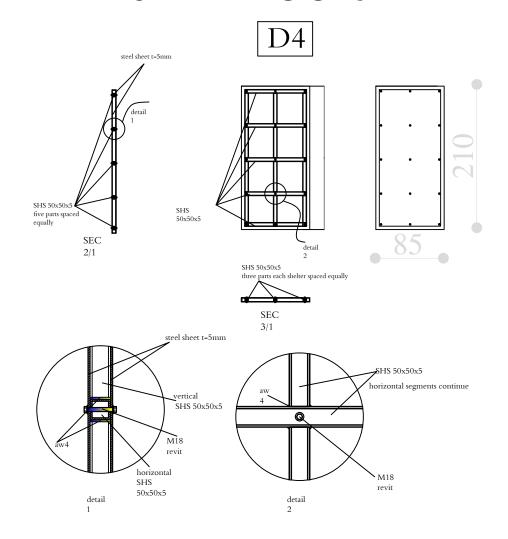

GENERAL NOTES:

1. ALL DIMENSIONS ARE IN CM.
2. DO NOT SCALE THE DWG. REFER TO THE DIMENSIONS MARKED IN THE DWG ONLY
3. ALL MATERIAL SAMPLES TO BE APPROVED BY ARCHITECT BEFORE USE.
4. COLUMNS DIMENSION ARE APPROXIMATE AND BE TOKEN AS THEY SEEN WITH NAKED EYES WITH NO STRUCTURAL TESTS.

NEGLECTED AREA REINFORCEMENT SEC **PAVMENT** SECTION 1,2



OFFICE FOR THE COORDINATION OF HUMANITARIAN AFFAIRS

## PROJECT NAME:

REHABILITATION OF OCHA BUILDING IN AL MAZEH


### DRAWING TITLE:

STEEL DOORS DETAILS

DESIGNED BY:		DRAWING NO. : A-03	
APPROVED BY:		SCALE :	NTS
DATE:	03/12/2016	REV NO.:	

# STEEL MAIN DOOR D7 50x50x5

# STEEL DOOR

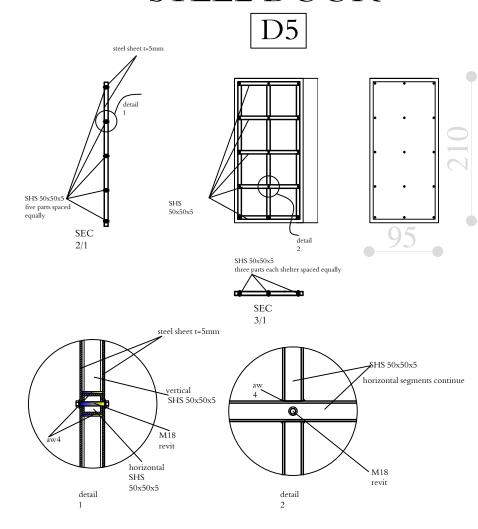

GENERAL NOTES:

1. ALL DIMENSIONS ARE IN CM.
2. DO NOT SCALE THE DWG. REFER TO THE DIMENSIONS MARKED IN THE DWG ONLY
3. ALL MATERIAL SAMPLES TO BE APPROVED BY ARCHITECT BEFORE USE.
4. COLUMNS DIMENSION ARE APPROXIMATE AND BE TOKEN AS THEY SEEN WITH NAKED EYES WITH NO STRUCTURAL TESTS.

NEGLECTED AREA REINFORCEMENT SEC **PAVMENT** SECTION 1,2



OFFICE FOR THE COORDINATION OF HUMANITARIAN AFFAIRS


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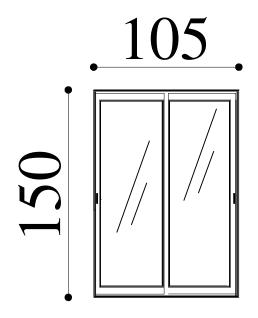
REHABILITATION OF OCHA BUILDING IN AL MAZEH

### DRAWING TITLE:

STEEL DOORS DETAILS


ESIGNED BY:		DRAWING NO. : A-04	
PPROVED BY:		SCALE: NTS	
ATE:	03/12/2016	REV NO.:	



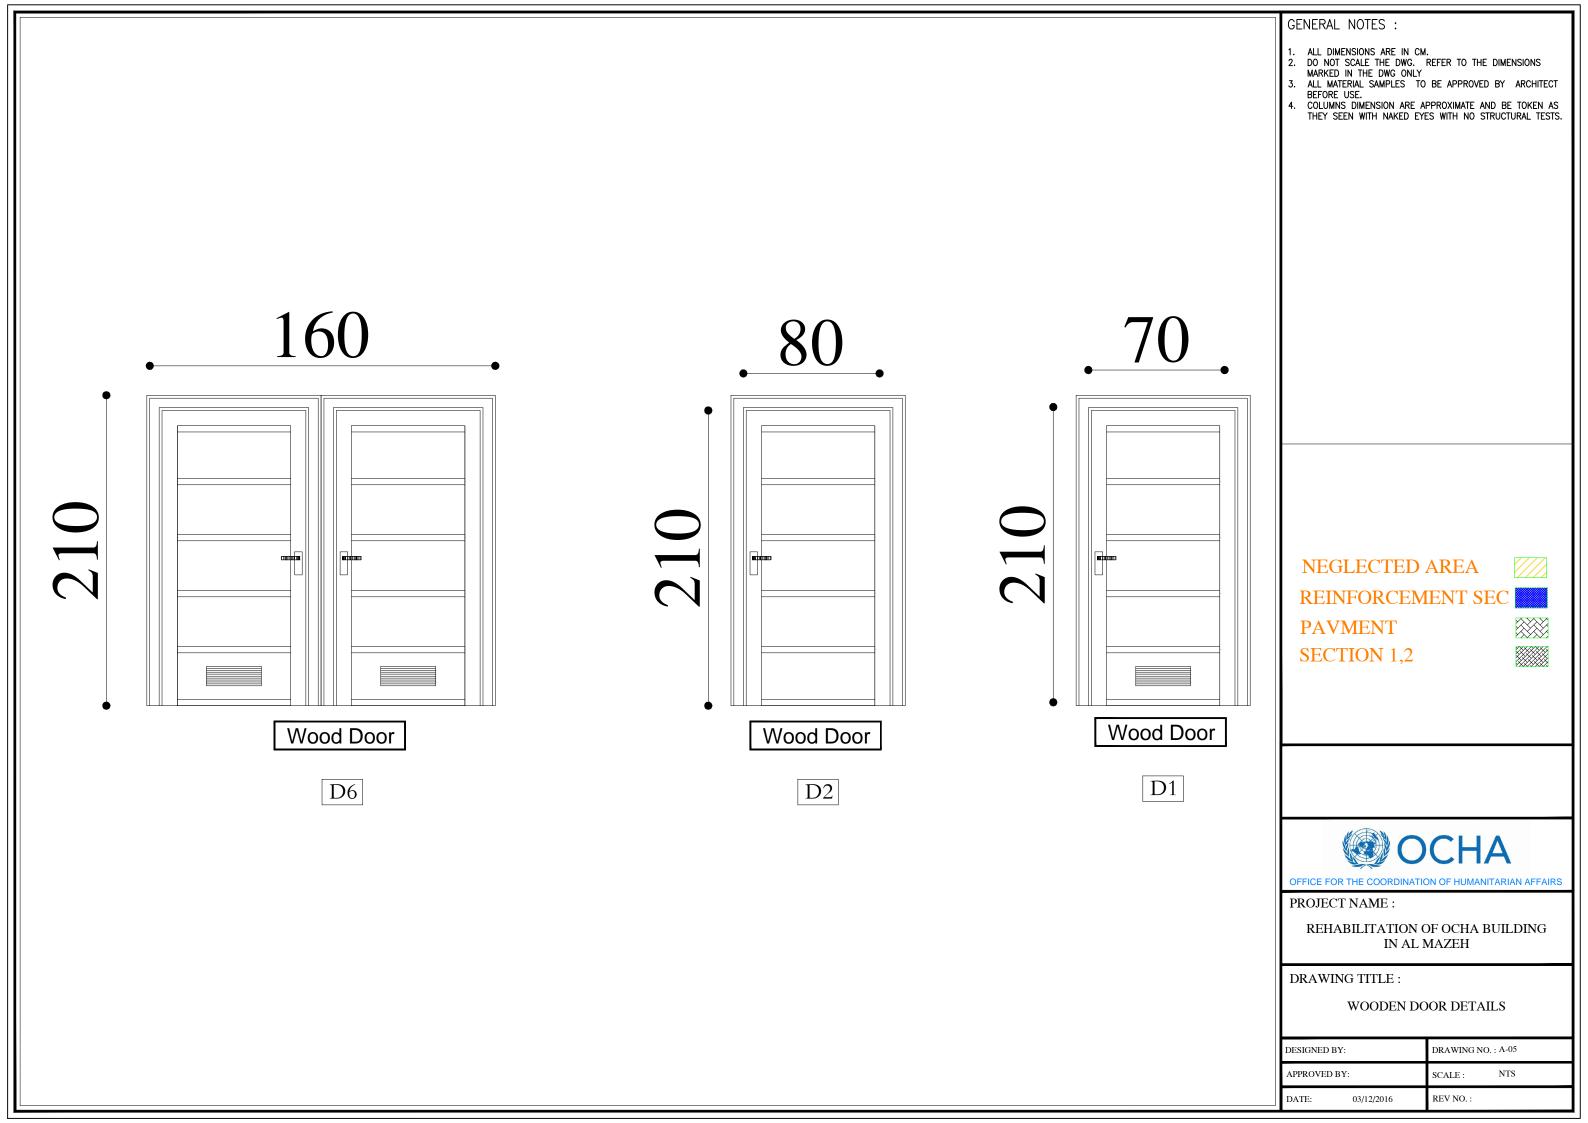


Aluminum Window with glass

Windows	The Type	Dimensional	The total number
W 1	sliding double glazed window	105*150	1
W 2	sliding double glazed window	145*150	1
W 3	sliding double glazed window	190*150	1
W 4	sliding double glazed window	170*160	1
W 5	sliding double glazed window	195*145	1
W 6	sliding double glazed window	200*210	2

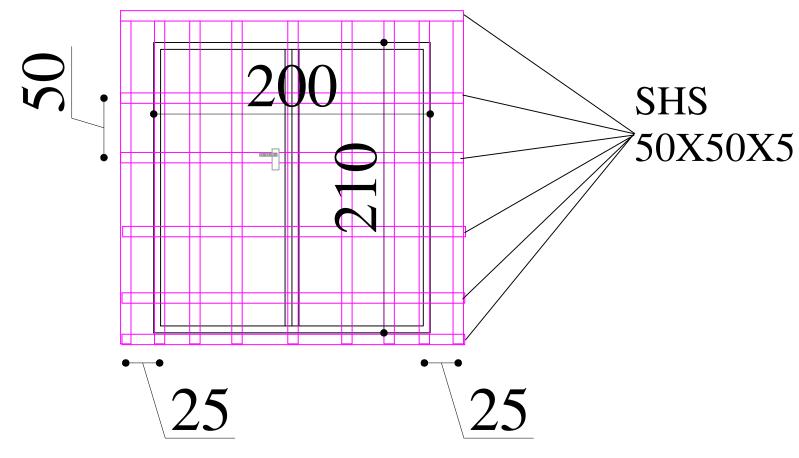


# STEEL FRAME PROTECTION

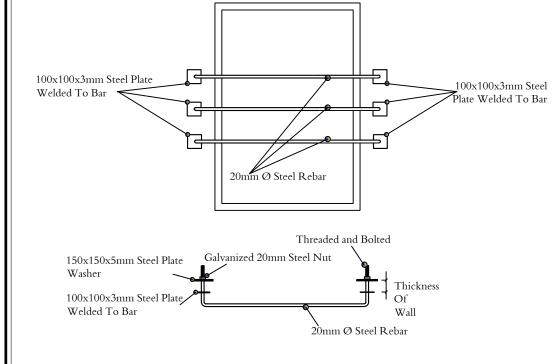

Window Frame Capture

Scale : 1/20

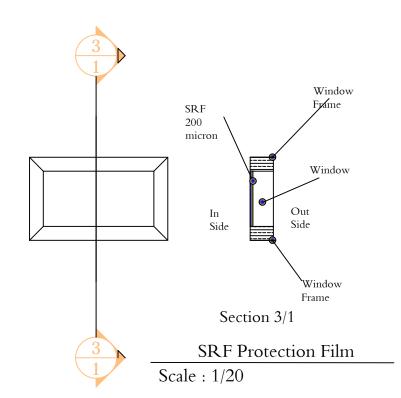

## GENERAL NOTES:

- 1. ALL DIMENSIONS ARE IN CM.
  2. DO NOT SCALE THE DWG. REFER TO THE DIMENSIONS MARKED IN THE DWG ONLY
  3. ALL MATERIAL SAMPLES TO BE APPROVED BY ARCHITECT BEFORE USE.
  4. COLUMNS DIMENSION ARE APPROXIMATE AND BE TOKEN AS THEY SEEN WITH NAKED EYES WITH NO STRUCTURAL TESTS.

NEGLECTED AREA

REINFORCEMENT SEC

**PAVMENT** 

SECTION 1,2



OFFICE FOR THE COORDINATION OF HUMANITARIAN AFFAIRS


### PROJECT NAME:

REHABILITATION OF OCHA BUILDING IN AL MAZEH

### DRAWING TITLE:

WINDOWS DETAILS

DESIGNED BY:		DRAWING NO. : A-06	
APPROVED BY:		SCALE: NTS	
DATE:	03/12/2016	REV NO.:	

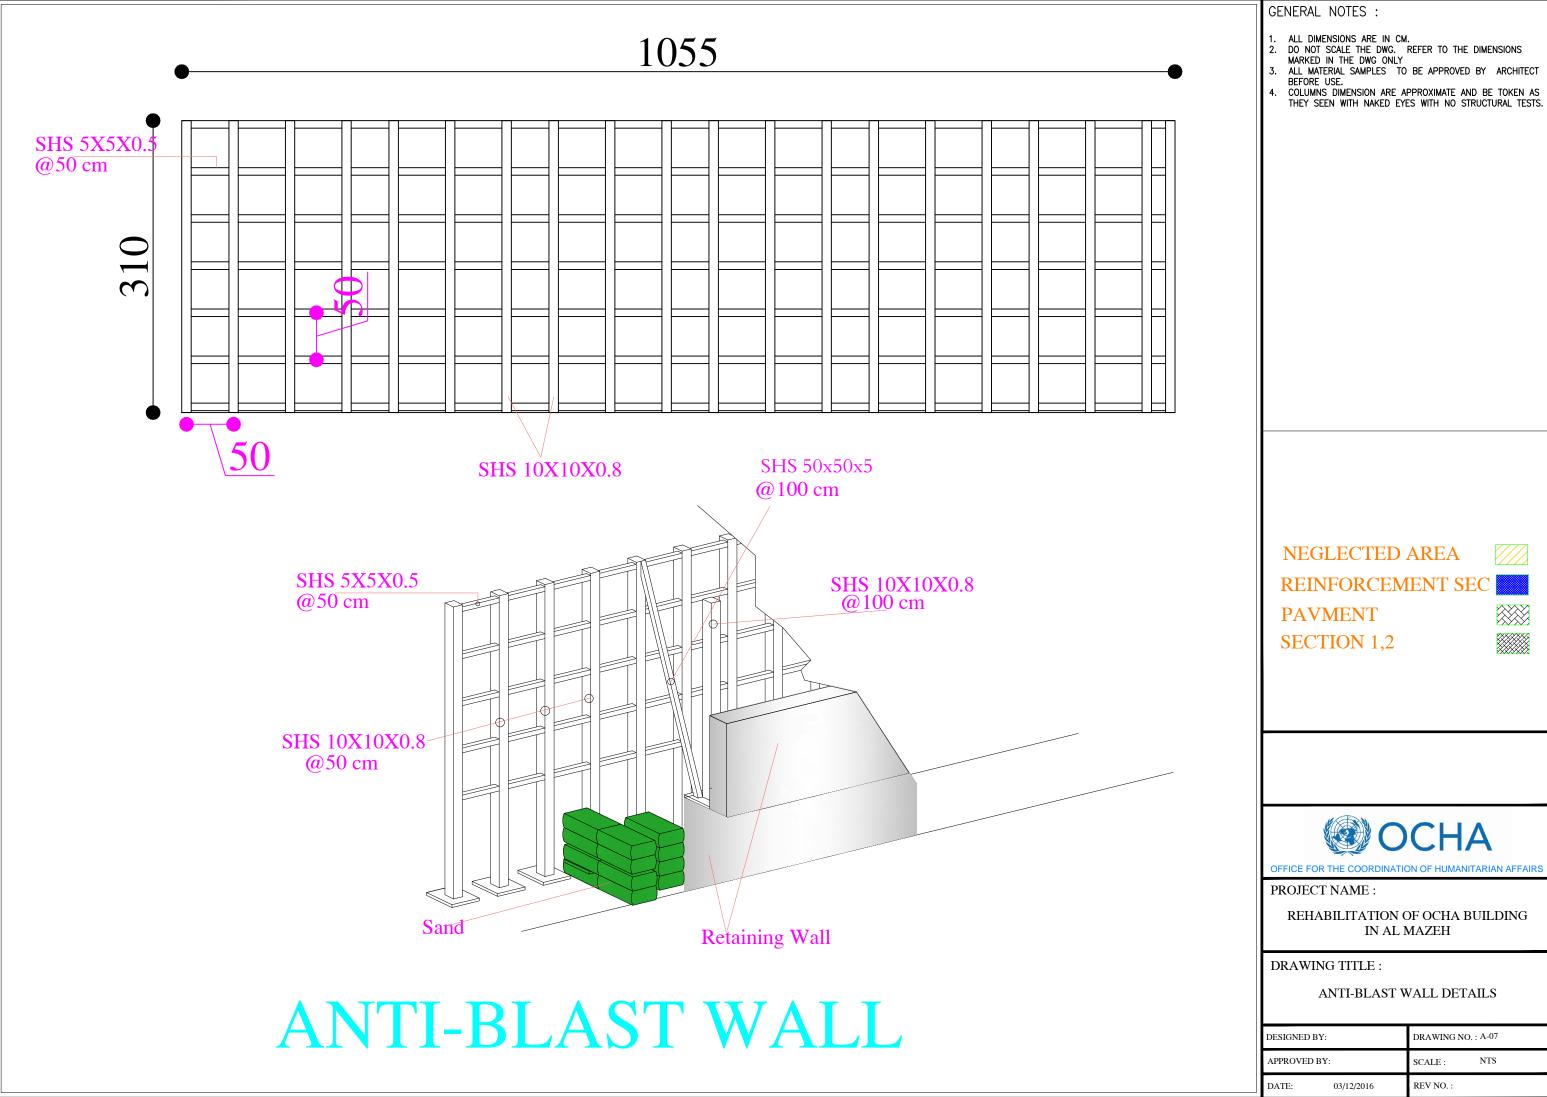

NEGLECTED AREA REINFORCEMENT SEC






REHABILITATION OF OCHA BUILDING IN AL MAZEH

ANTI-BLAST WALL DETAILS

DESIGNED BY:		DRAWING NO. : A-07		
APPROVED BY:		SCALE :	NTS	
DATE:	03/12/2016	REV NO.:		

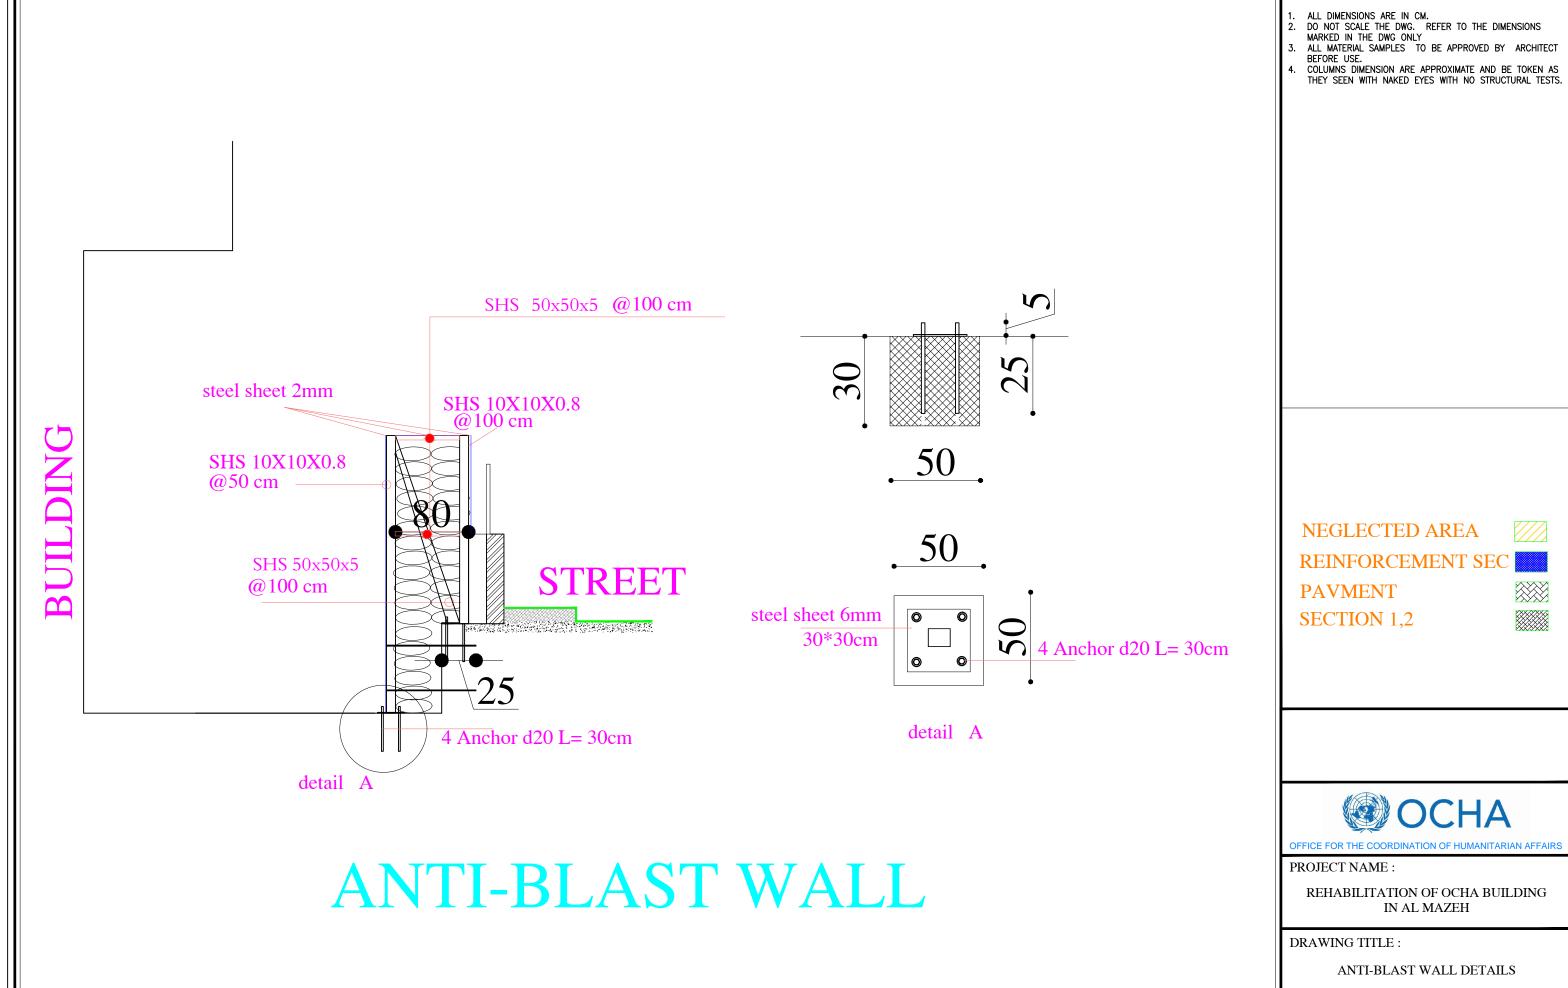


GENERAL NOTES:


REINFORCEMENT SEC



REHABILITATION OF OCHA BUILDING

DESIGNED BY:		DRAWING NO. : A-07	
APPROVED BY:		SCALE :	NTS
DATE: 03/12/2016		REV NO.:	

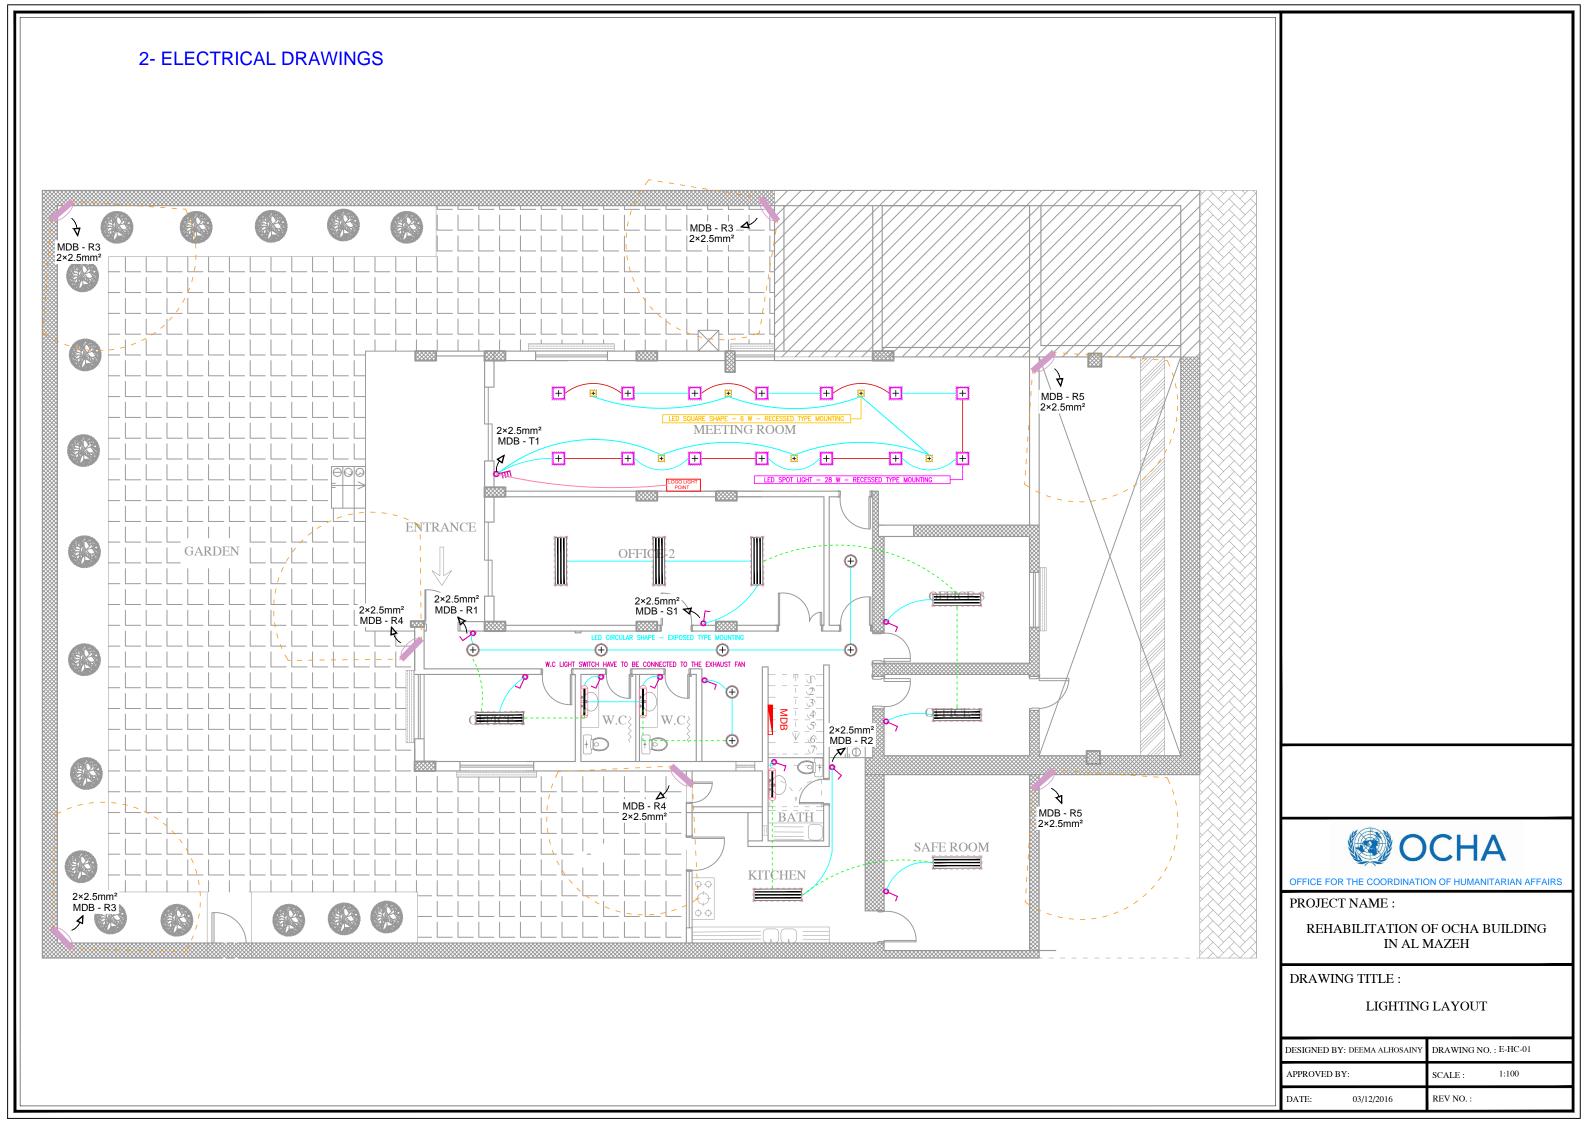

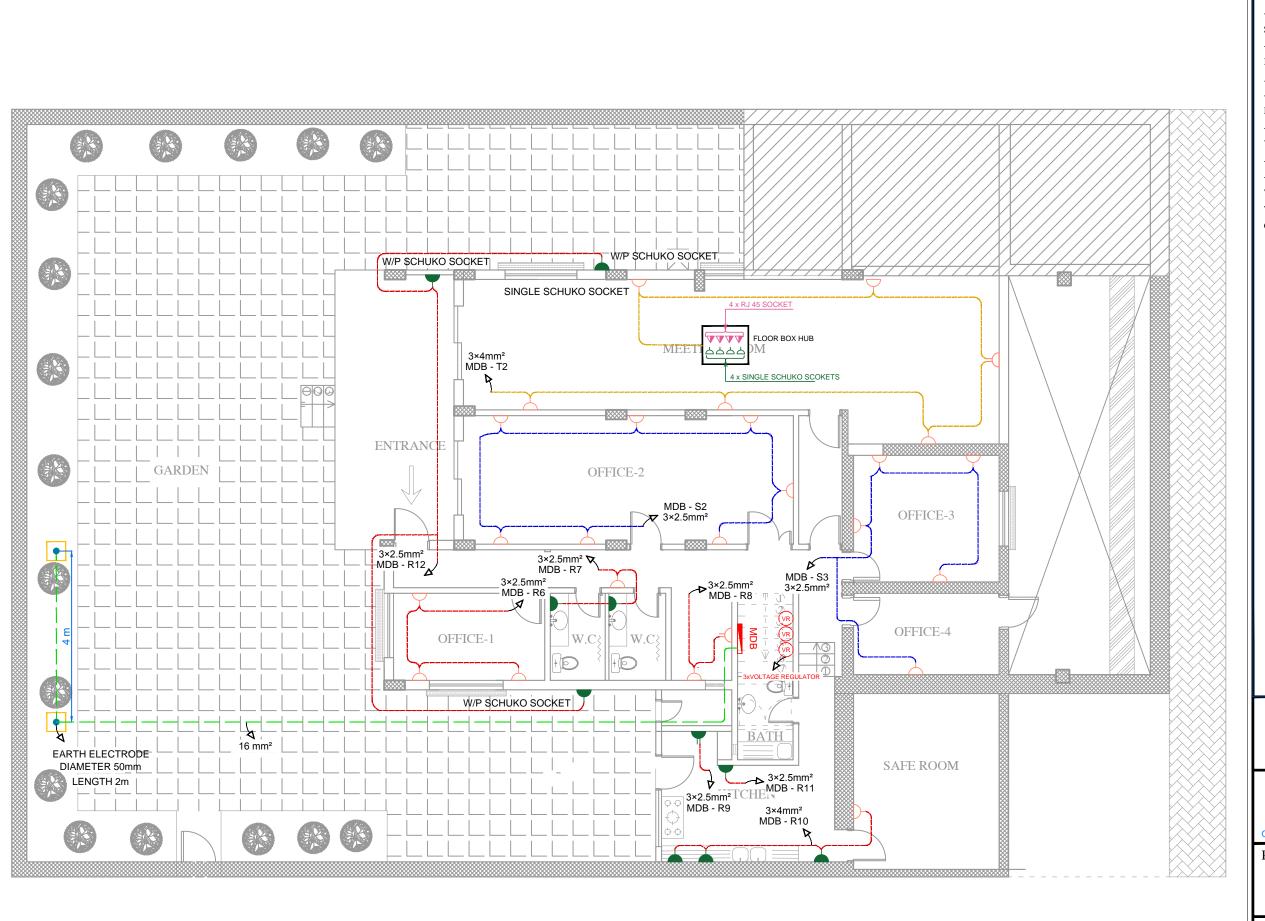

NOTES:

- FLOOR BOX HAS 4 DATA SOCKETS AND 4 SCHUKO SOCKETS.
- ALL CABLES ARE WIRED IN TRUNKING, EXCEPT IN THE MEETING ROOM,ALL CABLES ARE HIDDEN IN THE WALLS AND FALSE CEILING.
- ALL SOCKETS ARE EXPOSED, EXCEPT IN THE MEETING ROOM,ALL CABLES ARE HIDDEN IN THE WALLS.
- DISTANCE BETWEEN ANY SOCKET OFF THE DOORS AND WALLS MUST BE 50 Cm.
- ALL POWER SOCKETS ARE SCHUKO TYPE .
- WHEN WIRING SOCKETS ON TWO SIDES OF ONE WALL, THERE MUST BE A HORIZONTAL DISTANCE BETWEEN THE SOCKETS BETWEEN TWO SIDES MINIMUM ABOUT 15 Cm.



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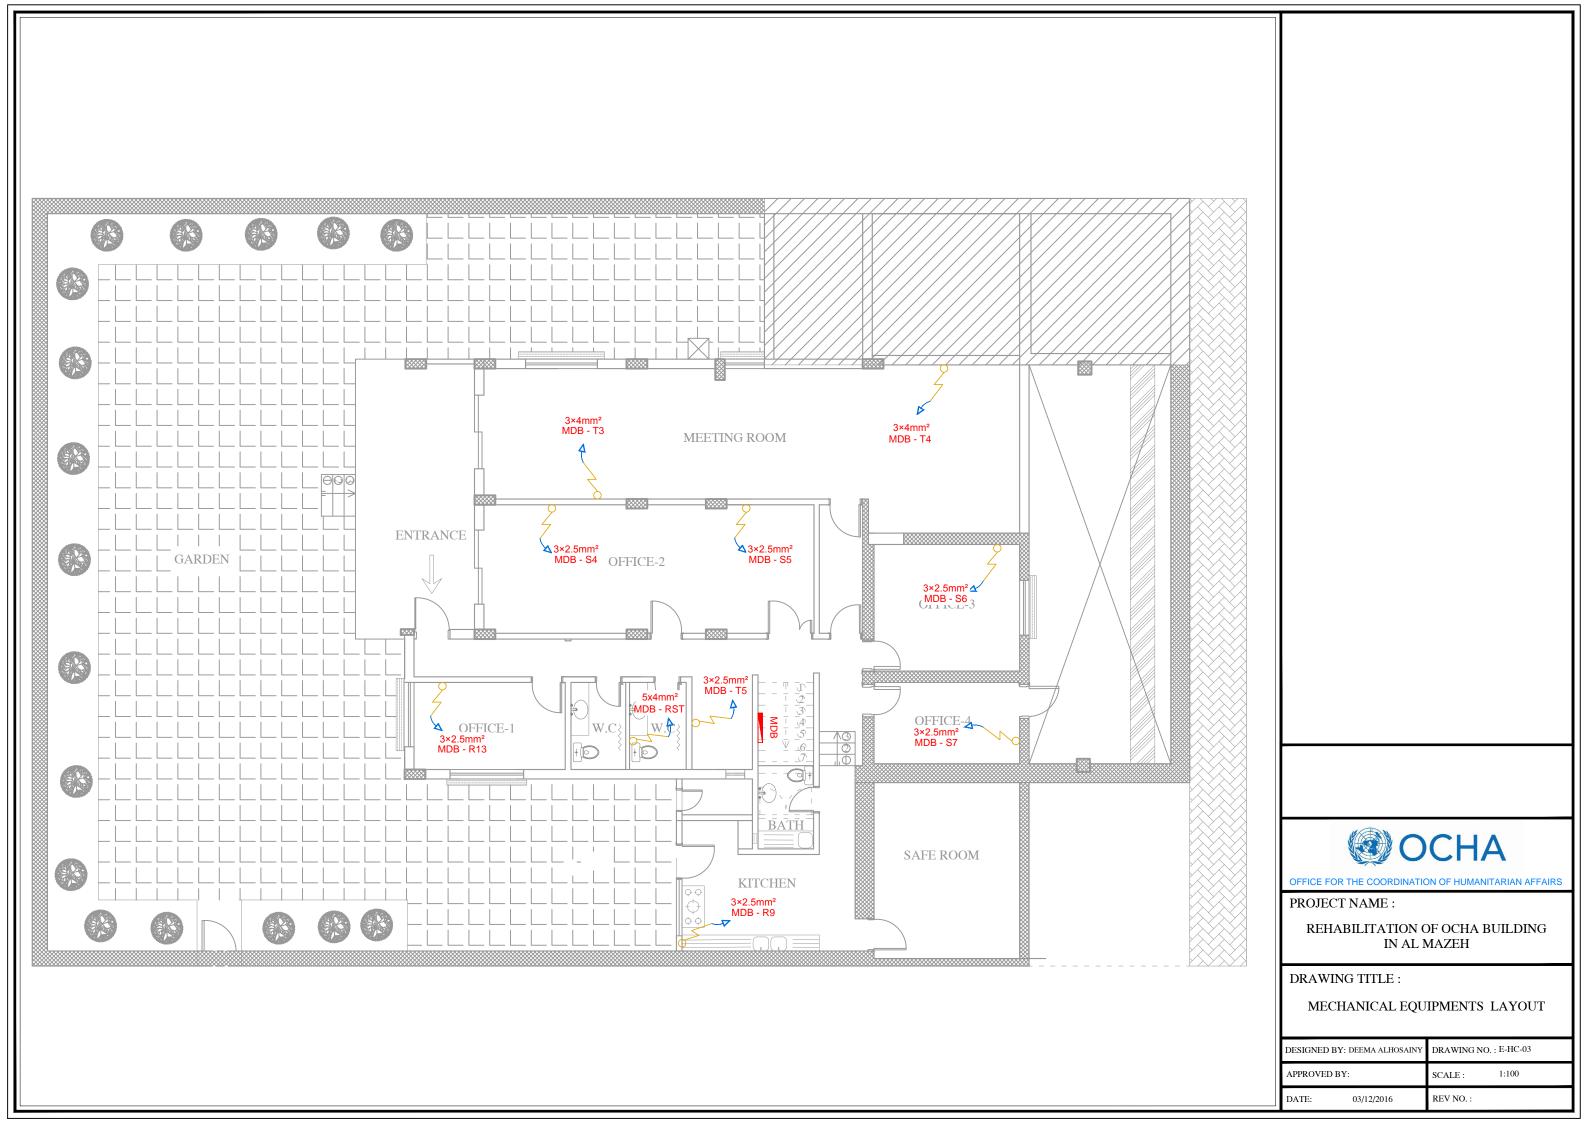
PROJECT NAME :


REHABILITATION OF OCHA BUILDING IN AL MAZEH

DRAWING TITLE:

POWER LAYOUT

DESIGNED BY:	DESIGNED BY: DEEMA ALHOSAINY		DRAWING NO · E-HC-02	
DESIGNED D1. DEEMINAEMOSMINI		BRAWING NO. : 2 He s2		
APPROVED BY:		SCALE :	1:100	
DATE:	03/12/2016	REV NO.:		




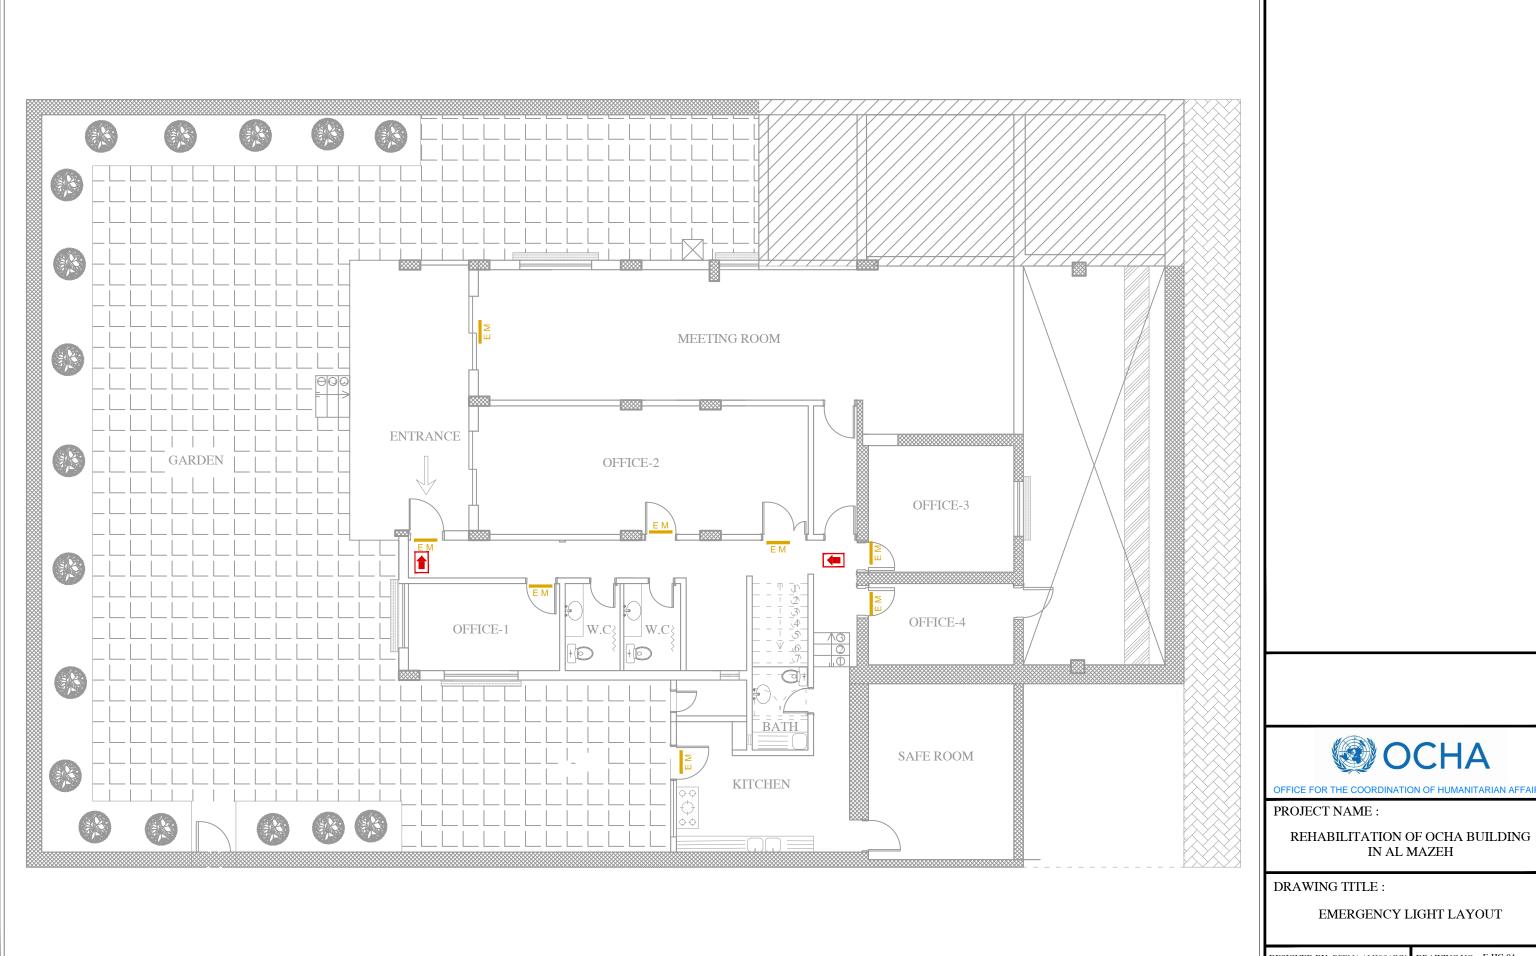




OFFICE FOR THE COORDINATION OF HUMANITARIAN AFFAIRS

DESIGNED BY: DEEMA ALHOSAINY		DRAWING NO. : E-HC-04	
APPROVED BY:		SCALE:	1:100
DATE: 03/12/2016		REV NO.:	

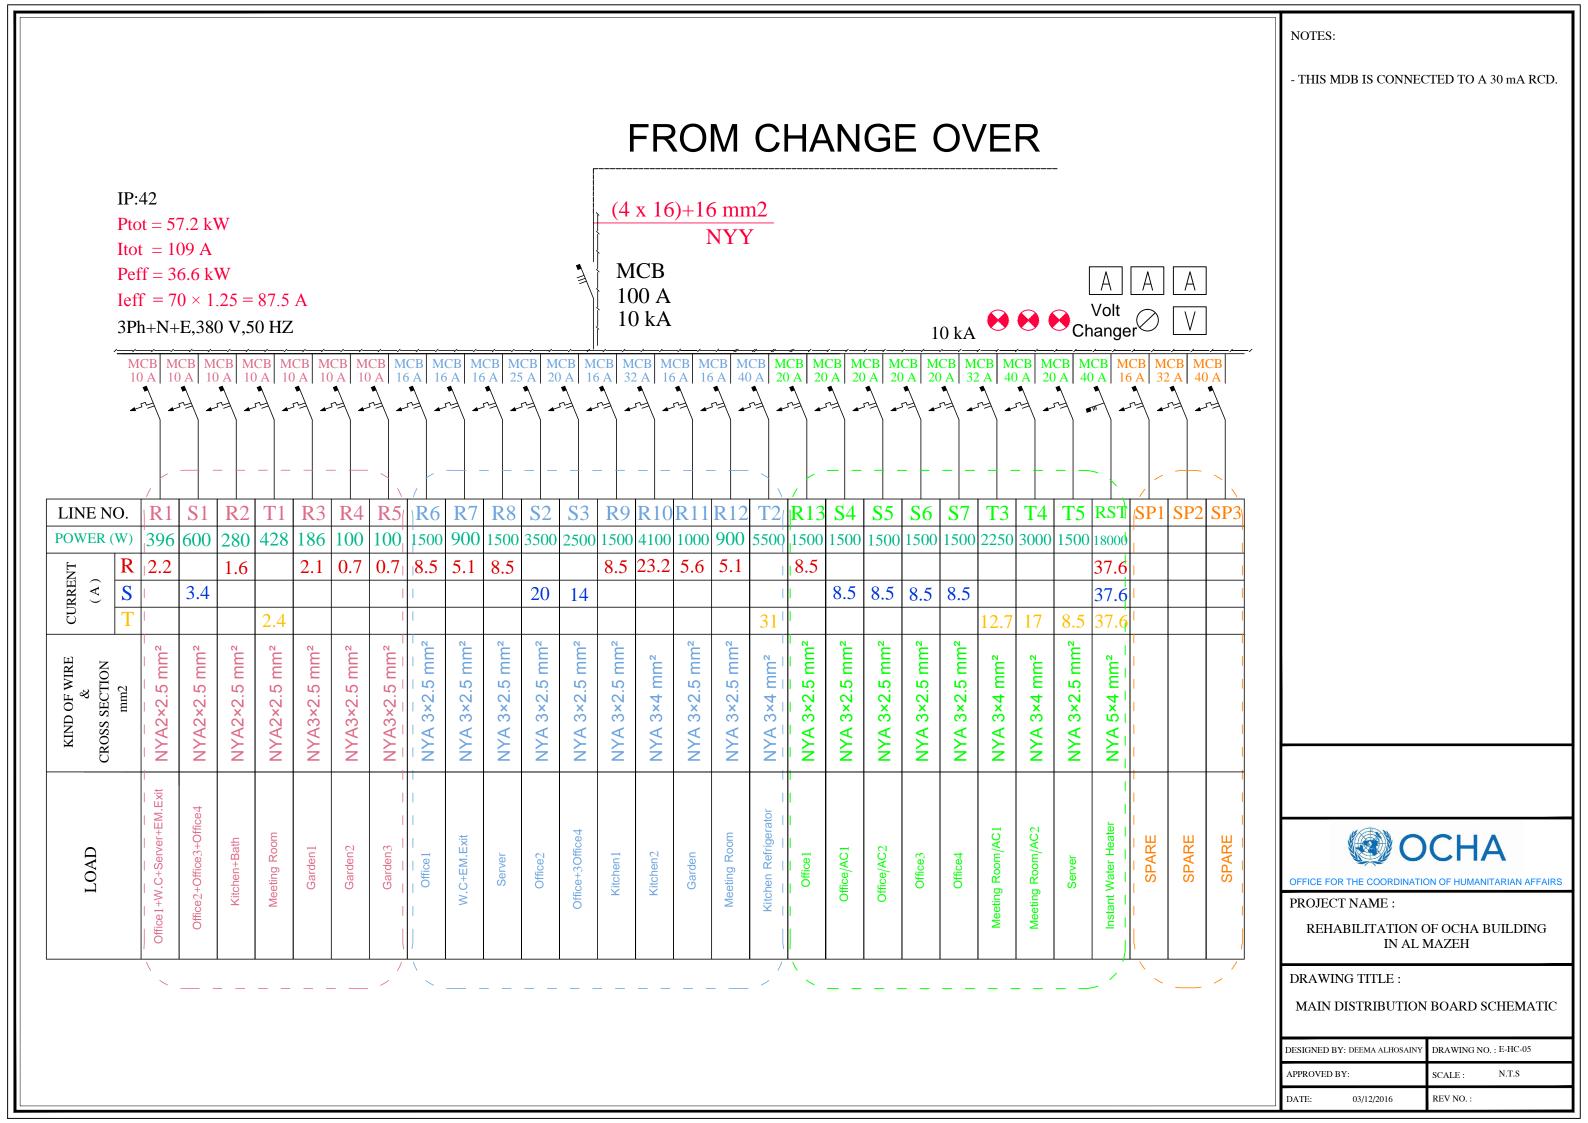

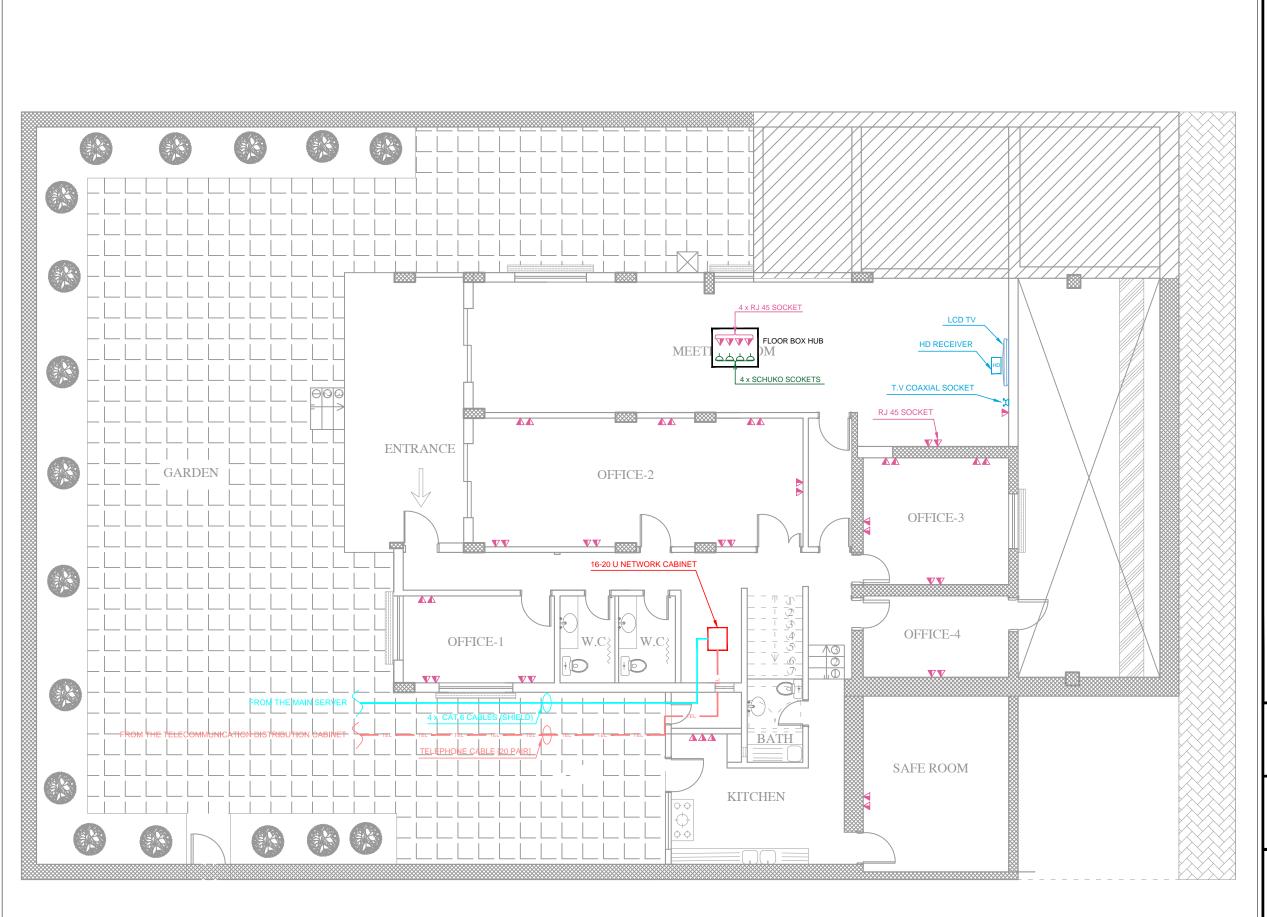

### NOTES:

- FLOOR BOX HAS 4 DATA SOCKETS AND 4 SCHUKO SOCKETS.
- ALL CABLES ARE WIRED IN TRUNKING, EXCEPT IN THE MEETING ROOM,ALL CABLES ARE HIDDEN IN THE WALLS AND FALSE CEILING
- . ALL SOCKETS ARE EXPOSED, EXCEPT IN THE MEETING ROOM, ALL CABLES ARE HIDDEN IN THE WALLS.
- DISTANCE BETWEEN ANY SOCKET OFF THE DOORS AND WALLS MUST BE 50 Cm.
- ALL DATA SOCKETS ARE RJ45 TYPE.
- WHEN WIRING SOCKETS ON TWO SIDES OF ONE WALL, THERE MUST BE A HORIZONTAL DISTANCE BETWEEN THE SOCKETS BETWEEN TWO SIDES AT LEAST ABOUT 15
- EACH DATA SOCKET HAVE TO BE CONNECTED TO THE NETWORK CABINET AS PER IT ENGINEER REQUIREMENTS.
- NETWORK CABINET IS CONNECTED TO THE MAIN SERVER BY 4 x CAT 6 CORDS WITH LENGTH FOR EACH CABLE APPROXIMATELY 50 m (REAL LENGTH MUST BE DETERMINED BY THE CONTRACTOR).
- ALL DATA WIRING (FROM THE NETWORK CABINET TO THE RJ45 SOCKET) ARE BY CAT 6 CORDS (REAL LENGTH OF ALL CABLES MUST BE DETERMINED BY THE CONTRACTOR).
- THE BUILDING IS CONNECTED TO THE
- TELECOMMUNICATION DISTRIBUTION CABINET BY 20 PAIR TELEPHONE CABLE WITH LENGTH APPROXIMATELY  $150\ \mathrm{m}$  (REAL LENGTH MUST BE DETERMINED BY THE CONTRACTOR).
- ALL DATA CABLES WHICH ARE COMING FROM THE MAIN SERVER ARE SHIELD CABLES, AND ALL THE CABLES FROM THE NETWORK CABINET TO THE DATA SOCKETS ARE UTP CABLES.
- ALL DATA CABLES FOR WIRING INSIDE THE NETWORK CABINET ARE UTP CAT 6 CABLES.
- NETWORK CABINET HAS 12 UNIT CAPACITY.
- EACH SWITCH PANEL AND PATCH PANEL HAS 24 PORT, AND EVERY PORT SUPPLY POWER PER ETHERNET ABOUT 15.4 WATT.



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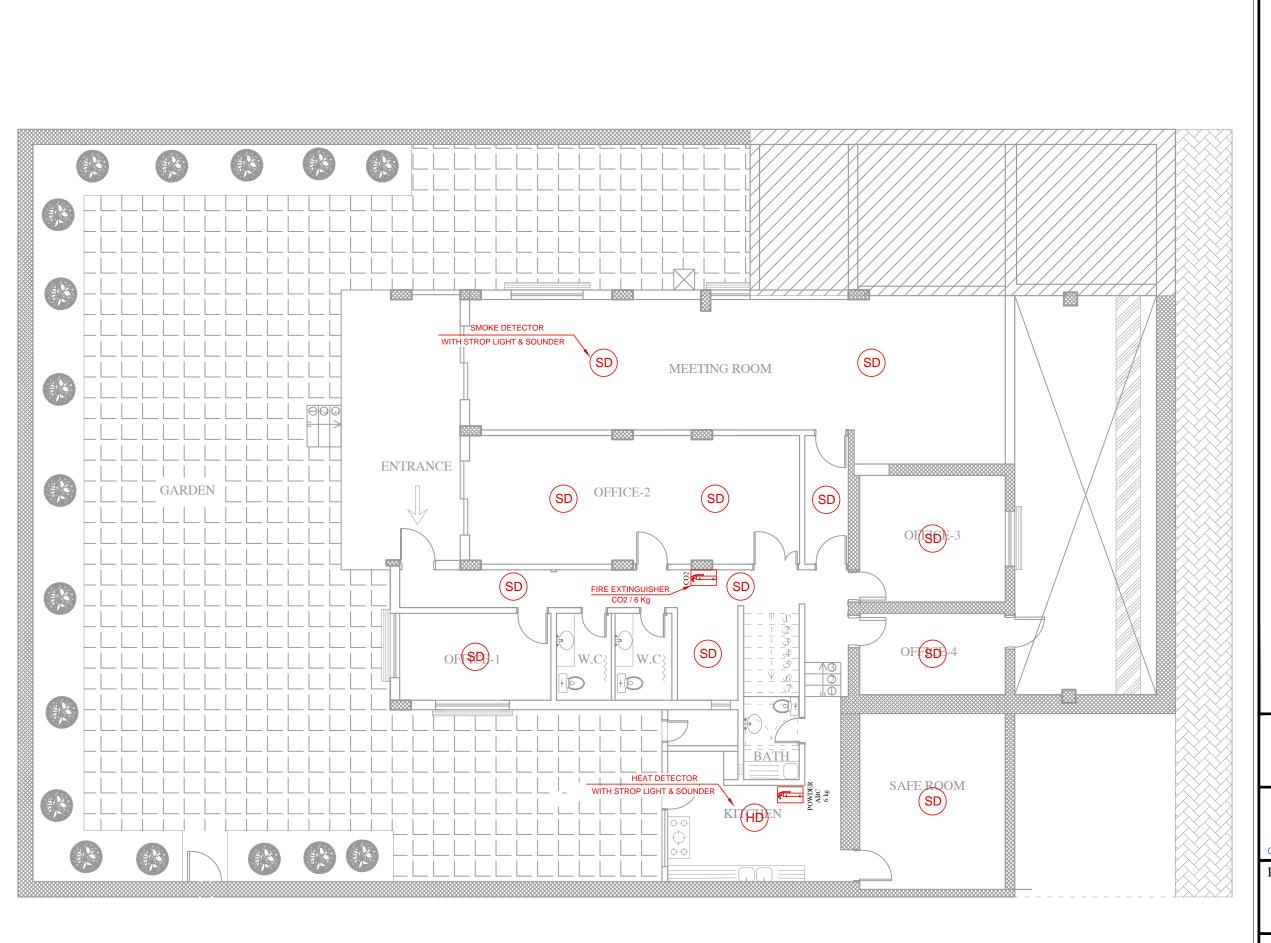
### PROJECT NAME:

REHABILITATION OF OCHA BUILDING IN AL MAZEH

### DRAWING TITLE:

DATA & TELEPHONE LAYOUT

DESIGNED BY: AMEER HAWARY		DRAWING NO, : E-LC-01	
APPROVED BY:		SCALE :	1:100
DATE:	03/12/2016	REV NO.:	



### NOTES:

- THERE IS NO FIRE FIGHTING SYSTEM CONNECTED TO THE FIRE ALARM SYSTEM.
- ALL SMOKE DETECTORS AND HEAT DETECTORS WORK SEPARATELY.
- ALL SMOKE DETECTORS AND HEAT DETECTORS ARE BATTERY DETECTORS.
- EACH DETECTOR CONTAINS (SENSOR, STROP LIGHT, AND SOUNDER).
- SENSITIVITY RANGE FOR EACH DETECTOR IS A CIRCLE WITH 4.5 m RADIUS.
- ALL DETECTORS HAVE TO BE POSITIONED AS SHOWN ON THE DRAWING.



OFFICE FOR THE COORDINATION OF HUMANITARIAN AFFAIRS

PROJECT NAME:

REHABILITATION OF OCHA BUILDING IN AL MAZEH

DRAWING TITLE:

FIRE ALARM LAYOUT

DESIGNED BY: AMEER HAWARY		DRAWING NO. : E-LC-02	
APPROVED BY:		SCALE :	1:100
DATE:	03/12/2016	REV NO.:	

