

NOTES:

- I. Locate light switches relative to door swings. Check height and location on site with Designer before installation
- 2. All cables to be mechanically secured \$ protected. Use pvc / pvc orange circular $^{\circ}$ V75 0.6 / I KV cables or TPS for internal wiring secure to steel catenary wires ınsıde ceiling space.
- 3. Use only equipment specified herein refer alternatives with samples and specifications to Designer for approval.
- 4. Use circuit breakers with thermal, magnetic \$ fault ratings to suit supply # load conditions.
- 5. Contractor to liase with EFL regarding permits \$ inspections.
- 6. Use PDL 600 series fitting for all light switches, switch toggles, normal \$ round - pin G.P.O power outlets.
- 7. A complete set of all drawings (latest revision)and specification shall be kept on site at all times \$ available for inspection
- 8. Mount switch toggles on pre fabricated switch plate with label insert slots.
- 9. All circuits shall be provided with rcd protection to AS3000-2000 and EFL regulations.
- I OPosition of all fittings, light \$ power shall be marked with chalk for Designer approval prior to permanent installation
- I I Also refer to SECTION: 18 ELECTRICAL of Specification
- I 2 All new cabling to be on Catenary wires
- 13All exterior and wet area light to be IP66

ELECTRICAL LEGEND:



(1x3) replacement LED PHILIPS troffer lights or equivalent to or approved by Designer approved by Designer (1200 x 600)



(1x3) replacement LED PHILIPS troffer lights or equivalent to or approved by Designer (600 x 600)





PHILIPS recessed downlight approved by Designer



One way switch PDL 600 series or approved equivalent all switches to be I 200mm above floor or unless otherwise noted

Copyright reserved in all drawings and the work excuted from them. Figured dimensions shall be read in preferance. Largest scaled drawings shall take precedence. Check all dimensions on site. All discrepancies shall be reported to the consultant immediately.




UNITED NATIONS DEVELOPMENT FUND PROPOSED OFFICE REFURBISHMENT

@ KADAVU HOUSE, LEVEL 1, VICTORIA PARADE, SUVA.

SHEET TITLE											ı	P			
LIGHTING LAYOUT PLAN											Б				
															S
REV.														ı	

PROJECT NO.: 004-020 SCALE: AS SHOWN : 01.04.20 SHEET NO. DATE SCALE : AS SHOWN

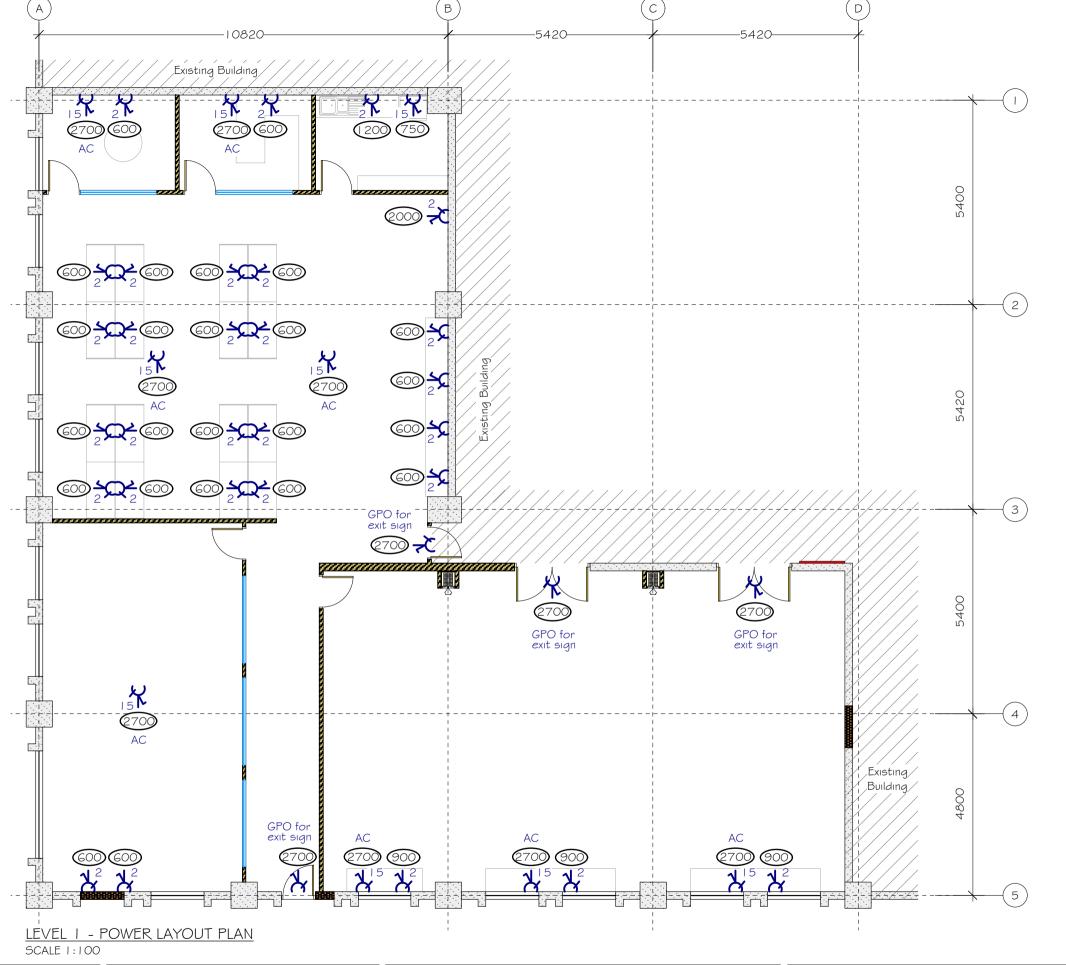

NOTES:

- Locate light switches relative to door swings. Check height and location on site with Designer before installation
- All cables to be mechanically secured \$
 protected. Use pvc / pvc orange circular
 V75 0.6 / IKV cables or TPS for internal
 wiring secure to steel catenary wires
 inside ceiling space.
- Use only equipment specified herein refer alternatives with samples and specifications to Designer for approval.
- Use circuit breakers with thermal, magnetic \$ fault ratings to suit supply \$ load conditions.
- 5. Contractor to liase with EFL regarding permits \$ inspections.
- G. Use PDL GOO series fitting for all light switches, switch toggles, normal \$ round pin G.P.O power outlets.
- 7. A complete set of all drawings (latest revision)and specification shall be kept on site at all times \$ available for inspection
- 8. Mount switch toggles on pre fabricated switch plate with label insert slots.
- All circuits shall be provided with rcd protection to AS3000-2000 and EFL regulations.
- IO. Position of all fittings, light \$ power shall be marked with chalk for Designers approval prior to permanent installation
- II. Also refer to SECTION: 18 ELECTRICAL of Specification
- I 2. All new cabling to be on Catenary wires
- 13. All electrical powerpoints and circut breakers to be CRIPSAL brand. Maximum of four (4) single powerpoints to be connected to one (1) 15AMPS circut breaker. All electrical cables to be properly ducted. All light and powerpoint switches to be separate.
- I 4. Electrical contractor to allow for powerpoints and separate circut breaker for air-conditioning works

LEGEND:



Single 10 amps general purpose outlet PDL 600 series or approved equivalent



Double 10 amps general purpose outlet PDL 600 series or approved equivalent



Single I Samps general purpose outlet PDL 600 series or approved equivalent

300

Height of fitting above finished floor level

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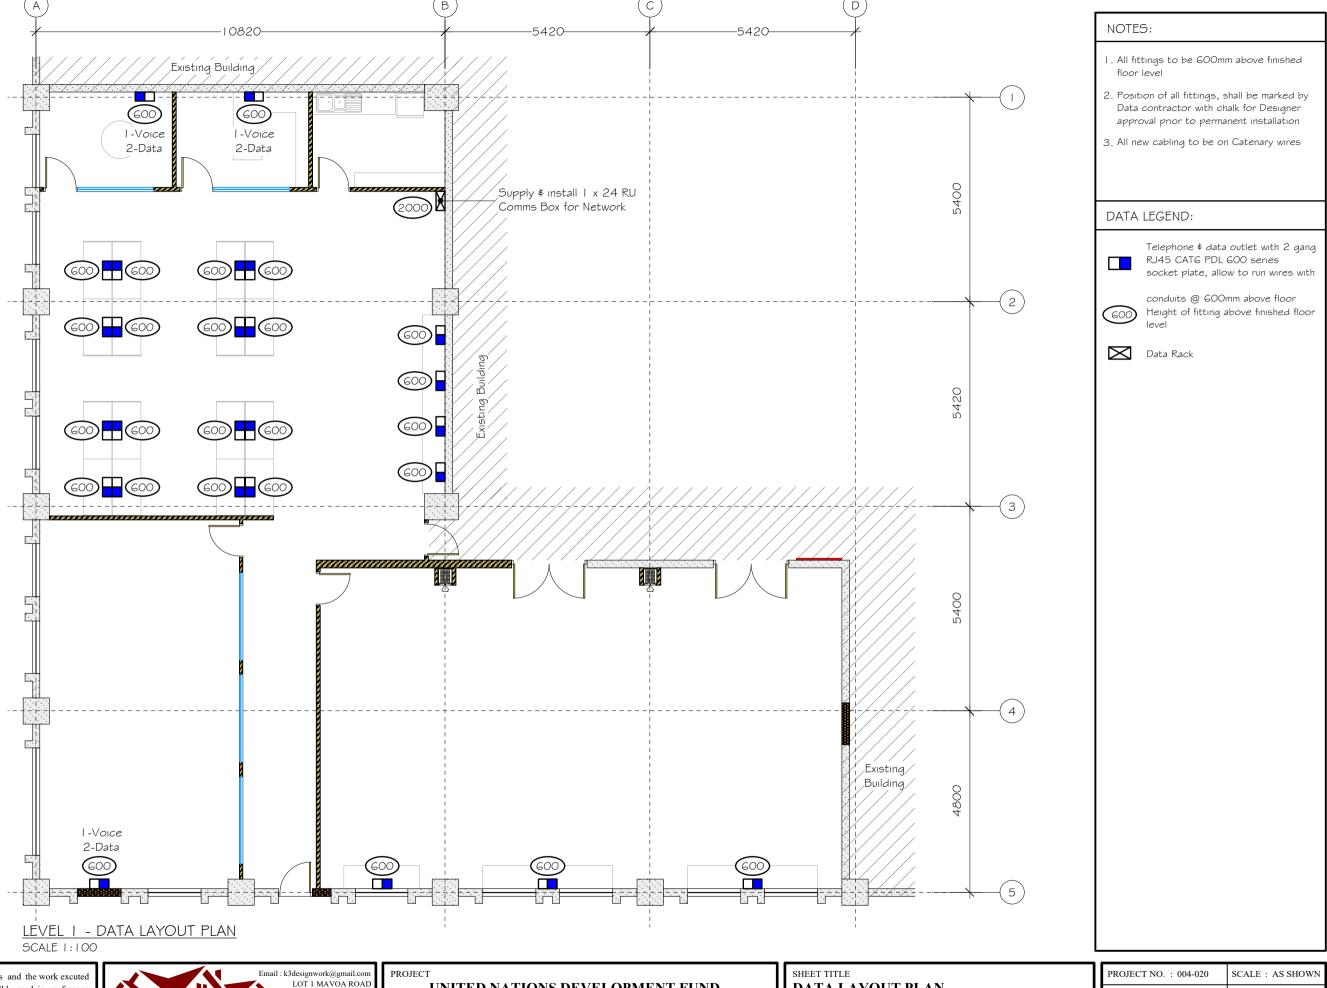


UNITED NATIONS DEVELOPMENT FUND PROPOSED OFFICE REFURBISHMENT

@ KADAVU HOUSE, LEVEL 1, VICTORIA PARADE, SUVA.

SHEET TITLE										ı	P			
POWER LAYOUT PLAN										ı	D			
														S
REV.														

PROJECT NO.	: 004-020	SCALE : AS SHOWN
DATE	: 01.04.20	SHEET NO.
SCALE	: AS SHOWN	Fa



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UNITED NATIONS DEVELOPMENT FUND **PROPOSI**

D NATIONS DEVELOPMENT FUND	DATA LAYOUT PLAN							
OSED OFFICE REFURBISHMENT								
@ KADAVU HOUSE, LEVEL 1,								
VICTORIA PARADE, SUVA.	REV.							

	PROJECT NO.	: 004-020	SCALE: AS SHOWN
	DATE	: 01.04.20	SHEET NO.
	SCALE	: AS SHOWN	F2
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