


HOMES FOR NGARANNAM, **ARMOURED VEHICLE SHADE** MAFA LGA, BORNO.

ISSUED FOR CONSTRUCTION

DECEMBER 2021

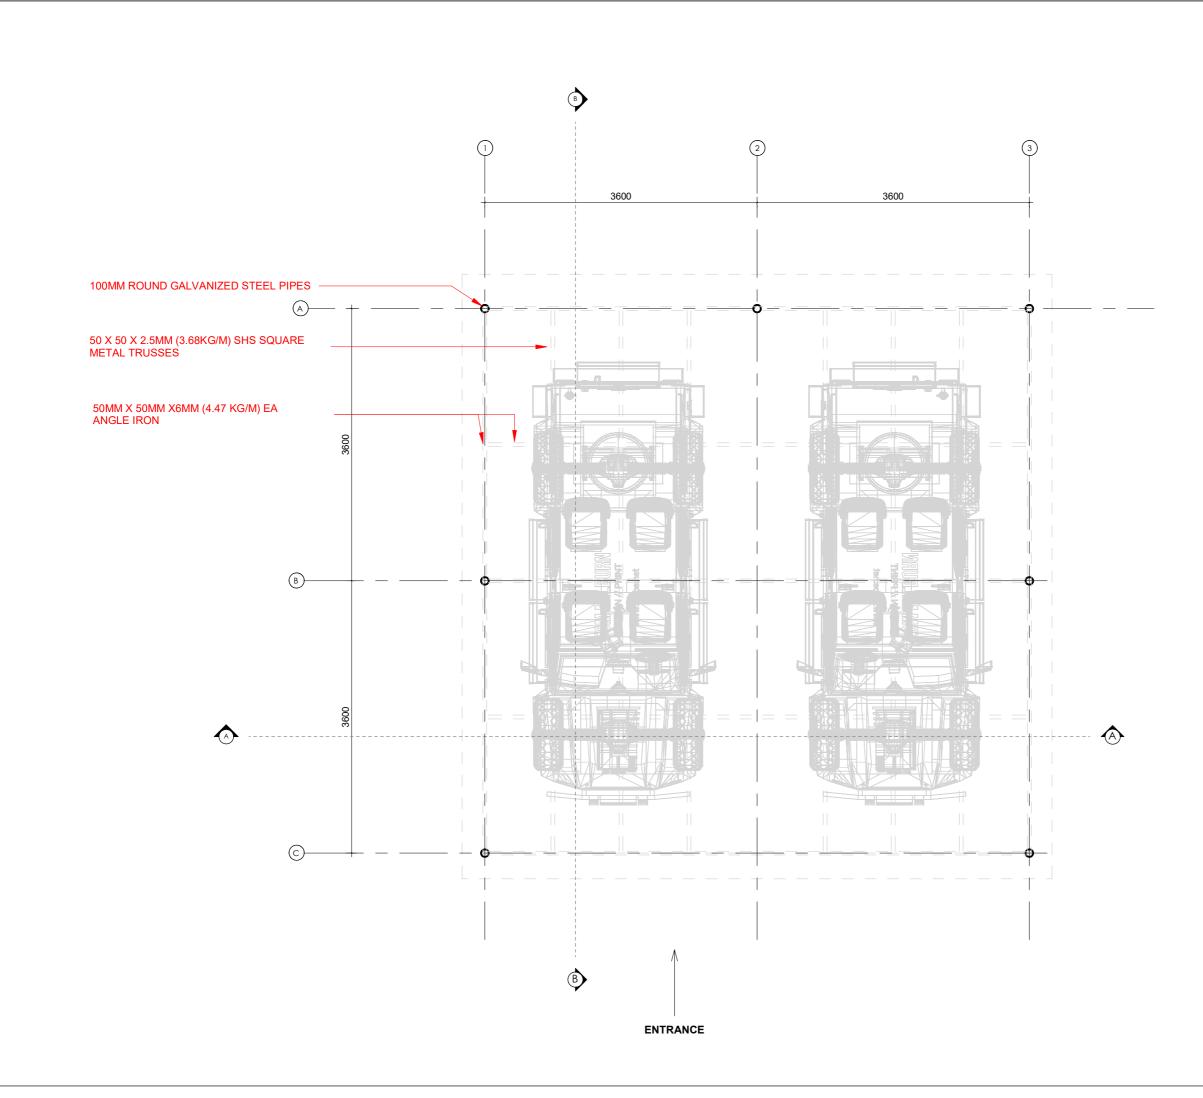

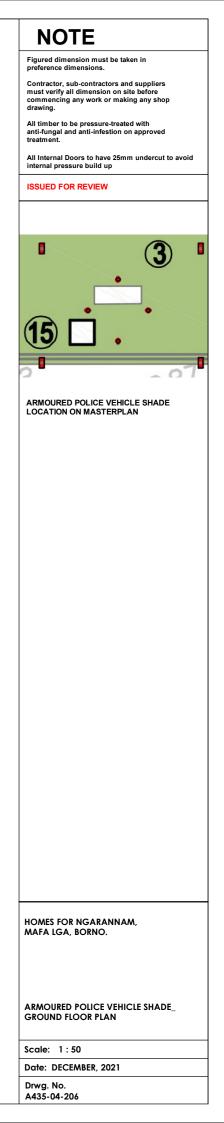

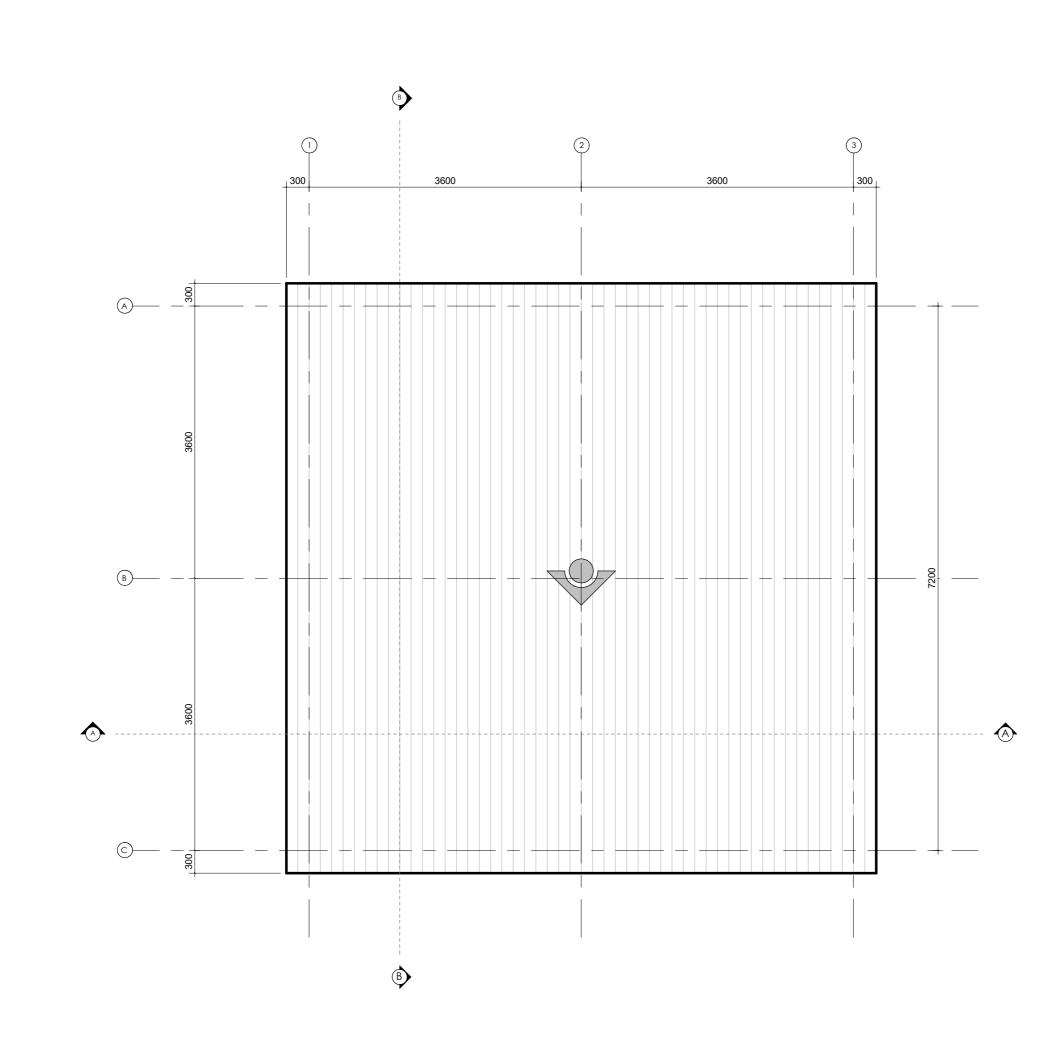

NOTE

Figured dimension must be taken in preference dimensions.

Contractor, sub-contractors and suppliers must verify all dimension on site before commencing any work or making any shop drawing.

All timber to be pressure-treated with anti-fungal and anti-infestion on approved treatment.

All Internal Doors to have 25mm undercut to avoid internal pressure build up


ISSUED FOR REVIEW

HOMES FOR NGARANNAM, MAFA LGA, BORNO.

ARMOURED POLICE VEHICLE SHADE_ ROOF PLAN

Scale: 1 : 50

Date: DECEMBER, 2021

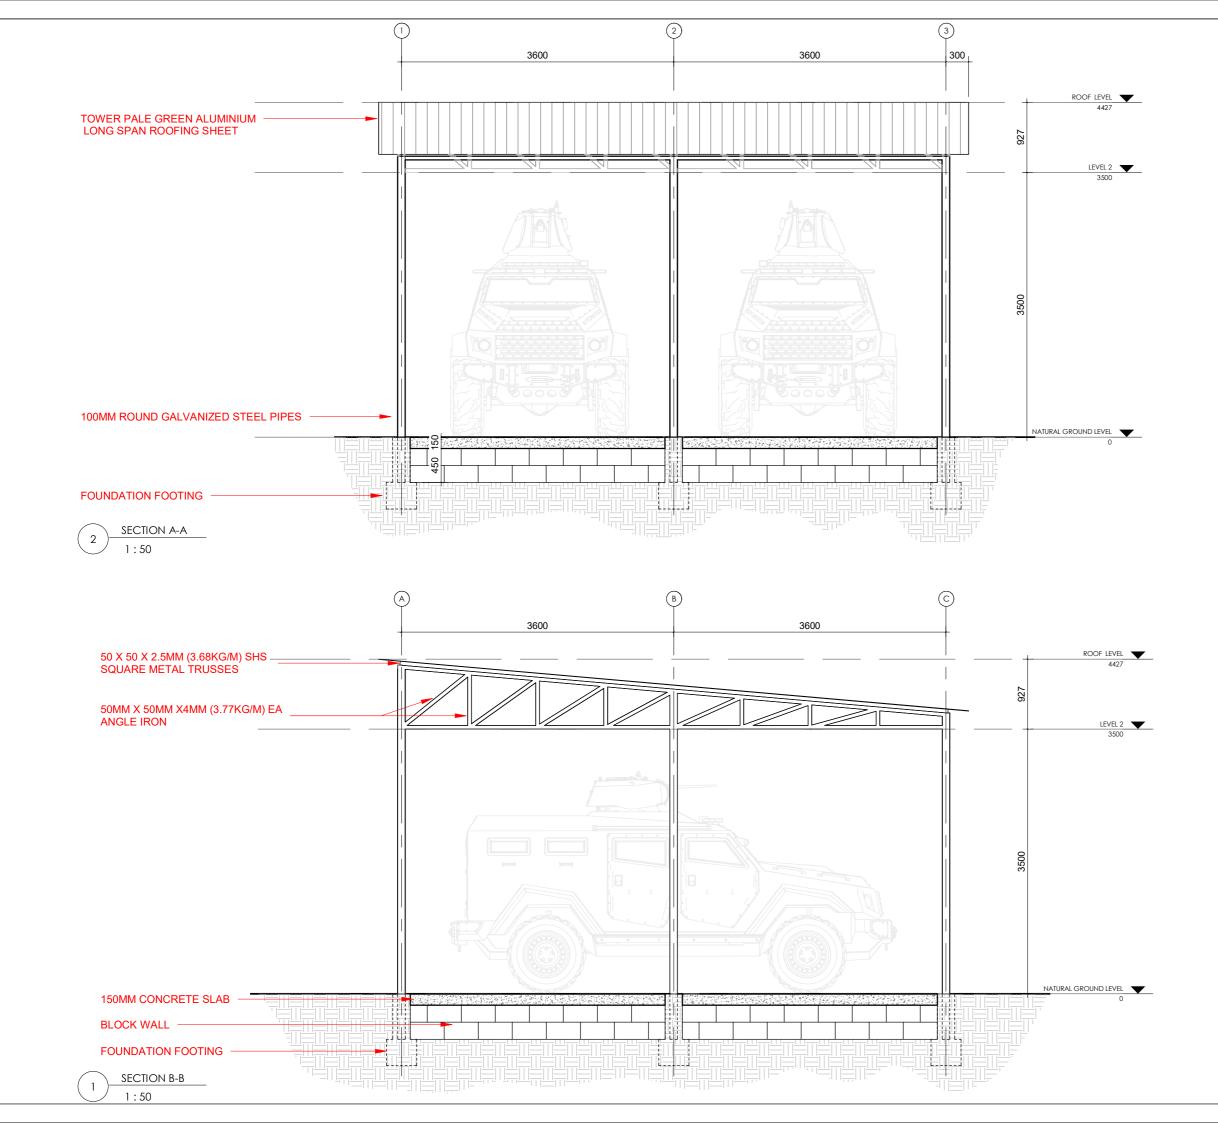

NOTE

Figured dimension must be taken in preference dimensions.

Contractor, sub-contractors and suppliers must verify all dimension on site before commencing any work or making any shop drawing.

All timber to be pressure-treated with anti-fungal and anti-infestion on approved treatment.

All Internal Doors to have 25mm undercut to avoid internal pressure build up


ISSUED FOR REVIEW

HOMES FOR NGARANNAM, MAFA LGA, BORNO.

ARMOURED POLICE VEHICLE SHADE_ SECTION A-A SECTION B-B

Scale: 1:50

Date: DECEMBER, 2021

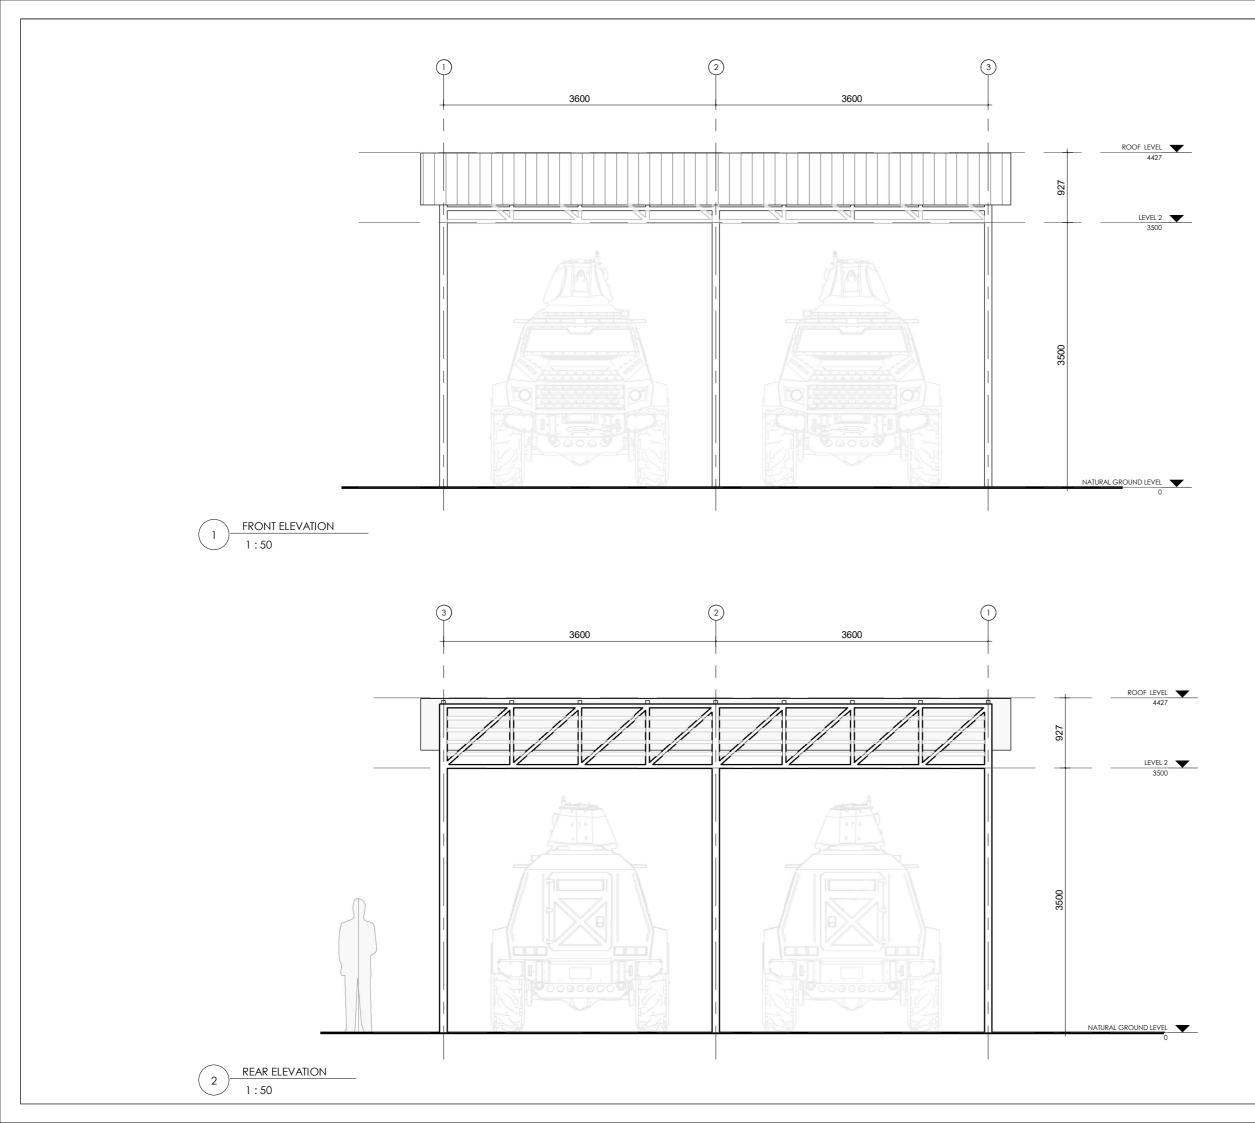

NOTE

Figured dimension must be taken in preference dimensions.

Contractor, sub-contractors and suppliers must verify all dimension on site before commencing any work or making any shop drawing.

All timber to be pressure-treated with anti-fungal and anti-infestion on approved treatment.

All Internal Doors to have 25mm undercut to avoid internal pressure build up


ISSUED FOR REVIEW


HOMES FOR NGARANNAM, MAFA LGA, BORNO.

ARMOURED POLICE VEHICLE SHADE_ FRONT AND REAR ELEVATIONS

Scale: 1:50

Date: DECEMBER, 2021

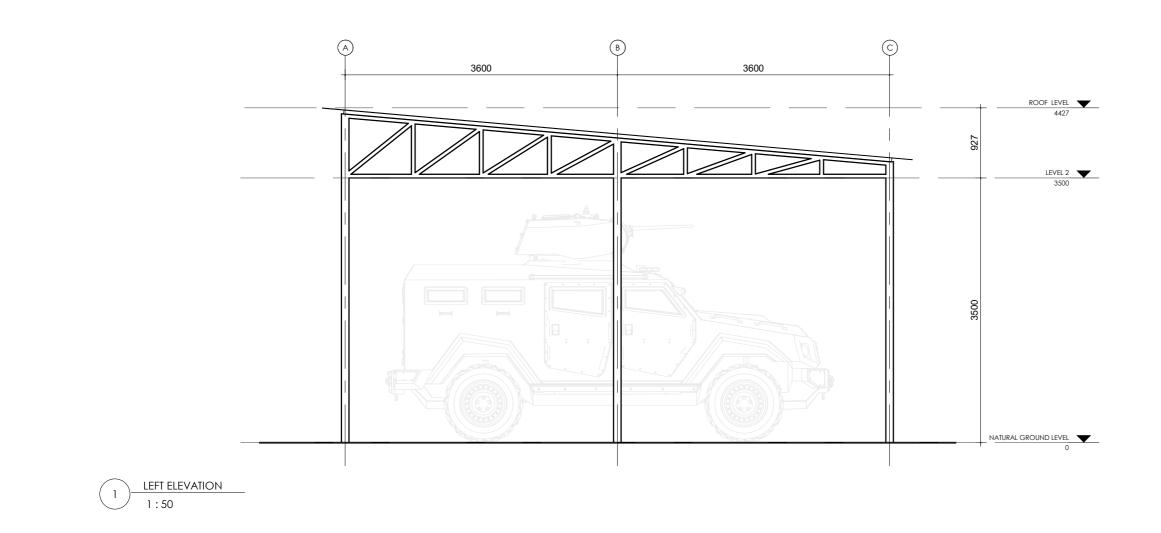

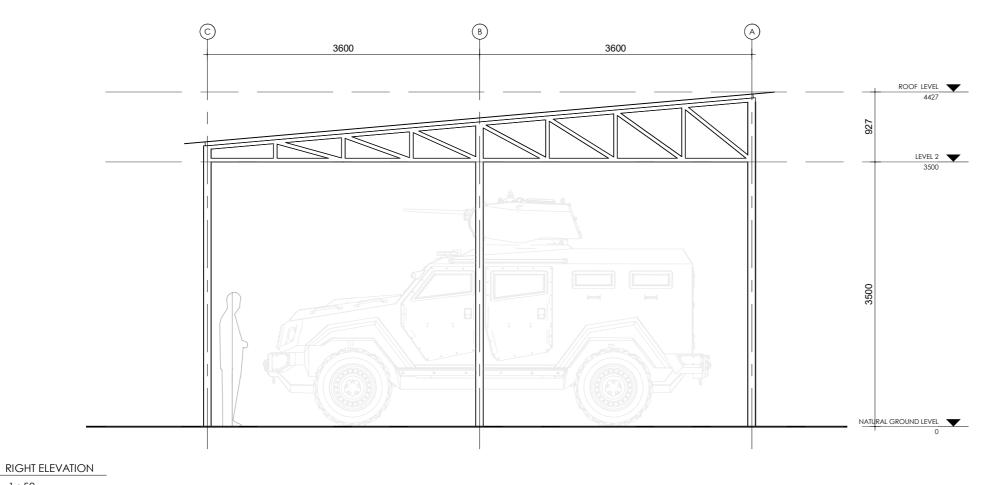

1 : 50

2

NOTE

Figured dimension must be taken in preference dimensions.

Contractor, sub-contractors and suppliers must verify all dimension on site before commencing any work or making any shop drawing.

All timber to be pressure-treated with anti-fungal and anti-infestion on approved treatment.

All Internal Doors to have 25mm undercut to avoid internal pressure build up


ISSUED FOR REVIEW

HOMES FOR NGARANNAM, MAFA LGA, BORNO.

ARMOURED POLICE VEHICLE SHADE_ LEFT ELEVATION & RIGHT ELEVATION


Scale: 1:50

Date: DECEMBER, 2021

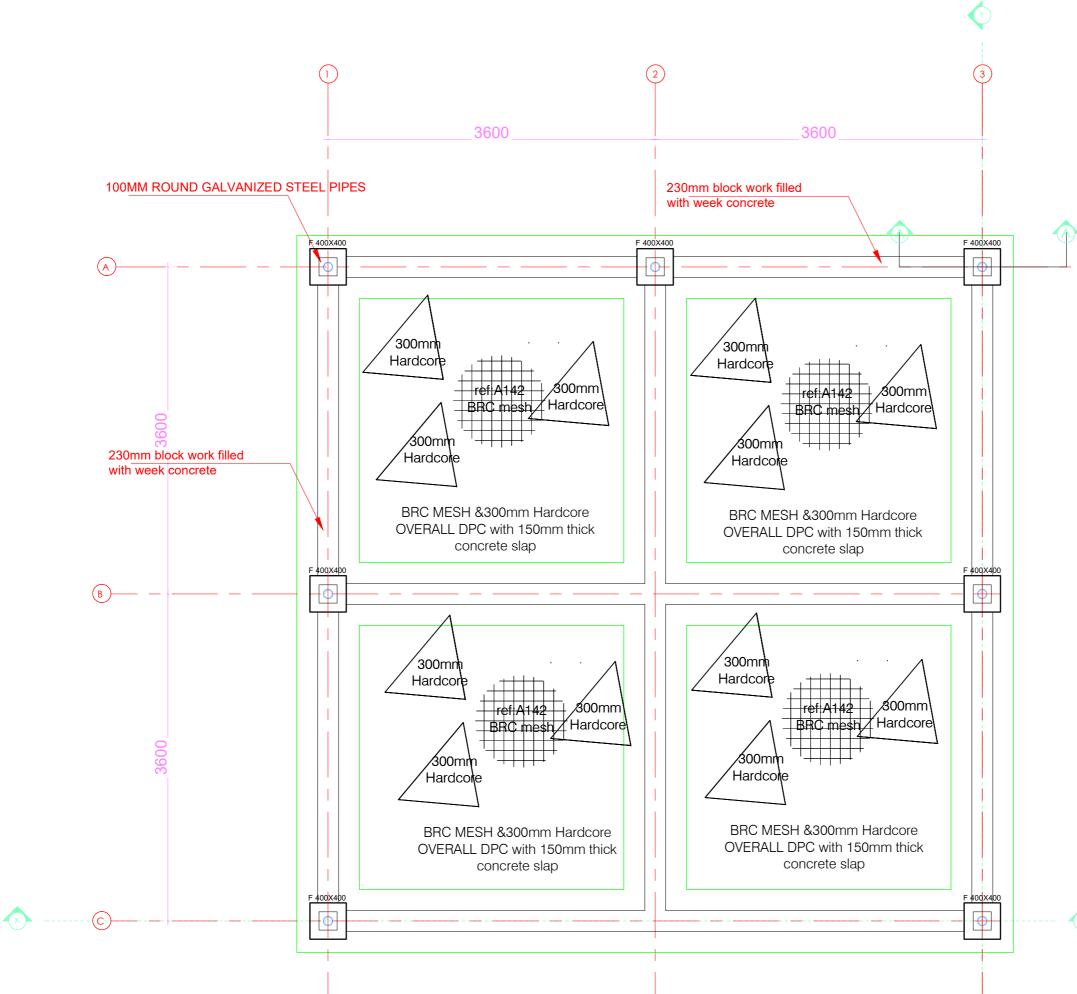



FOUNDATION LAYOUT


Y

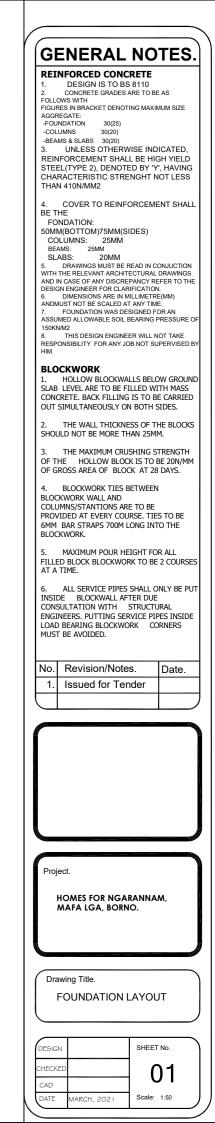


 \bigotimes

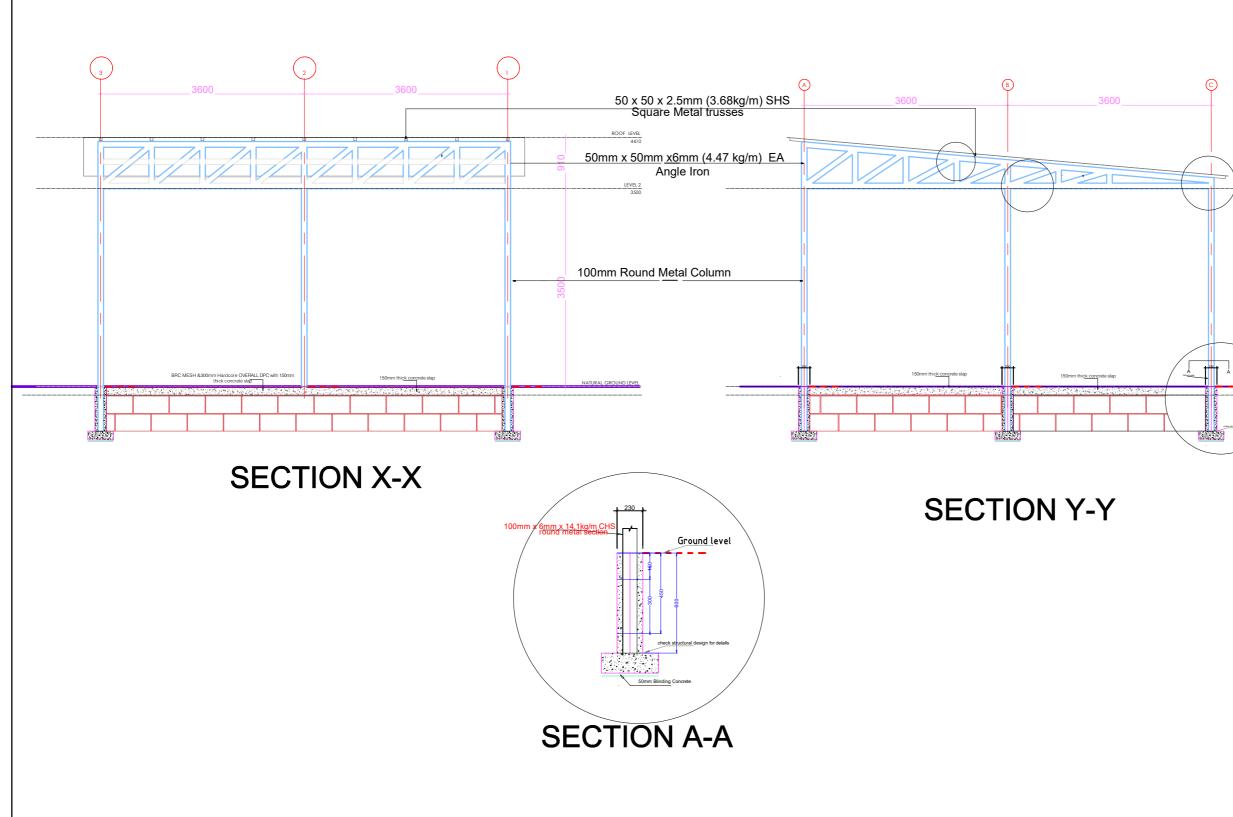


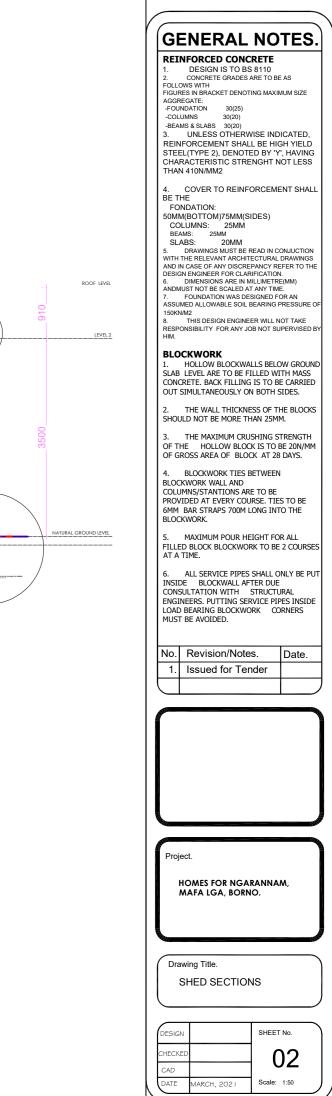

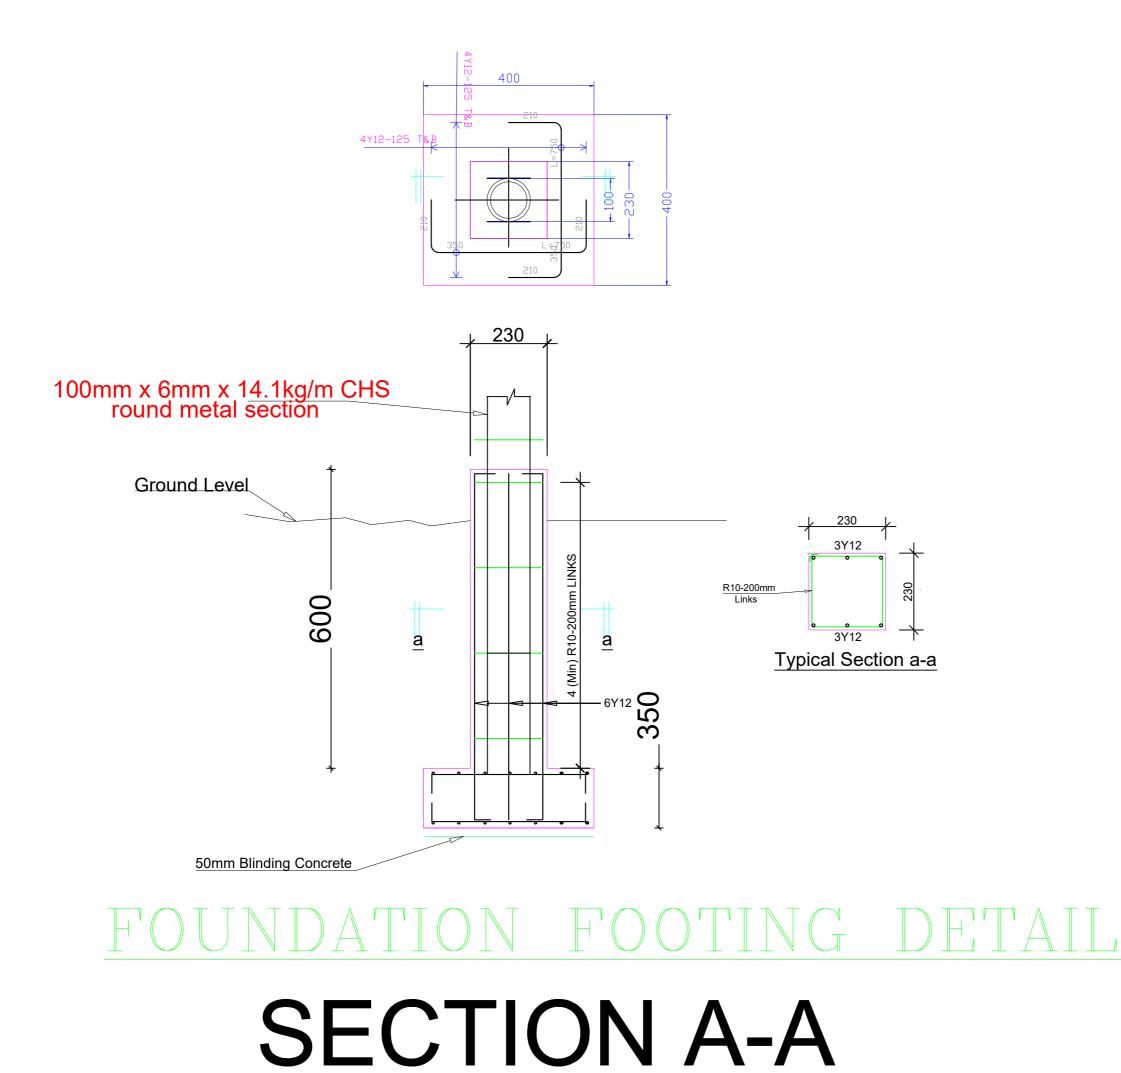


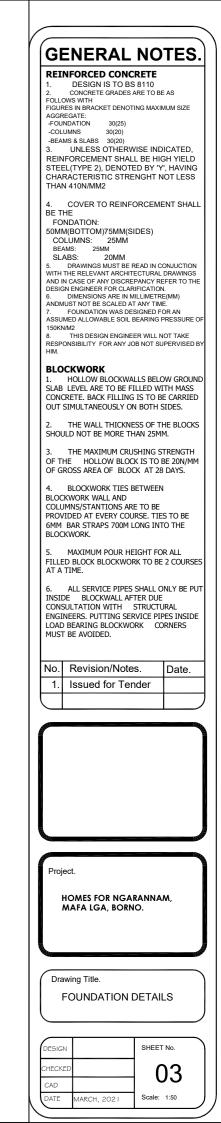

S

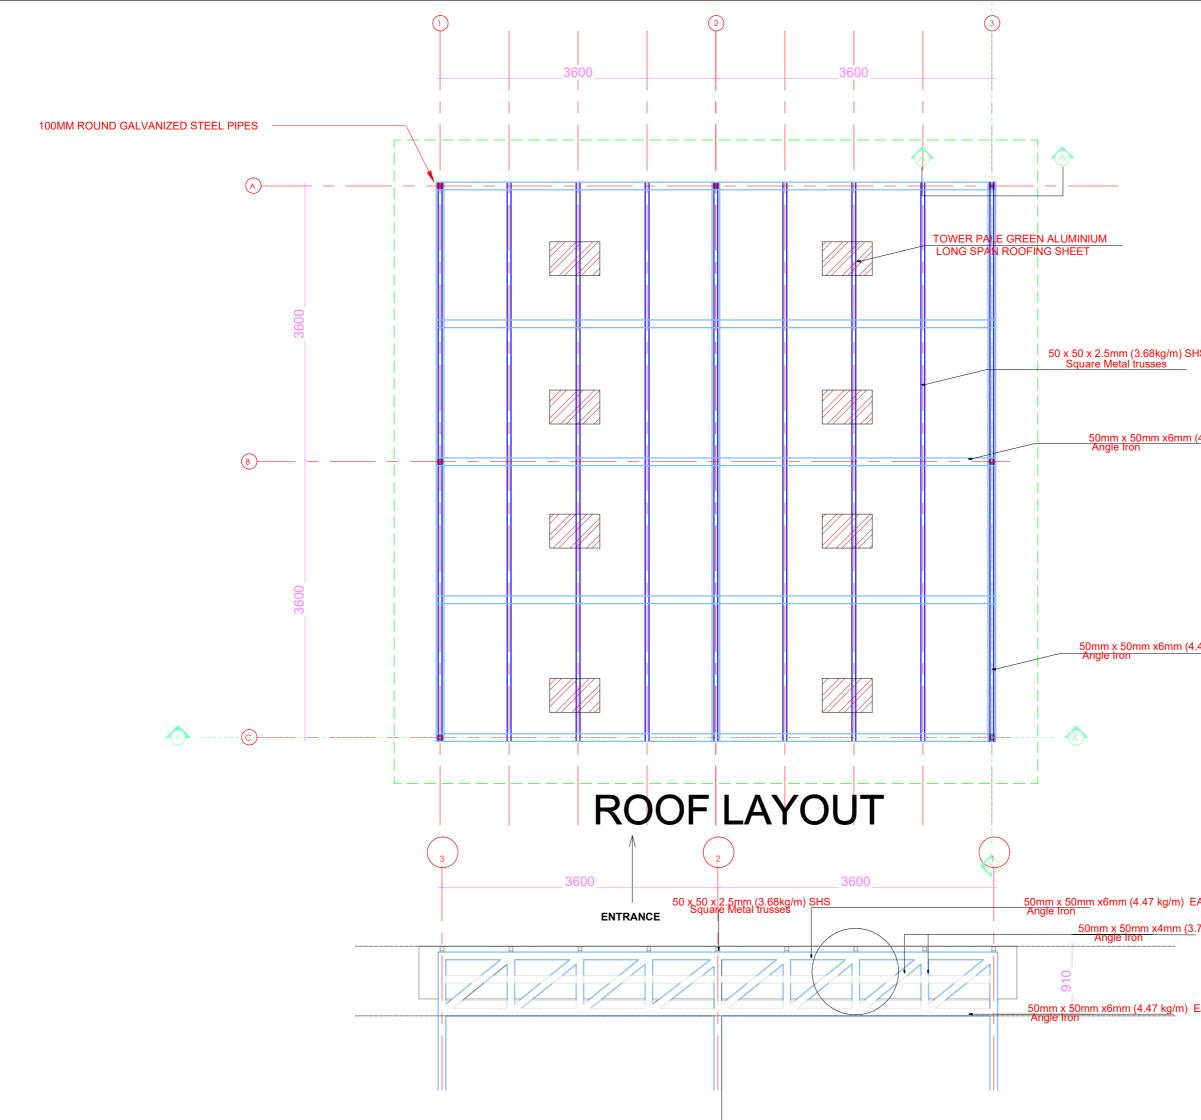

	GENERAL NOTES.
	REINFORCED CONCRETE 1. DESIGN IS TO BS 8110 2. CONCRETE GRADES ARE TO BE AS
	FOLLOWS WITH FIGURES IN BRACKET DENOTING MAXIMUM SIZE AGGREGATE: -FOUNDATION 30(25)
	-COLUMNS 30(20) -BEAMS & SLABS 30(20) 3. UNLESS OTHERWISE INDICATED,
	REINFORCEMENT SHALL BE HIGH YIELD STEEL(TYPE 2), DENOTED BY 'Y', HAVING CHARACTERISTIC STRENGHT NOT LESS THAN 410N/MM2
	4. COVER TO REINFORCEMENT SHALL BE THE FONDATION: 50MM(BOTTOM)75MM(SIDES) COLUMNS: 25MM BEAMS: 25MM 5. DRAWINGS MUST BE READ IN CONJUCTION WITH THE RELEVANT ARCHITECTURAL DRAWINGS AND IN CASE OF ANY DISCREPANCY REFER TO THE DESIGN ENGINEER FOR CLARIFICATION. 6. DIMENSIONS ARE IN MILLIMETRE(MM) ANDMUST NOT BE SCALED AT ANY TIME. 7. FOUNDATION WAS DESIGNED FOR AN ASSUMED ALLOWABLE SOIL BEARING PRESSURE OF
IS	Source Account of the source of the sou
	BLOCKWORK 1. HOLLOW BLOCKWALLS BELOW GROUND SLAB LEVEL ARE TO BE FILLED WITH MASS CONCRETE. BACK FILLING IS TO BE CARRIED OUT SIMULTANEOUSLY ON BOTH SIDES.
(4.47 kg/m) EA	2. THE WALL THICKNESS OF THE BLOCKS SHOULD NOT BE MORE THAN 25MM.
	3. THE MAXIMUM CRUSHING STRENGTH OF THE HOLLOW BLOCK IS TO BE 20N/MM OF GROSS AREA OF BLOCK AT 28 DAYS.
	4. BLOCKWORK TIES BETWEEN BLOCKWORK WALL AND COLUMNS/STANTIONS ARE TO BE PROVIDED AT EVERY COURSE. TIES TO BE 6MM BAR STRAPS 700M LONG INTO THE BLOCKWORK.
	5. MAXIMUM POUR HEIGHT FOR ALL FILLED BLOCK BLOCKWORK TO BE 2 COURSES AT A TIME.
47 kg/m) EA	6. ALL SERVICE PIPES SHALL ONLY BE PUT INSIDE BLOCKWALL AFTER DUE CONSULTATION WITH STRUCTURAL ENGINEERS. PUTTING SERVICE PIPES INSIDE LOAD BEARING BLOCKWORK CORNERS MUST BE AVOIDED.
	No. Revision/Notes. Date. 1. Issued for Tender
	Project.
A	HOMES FOR NGARANNAM, MAFA LGA, BORNO.
77kg/m) EA	
EA	Drawing Title. SHED ROOF DETAILS
	DESIGN SHEET NO. CHECKED 04
	CAD DATE MARCH, 2021 Scale: 1:50

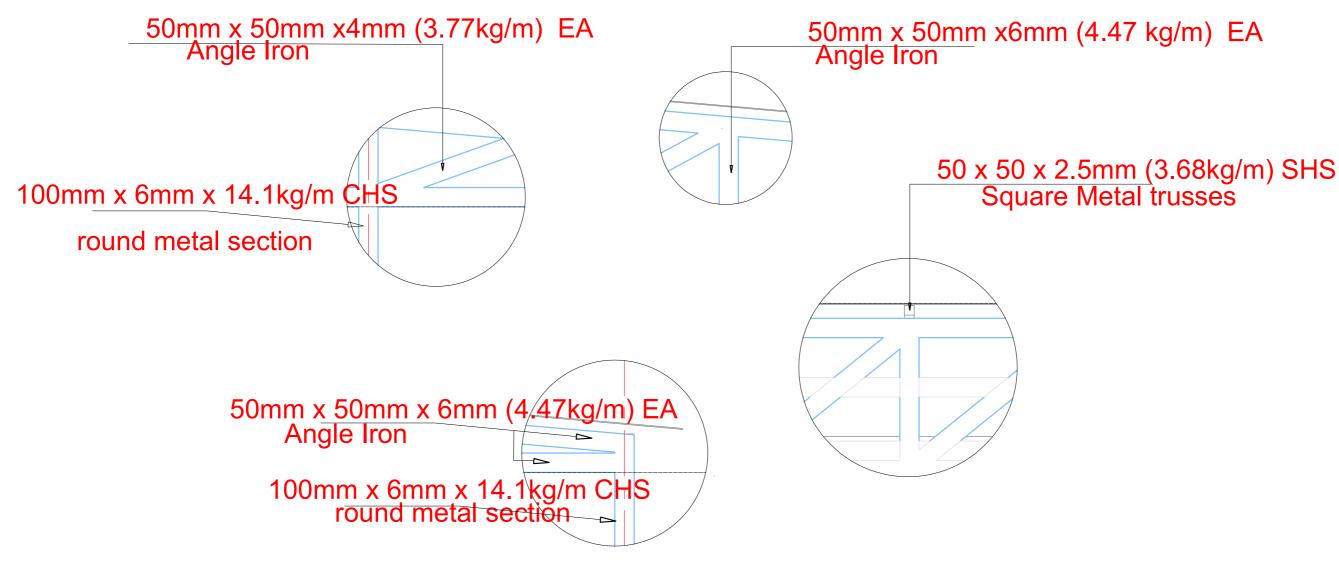

FD-UP ROOF SECTIONS

GENERAL NOTES. REINFORCED CONCRETE DESIGN IS TO BS 8110 DESIGN IS TO BS 8110
 CONCRETE GRADES ARE TO BE AS
 FOLLOWS WITH
 FIGURES IN BRACKET DENOTING MAXIMUM SIZE
 AGGREGATE:
 -FOUNDATION 30(25)
 -COLUMNS 30(20)
 BEAMS & SLABS 30(20)
 J. UNLESS OTHERWISE INDICATED,
 REINFORCEMENT SHALL BE HIGH YIELD
 STEEI (TY EAVIMOLE) STEEL(TYPE 2), DENOTED BY 'Y', HAVING CHARACTERISTIC STRENGHT NOT LESS THAN 410N/MM2 4. COVER TO REINFORCEMENT SHALL 4. COVER I BE THE FONDATION: FONDATION: 50MM(BOTTOM)/5MM(SIDES) COLUMNS: 25MM BEAMS: 25MM 5. ABS: 20MM 5. DRAWINGS MUST BE READ IN CONJUCTION WITH THE RELEVANT ARCHITECTURAL DRAWINGS AND IN CASE OF ANY DISCREPANCY REFER TO THE DESIGN ENGINEER FOR CLARIFICATION. 6. DIMENSIONS ARE IN MILLIMETRE(MM) ANDMUST NOT BE SCALED AT ANY TIME. 7. FOUNDATION WAS DESIGNED FOR AN 7. FOUNDATION WAS DESIGNED FOR AN ASSUMED ALLOWABLE SOIL BEARING PRESSURE O 150KN/M2 8. THIS DESIGN ENGINEER WILL NOT TAKE RESPONSIBILITY FOR ANY JOB NOT SUPER BLOCKWORK HOLLOW BLOCKWALLS BELOW GROUND SLAB LEVEL ARE TO BE FILLED WITH MASS CONCRETE. BACK FILLING IS TO BE CARRIED OUT SIMULTANEOUSLY ON BOTH SIDES. 2. THE WALL THICKNESS OF THE BLOCKS SHOULD NOT BE MORE THAN 25MM THE MAXIMUM CRUSHING STRENGTH OF THE HOLLOW BLOCK IS TO BE 20N/MM OF GROSS AREA OF BLOCK AT 28 DAYS. BLOCKWORK TIES BETWEEN BLOCKWORK WALL AND COLUMNS/STANTIONS ARE TO BE PROVIDED AT EVERY COURSE. TIES TO BE 6MM BAR STRAPS 700M LONG INTO THE BLOCKWORK. MAXIMUM POUR HEIGHT FOR ALL FILLED BLOCK BLOCKWORK TO BE 2 COURSES AT A TIME. ALL SERVICE PIPES SHALL ONLY BE PUT INSIDE BLOCKWALL AFTER DUE CONSULTATION WITH STRUCTURAL ENGINEERS, PUTTING SERVICE PIPES INSIDE LOAD BEARING BLOCKWORK CORNERS MUST BE AVOIDED. No. Revision/Notes. Date. Issued for Tender 1.

Project.

HOMES FOR NGARANNAM, MAFA LGA, BORNO.

Drawing Title.

DATE MARCH, 2021

CAD

ROOF STEEL DETAILS

SHEET No

Scale: 1:50

05